

### COUNTY OF MENDOCINO DEPARTMENT OF PLANNING AND BUILDING SERVICES

860 North Bush Street · Ukiah · California · 95482 120 West Fir Street · Ft. Bragg · California · 95437 JULIA KROG, DIRECTOR TELEPHONE: 707-234-6650 FAX: 707-463-5709 FB PHONE: 707-964-5379 FB FAX: 707-961-2427 pbs@mendocinocounty.gov www.mendocinocounty.org/pbs

April 30, 2024

Department of Transportation Environmental Health - Ukiah Building Inspection - Ukiah Assessor Air Quality Management

CASE#: AP\_2024-0016 DATE FILED: 3/18/2024 OWNER: VICTORIA TODD & JAMES GUNTLY APPLICANT: S. WILSON FOR T-MOBILE

Department of Forestry/ CalFire -Land Use Department of Fish and Wildlife Cloverdale Rancheria Potter Valley Tribe Redwood Valley Rancheria Sherwood Valley Band of Pomo Indians Potter Valley Community Services

**REQUEST:** Administrative Permit to authorize an eligible facilities request for modifications to an existing wireless communication facility that includes the replacement of six (6) existing antennas with six (6) new antennas, replacement of three (3) existing radios with six (6) new radios, removal of six (6) TMAs, removal of twelve (12) coaxial cables, installation of two (2) new cabinets, and other installation or removal of minor ancillary equipment.

**LOCATION:** 7.5± miles east of Calpella, on a private road 1.25± miles northeast of State Route 20, located at 6100 East Side Potter Valley Road, Potter Valley; (APN: 177-270-32).

SUPERVISORIAL DISTRICT: 1 STAFF PLANNER: LIAM CROWLEY

**RESPONSE DUE DATE:** May 14, 2024

### **PROJECT INFORMATION CAN BE FOUND AT:**

www.mendocinocounty.org

Select "Government" from the drop-down; then locate Planning and Building Services/Public Agency Referrals.

Mendocino County Planning & Building Services is soliciting your input, which will be used in staff analysis and forwarded to the appropriate public hearing. You are invited to comment on any aspect of the proposed project(s). Please convey any requirements or conditions your agency requires for project compliance to the project coordinator at the above address, or submit your comments by email to <u>pbs@mendocinocounty.org</u>. Please note the case number and name of the project coordinator with all correspondence to this department.

We have reviewed the above application and recommend the following (please check one):

□ No comment at this time.

Recommend conditional approval (attached).

Applicant to submit additional information (attach items needed, or contact the applicant directly, copying Planning and Building Services in any correspondence you may have with the applicant)

Recommend denial (Attach reasons for recommending denial).

Recommend preparation of an Environmental Impact Report (attach reasons why an EIR should be required).

Other comments (attach as necessary).

### **REVIEWED BY:**

Signature

Department

### CASE: AP\_2024-0016

**OWNER:** VICTORIA TODD & JAMES GUNTLY

APPLICANT: S. WILSON FOR T-MOBILE

- **REQUEST:** Administrative Permit to authorize an eligible facilities request for modifications to an existing wireless communication facility that includes the replacement of six (6) existing antennas with six (6) new antennas, replacement of three (3) existing radios with six (6) new radios, removal of six (6) TMAs, removal of twelve (12) coaxial cables, installation of two (2) new cabinets, and other installation or removal of minor ancillary equipment.
- LOCATION: 7.5± miles east of Calpella, on a private road 1.25± miles northeast of State Route 20, located at 6100 East Side Potter Valley Road, Potter Valley; (APN: 177-270-32).
- **APN/S:** 177-270-32
- PARCEL SIZE: 160± Acres
- GENERAL PLAN: Rangeland (RL:160)
- ZONING: Rangeland (R-L)

1

- EXISTING USES: Agricultural, Wireless Communication Facility
- DISTRICT:

LOCAL

RELATED CASES: See below.

	ADJACENT GENERAL PLAN	ADJACENT ZONING	ADJACENT LOT SIZES	ADJACENT USES
NORTH:	Rangeland (RL:160)	Rangeland (R-L)	160± Acres	Agricultural
EAST:	Rangeland (RL:160)	Rangeland (R-L)	160± Acres	Agricultural
SOUTH:	Public Lands (PL)	Public Facilities (P-F)	280± Acres	Vacant
WEST:	Public Lands (PL)	Public Facilities (P-F)	40± Acres	Vacant

### **REFERRAL AGENCIES**

🖾 Air Quality Management District	Potter Valley Community Services	TRIBAL
⊠ Assessor's Office	District	🖾 Cloverdale Rancheria
🖾 Building Division (Ukiah)	<u>STATE</u>	🖾 Potter Valley Tribe
Department of Transportation (DOT)	☑ CALFIRE (Land Use)	🖾 Redwood Valley Rancheria
🖾 Environmental Health (EH)	🛛 California Dept. of Fish & Wildlife	Sherwood Valley Band of Pomo Indians

### ADDITIONAL INFORMATION: Related projects include the following:

**V 8-96:** Variance to height restrictions to authorize the construction of a 150 foot tall communications tower. Approved 12/05/1996. **U 27-2003:** Use Permit to allow the addition of nine panel antennas (8 feet tall X 1 feet wide) to an existing 150 foot tall steel lattice tower. Approved 02/12/2004.

**UM 27-2003/2008:** Use Permit Modification to allow for the addition of a 6 foot diameter microwave dish at the 40 foot level of an existing 150 foot tall steel lattice tower. Approved 08/21/2008.

**UM 27-2003/2009:** Use Permit Modification to add three (3) panel antennas and one (1) microwave dish to an existing 150 foot tall tower and to place a battery backup power system, a GPS antenna and four (4) equipment cabinets within a 3,600± square foot leased area. Approved 07/16/2009. AP 9-2014: Administrative Permit for AT&T Mobility to collocate twelve (12) panel antennas at the 105 foot center-line on an existing 150 foot tall U.S. Cellular self-support lattice tower; installation of twenty-one (21) remote radio units (RRUs); installation of new surge protector; installation of new cable ladder; installation of inner ducts to support fiber and power lines; entitlement rights for two (2) future 4 foot diameter microwave antennas at the 97 foot centerline; installation of three (3) radio equipment outdoor cabinets; installation of a new 50 KVA propane fueled back up power generator and new 499 gallon propane tank and new electrical service. Approved 05/14/2014.

AP 28-2014: Administrative Permit to relocate two (2) and add three (3) panel antennas at 125 feet and relocate one (1) microwave antenna at 133 feet on an existing 150 foot tall wireless communications tower. Approved 12/10/2014.

**AP\_2017-0007:** Administrative Permit for US Cellular antenna modifications to an existing tower to include: decommissioning and removal from site: (3) antennae KMW-AM-X-VW-18-65-OOT-RET, (6) 7/8" coaxial cable. Install the following: (6) antennae KMW-AM-X-CD-17-65-OOT-RET, (1) ¼" Hybrid cable, (1) 1" power cable, (6) FRLB remote radio heads, (2) Raycap surge protectors, (12) Kaelus combiners, 2 stackable FXCB remote radio heads. Approved 07/18/2017.

**AP\_2019-0089:** Administrative Permit to install six (6) Long Term Evolution (LTE) Panel Antennas, six (6) Remote Radio Head (RRH) units and associated fiber and power jumpers to an existing 150 foot tall self-supporting lattice tower. Approved 10/12/2021.

**UR\_2020-0005:** Renewal of previously Modified Use Permit UM 27-2003/2009 to continue operation of an existing telecommunications facility. There are no proposed changes to the existing 150 foot tall self-supporting lattice tower, no associated ground equipment or requests for any physical modifications to the facility. Approved 12/17/2020.

**AP\_2020-0043:** Administrative Permit to install one (1) Generac<sup>®</sup> 25KW diesel generator with tank on a concrete slab and one (1) automatic transfer switch inside existing chain link fence enclosure. Approved 01/21/2021.

**AP\_2022-0021:** Administrative Permit to remove six (6) existing antennas and replace with six (6) new antennas. Remove twelve (12) existing radios and replace with six (6) new radios. Install two (2) new equipment cabinets within existing lease area. Install two (2) new pipe "T" standoffs to align antennas. Approved 08/29/2022.

### **ENVIRONMENTAL DATA**

### 1. MAC:

None

2. FIRE HAZARD SEVERITY ZONE: CALFIRE FRAP maps/GIS Very High

**3. FIRE RESPONSIBILITY AREA:** CALFIRE FRAP maps/GIS State Responsibility Area (SRA)

4. FARMLAND CLASSIFICATION:

Grazing Land (G)

5. FLOOD ZONE CLASSIFICATION: FEMA Flood Insurance Rate Maps (FIRM) None

6. COASTAL GROUNDWATER RESOURCE AREA: Coastal Groundwater Study/GIS N/A

7. SOIL CLASSIFICATION: Mendocino County Soils Study Eastern/Western Par Eastern Soil Class Unit No. 160

8. PYGMY VEGETATION OR PYGMY CAPABLE SOIL: LCP maps, Pygmy Soils Maps; GIS N/A

9. WILLIAMSON ACT CONTRACT: GIS/Mendocino County Assessor's Office Yes

**10. TIMBER PRODUCTION ZONE:** GIS None

**11. WETLANDS CLASSIFICATION:** 

Fluvial Natural Stream 400± feet west of site

12. EARTHQUAKE FAULT ZONE: Earthquake Fault Zone Maps; GIS

None

13. AIRPORT LAND USE PLANNING AREA: Airport Land Use Plan; GIS None

14. SUPERFUND/BROWNFIELD/HAZMAT SITE: GIS; General Plan 3-11 No

15. NATURAL DIVERSITY DATABASE: CA Dept. of Fish & Wildlife Rarefind Database/GIS None

16. STATE FOREST/PARK/RECREATION AREA ADJACENT: GIS; General Plan 3-10 No

17. LANDSLIDE HAZARD: Hazards and Landslides Map; GIS; Policy RM-61; General Plan 4-44 N/A

**18. WATER EFFICIENT LANDSCAPE REQUIRED:** Policy RM-7; General Plan 4-34 *No* 


19. WILD AND SCENIC RIVER: www.rivers.gov (Eel Only); GIS No


20. SPECIFIC PLAN/SPECIAL PLAN AREA: Various Adopted Specific Plan Areas; GIS No


21. STATE CLEARINGHOUSE REQUIRED: Policy No

22. OAK WOODLAND AREA: USDA No

23. HARBOR DISTRICT: Sec. 20.512 No

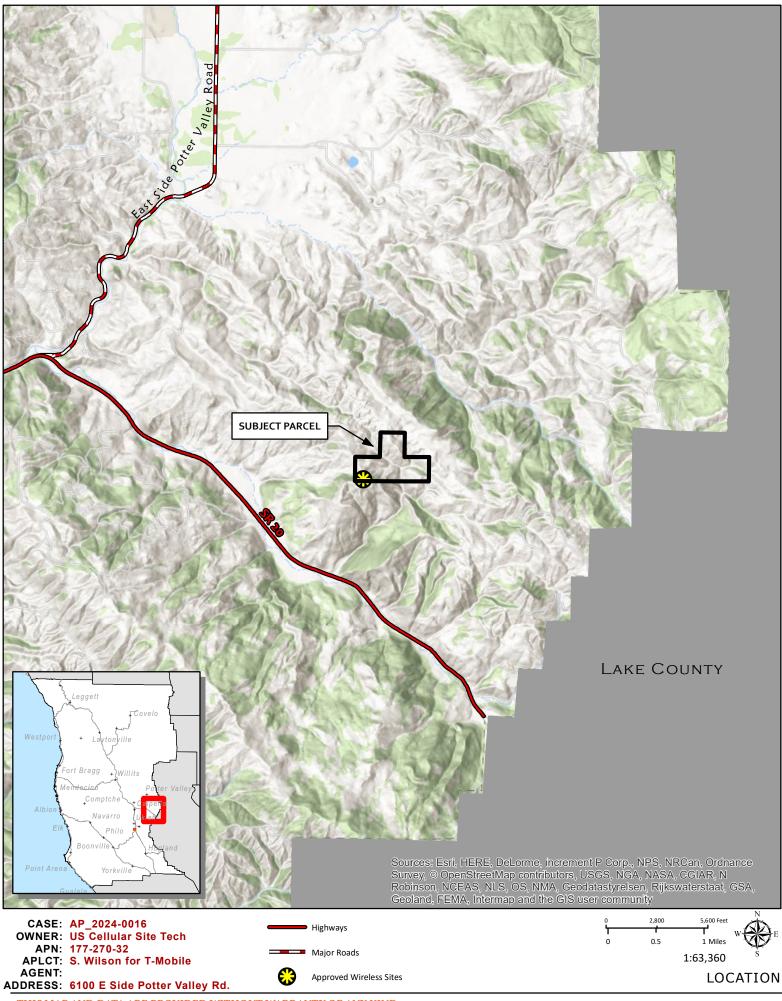

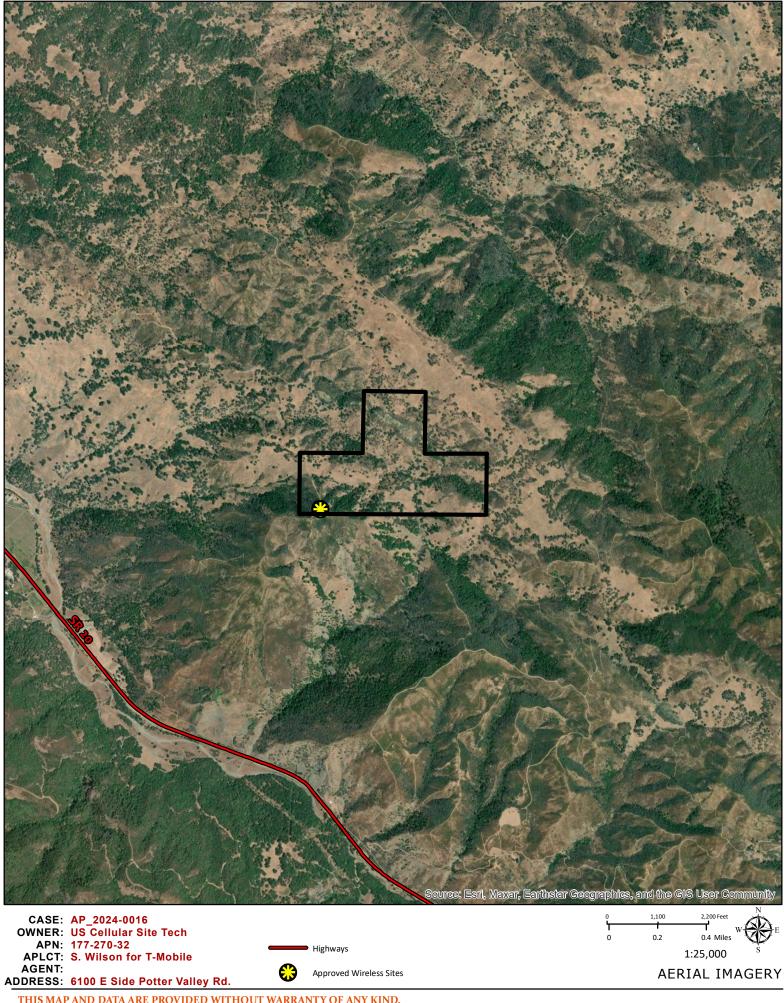

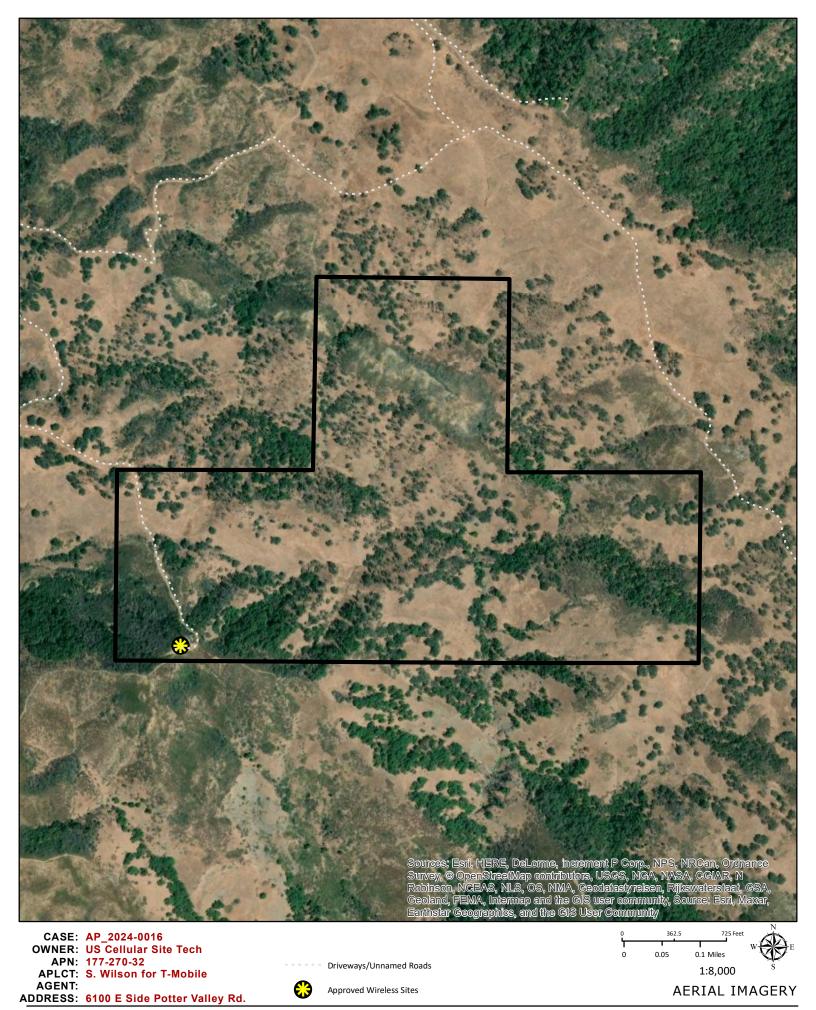

# **US CE**

### **PROJECT DESCRIPTION**

THE INSTALLATION AND OPERATION OF ANTENNAS AND ASSOCIATED EQUIPMENT AT AN EXISTING T-MOBILE UNMANNED WIRELESS COMMUNICATIONS FACILITY. SCOPE OF WORK CONSISTS OF THE FOLLOWING:

ANTENNA AREA:

- . REPLACE (6)(E) ANTENNAS WITH (6)(N) ANTENNAS FINAL QTY: (6)
- 2. REPLACE (3)(E) RADIOS WITH (3)(N) RADIOS AND ADD (3)(N) RADIOS TOTAL 6 3. REMOVE (6)(E) TMAS
- 4. REMOVE (12)(E) COAX CABLES

EQUIPMENT AREA:

- 5. RETAIN (1)(E) CABINET
- 6. INSTALL (1)(N) 6160 CABINET 7. INSTALL (2)(N) BASEBANDS INSIDE 6160 CABINET
- 8. INSTALL (1)(N) B160 CABINET
- 9. REMOVE (6)(E) DIPLEXERS
- 10. INSTALL (1)(N) IXRE ROUTER
- 11. INSTALL (2)(N) HYBRID CABLE SYSTEM (HCS) 12. REMOVE UNUSED EQUIPMENT IF ANY
- 13. INSTALL (1)(N) HCS WINDER BOX 14. REPLACE (1)(E) HALOGEN WORK LIGHT WITH (1)(N) LED SERVICE LIGHT

### CODE COMPLIANCE

ALL WORK AND MATERIALS SHALL BE PERFORMED AND INSTALLED IN ACCORDANCE WITH THE CURRENT EDITIONS OF THE FOLLOWING CODES AS ADOPTED BY THE LOCAL GOVERNING AUTHORITIES. NOTHING IN THESE PLANS IS TO BE CONSTRUED TO PERMIT WORK NOT CONFORMING TO THESE CODES.

1) 2022 CALIFORNIA BUILDING CODE (CBC)

- 2) 2022 CALIFORNIA RESIDENTIAL CODE (CRC) 3) 2022 CALIFORNIA HISTORICAL BUILDING CODE (CHBC)
- 4) 2022 CALIFORNIA EXISTING BUILDING CODE (CEBC)
- 5) 2022 CALIFORNIA GREEN BUILDINGS STANDARDS CODE (CGBSC)
- 6) 2022 CALIFORNIA FIRE CODE (CFC)
- 7) 2022 CALIFORNIA MECHANICAL CODE (CMC)
- 8) 2022 CALIFORNIA PLUMBING CODE (CPC)
- 9) 2022 CALIFORNIA ELECTRICAL CODE (CEC) 10) 2022 CALIFORNIA ENERGY CODE (CEC)
- 11) 2021 NFPA 101, LIFE SAFETY CODE
- 12) 2022 NFPA 72, NATIONAL FIRE ALARM AND SIGNALING CODE AS AMENDED BY CA
- 13) 2022 NFPA 13, FIRE SPRINKLER CODE AS AMENDED BY CA
- 14) 2023 NFPA 70, NATIONAL ELECTRICAL CODE
- 15) ASCE 7-16, STRUCTURAL MINIMUM DESIGN LOADS AND ASSOCIATED CRITERIA
- 16) ACI 318-19, CODE REQUIREMENTS FOR STRUCTURAL CONCRETE
- 17) CAL-OSHA

### SHE T-1 TITLE SHEET GN-1 GENERAL NOTES GN-2 GENERAL NOTES GN-3 SITE SIGNAGE GN-4 BATTERY SPECIFICATIONS A-1 OVERALL AND ENLARGED SITE PLAN A-2 EXISTING AND PROPOSED EQUIPMENT PLA A-2.1 EXISTING AND PROPOSED ANTENNA AND EXISTING AND PROPOSED ELEVATIONS (S A-3 A-4 EXISTING AND PROPOSED ELEVATIONS (N ANTENNA AND EQUIPMENT SCHEDULE A-5 DETAILS A-6 A-6.1 DETAILS ELECTRICAL NOTES AND PROPOSED GROU E-1 SINGLE LINE DIAGRAM, PANEL SCHEDULE E-2

### OCCUPANCY A

OCCUPANCY : U (UNMANNED COMMUNICATIONS F CONSTRUCTION TYPE: -

ACCESSIBILITY REQUIREMENTS

FACILITY IS UNMANNED AND NOT FOR HUMAN H REQUIRED, IN ACCORDANCE WITH CALIFORNIA S EXCEPTION 1 & SECTION 1134B.2.1, EXCEPTION

# RADIO FREC

REVISION LEV VERSION 5

# **GENERAL** C

DO NOT SCALE DRAWINGS

THESE DRAWINGS ARE FORMATTED TO BE FULL SIZ VERIFY ALL PLANS AND EXISTING DIMENSIONS AND IMMEDIATELY NOTIFY THE ARCHITECT/ENGINEER IN N PROCEEDING WITH THE WORK OR MATERIAL ORDERS

Σ

<ul> <li>Independent of the second secon</li></ul>	0855A CHOR DGUNT		Prepared For: T. A CONCORD AVENUE, SUITE 500 CONCORD, CA 94520 Engineer:
ET INDEX	PROJECT TEAM		
ANS EQUIPMENT PLANS SOUTHEAST) NORTHEAST) DUNDING PLAN/S E, AND GROUNDING DETAILS	APPLICANT/LESSEE: T-MOBILE 1200 CONCORD AVENUE, SUITE 500 CONCORD, CA 94520 ELIZABETH RIVERA PH: (949) 303–3095 AGENT/ENGINEER: THE CBR GROUP 2840 HOWE ROAD, SUITE E MARTINEZ, CA 94553 SARAH WILSON PH: (925) 246–3212 EMAIL: projects@thecbrgroup.com PH: (925) 246–3212 EMAIL: projects@thecbrgroup.com PROJECT INFORMATIONS CURRENT USE: UNMANNED TELEC OMMUNICATIONS FACILITY PROPOSED USE: UNMANNED TELEC OMMUNICATIONS FACILITY STRUCTURE TYPE: LATTICE TOWER	SITE	Image: Second state of the second s
AND CONSTRUCTION TYPE	<u>APN:</u> 177-270-32		IT IS A VIOLATION OF LAW FOR ANY PERSON, UNLESS THEY ARE ACTING UNDER THE DIRECTION OF A LICENSED PROFESSIONAL ENGINEER, TO ALTER THIS DOCUMENT.
FAC ILITY)	<u>COORDINATES (LAT/LONG):</u> 39.228011° (39° 13' 40.84" NORTH) /	STRUCTURE PHOTO	Licensor:
HABITATION, ACCESSIBILITY ACCESS AND REQUIREMENTS ARE NOT State administrative code, part 2, title 24, section 1103B.1, 4.	-123.064856° (123° 03' 53.48" WEST) <u>GROUND ELEVATION:</u> ±2393.1' Amsl <u>JURISDICTION:</u>		
QUENCY DATA PLAN	COUNTY OF MENDOCINO PROPERTY OWNER:		IT IS A VIOLATION OF LAW FOR ANY PERSON, UNLESS THEY ARE ACTING UNDER THE DIRECTION OF A LICENSED PROFESSIONAL ENGINEER, TO ALTER THIS DOCUMENT.
10/23/2023	US CELLULAR SITE TECH Shawn Cra <b>m</b> er Tel: 707–498–7503		Sheet Title:
ONTRACTOR NOTES	<u>POWER AGENCY:</u> pg&e 245 Market street san francisco, ca 94105		TITLE SHEET
ZE AT 24" × 36". CONTRACTOR SHALL CONDITIONS ON THE JOBSITE AND SHALL WRITING OF ANY DISCREPANCIES BEFORE RS OR BE RESPONSIBLE FOR THE SAME.	TELEPHONE AGENCY: at&t california 5001 executive parkway san ramon, ca 94583		Sheet Number: T-1

### GENERAL CONSTRUCTION NOTES

- 1. ALL WORK SHALL CONFORM TO THE REQUIREMENTS OF THE LOCAL BUILDING CODE, THE LATEST EDIT AND ALL OTHER APPLICABLE CODES AND ORDINATES.
- 2. CONTRACTOR SHALL VISIT THE JOB SITE TO BECOME FAMILIAR HIMSELF WITH ALL CONDITIONS AFFECTING THE PROPOSED WORK AND SHALL MAKE PROVISIONS AS TO THE COST THEREOF. CONTRACTOR SHALL ALSO BE RESPONSIBLE TO BECOME FAMILIAR WITH THE CONTRACT DOCUMENTS, FIELD CONDITIONS AND DIMENSIONS AND CONFIRMING THAT THE WORK MAY BE ACCOMPLISHED AS SHOWN PRIOR TO PROCEEDING WITH CONSTRUCTION. ANY DISCREPANCIES SHALL BE BROUGHT TO ATTENTION OF THE ENGINEER OF RECORD PRIOR TO THE COMMENCEMENT OF WORK. NO COMPENSATION WILL BE AWARDED BASED ON CLAIM OF LACK OF THE KNOWLEDGE OF THE FIELD CONDITIONS.
- 3. PLANS ARE NOT TO BE SCALED. THESE PLANS ARE INTENDED TO BE A DIAGRAMMATIC OUTLINE ONLY UNLESS OTHERWISE NOTED. THE WORK SHALL INCLUDE FURNISHING MATERIALS, EQUIPMENT AND APPURTENANCES, AND LABOR NECESSARY TO EFFECT ALL INSTALLATION AS INDICATED ON THE DRAWINGS. OWNER PROVIDED MATERIALS WILL INCLUDE THE FOLLOWING BUT NOT LIMITED TO, UNLESS NOTED OTHERWISE:
  - A) ANTENNAS B) RADIOS
  - C) TOWER-MOUNTED AMPLIFIERS (TMA)
  - D) MULTIPLEXERS E) CABLES (COAX, HCS, JUMPERS)
  - F) ENCLOSURES AND BASEBANDS
  - G) **m**ountings H) INTEGRATED LOAD CENTER
- 4. DIMENSIONS SHOWN ARE TO BE FINISH SURFACED UNLESS OTHERWISE NOTED. SPACING BETWEEN EQUIPMENT IS REQUIRED CLEARANCE. THEREFORE, IT IS CRITICAL TO FIELD VERIFY DIMENSIONS, SHOULD THERE BE ANY QUESTIONS REGARDING THE CONTRACT DOCUMENTS, EXISTING CONDITIONS AND/OR DESIGN INTENT, THE CONTRACTOR SHALL BE RESPONSIBLE FOR OBTAINING THE WORK.
- 5. DETAILS ARE INTENDED TO SHOW DESIGN INTENT. MODIFICATIONS MAY BE REQUIRED TO SUIT JOB DIMENSIONS OR CONDITIONS, AND SUCH MODIFICATIONS SHALL BE INCLUDED AS PART OF THE WORK
- 6. CONTRACTOR SHALL RECEIVE CLARIFICATION IN WRITING, AND SHALL RECEIVE IN WRITING AUTHORIZATION TO PROCEED BEFORE STARTING WORK ON ANY ITEMS NOT CLEARLY DEFINED OR IDENTIFIED BY THE CONTRACTOR DOCUMENTS.
- 7. CONTRACTOR SHALL SUPERVISE AND DIRECT THE WORK USING THE BEST CONSTRUCTION SKILLS AND ATTENTION. CONTRACTOR SHALL BE SOLELY RESPONSIBLE FOR CONSTRUCTION MEANS, METHODS, TECHNIQUES, SEQUENCES AND PROCEDURES AND FOR COORDINATING ALL PORTIONS OF THE WORK UNDER CONTRACT, UNLESS OTHERWISE NOTED.
- 8. CONTRACTOR SHALL BE RESPONSIBLE FOR THE SAFETY OF THE WORK AREA, ADJACENT AREAS AND BUILDING OCCUPANTS THAT ARE LIKELY TO BE AFFECTED BY THE WORK UNDER THIS CONTRACT. WORK SHALL CONFORM TO ALL OSHA REQUIREMENTS.
- 9. CONTRACTOR SHALL COORDINATE HIS WORK WITH THE SUPERINTENDENT OF BUILDINGS & GROUNDS AND SCHEDULE HIS ACTIVITIES AND WORKING HOURS IN ACCORDANCE WITH THE REQUIREMENTS.
- 10. CONTRACTOR SHALL BE RESPONSIBLE FOR COORDINATING THIER WORK WITH THE WORK OF OTHERS AS IT MAY RELATE TO RADIO EQUIPMENT, ANTENNAS AND ANY OTHER PORTION OF THE WORK.
- 11. INSTALL ALL EQUIPMENT AND MATERIALS IN ACCORDANCE WITH MANUFACTURERS RECOMMENDATIONS UNLESS SPECIFICALLY OTHERWISE INDICATED OR WHERE LOCAL CODES OR REGULATIONS TAKE PRECEDENCE.
- 12. MAKE NECESSARY PROVISIONS TO PROTECT EXISTING SURFACES, EQUIPMENT, IMPROVEMENTS PIPING ETC. AND IMMEDIATELY REPAIR ANY DAMAGE THAT OCCURS DURING CONSTRUCTION.
- 13. IN DRILLING HOLES INTO CONCRETE WHETHER FOR FASTENING OR ANCHORING PURPOSED, OR PENETRATIONS THROUGH THE FLOOR FOR CONDUIT RUNS, PIPE RUNS, ETC., MUST BE CLEARLY UNDERSTOOD THAT REINFORCING STEEL SHALL NOT BE DRILLED INTO, CUT OR DAMAGED UNDER ANY CIRCUMSTANCES (UNLESS NOTED OTHERWISE). LOCATIONS OF REINFORCING STEEL ARE NOT DEFINITELY KNOWN AND THEREFORE MUST BE SEARCHED FOR BY APPROPRIATE METHODS AND FQUIPMENT
- 14. REPAIR ALL EXISTING WALL SURFACES DAMAGED DURING CONSTRUCTION SUCH THAT THEY MATCH AND BLEND IN WITH ADJACENT SURFACES.
- 15. SEAL PENETRATIONS THROUGH FIRE RATED AREA WITH U.L. LIST AND FIRE CODE APPROVED MATERIALS.
- 16. KEEP CONTRACT AREA CLEAN, HAZARD FREE, AND DISPOSE OF ALL DIRT, DEBRIS, AND RUBBISH, FOUIPMENT NOT SPECIFIED AS REMAINING ON THE PROPERTY OF THE OWNER SHALL BE REMOVED. LEAVE PREMISE IN CLEAN CONDITION AND FREE FROM PAINT SPOTS, DUST, OR SMUDGES OF ANY NATURE. CONTRACTOR SHALL BE RESPONSIBLE FOR MAINTAINING ALL ITEMS UNTIL COMPLETION OF CONSTRUCTION.
- 17. MINIMUM BEND RADIUS OF ANTENNA CABLES SHALL BE IN ACCORDANCE WITH CABLE MANUFACTURERS RECOMMENDATIONS.
- 18. ALL EXISTING INACTIVE SEWER, WATER, GAS ELECTRIC, AND OTHER UTILITY, WHICH INTERFERE WITH THE EXECUTION OF THE WORK, SHALL BE REMOVED AND/OR CAPPED, PLUGGED OR OTHERWISE DISCONTINUED AT POINTS WHICH WILL NOT INTERFERE WITH THE EXECUTION OF THE WORK, SUBJECT TO APPLICABLE REGULATORY AUTHORITIES.
- 19. CONTRACTOR SHALL MINIMIZE DISTURBANCE TO EXISTING SITE DURING CONSTRUCTION. EROSION CONTROL MEASURES, IF REQUIRED DURING CONSTRUCTION SHALL BE IN CONFORMANCE WITH JURISDICTION OR STATE AND LOCAL GUIDELINES FOR EROSION AND SEDIMENT CONTROL AND COORDINATE WITH LOCAL REGULATORY AUTHORITIES.
- 20. ALL CONSTRUCTION IS TO ADHERE TO T-MOBILE INTEGRATED CONSTRUCTION STANDARDS UNLESS CALIFORNIA CODE IS MORE STRINGENT.
- 21. THE INTENT OF THE PLANS AND SPECIFICATIONS TO PERFORM THE CONSTRUCTION IN ACCORDANCE WITH THE CALIFORNIA BUILDING STANDARDS CODE, TITLES 19 AND 24, CALIFORNIA CODE OF REGULATIONS SHALL ANY CONDITIONS DEVELOP NOT COVERED BY THE APPROVED PLANS AND SPECIFICATIONS WHEREIN THE FINISHED WORK WILL NOT COMPLY WITH TITLE 24, CALIFORNIA CODE OF REGULATIONS, A CHANGE ORDER DETAILING AND SPECIFYING THE REQUIRED WORK SHALL BE SUBMITTED TO AND APPROVED BY THE JURISDICTION BEFORE PROCEEDING WITH THE WORK.

- FACILITIES.

### SITE WORK NOTES

- UTILITIES.

- AVAILAB LE.

- LOCATION.

### GENERAL RF NOTES:

1. ALL ANTENNAS AND ANTENNA CABLES SHALL BE FURNISHED BY THE CELL CARRIER AND INSTALLED BY ANTENNA INSTALLATION CONTRACTOR.

2. PRIOR TO INSTALLATION OF ANTENNAS, THE CONTRACTOR SHALL VERIFY THAT THE AZIMUTH AND DIMENSIONS SHOWN ON THE PLANS MATCH ACTUAL FIELD CONDITIONS.

3. ANTENNA INSTALLATION CONTRACTOR SHALL PROVIDE ALL CONDUIT, CABLE TRAYS, GROUND KITS, CLAMPS, GROUNDS, ETC., FOR COMPLETE INSTALLATION OF ANTENNAS AND CABLES SHOWN AND INTENDED AS REQUIRED FOR A COMPLETE OPERATING SYSTEM IN ACCORDANCE WITH T-MOBILE WIRELESS STANDARDS.

4. ANTENNA CONDUIT SHALL INCLUDE FACTORY-MADE LARGE RADIUS SWEEPS AT ALL CHANGES IN DIRECTION. SWEEP RADIOS SHALL BE AS REQUIRED TO MEET COAX MANUFACTURER'S MINIMUM BENDING RADIUS.

5. ALL UNDERGROUND CONDUIT SHALL BE SCHEDULE 40 PVC WITH STEEL BENDS. ALL EXPOSED CONDUIT ABOVE GRADE LEVEL SHALL BE IMC (INTERMEDIATE METAL CONDUIT) OR RIGID GALVANIZED. ALL EXPOSED CONDUIT PROTECTED IN A BUILDING OR ON A ROOF SHALL BE EMT (ELECTRICAL METALLIC TUBING) OR UV-STABILIZED, PAINTED, SCHEDULE 80 PVC.

6. IN HIGH TRAFFIC AREAS OR WHERE SUSCEPTIBLE TO DAMAGE, CONTRACTOR SHALL PROVIDE FORMED 14-GA GALVANIZED SHEET METAL COVER OVER COAXIAL CABLE ROUTES. WHERE CABLE IS RUN ON THE WALL, ATTACH UNISTRUT TO WALL AND COVER WITH 14-GA GALVANIZED FORMED SHEET METAL COVER OR MATERIAL AS DIRECTED BY T-MOBILE WIRELESS PROJECT MANAGER.

7. VERIFY ROUTE AND LENGTH OF CABLE PRIOR TO CUTTING. ADJUST INDICATED ROUTE AS REQUIRED TO CLEAR EXISTING OBSTRUCTIONS AND MAINTAIN REQUIRED CLEARANCE FROM EXISTING EQUIPMENT AND

8. MAXIMUM LENGTH OF 7/8" COAXIAL CABLE SHALL BE 140 FEET. MAXIMUM LENGTH OF 1-5/8" COAXIAL CABLE SHALL BE 240 FEET.

9. VERIFY MODEL NUMBERS OF ANTENNAS WITH T-MOBILE WIRELESS SERVICES.

10. THE CONTRACTOR SHALL PROVIDE TESTING OF ANTENNAS AND SHALL PROVIDE DOCUMENTATION TO THE CELL CARRIER PROJECT MANAGER.

11. INSTALL EMBOSSED ALUMINUM IDENTIFICATION TAGS AT THE END OF THE MAIN COAXIAL CABLE RUNS, ALONG WITH THE END OF THE JUMPER CABLE LOCATED WITHIN THE PLINTH SECTION OF THE BTS UNIT.

12. MATERIALS IN FRONT AND SIDE OF ANTENNAS MUST BE RF TRANSPARENT TO MINIMIZE PIM ISSUES.

13. MAKE SURE THERE'S NO RUST ON COMPONENTS AND NO LOOSE CONNECTIONS.

14. ENSURE THERE ARE NO PIM ISSUES DURING INSTALLATION.

15. ANTENNAS CANNOT SHOOT INTO METAL, OTHER OPERATOR ANTENNAS, ANYTHING THAT CAN CAUSE PIM, ETC. 16. NO ANTENNA SHADOWING. ALL ANTENNAS ARE TO BE CO-PLANAR.

17. ANTENNAS AND RADIOS CANNOT TOUCH THE FRP SCREEN.

18. IF THERE IS A PARAPET WALL, THE BOTTOM OF ALL ANTENNAS MUST BE ABOVE THE HIGHEST POINT.

19. CALL OUT THE USE OF THE CONCEALFAB PIM SHIELD KIT.

1. DO NOT EXCAVATE OR DISTURB THE PROPERTY LINES OR LEASE LINES, UNLESS OTHERWISE NOTED. 2. DO NOT SCALE BUILDING DIMENSIONS FROM DRAWING.

3. SIZE, LOCATION AND TYPE OF ANY UNDERGROUND UTILITIES OR IMPROVEMENTS SHALL BE

ACCURATELY NOTED AND PLACED ON AS-BUILT DRAWINGS BY GENERAL CONTRACTOR AND ISSUED TO ARCHITECT/ENGINEER AT COMPLETION OF PROJECT.

4. ALL EXISTING UTILITIES, FACILITIES, CONDITIONS AND THEIR DIMENSIONS SHOWN ON PLANS HAVE BEEN PLOTTED FROM AVAILABLE RECORDS. THE ENGINEER AND OWNER ASSUME NO RESPONSIBILITY WHATSOEVER AS TO THE SUFFICIENCY OR ACCURACY OF THE INFORMATION SHOWN ON THE PLANS OR THE MANNER OF THEIR REMOVAL OR ADJUSTMENT. CONTRACTOR SHALL BE RESPONSIBLE FOR DETERMINING EXACT LOCATION OF ALL EXISTING UTILITIES AND FACILITIES PRIOR TO START OF CONSTRUCTION. CONTRACTOR SHALL ALSO OBTAIN FROM EACH UTILITY COMPANY DETAILED INFORMATION RELATIVE TO WORKING SCHEDULES AND METHODS OF REMOVING OR ADJUSTING EXISTING

5. CONTRACTOR SHALL VERIFY ALL EXISTING UTILITIES BOTH HORIZONTALLY AND VERTICALLY PRIOR TO START OF CONSTRUCTION. ANY DISCREPANCIES OR DOUBTS AS TO THE INTERPRETATION OF PLANS SHALL BE IMMEDIATELY REPORTED TO THE ARCHITECT/ENGINEER FOR SOLUTION AND INSTRUCTION, AND NO FURTHER WORK SHALL BE PERFORMED UNTIL THE DISCREPANCY IS CHECKED AND CORRECTED BY THE ARCHITECT/ENGINEER. FAILURE TO SECURE SUCH AS INSTRUCTION MEANS CONTRACTOR WILL HAVE WORKED AT HIS/HER OWN RISK AND EXPENSE. CONTRACTOR SHALL CALL LOCAL DIGGER HOT LINE FOR UTILITY LOCATIONS 48 HOURS PRIOR TO CONSTRUCTION.

6. ALL NEW AND EXISTING UTILITY STRUCTURES ON SITE AND IN AREAS TO BE DISTURBED BY CONSTRUCTION SHALL BE ADJUSTED TO FINISH ELEVATIONS PRIOR TO FINAL INSPECTION OF WORK.

7. GRADING OF THE SITE WORK AREA IS TO BE SMOOTH AND CONTINUOUS IN SLOPE AND IS TO FEATHER INTO EXISTING GRADES AT THE GRADING LIMITS.

8. ALL TEMPORARY EXCAVATIONS FOR THE INSTALLATION OF FOUNDATIONS, UTILITIES, ETC. SHALL BE PROPERLY LAID BACK OR BRACED IN ACCORDANCE WITH CORRECT OCCUPATIONAL SAFETY AND HEALTH ADMINISTRATION (OSHA) REQUIREMENTS.

9. STRUCTURAL FILLS SUPPORTING PAVEMENT SHALL BE COMPACTED TO 95% OF MAXIMUM STANDARD PROCTOR DRY DENSITY.

10. NEW GRADES NOT IN BUILDING AND DRIVEWAY IMPROVEMENT AREA TO BE ACHIEVED BY FILLING WITH APPROVED CLEAN FILL AND COMPACTED TO 95% OF STANDARD PROCTOR DENSITY.

11. ALL FILLS SHALL BE PLACED IN UNIFORM LIFTS. THE LIFTS THICKNESS SHOULD NOT EXCEED THAT WHICH CAN BE PROPERLY COMPACTED THROUGHOUT ITS ENTIRE DEPTH WITH THE EQUIPMENT

12. ALL FILLS PLACED ON EXISTING SLOPES THAT ARE STEEPER THAN 10 HORIZONTAL TO 1 VERTICAL SHALL BE PROPERLY BENCHED INTO THE EXISTING SLOPE AS DIRECTED BY A GEO-TECHNICAL ENGINEER.

13. CONTRACTOR SHALL CLEAN ENTIRE SITE AFTER CONSTRUCTION SUCH THAT NO PAPERS, TRASH, WEEDS, BRUSHES OR ANY OTHER DEPOSITS WILL REMAIN. ALL MATERIALS COLLECTED DURING CLEANING OPERATIONS SHALL BE DISPOSED OF OFF-SITE BY THE GENERAL CONTRACTOR.

14. ALL TREES AND SHRUBS WHICH ARE NOT IN DIRECT CONFLICT WITH THE IMPROVEMENTS SHALL BE PROTECTED BY THE GENERAL CONTRACTOR.

15. ALL SITE WORK SHALL BE CAREFULLY COORDINATED BY GENERAL CONTRACTOR WITH LOCAL UTILITY COMPANY, TELEPHONE COMPANY, AND OTHER UTILITY COMPANIES HAVING JURISDICTION OVER THIS

### ENVIRONMENTAL NOTES

- 1. ALL WORK PERFORMED SHALL BE DONE IN ACCORE SHALL BE RESPONSIBLE FOR PAYMENT OF FINES AN
- 2. CONTRACTOR AND/OR DEVELOPER SHALL BE RESPO OF EROSION AND SEDIMENTATION CONTROLS DURING PROPERTIES, ROADWAYS AND WATERWAYS AND SHALL JURISDICTIONAL INSPECTION & RELEASE OF SITE.
- 3. CONTRACTOR SHALL INSTALL/CONSTRUCT ALL NECES PROTECTIVE MEASURES WITHIN THE LIMITS OF SITE
- 4. NO SEDIMENT SHALL BE ALLOWED TO EXIT THE PROF TAKING ADEQUATE MEASURED FOR CONTROLLING ERC MAY BE REQUIRED IN ANY AREAS SUBJECT TO EROS
- 5. THE CONTRACTOR IS RESPONSIBLE FOR MAINTAINING WITH SILT AND EROSION CONTROL MEASURES MAINTA DRAINAGE. ANY DAMAGE TO ADJACENT PROPERTY A THE CONTRACTOR EXPENSE.
- 6. CONTRACTOR SHALL BE RESPONSIBLE FOR DAILY INS CONTROL MEASURES INCLUDING SEDIMENT REMOVAL
- 7. CLEANING OF VEGETATION AND TREE REMOVAL SHALL MINIMUM. ONLY TREES NECESSARY FOR CONSTRUCT
- 8. SEEDING AND MULCHING AND/OR SODDING OF THE POSSIBLE AFTER COMPLETION OF THE PROJECT FAC
- 9. CONTRACTOR SHALL PROVIDE ALL EROSION AND SEE LOCAL, COUNTY AND STATE CODES AND ORDINANCE AND PREVENT ACCUMULATION OF SOIL AND SILT IN CONSTRUCTION AREA. THIS MAY INCLUDE SUCH MEA BARRIERS, AND CHECK DAMS.
- 10. RIP RAP OF SIZES INDICATED SHALL CONSIST OF C QUALITY STONE FREE OF ANY DETRIMENTAL QUANTITY LAMINATED PIECES, DISINTEGRATED MATERIAL, ORGAN SUB STANCES.

### FOUNDATION, EXCAVATION AND BACKFIL

- 1. ALL FINAL GRADED SLOPES SHALL BE A MAXIMUM 2. ALL EXCAVATIONS PREPARED FOR PLACEMENT OF C SUBSTANTIALLY HORIZONTAL AND FREE FROM ANY I AND WITHOUT THE PRESENCE OF POUNDING WATER.
- BE PROVIDED WHEN REQUIRED. COMPACTION OF SC NOT BE LESS THAN 95% OF THE MODIFIED PROCTOF ACCORDANCE WITH ASTM D1557. 3. CONCRETE FOUNDATIONS SHALL NOT BE PLACED ON INADEQUATE BEARING CAPACITY IS REACHED AT THE
- UNSATISFACTORY SOIL SHALL BE EXCAVATED TO ITS MECHANICALLY COMPACTED GRANULAR MATERIAL OR CONCRETE OF SAME TYPE SPECIFIED FOR THE FOU STABILIZE THE BOTTOM OF THE EXCAVATION. ANY SUBSTITUTE FOR REQUIRED THICKNESS OF CONCRET
- 4. ALL EXCAVATIONS SHALL BE CLEAN OF UNSUITABLE AND ALSO FORTH PRIOR TO BACK FILLING. BACK SUCH AS EARTH, LOAM, SANDY CLAY, SAND, AND G LARGE STONES OVER 2-1/2" MAX DIMENSION. ALL LAYERS.
- 5. ALL FILL MATERIALS AND FOUNDATION BACK FILL SI BEFORE COMPACTION. EACH LIFT SHALL BE WETT THAN 95% OF THE MODIFIED PROCTOR MAXIMUM DR'
- 6. NEWLY PLACED CONCRETE FOUNDATION SHALL CURE BACK-FILL.
- 7. FINISHED GRADING SHALL BE SLOPED TO PROVIDE THE FINAL (FINISH) ELEVATION OF SLAB FOUNDATION THE CENTER. FINISH GRADE OF CONCRETE PADS FINISH GRADE ELEVATIONS. PROVIDE SURFACE FILL WHERE REQUIRED.
- 8. NEWLY GRADED SURFACE AREAS TO RECEIVE GRAVE TYPE: TYPAR-3401 AS MANUFACTURED BY "CONST APPROVED EQUIVALENT, SHOWN ON PLANS. THE GE CONTROL THE RECURRENCE OF VEGETATIVE GROWN SITE FENCING OR ELECTRICAL GROUNDING SYSTEM SHALL BE COVERED WITH A MINIMUM OF 4" DEEP FDOT TYPE NO. 57 FOR FENCED COMPOUND, FDOT
- 9. IN ALL AREAS TO RECEIVE FILL, REMOVE ALL VEGETA UNSATISFACTORY SOIL MATERIALS, OBSTRUCTIONS, AI HORIZONTAL SUCH AS THAT FILL MATERIAL WILL BINE
- 10. WHEN SUB-GRADE OR PREPARED GROUND SURFACE THE FILL MATERIAL, SCARIFY THE GROUND SURFACE MOISTURE-CONDITION AND/OR AERATE THE SOIL AND TO PLACEMENT OF FILLS.
- 11. IN AREAS WHICH EXISTING GRAVEL SURFACING IS RE OPERATIONS, REPLACE GRAVEL SURFACING TO MATC TO THE SAME THICKNESS AND COMPACTION AS SPE SHALL BE FREE FROM CORRUGATIONS AND WAVES.
- 12. EXISTING GRAVEL SURFACING MAY BE EXCAVATED SI ANY UNFAVORABLE AMOUNTS OF ORGANIC MATTER, PRIOR TO REUSED. FURNISH ANY ADDITIONAL GRAV PROVIDE A FULL DEPTH COMPACTED SURFACE THRO
- 13. GRAVEL SUB SURFACE SHALL BE PREPARED TO REQUIRED COMPACTION AND SUB GRADE ELEVATIONS BEFORE GRAVEL SURFACING IS PLACED AND/OR RESTORED. ANY LOOSE OR DISTURBED MATERIALS SHALL BE THROUGHOUT COMPACTED AND ANY DEPRESSIONS IN THE SUB-GRADE SHALL BE FILLED AND COMPACTED WITH APPROVED SELECTED MATERIAL. GRAVEL SURFACING MATERIAL SHALL NOT USED FOR FILLING DEPRESSIONS IN THE SUB-GRADE.
- 14. PROTECT EXISTING GRAVEL SURFACING AND SUB-GRADE IN AREAS WHERE EQUIPMENT LOADS WILL OPERATE. USE PLANKING 'MATTS' OR OTHER SUITABLE PROTECTION DESIGNED TO SPREAD EQUIPMENT LOADS AS MAY BE NECESSARY. REPAIR ANT DAMAGE TO EXISTING GRAVEL. SURFACING OR SUB-GRADE WHERE SUCH DAMAGE IS DUE TO THE CONTRACTOR'S OPERATIONS.
- 15. DAMAGE TO EXISTING STRUCTURES AND/OR UTILITIES RESULTING FROM CONTRACTOR'S NEGLIGENCE SHALL BE REPAIRED AND/OR REPLACED TO OWNER'S SATISFACTION AT NO ADDITIONAL COST TO THE CONTRACT.
- 16. ALL SUITABLE BORROW MATERIAL FOR BACKFILL OF THE SITE SHALL BE INCLUDED IN THE BID. EXCESS TOPSOIL AND UNSUITABLE MATERIAL SHALL BE DISPOSED OF OFF-SITE AT LOCATIONS APPROVED BY GOVERNING AGENCIES AT NO ADDITIONAL COST TO THE CONTRACT.

DANCE WITH ISSUED PER <b>M</b> ITS. THE CONTRACTOR ND PROPER CLEAN UP FOR AREAS IN VIOLATION.
ONSIBLE FOR CONSTRUCTION AND MAINTENANCE G CONSTRUCTION FOR PROTECTION OF ADJACENT L BE MAINTAINED IN PLACE THROUGH FINAL
SSARY SEDI <b>M</b> ENT/SILT CONTROL FENCING AND DISTURBANCE PRIOR TO CONSTRUCTION.
DPERTY. THE CONTRACTOR IS RESPONSIBLE FOR OSION. ADDITIONAL SEDI <b>M</b> ENT CONTROL FENCING DSION.
G POSITIVE DRAINAGE ON THE SITE AT ALL TI <b>m</b> es "Ained on the downstrea <b>m</b> side of site as a result of erosion will be corrected at
NSPECTIONS AND ANY REPAIRS OF ALL SEDI <b>m</b> ent As necessary.
L BE ONLY AS PER <b>m</b> itted and be held to a Ction of the facilities shall be re <b>m</b> oved.
SITE WILL BE ACCOMPLISHED AS SOON AS CILITIES AFFECTING LAND DISTURBANCE.
DIMENTATION CONTROL MEASURES AS REQUIRED BY es to protect embankments from soil loss streams and drainage paths leaving the asures as silk fences, straw bale sediment
CLEAN, HARD, SOUND, DURABLE, UNIFOR <b>m</b> in Y of soft, friable, thin, elongated or NIC <b>m</b> atter, oil, alkali, or other deleterious
L NOTES
OF 3 HORIZONTAL TO 1 VERTICAL.
CONCRETE SHALL BE OF UNDISTURBED SOIL, DOSE, UNSUITABLE MATERIAL OR FROZEN SOILS, DEWATERING FOR EXCESS GROUND WATER SHALL DILS UNDER CONCRETE PAD FOUNDATIONS SHALL DR MAXIMUM DRY DENSITY FOR THE SOIL IN
N ORGANIC OR UNSUITABLE MATERIAL. IF e designed excavation depth, the 5 full depth and either be replaced with 7 the excavation shall be filled with 1ndation. Crushed stone May be used to 8 stone sub-base Material, if used, shall not 9 stone sub-base Material, if used, shall not
E MATERIAL SUCH AS VEGETATION, TRASH, DEBRIS, —FILL SHALL CONSIST OF APPROVED MATERIAL GRAVEL, OR SOFT SHALE, FREE FROM CLODS OR _ BACK FILL SHALL BE PLACED IN COMPACTED
HALL BE PLACED IN MAXIMUM 6" THICK LIFTS ED IF REQUIRED AND COMPACTED TO NOT LESS RY DENSITY FOR SOIL IN ACCORDANCE WITH ASTM
E A MINIMUM OF 72 HOURS PRIOR TO
POSITIVE DRAINAGE AND PREVENT STANDING WATER. N SHALL SLOPE AWAY IN ALL DIRECTIONS FROM SHALL BE A MINIMUM OF 4 INCHES ABOVE . GRAVEL TO ESTABLISH SPECIFIED ELEVATIONS
TL SHALL BE COVERED WITH GEOTEXTILE FABRIC RUCTION MATERIAL 1-800-239-384" OR AN EOTEXTILE FABRIC SHALL BE BLACK IN COLOR TO AND EXTEND TO WITHIN 1 FOOT OUTSIDE THE PERIMETER WHICH EVER IS GREATER. ALL FABRIC COMPACTED STONE OR GRAVEL AS SPECIFIED, I.E. TYPE NO.67 FOR ACCESS DRIVE AREA.
ATION, TOPSOIL, DEBRIS, WET AND AND DELETERIOUS MATERIALS FROM VERTICAL TO 4 ND WITH EXISTING/PREPARED SOIL SURFACE.
E HAS A DENSITY LESS THAN THAT REQUIRED FOR E TO DEPTH REQUIRED, PULVERIZE, ID RECO <b>M</b> PACT TO THE REQUIRED DENSITY PRIOR
REMOVED OR DISTURBED DURING CONSTRUCTION TH ADJACENT GRAVEL SURFACING AND RESTORED ECIFIED. ALL RESTORED GRAVEL SURFACING
EPARATELY AN REUSED WITH THE CONDITION THAT OR OTHER DELETERIOUS MATERIALS ARE REMOVED /EL RESURFACING MATERIAL AS NEEDED TO OUGHOUT SITE.

En	gineer:		
(			
		<b>GROUP</b> DWE ROAD, SUITE E	
		TINEZ, CA 94553 TheCBRGroup.com	
T-	Mobile ID:		
Sit	S e Name:	F40855A	
		HWY 20 GUNTL	Y
Sit	e Address:		
	6100 E	E SIDE POTTER	
P		ALLEY RD /ALLEY, CA 954	69
		,	
lss	ued For:	ISTRUCTION	
С	02/27/2024	PLAN CHECK COMMENTS	JD
В	12/28/2023	100%CDs FOR REVIEW	MS
A REV	11/17/2023 DATE	90%CDs FOR REVIEW DESCRIPTION	SF BY
Ju	risdiction:		
		ATION OF LAW FOR ANY PERSON, ARE ACTING UNDER THE DIRECTION	
		ED PROFESSIONAL ENGINEER, TO .TER THIS DOCUMENT.	
Lic	censor:		
	UNLESS THEY A	TION OF LAW FOR ANY PERSON, REACTING UNDER THE DIRECTION	
	Al	ED PROFESSIONAL ENGINEER, TO .TER THIS DOCUMENT.	
Sh	eet Title:		
	GEN	ERAL NOTES	

### STRUCTURAL STEEL

- 1. ALL STEEL WORK SHALL BE IN ACCORDANCE WITH STEEL CONSTRUCTION MANUAL, 15th EDITION AND ALL EXTERIOR EXPOSED STEEL AND HARDWARE SHALL BE HOT-DIPPED GALVANIZED. FILL MODIFICATIONS ARE TO BE COATED WITH ZINC-ENRICHED PAINT.
- 2. STEEL SECTIONS SHALL BE IN ACCORDANCE WITH THE FOLLOWING ASTM STANDARDS: -ANGLE, BARS, AND CHANNELS: ASTM A36, 36 KSI -W-SHAPES: ASTM 1992, 50 KSI -HSS SECTOR: ASTM A53-E, 35 KSI
- 3. ALL WELDING SHALL BE PERFORMED USING E70 (LOW HYDROGEN) ELECTRODES BY AWS CERTIFIED WELDERS. WELDING SHALL CONFORM TO AISC AND THE LATEST EDITION OF AWS D1.1. WHERE FILLET WELD SIZES ARE NOT SHOWN, PROVIDE THE MINIMUM SIZE PER TABLE J2.4 IN THE AISC "MANUAL OF STEEL CONSTRUCTION". PAINTED SURFACES SHALL BE TOUCHED UP.
- 4. NON-STRUCTURAL CONNECTIONS FOR STEEL GRATING MAY USE 5/8" DIA. ASTM A307 BOLTS UNLESS NOTED OTHERWISE. BOLTED CONNECTIONS SHALL BE ASTM A325 BEARING TYP. 3/4" DIA. CONNECTIONS AND SHALL HAVE MINIMUM OF TWO BOLTS UNLESS NOTED OTHERWISE.
- 5. CONTRACTOR SHALL COLD-GALVANIZE ALL RAW STEEL AS REQUIRED DURING CONSTRUCTION PROCESS.

### CONCRETE AND REINFORCEMENT STEEL

- 1. ALL CONCRETE WORK SHALL BE IN ACCORDANCE WITH ACI 318-16, ACI 301-16 AND THE CAST-IN-PLACE CONCRETE SPECIFICATIONS.
- 2. ALL CONCRETE SHALL HAVE A MINIMUM COMPRESSIVE STRENGTH OF 2,500 PSI AT 28 DAYS UNLESS NOTED OTHERWISE.
- 3. WELDED WIRE FABRIC SHALL CONFORM TO ASTM A185 WELDED STEEL WIRE FABRIC UNLESS NOTED OTHERWISE
- 4. REINFORCING STEEL SHALL CONFORM TO ASTM A615, GRADE 60, UNLESS NOTED OTHERWISE.
- 5. SPLICES CLASS "B" AND ALL HOOKS SHALL BE STANDARD UNLESS NOTED OTHERWISE.
- 6. A 3/4" CHAMFER SHALL BE PROVIDED AT ALL EXPOSED EDGES OF CONCRETE UNLESS NOTED OTHERWISE IN ACCORDANCE WITH ACI 301 SECTION 4.2.4.
- 7. CONCRETE COVER FOR REINFORCEMENT STEEL SHALL BE ACCORDING TO ACI 318-19, TABLE 20.6.1.3.1:

CONCRETE EXPOSURE	MEMBER	REINFORC E <b>M</b> ENT	SPECIFIED COVER, IN.
CAST AGAINST AND PER <b>M</b> ANENTLY IN CONTACT WITH GROUND	ALL	ALL	3
EXPOSED TO WETHER OR IN		NO.6 THROUGH NO.18 BARS	2
CONTACT WITH GROUND	ALL	NO. 5 BAR, W31 OR D31 WIRE, AND S <b>M</b> ALLER	1-1/2
	SLABS, JOISTS, AND WALLS –	NO. 14 AND NO.18 BARS	1-1/2
NOT EXPOSED TO WEATHER OR IN CONTACT WITH		NO.11 BAR AND S <b>m</b> aller	3/4
GROUND	BEAMS, COLUMNS PEDESTALS, AND TENSION TIES	PRIMARY REINFORCEMENT, STIRRUPS, TIES, SPIRALS, AND HOOPS	1-1/2

### CONCRETE MASONRY

- 1. MORTAR SHALL BE HAVE TYPE "S" WITH A MINIMUM 1,800 PSI AT 28 DAYS. GROUT SHALL BE A MINIMUM COMPRESSIVE STRENGTH OF 2,000 PSI AT 28 DAYS AND ALL GROUT SHALL BE CONSOLIDATED WITH A MECHANICAL VIBRATOR.
- 2. CONCRETE MASONRY UNITS SHALL BE MEDIUM WEIGHT (115 PCF) UNITS CONFORMS TO ASTM C90, GRADE N—1, f'M OF 1,500 PSI.
- 3. ALL CELLS IN CONCRETE BLOCKS SHALL BE FILLED SOLID WITH GROUT, EXCEPT AS NOTED IN THE DRAWINGS OR SPECIFICATIONS. CELL SHALL BE IN VERTICAL ALIGNMENT. DOWELS IN FOOTINGS SHALL BE SET TO ALIGN WITH CORES CONTAINING STEEL. ALL BOND BEAM BLOCK SHALL BE "DEEP CUT" UNITS.
- 4. ALL CELLS CONTAINING REINFORCING STEEL OR EMBEDDED ITEMS AND ALL CELLS IN RETAINING WALLS AND WALLS BELOW GRADE SHALL BE SOLID GROUTED. ALL HORIZONTAL REINFORCING STEEL SHALL BE PLACED IN BOND OR LINTEL BEAM UNITS.
- 5. WHEN GROUTING IS STOPPED FOR ONE LONGER, HORIZONTAL CONSTRUCTION JOINTS SHALL BE FORMED BY STOPPING THE GROUT POUR 1-1/2" below top of the uppermost unit. Low lift CONSTRUCTION, MAXIMUM GROUT POUR HEIGHT IS 4 FEET.
- 6. PROVIDE INSPECTION AND CLEAN OUT HOLES AT BASE OF VERTICAL CELLS HAVING GROUT LIFTS IN EXCESS OF 4'-0" OF HEIGHT.
- 7. PROVIDE ONE BAR DIAMETER (A MINIMUM OF 1/2") GROUT BETWEEN MAIN REINFORCING AND MASONRY UNITS.
- 8. SAND SHALL BE CLEAN, SHARP AND WELL GRADED, AND FREE FROM INJURIOUS AMOUNTS OF DUST, LUMPS, SHALE, ALKAU OR ORGANIC MATERIAL.
- 9. BRICK SHALL CONFORM TO ASTM C-62 AND SHALL BE GRADE MW OR BETTER.

### PAINTING NOTES:

- 1. ALL PAINT PRODUCT LINE SHALL BE "SHERWIN-WILLIAMS" OR EQUAL UNLESS SPECIFICALLY NOTED OTHERWISE.
- 2. CONTRACTOR SHALL PREPARE ALL SURFACES AND APPLY ALL FINISHES PER LATEST EDITION OF MANUFACTURER'S SPECIFICATIONS.
- 3. FINISH COLOR AND TEXTURE OF ALL SURFACES TO BE PAINTED SHALL MATCH ADJACENT SURFACES UNLESS NOTED OTHERWISE.
- 4. ALL PAINT MATERIAL DATA SHEET SHALL BE PROVIDED TO THE CELL CARRIER CONSTRUCTION MANAGER.
- 5. CONTRACTOR SHALL CORRECT RUNS, SAGS, MISSES, AND OTHER DEFECTS INCLUDING INADEQUATE COVERAGE AS DIRECTED BY THE T-MOBILE CONSTRUCTION MANAGER. REPAINT AS NECESSARY TO ACHIEVE SURFACES WHICH ARE SMOOTH, EVENLY COATED WITH UNIFORM SHEEN AND FREE FROM BLEMISHES.

- MAINTAINED.

### **PENETRATION AT FIRE-RATED ASSEMBLIES NOTES:**

### **ROOF & WATERPROOFING NOTES:**

1. CONTRACTOR SHALL CONTACT THE BUILDING OWNER TO DETERMINE IF ROOF IS UNDER WARRANTY. CONTRACTOR SHALL GUARANTEE THAT ANY AND ALL NEW ROOFING WORK MEETS THE SPECIFICATION OF ANY EXISTING ROOFING WARRANTIES SUCH THAT THE WARRANTY IS NOT MADE INVALID AS A RESULT OF THIS WORK. IF IT IS DETERMINED THAT THE ARCHITECT'S DETAILING IS INADEQUATE OR IMPROPER OR IF ANY OTHER DISCRPANCY IS FOUND, THE CONTRACTOR SHALL IMMEDIATELY NOTIFY THE ARCHITECT AND THE CLIENT PROJECT MANAGER IN WRITING. ULTIMATELY, THE CONTRACTOR SHALL BE RESPONSIBLE FOR COMPLYING WITH THE ORIGINAL ROOF MANUFACTURER'S SPECIFICATIONS.

2. CONTRACTOR SHALL USE METHODS AND MATERIALS SIMILAR AND COMPATIBLE WITH EXISTING MATERIALS AND CONDITIONS FOR ROOF PATCHING, NEW PENETRATIONS, ETC.

3. THE CONTRACTOR SHALL PROPERLY SEAL ALL NEW ROOF AND BUILDING ENVELOPE PENETRATIONS SUCH THAT THE INTEGRITY OF THE ORIGINAL BUILDING ASSEMBLY AND ALL APPLICABLE WARRANTIES ARE


4. IF DEEMED NECESSARY TO REMOVE EXISTING FINISHED AND/OR MATERIALS, THE CONTRACTOR SHALL BE RESPONSIBLE FOR RECONSTRUCTING FINISHES AND MATERIALS TO LIKE-NEW CONDITIONS. CONTRACTOR SHALL MAINTAIN THE ORIGINAL COLORS, TEXTURES AND FINISHES UNLESS SPECIFICALLY NOTED TO THE CONTRARY OR APPROVED BY T-MOBILE CONSTRUCTION MANAGER IN ADVANCE.


5. AT THE CLIENT CONSTRUCTION MANAGER'S DISCRETION, THE CONTRACTOR SHALL PROVIDE ROOFTOP WALKPADS TO ALL NEW EQUIPMENT. ON CONVENTIONAL ROOFING, THE WALKPADS SHALL BE "DUCK BOARDS" AS MANUFACTURED BY 'APC' OR EQUAL. ON SPECIAL ROOFINT SYSTEMS SUCH AS SINGLE MEMBRANE, ROOFS WILL REQUIRE A SPECIFIC PRODUCT AS NOTED ON PLANS OR AS REQUIRED BY NOTES #1 & #2 ABOVE.

1. AT THE CLIENT PROJECT MANAGER'S DIRECTION, THE CONTRACTOR SHALL PROVIDE "HILTI" HIGH PERFORMANCE FIRESTOP SYSTEM #FS601 AT ALL FIRE-RATED PENETRATIONS INSTALLED PER MANUFACTURER'S LATEST INSTALLATION SPECIFICATIONS.


2. ALL PENETRATIONS THROUGH FIRE-RATED ASSEMBLIES SHALL BE CONSTRUCTED SO AS TO MAINTAIN AN EQUAL OR GREATER FIRE-RATING.

Prepared For: <b>TNobile</b> - 1200 CONCORD AVENUE, SUITE 500 CONCORD, CA 94520				
Eng	gineer:			
		тые		
		GROUP		
		OWE ROAD, SUITE E TINEZ, CA 94553		
		TheCBRGroup.com		
T-I	Mobile ID:	E 400E E A		
C:+		F40855A		
	e Name: US CELL-	HWY 20 GUNTL	Y	
Sit	e Address:			
		E SIDE POTTER ALLEY RD		
P		ALLEY KD /ALLEY, CA 954	169	
$\geq$			$\prec$	
Iss	ued For: CON	ISTRUCTION		
С	02/27/2024	PLAN CHECK COMMENTS	JD	
B	12/28/2023 11/17/2023	100%CDs FOR REVIEW 90%CDs FOR REVIEW	MS SF	
REV	DATE	DESCRIPTION	ВҮ	
$\geq$			$\prec$	
Ju	risdiction:			
	UNLESS THEY A OF A LICENS	ATION OF LAW FOR ANY PERSON, ARE ACTING UNDER THE DIRECTION ED PROFESSIONAL ENGINEER, TO	-	
		LTER THIS DOCUMENT.	$\prec$	
	ensor:			
IT IS A VIOLATION OF LAW FOR ANY PERSON, UNLESS THEY ARE ACTING UNDER THE DIRECTION				
$\leq$	OF A LICENS	ED PROFESSIONAL ENGINEER, TO TER THIS DOCUMENT.	$\leq$	
She	eet Title:			
	GEN	ERAL NOTES		
Sh	eet Numbe	er:	$\prec$	
5/1				
	G	<b>N-2</b>		
	V			

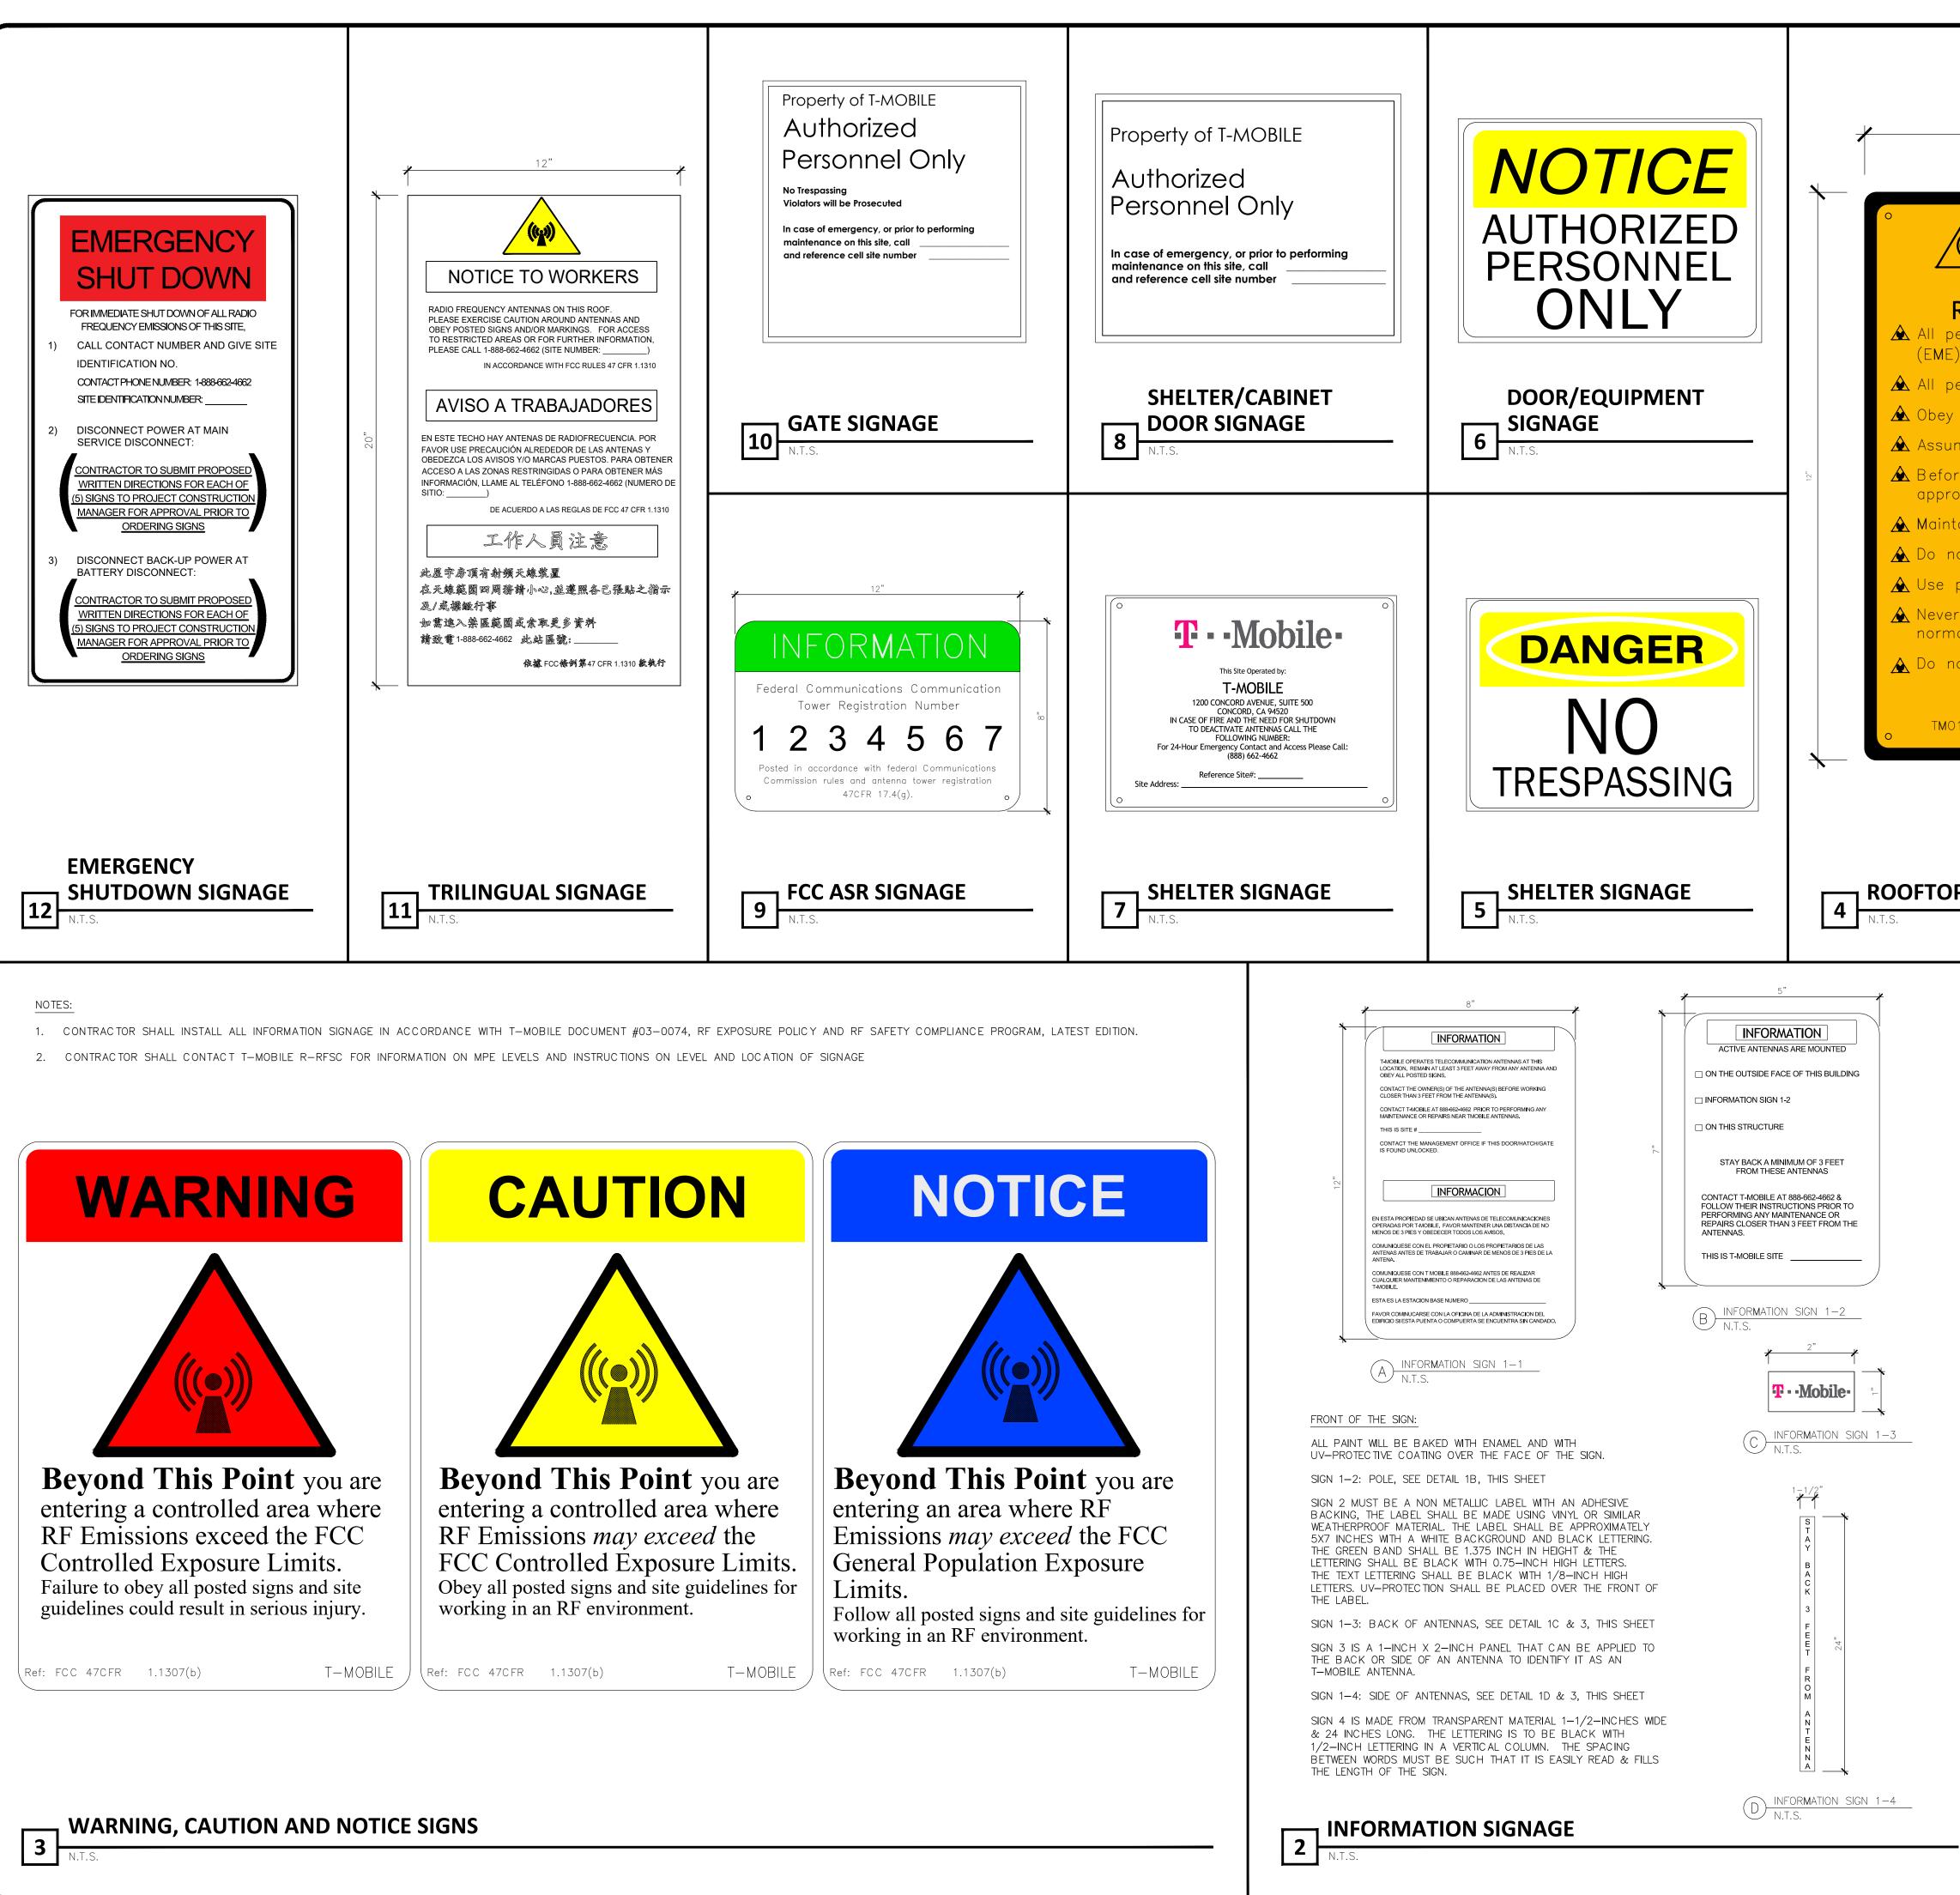

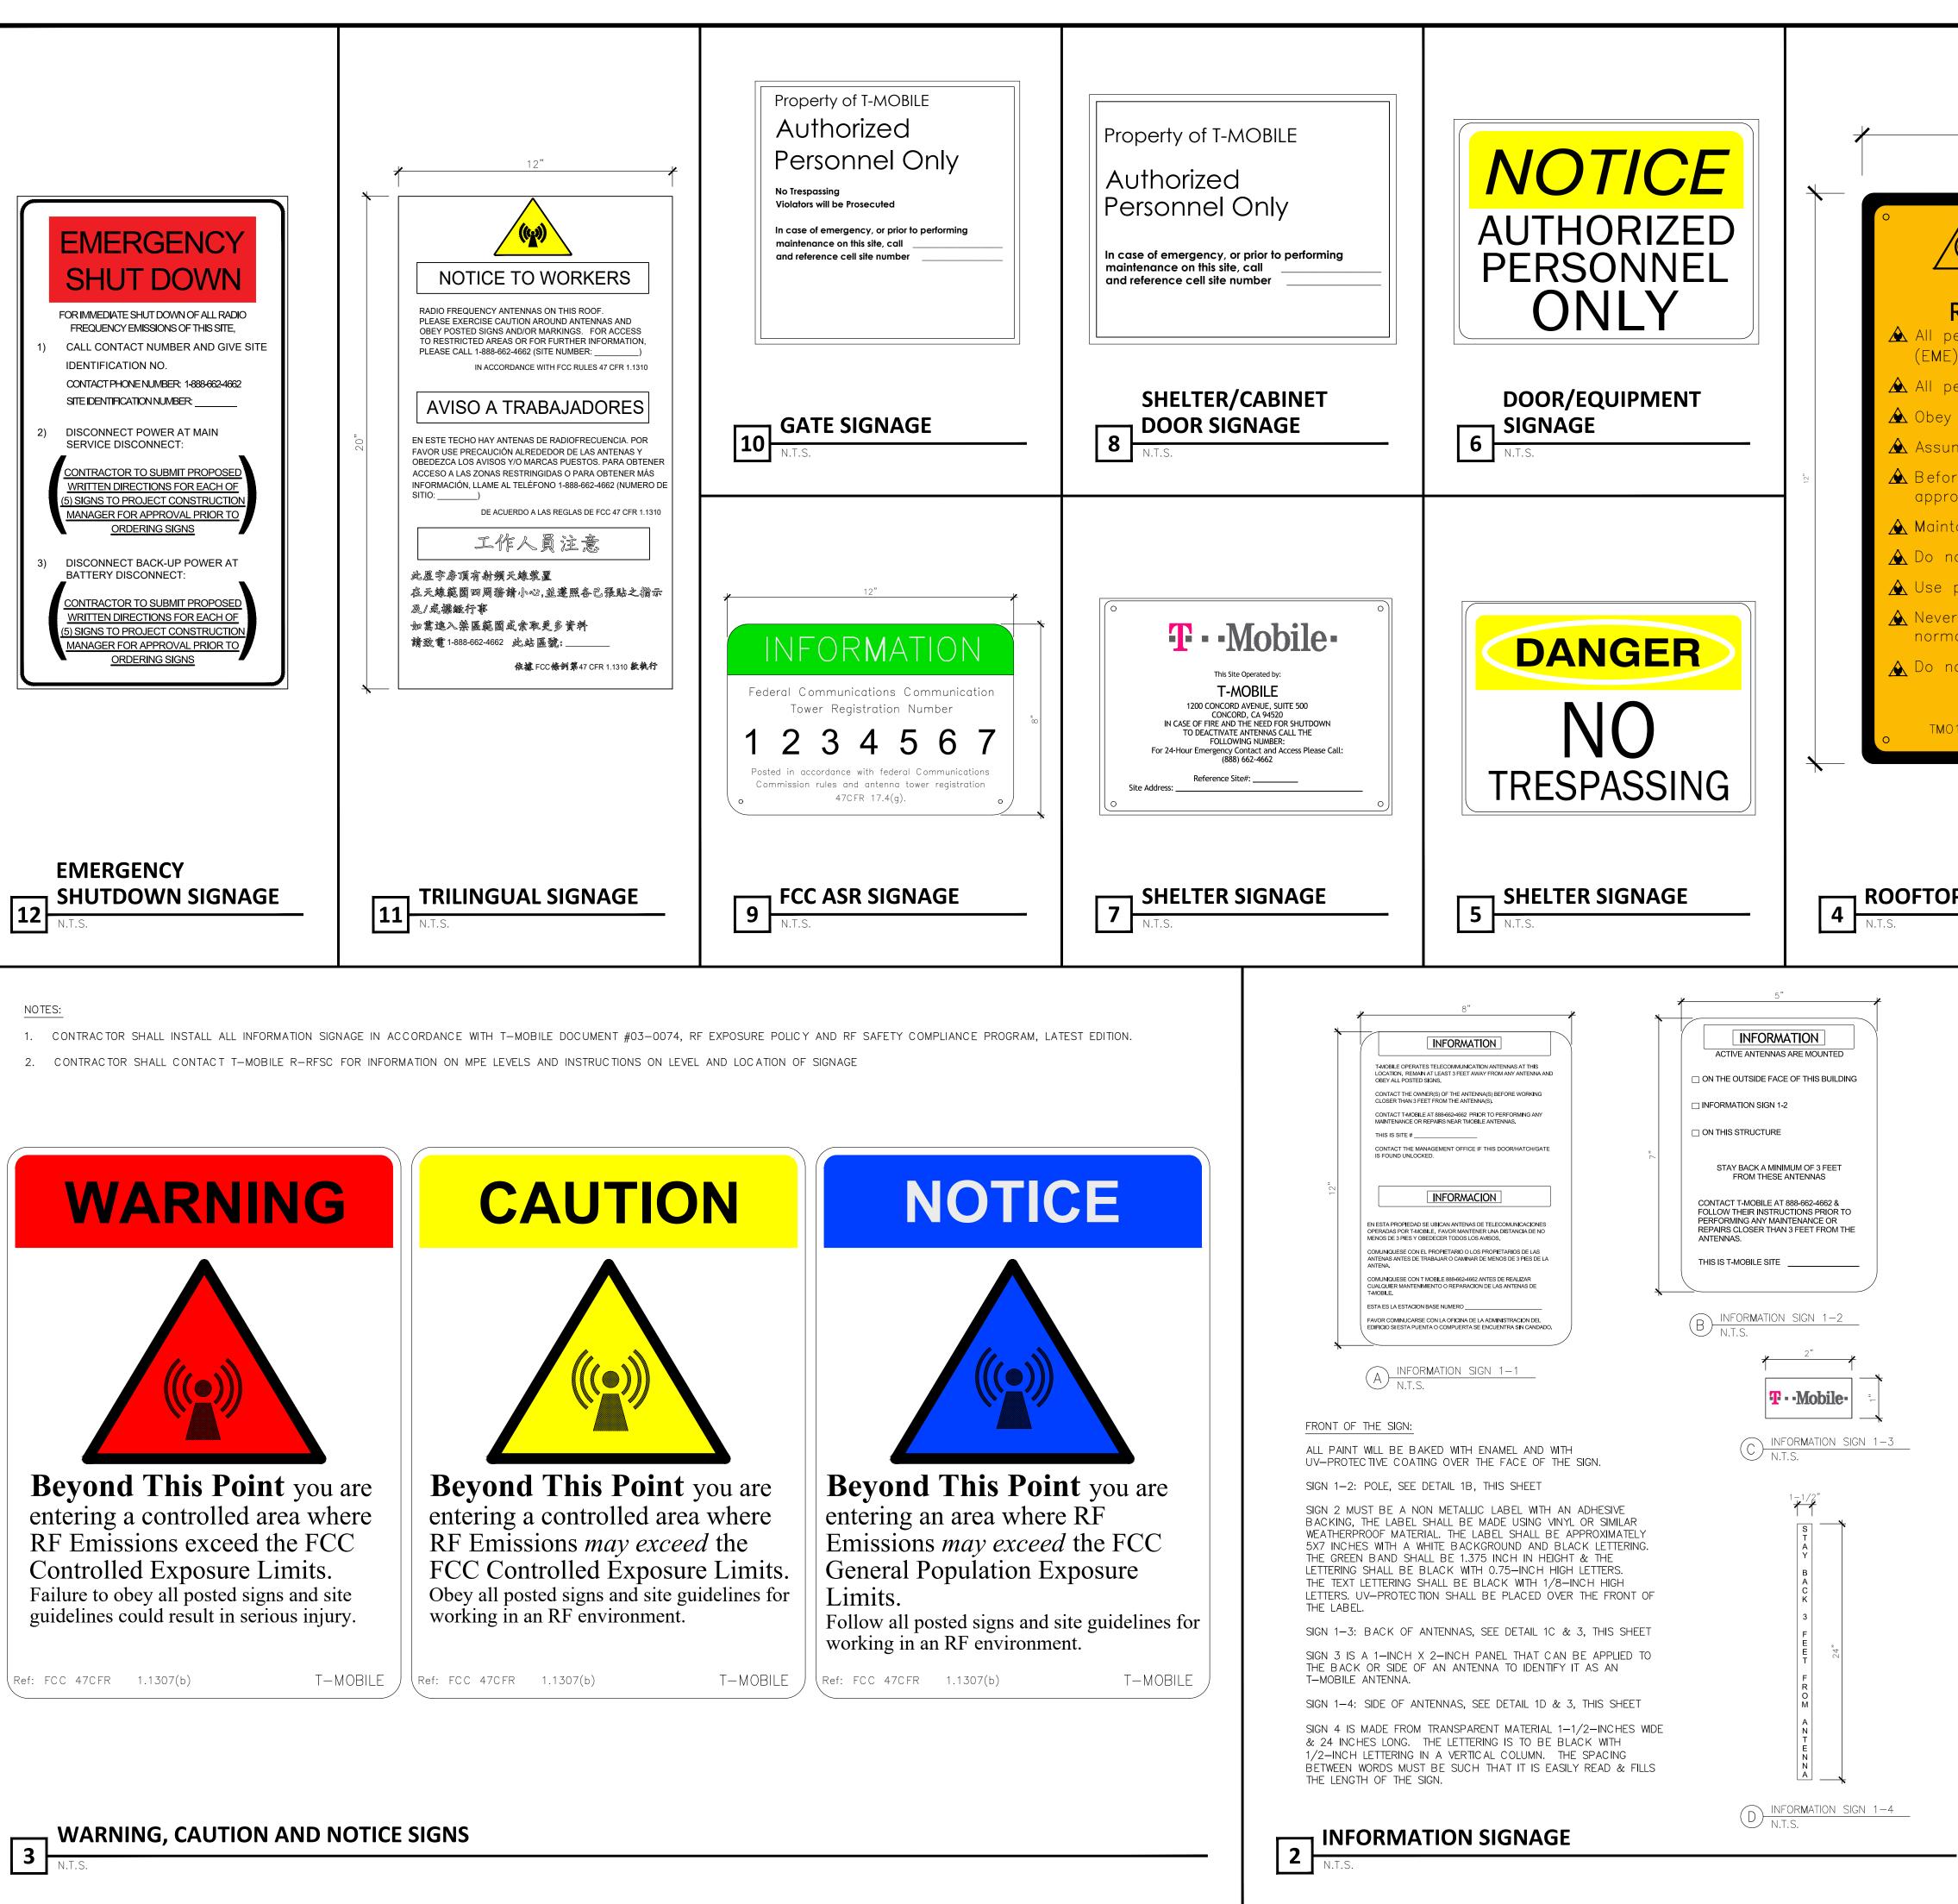

12"	Prepared For: <b>T</b> - <b>Nobile</b> - 1200 CONCORD AVENUE, SUITE 500 CONCORD, CA 94520
	Engineer:
GUIDELINES FOR WORKING IN RADIO FREQUENCY ENVIRONMENTS	THE
personnel should have electromagnetic energy E) awareness training.	GROUP
personnel entering this site must be authorized.	2840 HOWE ROAD, SUITE E MARTINEZ, CA 94553
ume all antennas are active.	www. TheCBRGroup.com
ore working on antennas, notify owners and disable ropriate transmitters.	T-Mobile ID: SF40855A
tain minimum 3 feet clearance from all antennas.	Site Name:
not stop in front of antennas. personal RF monitors while working near antennas.	US CELL-HWY 20 GUNTLY
er operate transmitters without shields during nal operation.	Site Address: 6100 E SIDE POTTER
not operate base station antennas in equipment room.	VALLEY RD POTTER VALLEY, CA 95469
For information contact: 877-611-5868	
	Issued For: CONSTRUCTION
P SIGNAGE	
SIGNAGE AND STRIPING INFOR <b>M</b> ATION	
1. THE FOLLOWING INFORMATION IS A GUIDELINE WITH RESPECT TO PREVAILING STANDARDS LIMITING HUMAN EXPOSURE TO RADIO FREQUENCY ENERGY AND SHOULD BE USED AS SUCH. IF THE SITE'S EME REPORT OR ANY LOCAL, STATE OR FEDERAL GUIDELINES OR REGULATIONS SHOULD BE IN CONFLICT WITH ANY PART OF THESE NOTES OR PLANS, THE MORE RESTRICTIVE GUIDELINE OR	
REGULATION SHALL BE FOLLOWED AND OVERRIDE THE LESSER. 2. THE PUBLIC LIMIT OF RF EXPOSURE ALLOWED BY T-MOBILE IS 1mWcm*2 AND THE OCCUPATIONAL LIMIT OF RF EXPOSURE ALLOWED BY T-MOBILE IS	C         02/27/2024         PLAN CHECK COMMENTS         JD           B         12/28/2023         100%CDs FOR REVIEW         MS           A         11/17/2023         90%CDs FOR REVIEW         SF
5mWcm*2. 3. IF THE BOTTOM OF THE ANTENNA IS MOUNTED 8 FEET ABOVE THE GROUND OR WORKING PLATFORM LINE OF THE PERSONAL COMMUNICATION SYSTEM (PCS) AND DOES NOT EXCEED THE PUBLIC LIMIT OF RF EXPOSURE LIMIT THEN NO STRIPING OR BARRICADES SHOULD BE NEEDED.	REV     DATE     DESCRIPTION     BY
4. IF THE PUBLIC LIMIT OF RF EXPOSURE ON THE SITE IS EXCEEDED AND THE AREA IS PUBLICLY ACCESSIBLE (E.G. ROOF ACCESS DOOR THAT CANNOT BE LOCKED, OR FIRE EGRESS) THEN BOTH BARRICADES AND STRIPING SHALL BE PLACED AROUND THE ANTENNAS. THE EXACT EXTENT OF THE BARRICADES AND STRIPING SHALL BE DETERMINED BY THE EME REPORT FOR THE SITE DONE BEFORE OR SHORTLY AFTER COMPLETION OF SITE CONSTRUCTION. USE THE PLANS AS A GUIDELINE FOR PLACEMENT OF SUCH BARRICADES AND STRIPING.	Jurisdiction:
5. ALL TRANSMIT ANTENNAS REQUIRE A THREE LANGUAGE WARNING SIGN WRITTEN IN ENGLISH, SPANISH, AND CHINESE. THIS SIGN SHALL BE PROVIDED TO THE CONTRACTOR AND THE T-MOBILE CONSTRUCTION PROJECT MANAGER AT THE TIME OF CONSTRUCTION. THE LARGER SIGN SHALL BE PLACED IN PLAIN SIGHT AT ALL ROOF ACCESS LOCATIONS AND ON ALL BARRICADES. THE SMALLER SIGN	IT IS A VIOLATION OF LAW FOR ANY PERSON,
SHALL BE PLACED ON THE ANTENNA ENCLOSURES IN A MANNER THAT IS EASILY SEEN BY ANY PERSON ON THE ROOF. WARNING SIGNS SHALL COMPLY WITH ANSI C95.2 COLOR, SYMBOL, AND CONTENT CONVENTIONS. ALL SIGNS SHALL	UNLESS THEY ARE ACTING UNDER THE DIRECTION OF A LICENSED PROFESSIONAL ENGINEER, TO ALTER THIS DOCUMENT.
HAVE T-MOBILE'S NAME AND THE COMPANY CONTACT INFORMATION (E.G. TELEPHONE NUMBER) TO ARRANGE FOR ACCESS TO THE RESTRICTED AREAS. THIS TELEPHONE NUMBER SHALL BE PROVIDED TO THE CONTRACTOR BY THE T-MOBILE CONSTRUCTION PROJECT MANAGER AT THE TIME OF CONSTRUCTION.	Licensor:
6. PHOTOS OF ALL STRIPING, BARRICADES AND SIGNAGE SHALL BE PART OF THE CONTRACTOR'S CLOSE-OUT PACKAGE AND SHALL BE TURNED INTO THE T-MOBILE CONSTRUCTION PACKAGE AND SHALL BE TURNED OVER TO THE T-MOBILE CONSTRUCTION PROJECT MANAGER AT THE END OF CONSTRUCTION. STRIPING SHALL BE DONE WITH FADE-RESISTANT YELLOW SAFETY PAINT IN A CROSS-HATCH PATTERN AS DETAILED BY THE CONSTRUCTION DRAWINGS. ALL	
BARRICADES SHALL BE MADE OF AN RF-FRIENDLY MATERIAL SO AS NOT TO BLOCK OR INTERFERE WITH THE OPERATION OF THE ANTENNAS. BARRICADES SHALL BE PAINTED WITH FADE-RESISTANT YELLOW SAFETY PAINT. THE CONTRACTOR SHALL PROVIDE ALL RF-FRIENDLY BARRICADES NEEDED, AND SHALL PROVIDE THE T-MOBILE CONSTRUCTION PROJECT MANAGER WITH A DETAILED	IT IS A VIOLATION OF LAW FOR ANY PERSON, UNLESS THEY ARE ACTING UNDER THE DIRECTION OF A LICENSED PROFESSIONAL ENGINEER, TO
SHOP DRAWING OF EACH BARRICADE UPON CONSTRUCTION COMPLETION.	ALTER THIS DOCUMENT. Sheet Title:
	SITE SIGNAGE
	Sheet Number:
GENERAL NOTES	
<b>1</b> N.T.S.	GN-3

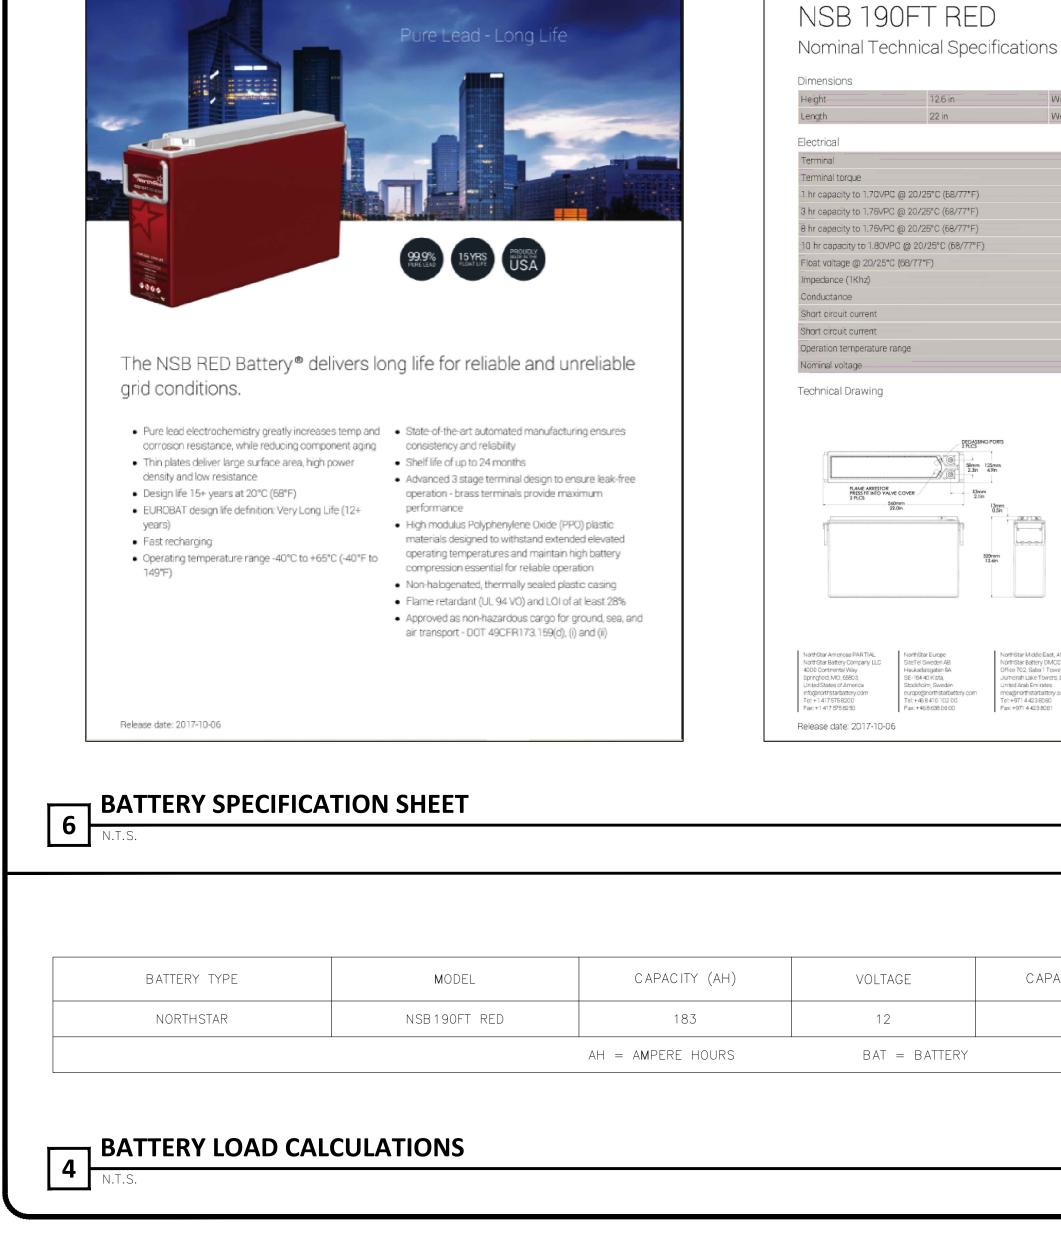

NSB 190FT RED

NorthStar

Height 12.6 in Width 22 in Weight 1.hr capacity to 1.70VPC @ 20/25°C (68/77°F) 3 hr capacity to 1.75VPC @ 20/25°C (68/77°F) 8 hr capacity to 1.75VPC @ 20/25°C (68/77°F) 10 hr capacity to 1.80VPC @ 20/25°C (68/77°F)


All NorthStar . 53mm Bellcore GR-63 13mm 0.5in standards; UL : A A ISO 9001 and I

CAPACITY


2.

	1. IDENTIFICATION			REVISION DATE: 01-31-18	
	Product Name: Lead Acid Battery, N	on-Spillable		Electric Storage Battery	
	Wet		Manufacturer LLC	/Supplier: NorthStar Battery, Co.,	
	Synonyms: Industrial Battery, Traction	Battery,		00 E. Continental	
	Stationary Battery, Deep Cycle Battery			ay, Springfield,	
	General Information Number: 417.57	5 8200		D 65803 Not Applicable	
4.9 in	General Information Number: 417.57	3.8200	CHEMTREC:		
123 lbs	2. GHS HAZARDS IDENTIFICA	TION			
	Health	E	nvironmental	Physical	
10-105	Acute		tic Chronic - 1	Explosive Chemical, Division 1.3	
//8 x 1.25	Toxicity (Oral/Darmal/Inhalation) Catagory		tic Acute - 1		
9 Ah	(Oral/Dermal/Inhalation) - Category 4 Skin Corrosion/Irritation - Category 1				
l Ah	Eye Damage - Category 1				
Ah	Reproductive - Category 1				
Ah	Carcinogenicity (lead) - Category 1 Carcinogenicity (arsenic) - Category 1				
VPC	Carcinogenicity (arisenic) - Category I Carcinogenicity (acid mist) - Category I				
25°C (77°F)	Specific Target Organ - Category				
	Toxicity (repeated exposure)				
· · · · ·	GHS Label: Health	Envi	ironmental	Dhusiaal	
		Env		Physical	
.65°C			¥	the	
	Hazard Statements	Pressutia	nary Statements		
	DANGER!		oughly after hand	dling.	
	Causes severe skin burns and eye	Do not eat	, drink or smoke	when using this product.	
	damage. Causes serious eye damage.		ective gloves/pro /face protection.	tective clothing, eye	
	May damage fertility or the unborn	Avoid brea			
iant with: Telcordia SR4228, IEC 60896; ish, German, and Russian telecorn	child if ingested or inhaled.	dust/fume/	/gas/mist/vapors/		
800 certified. NorthStar is registered to	May cause cancer if ingested or inhaled			ated area. Causes	
	Causes damage to central nervous system, blood and kidneys through		ion, serious eye o ith internal comp	iamage.	
	prolonged or repeated exposure.			t with internal acid.	
	May form explosive air/gas	Irritating to	o eyes, respirator	y system, and skin.	
	mixture during charging.				
	Extremely flammable gas (hydrogen). Explosive, fire, blast or projection hazar	d.			
	Emplorite, me, one of projecton mater				
	Date: 01-31-18 ECO-101808	ISO Clause:	431 DOM-S	SDS-430-00607-06 Page: 1 of 10	
	Date: 01-01-10 200-101006	ico ciause.			

(kWh)/BAT	# OF EXISITING BAT	# OF PROPOSED BAT	FINAL # OF BAT	kWh
196	0	12	12	26.35
kWh = KILOWATT HOURS			TOTAL kWh	26.35

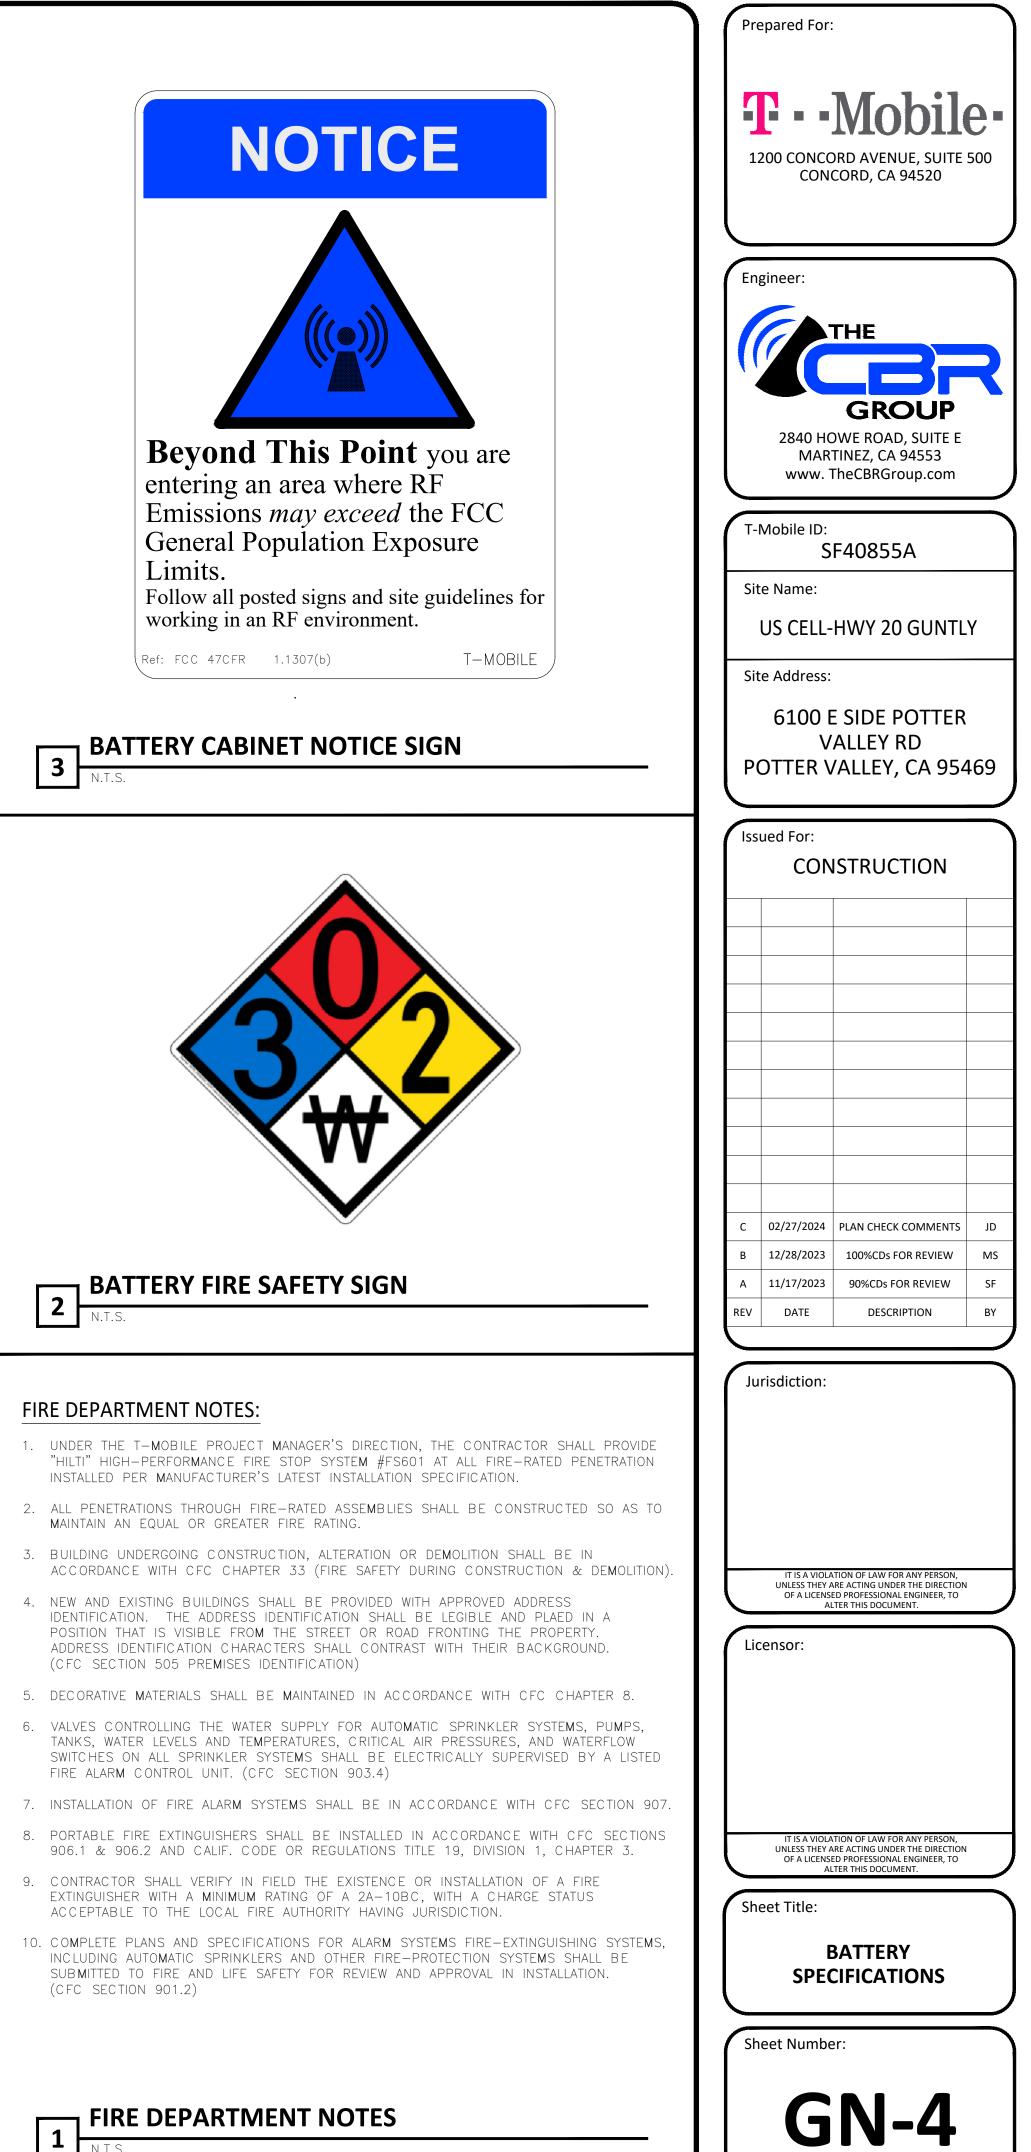

# **SYMBOLS & ABBREVIATIONS**

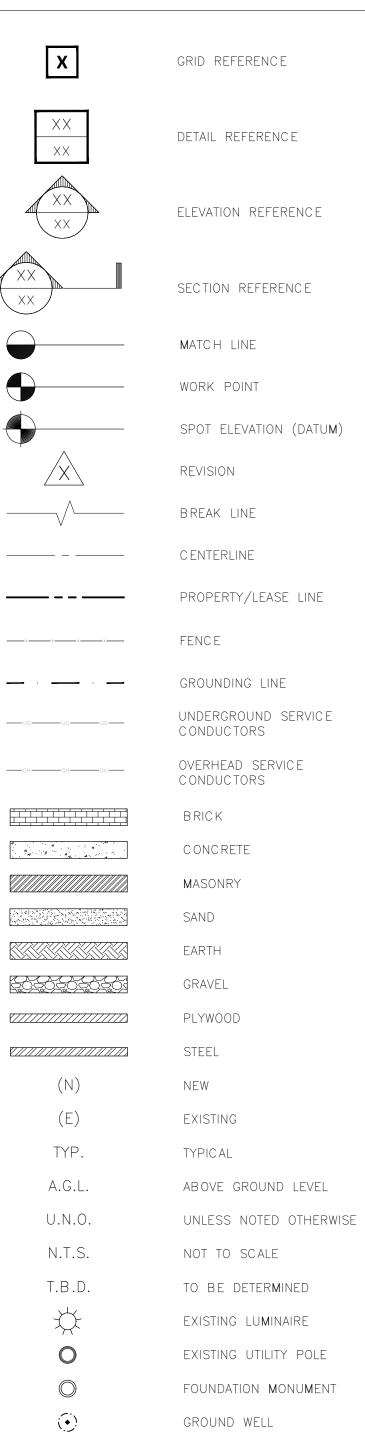


 $\triangle$ 

SET POINT


O° MAG. NORTH 240° 120°

- FIELD TEA**m**

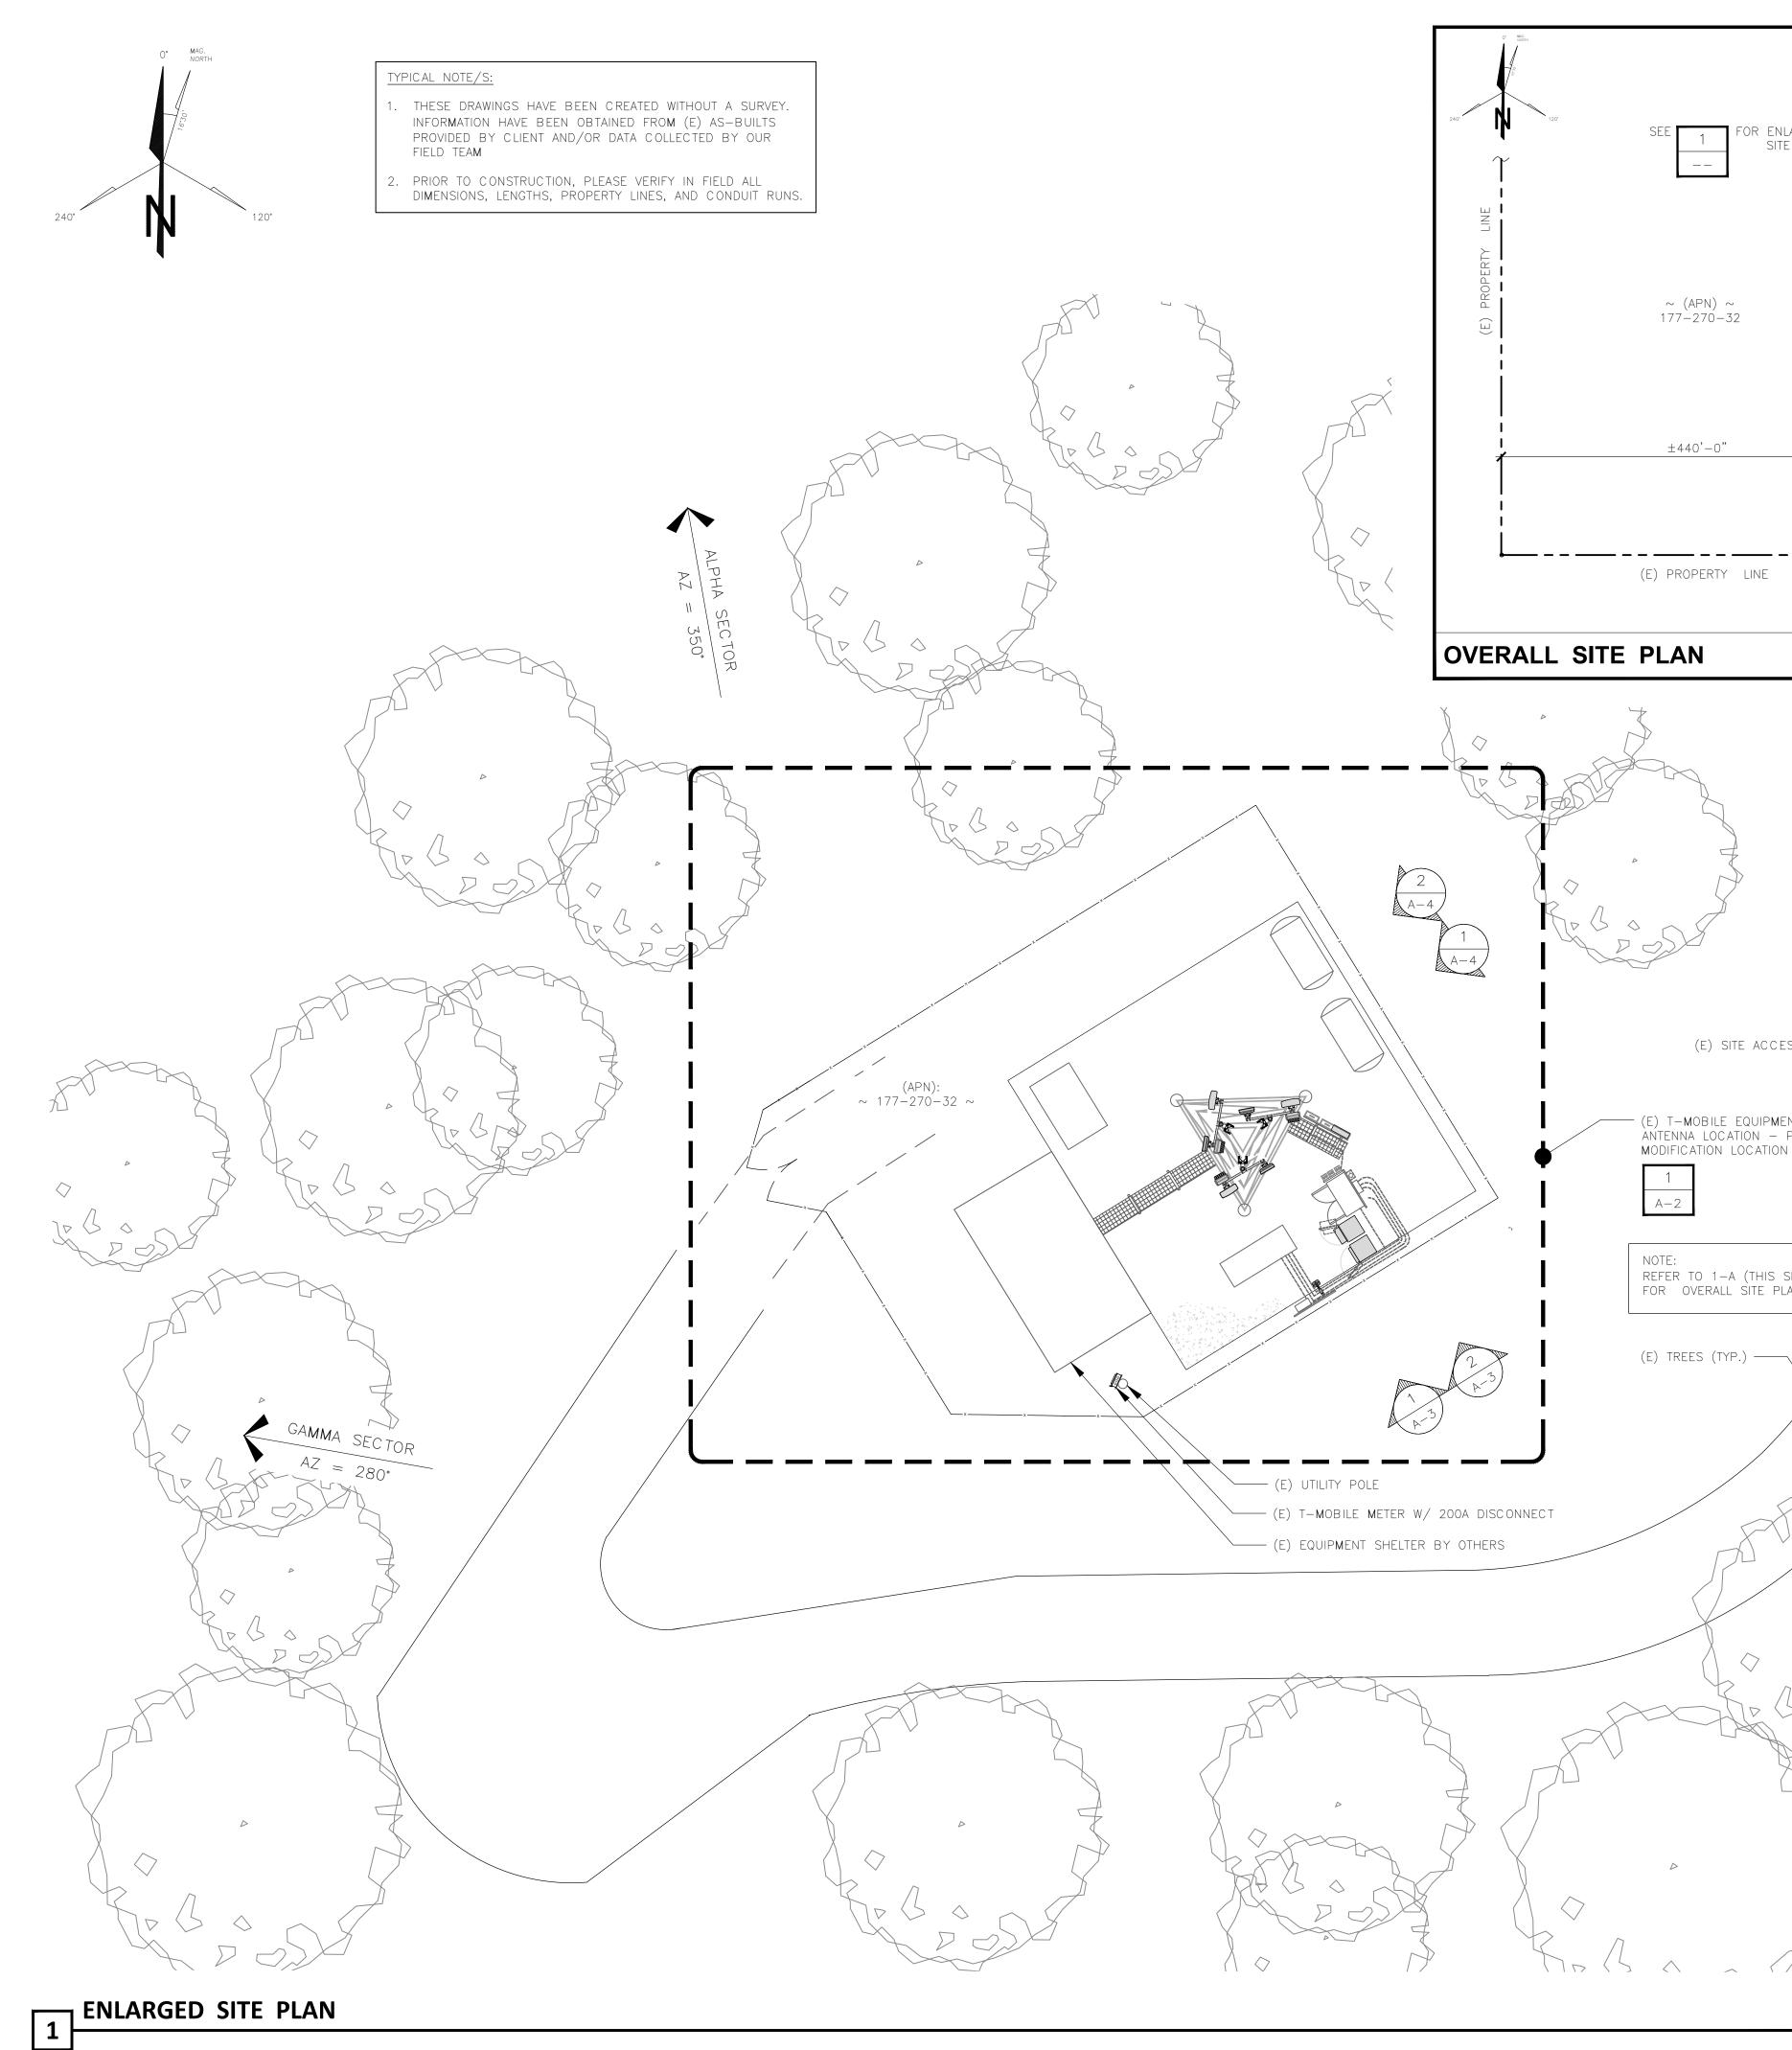


NLARGED		
		<u>_</u>
		саlе: =80'-0" <b>1-А</b>
	- Look	/
ESS DRIVE		
ENT AND PROPOSED		$\sim$
N		
SHEET) PLAN		
BETA SECTOR		
	SCALE: 1" = 10'-0" 0' 10'	20' 30


Pro	epared For:		
	_		
	<b>G</b> • •	Mobil	<b>e</b> •
1		DRD AVENUE, SUITE CORD, CA 94520	500
En	gineer:		
1		THE	
		GROUP	≺
		OWE ROAD, SUITE E TINEZ, CA 94553	
		TheCBRGroup.com	
T-	Mobile ID: S	F40855A	
	te Name:		
		HWY 20 GUNTL	Y
Sit	te Address: 6100 l	E SIDE POTTER	
P	V	ALLEY RD /ALLEY, CA 954	
		,	$\prec$
lss	ued For: CON	ISTRUCTION	
С	02/27/2024	PLAN CHECK COMMENTS	JD
B A	12/28/2023 11/17/2023	100%CDs FOR REVIEW 90%CDs FOR REVIEW	MS SF
REV	DATE	DESCRIPTION	ВҮ
Ju	risdiction:		
t	UNLESS THEY A OF A LICENS	ATION OF LAW FOR ANY PERSON, ARE ACTING UNDER THE DIRECTION ED PROFESSIONAL ENGINEER, TO LTER THIS DOCUMENT.	$ \exists$
Lie	censor:		$\overline{}$
t	UNLESS THEY A OF A LICENS	ATION OF LAW FOR ANY PERSON, ARE ACTING UNDER THE DIRECTION ED PROFESSIONAL ENGINEER, TO .TER THIS DOCUMENT.	
Sh	eet Title:		$\overline{\neg}$
		ERALL AND GED SITE PLAN	
Sh	ieet Numbe	er:	$\overline{}$
		1	
	F	<b>\-1</b>	

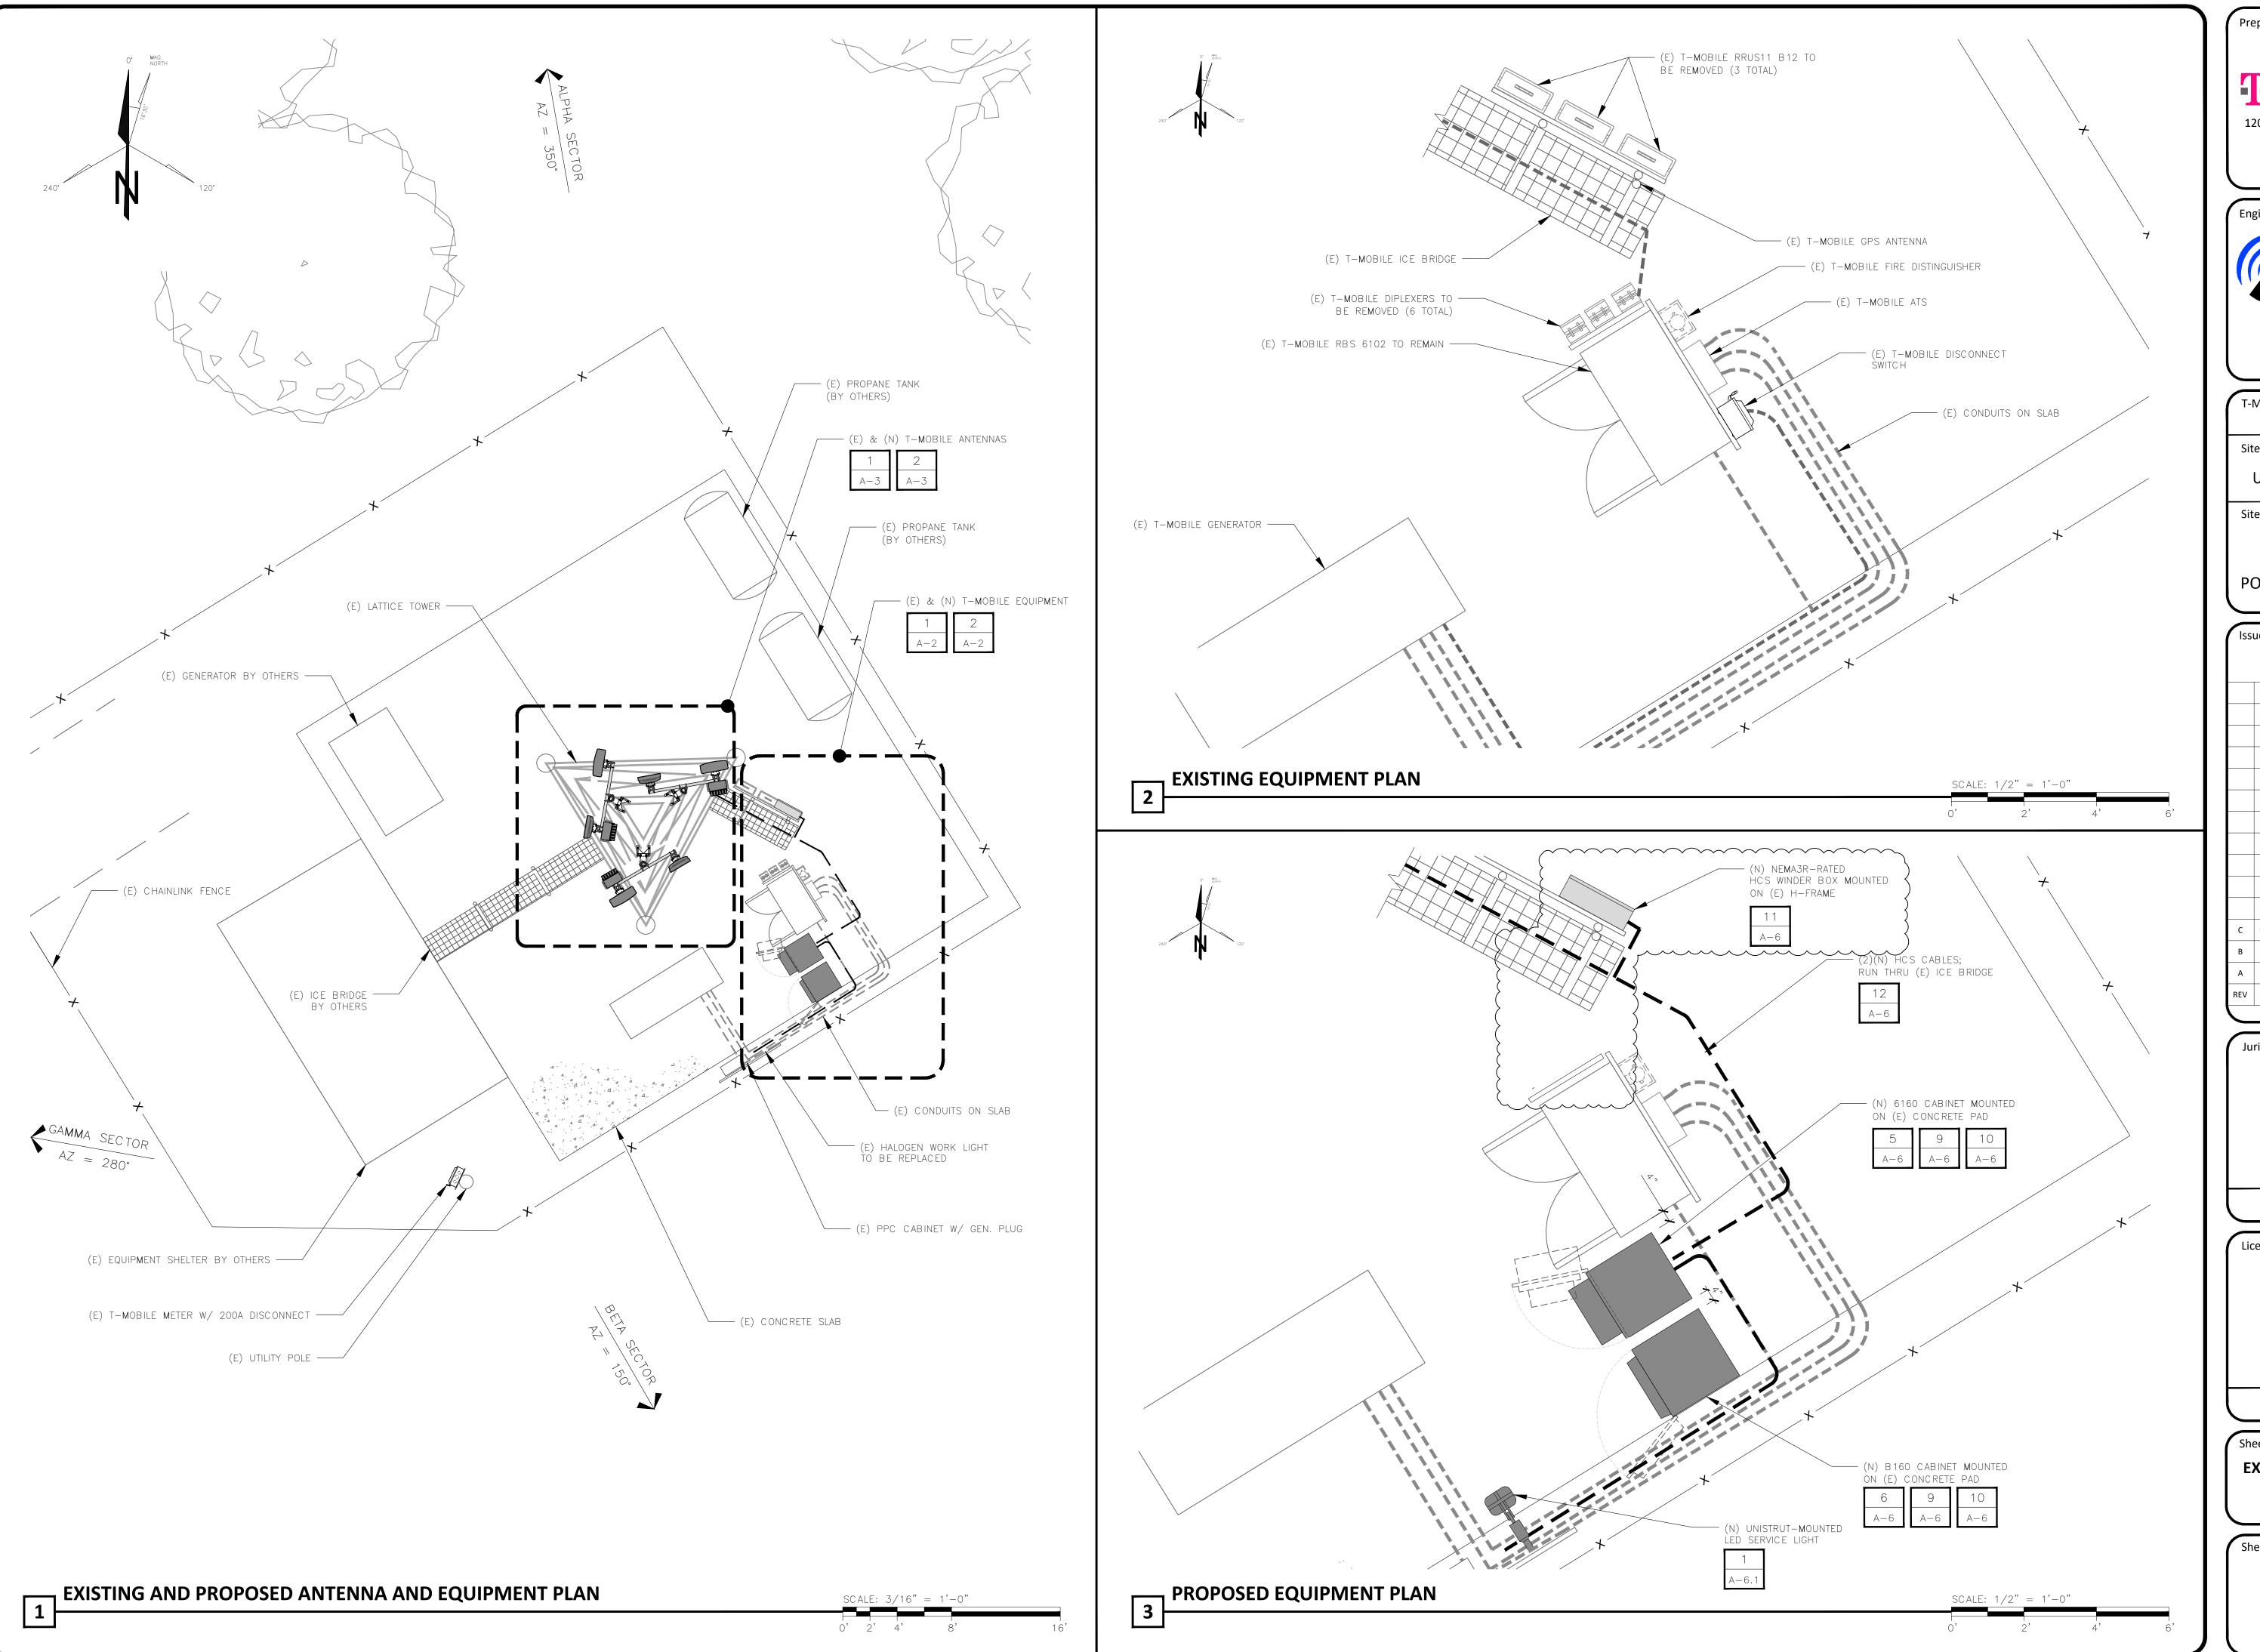


	epared For:		
	200 CONCO	<b>Mobil</b> ORD AVENUE, SUITE CORD, CA 94520	_
En	gineer:		$\leq$
	2840 HC MAR	THE GROUP OWE ROAD, SUITE E TINEZ, CA 94553 TheCBRGroup.com	2
(T-I	Mobile ID:		$\overline{}$
	e Name:	F40855A HWY 20 GUNTL	v
	e Address:		
	6100 8	E SIDE POTTER	
P		ALLEY RD /ALLEY, CA 954	69
			$\prec$
lss	ued For: CON	ISTRUCTION	
C B	02/27/2024	PLAN CHECK COMMENTS	JD MS
A	11/17/2023	90%CDs FOR REVIEW	SF
REV	DATE	DESCRIPTION	ВҮ
Ju	risdiction:		
C	UNLESS THEY A OF A LICENS	ATION OF LAW FOR ANY PERSON, ARE ACTING UNDER THE DIRECTION ED PROFESSIONAL ENGINEER, TO .TER THIS DOCUMENT.	$\mathcal{I}$
Lic	ensor:		
F	UNLESS THEY A OF A LICENS	NTION OF LAW FOR ANY PERSON, RE ACTING UNDER THE DIRECTION ED PROFESSIONAL ENGINEER, TO .TER THIS DOCUMENT.	
1	eet Title:		Ē
E	AN	AND PROPOS FENNA AND PMENT PLANS	ED
Sh	eet Numbe	er:	$\leq$
		<b>4-2</b>	

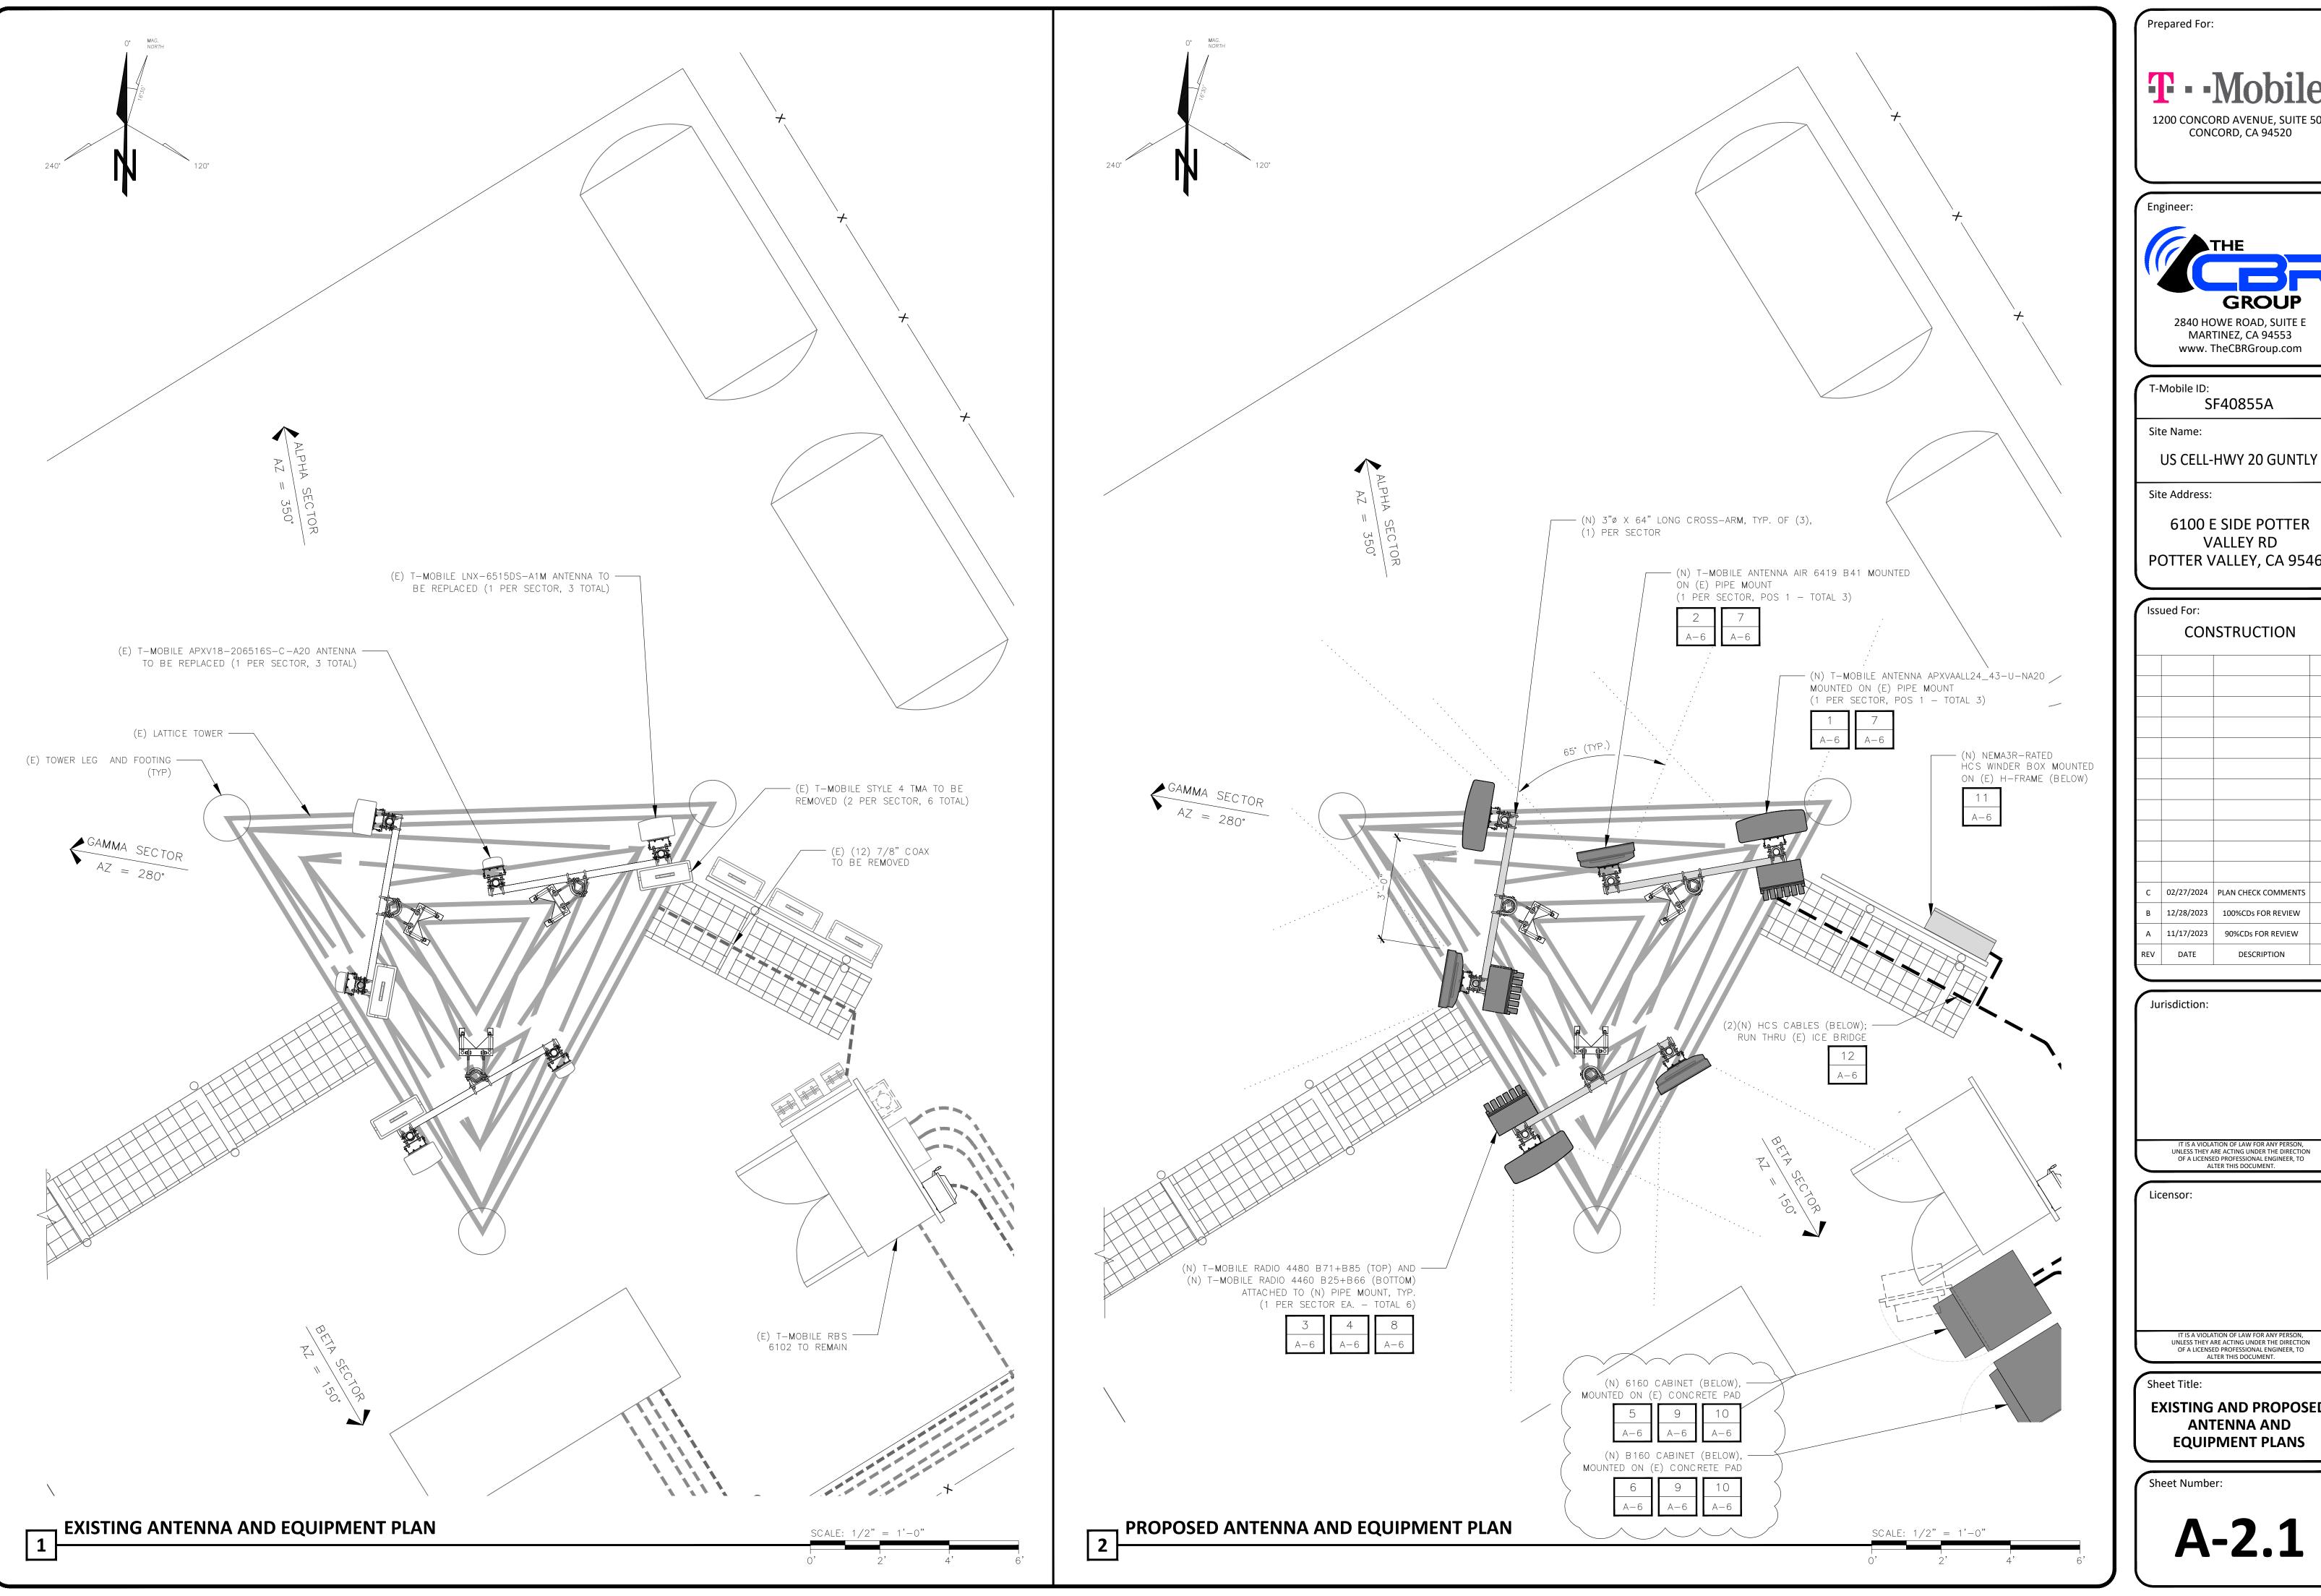

_			_				
Pre	epared For:						
	<b>T</b> · · Mobile ·						
		ORD AVENUE, SUITE CORD, CA 94520	500				
En	gineer:		$\prec$				
(		THE					
		GROUP	~				
	MAR	OWE ROAD, SUITE E TINEZ, CA 94553 TheCBRGroup.com					
	Mobile ID: S	F40855A	$\prec$				
Sit	e Name:						
		HWY 20 GUNTL	Y				
Sit		E SIDE POTTER					
P		ALLEY RD /ALLEY, CA 954	169				
Iss	ued For:		$\prec$				
	CON	ISTRUCTION					
С	02/27/2024	PLAN CHECK COMMENTS	JD				
B A	12/28/2023 11/17/2023	100%CDs FOR REVIEW 90%CDs FOR REVIEW	MS SF				
REV	DATE	DESCRIPTION	ВҮ				
Ju	risdiction:						
<u> </u>	UNLESS THEY A OF A LICENS	ITION OF LAW FOR ANY PERSON, IRE ACTING UNDER THE DIRECTION ED PROFESSIONAL ENGINEER, TO THE THIS DOCUMENT					
Lic	ensor:	TER THIS DOCUMENT.	$\leq$				
	.ug · -	TION OF LOWIS-					
	UNLESS THEY A OF A LICENSI	TION OF LAW FOR ANY PERSON, RE ACTING UNDER THE DIRECTION ED PROFESSIONAL ENGINEER, TO .TER THIS DOCUMENT.					
	eet Title: <b>XISTING</b>	AND PROPOS	ED				
		TENNA AND PMENT PLANS					
Sh	eet Numbe	er:	$\leq$				

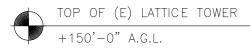

TOP OF (E) ANTENNAS +128'-10" A.G.L. TOP OF (E) ANTENNAS +126'-5" A.G.L. RAD CENTER OF (E) ANTENNA +125'-0" A.G.L.

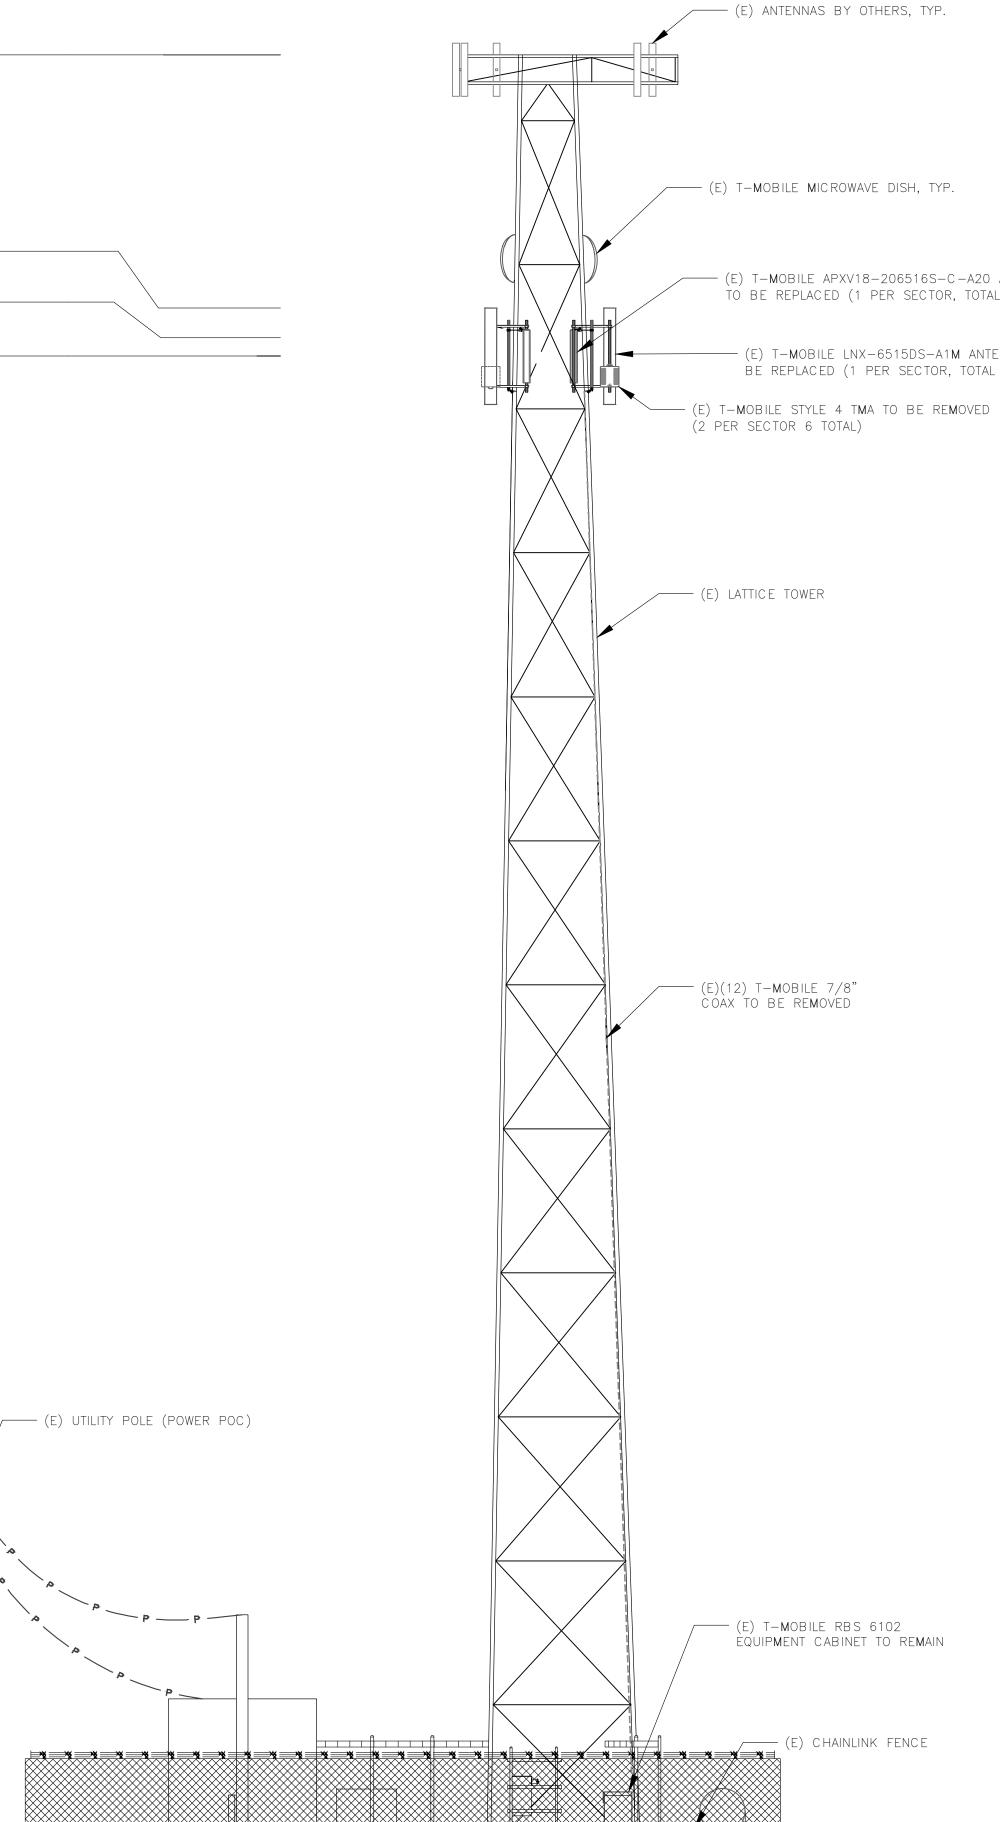



GROUND LEVEL ±0'-0" A.G.L.

### - (E) ANTENNAS BY OTHERS, TYP.

(E) T-MOBILE MICROWAVE DISH, TYP.

- (E) T-MOBILE APXV18-206516S-C-A20 ANTENNA TO BE REPLACED (1 PER SECTOR, TOTAL 3)

—— (E) T-MOBILE LNX-6515DS-A1M ANTENNA TO BE REPLACED (1 PER SECTOR, TOTAL 3)

(E) T-MOBILE RBS 6102 Equipment cabinet to remain

— (E) CHAINLINK FENCE


SCALE: 1/8" = 1'-0"16' 0'4'8'





GROUND LEVEL ±0'-0" A.G.L.

TOP OF (N) ANTENNAS +128'-10" A.G.L. TOP OF (N) ANTENNAS +126'-5" A.G.L. RAD CENTER OF (N) ANTENNA +125'-0" A.G.L. ~ P \_\_\_\_ P 

TOP OF (E) LATTICE TOWER +150'-0" A.G.L.

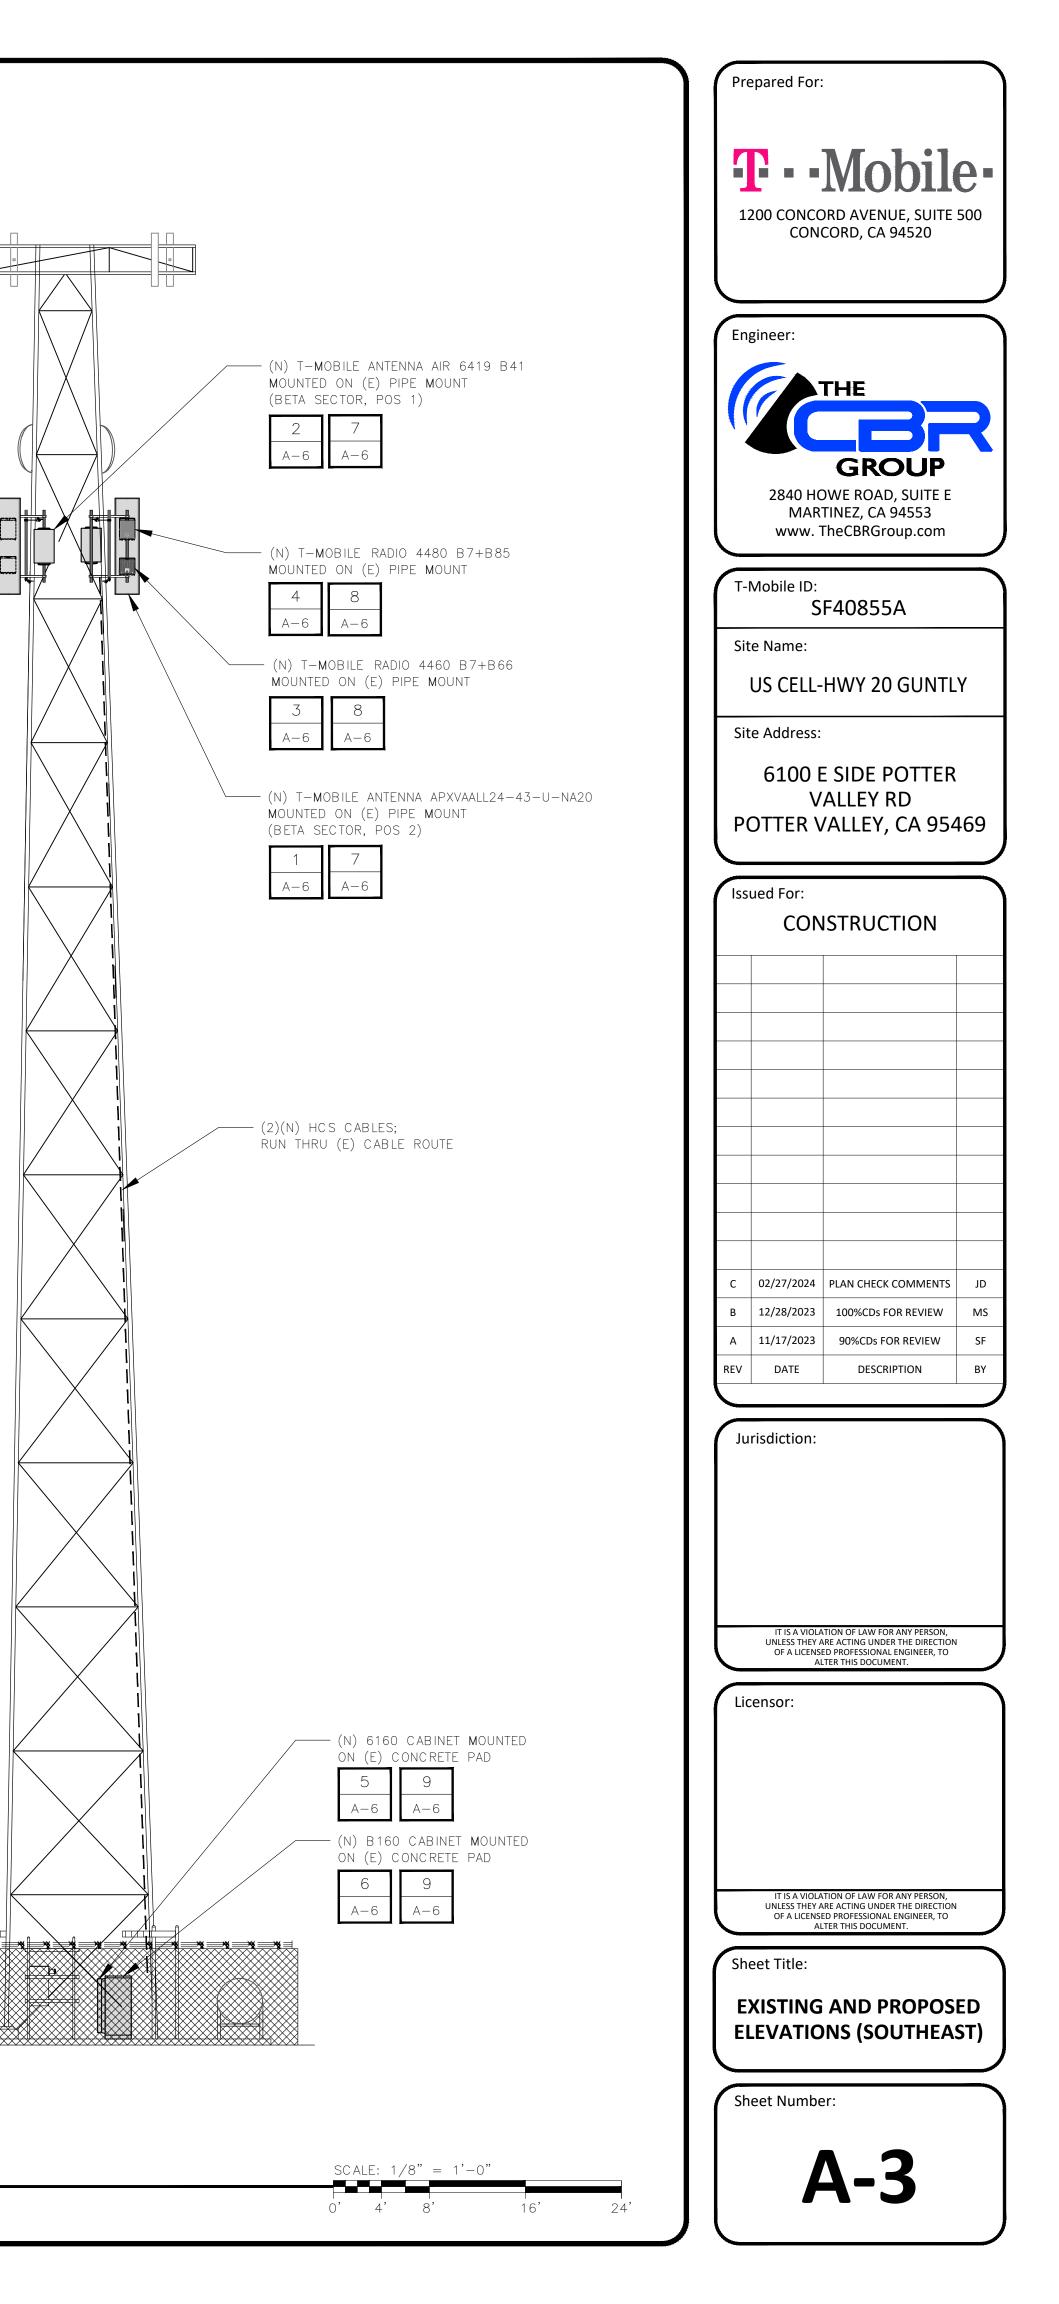

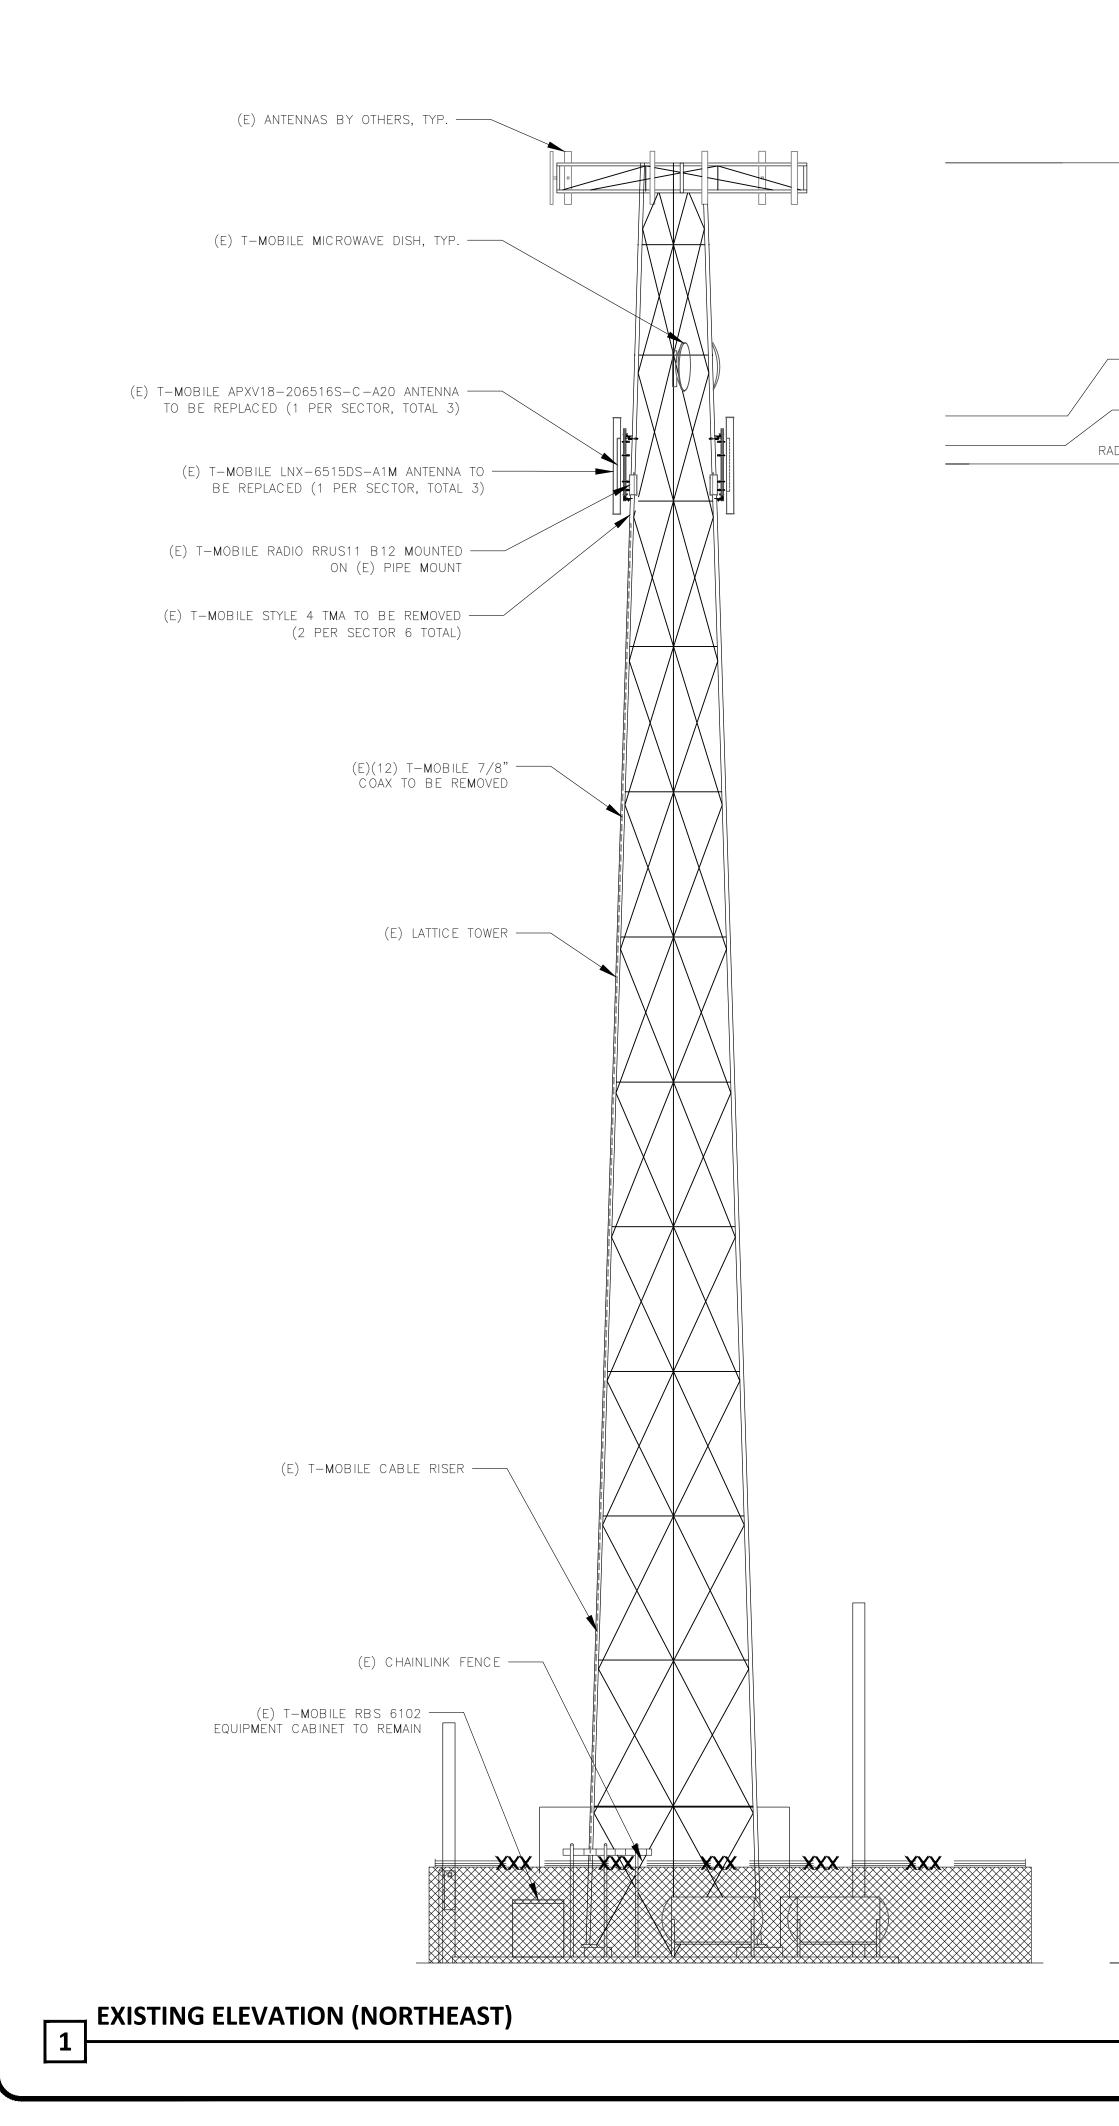

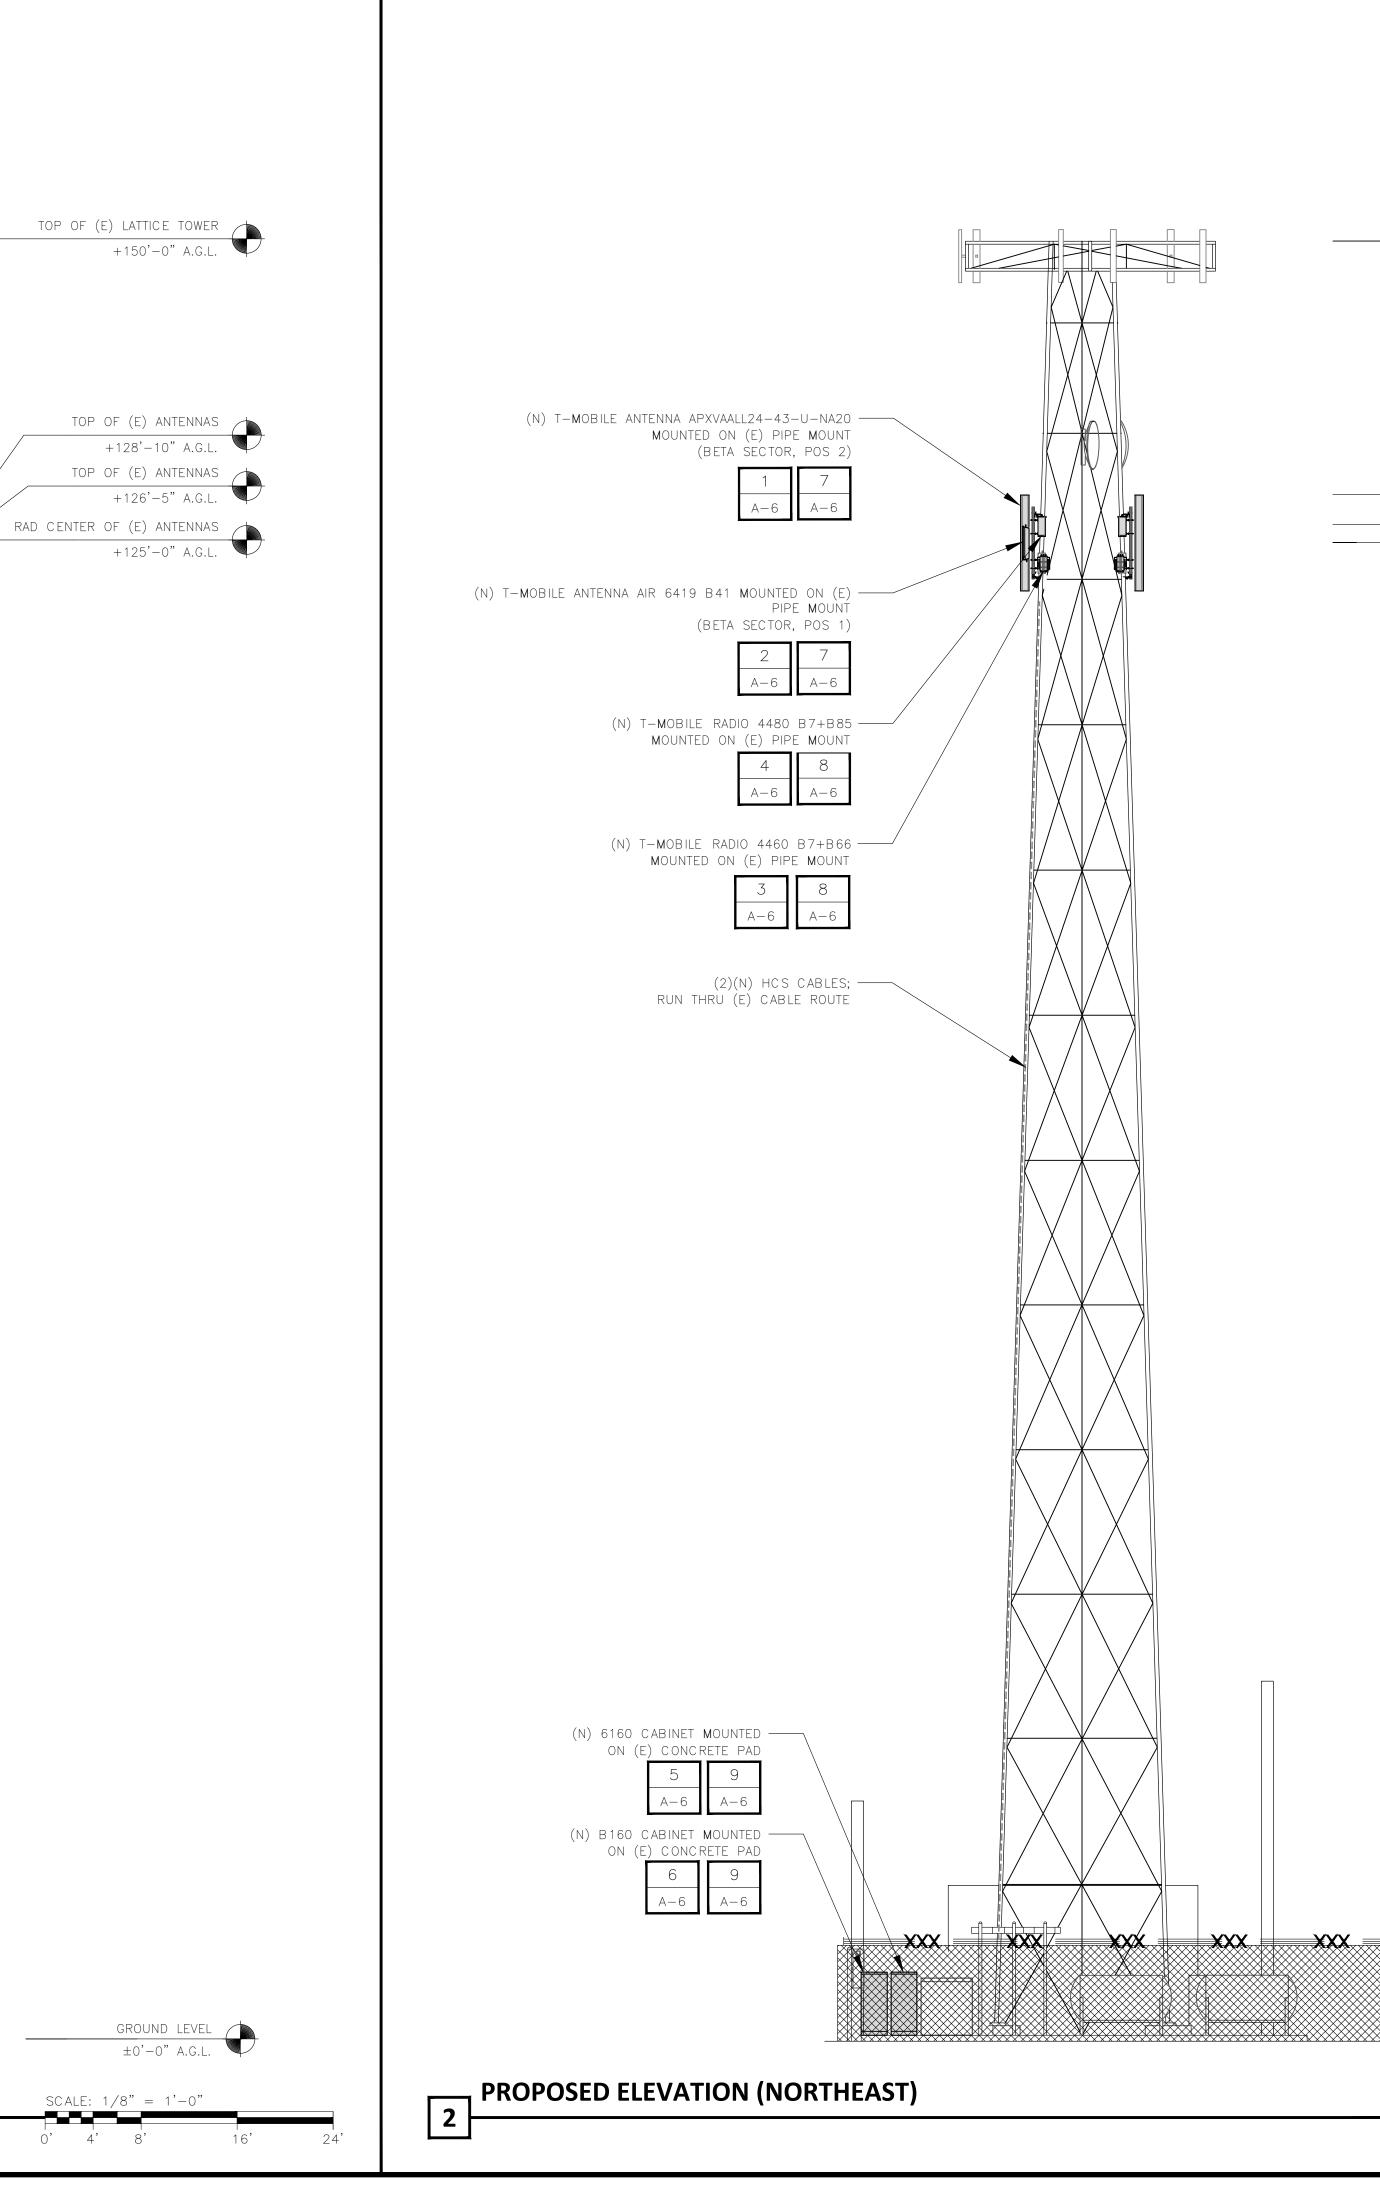

			)	Prepared	For:
				1200 CC	NCORD AVENUE, SUITE 500
	TOP				
		+150 -0 A.G.L.		Engineer	:
INCURSION       INCURSION         INCURSION       INCURENCISION         INCURSION<					GROUP O HOWE ROAD, SUITE E
The Control of Contro		TOP OF (N) ANTENNAS			
Site Name: US CELL-HWY 20 GUNTLY Site Advers: G100 E SIDE POTTER VALLEY RD POTTER VALLEY, CA 95469 Issued For: CONSTRUCTION	RAD CEN			T-Mobile	
US CELL-HWY 20 GUNTLY US Address:  Site Address:  Site Address:  Site Address:  Site Address:  CONSTRUCTION  CONST			¢	Site Nam	
				610	00 E SIDE POTTER VALLEY RD
					pr:
Image: State of the state					
Image: State in the state				C 02/27/	2024 PLAN CHECK COMMENTS JD
REV     DATE     DESCRIPTION     BY       Jurisdiction:     Initial NUMARIANT MUMORANT MUM				B 12/28/	2023 100%CDs FOR REVIEW MS
IT E A VICLATION OF LAW VICA ANY PERSON UNEX HEY ARE ACTING UNDER HEY DESCRIPTION ALTER HES DOCUMENT. LICENSOR UNDER HEY DATA ACTING UNDER HEY DESCRIPTION ALTER HES DOCUMENT. LICENSOR UNDER HEY DATA ACTING UNDER HEY DESCRIPTION ALTER HES DOCUMENT. Sheet Title: EXISTING AND PROPOSED ELEVATIONS (NORTHEAST) Sheet Number:					
IT I A MULATION OF LAW FOR ANY PERSON. UNLESS THEY ARE ACTING UNDER INF DIRECTION ALTER THIS DOCUMENT. LICENSOR UNDER THE ACTING UNDER THE DIRECTION ALTER THIS DOCUMENT. LICENSOR UNDER THE DOCUMENT. Sheet Title EXISTING AND PROPOSED LEVATIONS (NORTHEAST) Sheet Number:					
UNLESS THEY ARE ACTING UNDER THE DIRECTION OF A LICENSE PROFESSIONAL LEWIER, TO ALTER THIS DOCUMENT. Licensor: UNLESS THEY ARE ACTING UNDER THE DIRECTION OF A UCHNOR OF LAW FOR ANY PRESON. UNLESS THEY ARE ACTING UNDER THE DIRECTION OF A UCHNOR PROPERSIONAL REGIMER, TO ALTER THIS DOCUMENT. UNLESS THEY ARE ACTING UNDER THE DIRECTION OF A UCHNOR PROPERSIONAL REGIMER, TO ALTER THIS DOCUMENT. Sheet Title: EXISTING AND PROPOSED ELEVATIONS (NORTHEAST) Sheet Number:				Jurisdict	ion:
$\frac{\text{Ground Level}}{\pm 0' - 0'' \text{ A.G.L.}}$				UNLESS	S THEY ARE ACTING UNDER THE DIRECTION LICENSED PROFESSIONAL ENGINEER, TO
UNLESS THEY ARE ACTING UNDER THE DIRECTION OF A LICENSED PROPOSED ALTER THIS DOCUMENT. Sheet Title: EXISTING AND PROPOSED ELEVATIONS (NORTHEAST) Sheet Number:				Licensor	
UNLESS THEY ARE ACTING UNDER THE DIRECTION OF A LICENSED PROFESSIONAL ENGINEER, TO ALTER THIS DOCUMENT. Sheet Title: EXISTING AND PROPOSED ELEVATIONS (NORTHEAST) Sheet Number:					
GROUND LEVEL         ±0'-0" A.G.L.     EXISTING AND PROPOSED ELEVATIONS (NORTHEAST)  Sheet Number:				UNLESS	S THEY ARE ACTING UNDER THE DIRECTION LICENSED PROFESSIONAL ENGINEER, TO
±0'-0" A.G.L.				EXISTI	NG AND PROPOSED
SCALE: $1/8" = 1'-0"$				Sheet Nu	
	SCAL	E: $1/8" = 1'-0"$			$\Lambda_{-}\Lambda$

ANTENNA SCHEDULE (VERIFY WITH CURRENT RFDS)									
ECTOR EXISTING/PROPOSED	ANTENNA	SIZE (INCHES) (H X W X D)	ANTENNA RAD CENTER	AZI <b>m</b> uth	AC TIVE TEC HNOLOGY	RADIO (QTY)	TMA / MULTIPLEXER (QTY)	FIBER, COAX TYPE AND QUANTITY (LENGTH)	
EXISTING	RFS - APXV18-206516S-C-A20 (DUAL)	53.1" X 6.9" X 3.15"			L2100, G1900	_	(2) COMMSCOPE STYLE 4 - ETM19V2S12UB (E15S09P84)	(2) 7/8" COAX - 140 FT.	
A1 PROPOSED	AIR 6419 B41	33.6" X 20.0" X 6.3"		35.0°	N2500	_	_	_	
EXISTING	ANDREW — LNX—6515DS—A1 <b>m</b> (DUAL)	96.6" X 11.85" X 7.1"	125'-0"	350°	L700	(1) RRUS11 B12	_	(2) 7/8" COAX - 140 FT.	
A2 PROPOSED	RFS — APXVAALL24_43-U-NA20 (OCTO)	96.0" X 24.0" X 8.9"			L700, L1900, L2100, N600, N1900, G1900	(1) RADIO 4480 B71+B85, (1) RADIO 4460 B25+B66	-	(8) COAX JU <b>m</b> per — 10 ft.	

BETA

	ANTENNA SCHEDULE (VERIFY WITH CURRENT RFDS)									
SECTOR	EXISTING/PROPOSED	ANTENNA	SIZE (INCHES) (H X W X D)	ANTENNA RAD CENTER	AZI <b>m</b> uth	AC TIVE TEC HNOLOGY	RADIO (QTY)	TMA / MULTIPLEXER (QTY)	FIBER, COAX TYPE AND QUANTITY (LENGTH)	
	EXISTING	RFS - APXV18-206516S-C-A20 (DUAL)	53.1" X 6.9" X 3.15"			L2100, G1900	_	(2) COMMSCOPE STYLE 4 - ETM19V2 S12UB (E15S09P84)	(2) 7/8" COAX - 140 FT.	
B1	PROPOSED	AIR 6419 B41	33.6" X 20.0" X 6.3"				N2500	_	-	_
	EXISTING	ANDREW — LNX—6515DS—A1 <b>m</b> (DUAL)	96.6" X 11.85" X 7.1"	125'-0"	150°	L700	(1) RRUS11 B12	_	(2) 7/8" COAX - 140 FT.	
B2	PROPOSED	RFS — APXVAALL24_43-U-NA20 (OCTO)	96.0" X 24.0" X 8.9"			L700, L1900, L2100, N600, N1900, G1900	(1) RADIO 4480 B71+B85, (1) RADIO 4460 B25+B66	-	(8) COAX JU <b>m</b> per — 10 ft.	

GAMMA

	(VERIFY WITH CURRENT RFDS)									
SECTOR	EXISTING/PROPOSED	ANTENNA	SIZE (INCHES) (H X W X D)	ANTENNA RAD CENTER	AZI <b>m</b> uth	AC TIVE TEC HNOLOGY	RADIO (QTY)	TMA / MULTIPLEXER (QTY)	FIBER, COAX TYPE AND QUANTITY (LENGTH)	
	EXISTING	RFS - APXV18-206516S-C-A20 (DUAL)	53.1" X 6.9" X 3.15"			L2100, G1900		(2) COMMSCOPE STYLE 4 - ETM19V2 S12UB (E15S09P84)	(2) 7/8" COAX - 140 FT.	
C 1	PROPOSED	AIR 6419 B41	33.6" X 20.0" X 6.3"			N2500		_	_	
	EXISTING	RFS — APXVF24—C—A20 (DUAL)	93" X 14.6" X 6.9"	125'-0"	280°	L700	(1) RRUS11 B12	_	(2) 7/8" COAX - 140 FT.	
C 2	PROPOSED	RFS — APXVAALL24_43-U-NA20 (OCTO)	96.0" X 24.0" X 8.5"			L700, L1900, L2100, N600, N1900, G1900	(1) RADIO 4480 B71+B85, (1) RADIO 4460 B25+B66	_	(8) COAX JUMPER — 10 FT.	

ENCLOSURE TYPE	
RADIO	
BASEBAND	

PROPOSED EQUIPMENT SCHEDULE (AT EQUIPMENT AREA)							
ENCLOSURE TYPE	ENCLOSURE 6160-V2 AC	RBS 6102	B160				
BASEBAND	RP6651 (N2500), RP 6651 (N600, L700)	BB 6630 (N600, L700, L2100), DUG20 (G1900)	_				
TRANSPORT SYSTE <b>m</b>	CSR IXRE V2 (GEN2)	_	_				
HYBRID CABLE SYSTE <b>m</b>	HYBRID TRUNK 6/24 4AWG 50 <b>m</b>	HYBRID TRUNK 6/24 4AWG 50M	_				

RAN SCOPE OF WORK (VERIFY LATEST RFDS)	CABINET SOW: REUSE THE (1) RBS 6102. ADD: (1) E6160; (1) B160. HCS SOW: (2) ERICSSON HYBRID TRUNK 6X24 4AWG 50M. PER SECTOR RRU SOW: THIS PROJECT WILL REMOVE (1) RRUSI1 B12 (AT CABINET); ADD (1) RADIO 4480 (AT ANTENNA); ADD (1) RADIO 4460 (AT ANTENNA); PER SECTOR ANTENNA SOW: THIS PROJECT WILL SWAP AN (1) RRFS-APX18-206516S-C-A20 (DUAL) FOR AN (1) ERICSSON – AIR 6419 B41 (ACTIVE ANTENNA – MASSIVE MIMO);SWAP AN(1) ANDREW – LNX-6515DS-A11 (DUAL) FOR AN (1) RFS – APX18-206516S-C-A20 (DUAL) FOR AN (1) ERICSSON – AIR6419 B41 (ACTIVEANTENNA – MASSIVE MIMO); SWAP AN (1) ANDREW – LNX-6515DS-A1M (DUAL) FOR AN (1) RFS – APXVAALL24,43-U-NAZO (BFT, COTO); PER SECTOR COAX SOW: REMOVE (4) 7/8" COAX ADD PER SECTOR TMA SOW: NEMOVE (2) ERICSSON AWS/PCS – KRF 102 267/1 (AT CABINET); PER SECTOR TMA SOW: NEMEMOVE (2) COMMSCOPE STYLE 4 – ETM19V2S12UB (15S09P84) (AT ANTENNA); ANTENNA MOUNT SOW: INSTALL NEW MOUNTS – 3 SECTOR 3 POSITION DUAL HORIZONTAL PIPE MOUNTS WITH MINIMUM 9 FT. FACE. MAINTAIN A MINIMUM OF 38' HORIZONTAL SEPARATION BETWEEN CLOSEST EDGES OF LOWBAND ANTENNA AND DHER ANTENNAS/OBJECTS AND A MINIMUM 14" SEPARATION BETWEEN CLOSEST EDGES OF MIDBAND ANTENNAS/OBJECTS. ANTENNAS SHOULD BE MOUNTED PERPENDICULAR TO THE FACE THEY ARE MOUNTED ON. THE LIMIT OF DEVIATION ALLOWED IS 15' FROM THIS STANDARD. PROPOSED RAN: CONFIDURATION = 67E50998E HYBRID, CABINETS – (1) RBS 6102; (1) 6160; (1) 8160; BASEBAND – (1) BB6630 FOR AWS/PCS/LOWBAND; (1) DUG20; (1) RP 6651 FOR N25; HCS – (2) ERICSSON HYBRID TRUNK 6X24 4AWG SOM; ROUTER – (1) KRE PROPOSED A&L: ANIENNA PER SECTOR – POS 1: (1) ERICSSON – AIR Z A 6419 B41 (ACTIVE ANTENNA – MASSIVE MIMO); POS 2: (1) RFS – APXVAALL24_43–U-NA20 (BF1 OC10); (4) COAX JUMPER – 10 FT. FROM RADIO 4480 TO (1) RFS-APXVAALL24_43–U-NA20 (BF1 OC10); (4) COAX JUMPER – 10 FT. FROM RADIO 4480 TO (1) RFS-APXVAALL24_43–U-NA20 (BF1 OC10); (4) COAX JUMPER – 10 FT. FROM RADIO 4480 TO (1) RFS-APXVAALL24_43–U-NA20 (BF1 OC10); (4) COAX JUMPER – 10 FT. FROM RADIO 4480 TO (1) RFS-APXVAALL24_43–U-NA20 (BF1 OC10); (4) COAX J
---	---

ANTENNA SCHEDULE
(VERIFY WITH CURRENT RFDS)

### EXISTING EQUIPMENT SCHEDULE (AT EQUIPMENT AREA)

RBS 6102 MU AC


(3) RUS01 B2 (G1900), (3) RUS01 B2 (U1900-DECOMMISSIONED), (6) RUS01 B4 (L2100)

BB 6630 (L2100, L700), DUG20 (G1900), DUW30 (U1900-DECO**MM**ISSIONED)


1200 CONCORD AVENUE, SUITE 500 CONCORD, CA 94520
Engineer:
THE
GROUP
2840 HOWE ROAD, SUITE E MARTINEZ, CA 94553 www. TheCBRGroup.com
T-Mobile ID: SF40855A
Site Name:
US CELL-HWY 20 GUNTLY Site Address:
6100 E SIDE POTTER
VALLEY RD POTTER VALLEY, CA 95469
Issued For: CONSTRUCTION
C 02/27/2024 PLAN CHECK COMMENTS JD
B12/28/2023100%CDs FOR REVIEWMSA11/17/202390%CDs FOR REVIEWSFREVDATEDESCRIPTIONBY
Jurisdiction:
Junsaiction.
IT IS A VIOLATION OF LAW FOR ANY PERSON, UNLESS THEY ARE ACTING UNDER THE DIRECTION OF A LICENSED PROFESSIONAL ENGINEER, TO ALTER THIS DOCUMENT.
Licensor:
IT IS A VIOLATION OF LAW FOR ANY PERSON, UNLESS THEY ARE ACTING UNDER THE DIRECTION OF A LICENSED PROFESSIONAL ENGINEER, TO ALTER THIS DOCUMENT.
Sheet Title: ANTENNA AND
EQUIPMENT SCHEDULE
Sheet Number:
<b>A-5</b>

Prepared For:

**T** · · Mobile ·

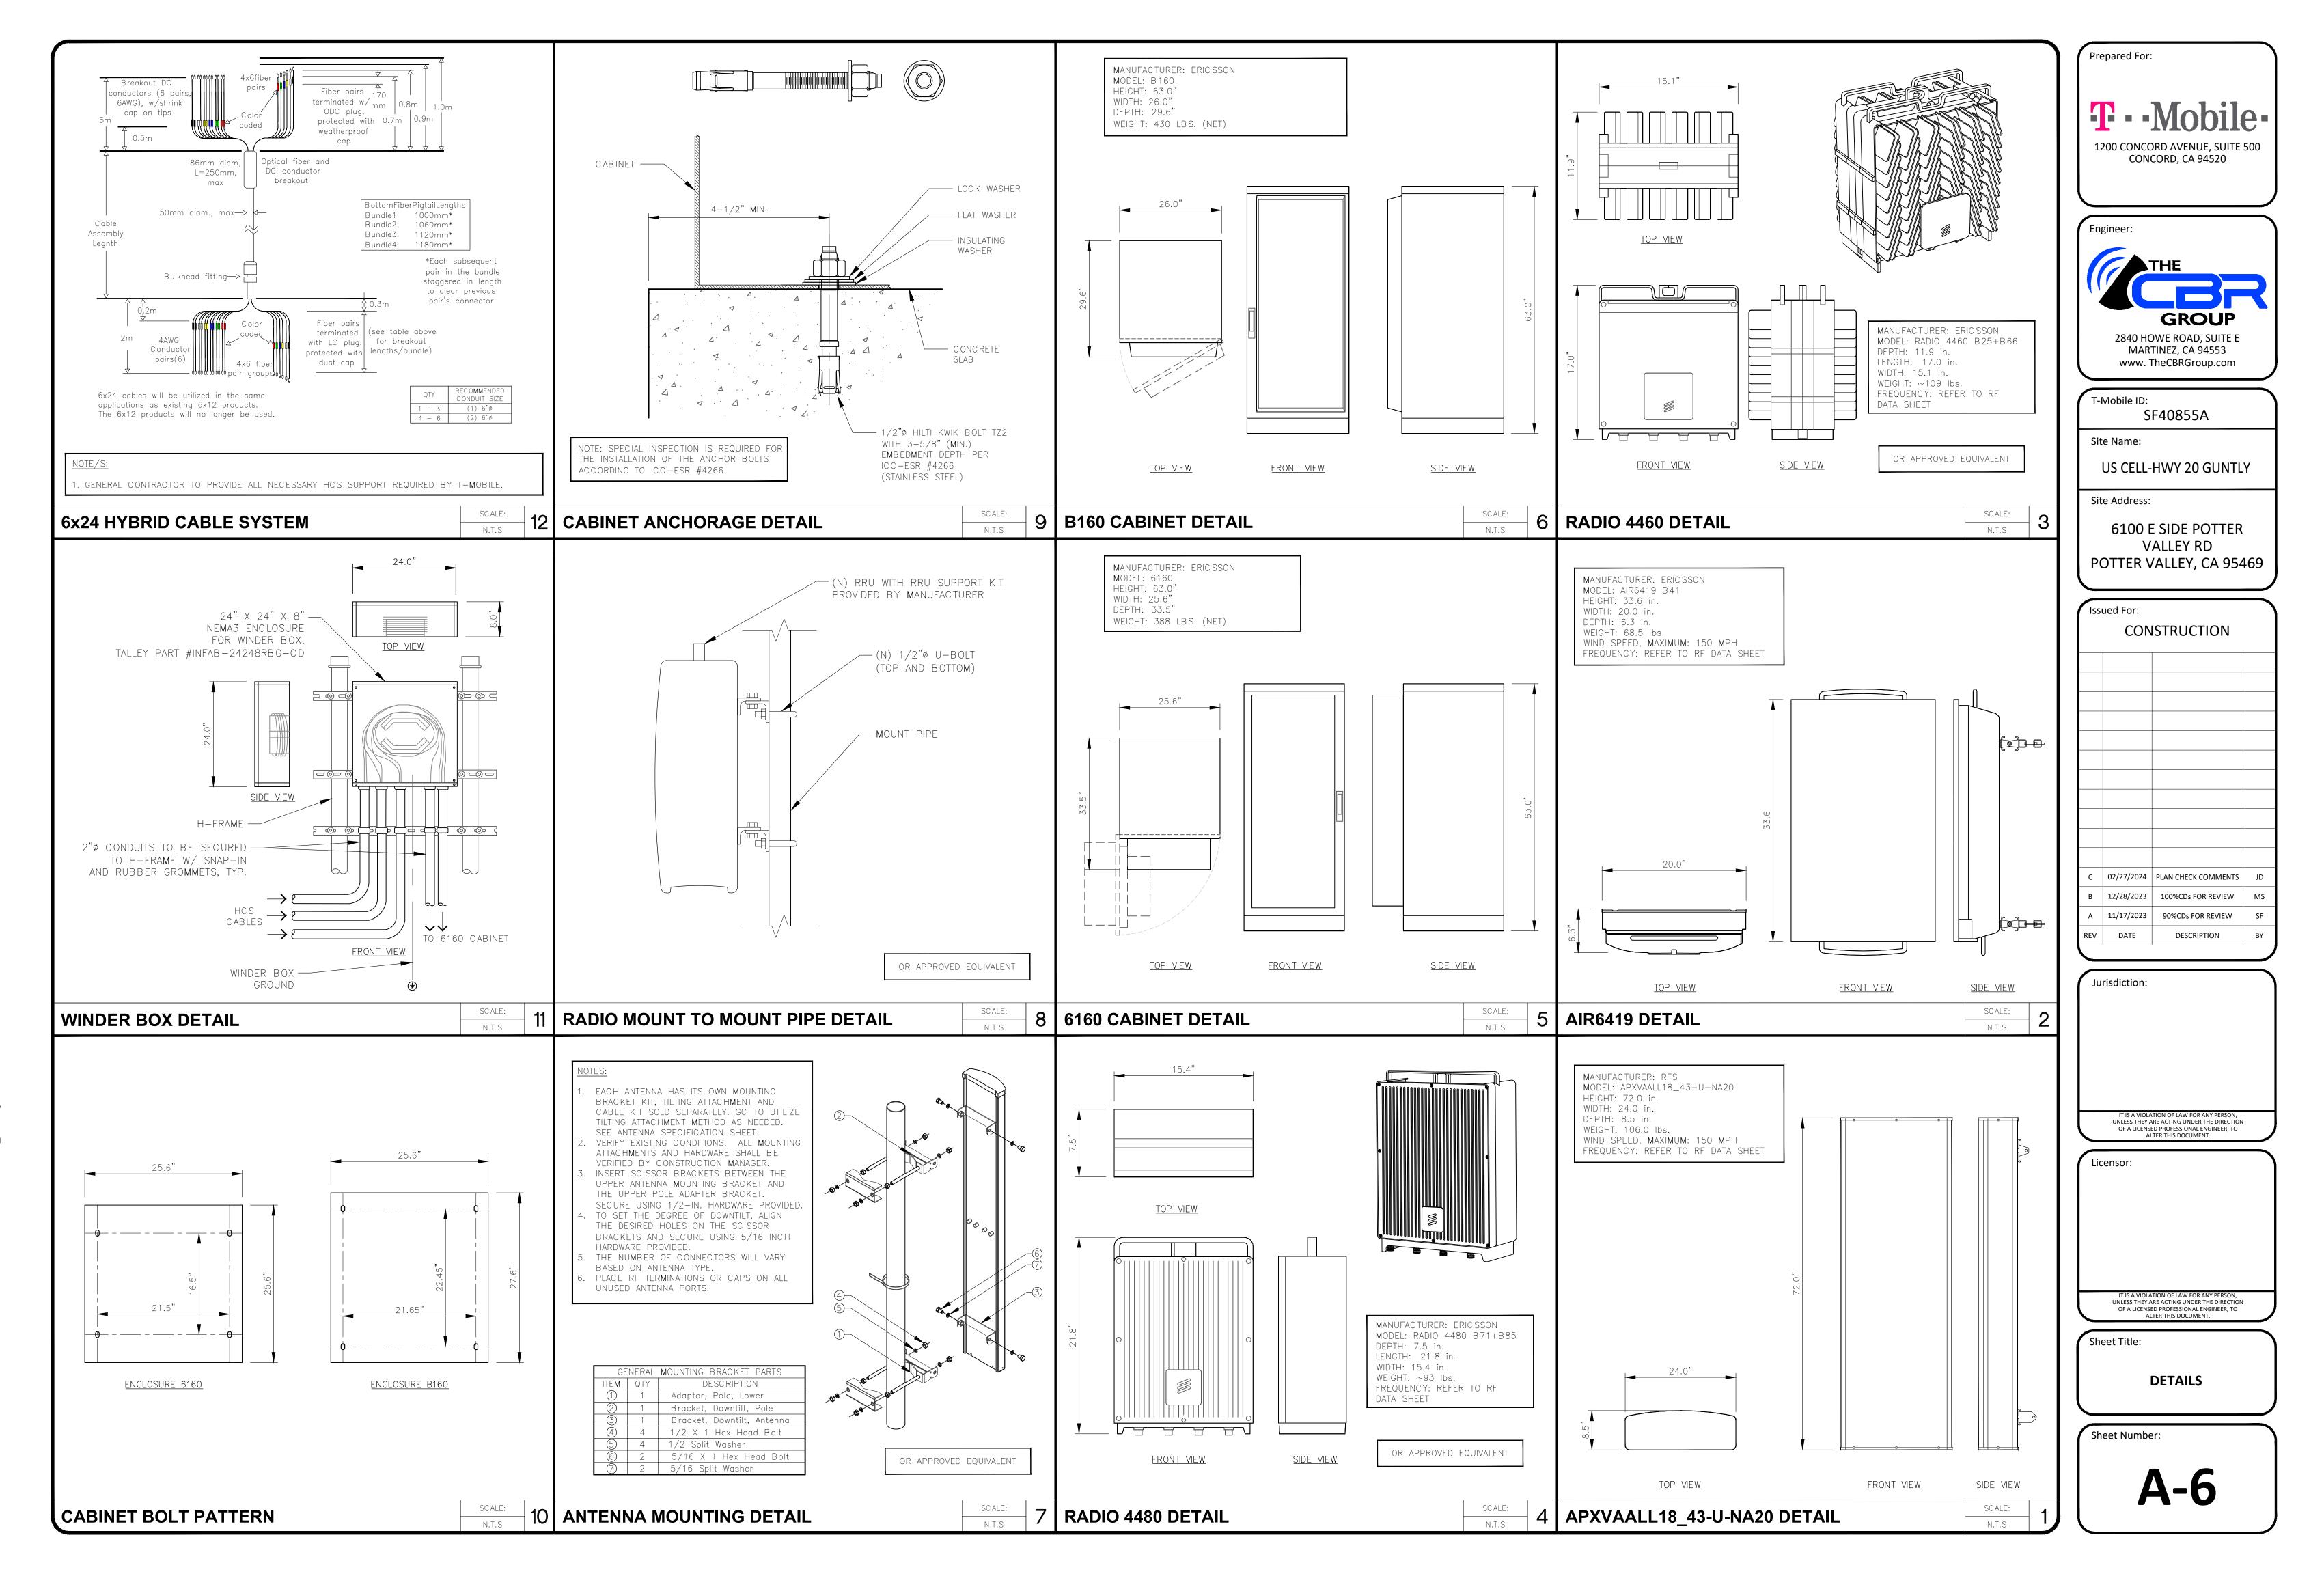

NOT USED SCALE N.T.S	NOT USED	SCALE: N.T.S	SCALE:         SCALE:         6	NOT U
NOT USED SCALE N.T.S	NOT USED	SCALE: 8	SCALE:         SCALE:         5           N.T.S         5         5	NOT U
				MANUF MODEL DIMENS WEIGHT <u>ELECTF</u> WATTAC LUMEN TEC HN FIXTUR LENS I MATERI
NOT USED SCALE N.T.S	NOT USED	SCALE: 7	NOT USED SCALE: 4	LED S

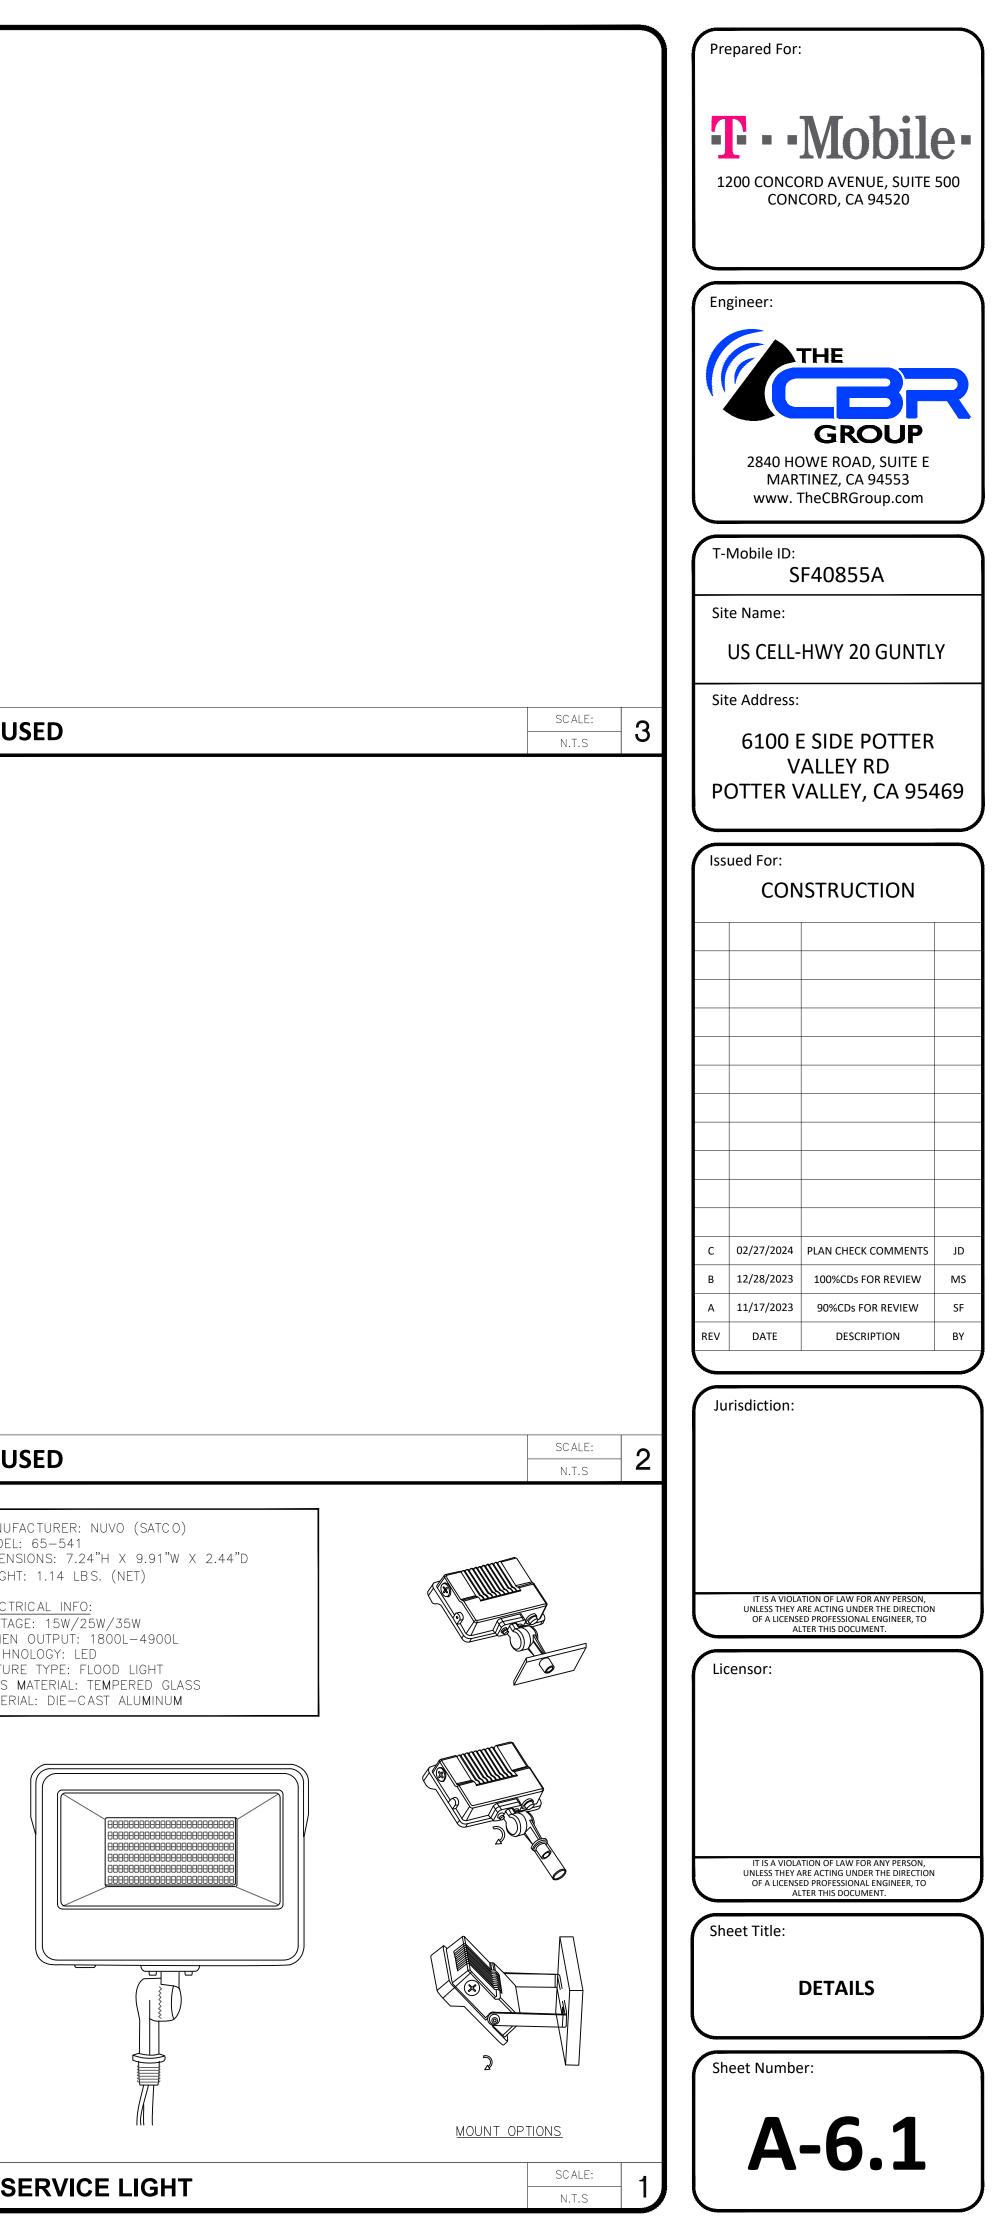


### GENERAL ELECTRICAL NOTES

- 1. ELECTRICAL CONTRACTOR SHALL SUPPLY AND INSTALL ANY/ALL ELECTRICAL WORK INDICATED. ANY/ALL CONSTRUCTION SHALL BE IN ACCORDANCE W/DRAWINGS AND ANY/ALL APPLICABLE SPECIFICATIONS. IF ANY PROBLEMS ARE ENCOUNTERED BY COMPLYING WITH THESE REQUIREMENTS, CONTRACTOR SHALL NOTIFY 'CONTRACTOR MANAGER' AS SOON AS POSSIBLE, AFTER THE DISCOVERY OF THE PROBLEMS, AND SHALL NOT PROCEED WITH THAT PORTION OF WORK, UNTIL THE 'CONSTRUCTION MANAGER' HAS DIRECTED THE CORRECTIVE TO BE TAKEN.
- 2. ELECTRICAL CONTRACTOR SHALL VISIT THE JOB SITE AND THEMSELF WITH ANY/ALL CONDITIONS AFFECTING ELECTRICAL AND COMMUNICATION INSTALLATION AND MAKE PROVISIONS AS TO COST THEREOF. ALL EXISTING CONDITIONS OF ELECTRICAL EQUIP., LIGHT FIXTURES, ETC., THAT ARE PART OF THE FINAL SYSTEM, SHALL BE VERIFIED BY THE CONTRACTOR, PRIOR TO THE SUBMITTING OF HIS BID, FAILURE TO COMPLY WITH THIS PARAGRAPH WILL IN NO WAY RELIEVE CONTRACTOR OF PERFORMING ALL WORK NECESSARY FOR A COMPLETE AND WORKING SYSTEM.
- 3. ALL WORK SHALL BE PERFORMED IN ACCORDANCE WITH THE LATEST EDITION OF THE CEC AND ALL CODES AND LOCAL ORDINANCES OF THE LOCAL POWER & TELEPHONE COMPANIES HAVING JURISDICTION AND SHALL INCLUDE BUT NOT LIMITED
  - A. UL UNDERWRITERS LABORATORIES


YEAR FROM THE DAY OF FINAL ACCEPTANCE.

- B. CEC CALIFORNIA ELECTRICAL CODE C. NEMA — NATIONAL ELECTRICAL MANUFACTURERS ASSOC.
- D. OSHA OCCUPATIONAL SAFETY AND HEALTH ACT E. CBC – CALIFORNIA BUILDING CODE
- 4. DO NOT SCALE ELECTRICAL DRAWINGS, REFER TO SITE PLANS AND ELEVATIONS FOR EXACT LOCATION OF ALL EQUIPMENT, AND
- CONFIRM WITH 'CONSTRUCTION MANAGER' ANY SIZES AND LOCATIONS WHEN NEEDED.
- 5. EXISTING SERVICE: CONTRACTOR SHALL NOT INTERRUPT EXISTING SERVICE WITHOUT WRITTEN PERMISSION OF THE OWNER.
- 6. CONTRACTOR SHALL PAY FOR ANY/ALL PERMITS, FEES, INSPECTIONS AND TESTING. CONTRACTOR IS TO OBTAIN PERMITS AND APPROVED SUBMITTALS PRIOR TO THE WORK BEGINNING OR ORDERING EQUIPMENT.
- 7. THE TERM "PROVIDE" USED IN CONSTRUCTION DOCUMENTS AND SPECIFICATIONS, INDICATED THAT THE CONTRACTOR SHALL FURNISH AND INSTALL.
- 8. CONTRACTOR SHALL CONFIRM WITH LOCAL UTILITY COMPANY ANY/ALL REQUIREMENTS. ANY/ALL CONFLICTS SHALL BE BROUGHT TO THE ATTENTION OF THE CONSTRUCTION MANAGER, PRIOR TO BEGINNING ANY WORK
- 9. MINIMUM WIRE SIZE SHALL BE #12 AWG, NOT INCLUDING CONTROL WIRING, UNLESS NOTED OTHERWISE. ALL CONDUCTORS SHALL BE COPPER WITH THWN INSULATION.
- 10. OUTLET BOXES SHALL BE PRESSED STEEL IN DRY LOCATIONS, CAST ALLOY WITH THREADED HUBS IN WET/DAMP LOCATIONS AND SPECIAL ENCLOSURES FOR OTHER CLASSIFIED AREAS.
- 11. IT IS NOT THE INTENT OF THESE PLANS TO SHOW EVERY MINOR DETAIL OF THE CONSTRUCTION. CONTRACTOR IS EXPECTED TO FURNISH AND INSTALL ALL ITEMS FOR A COMPLETE ELECTRICAL SYSTEM AND PROVIDE ALL REQUIREMENTS FOR THE EQUIPMENT TO BE PLACED IN PROPER WORKING ORDER.
- 12. ELECTRICAL SYSTEM SHALL BE AS COMPLETELY AND EFFECTIVELY GROUNDED, AS REQUIRED BY SPECIFICATIONS, SET FORTH BY T-MOBILE.
- 13. ALL WORK SHALL BE PERFORMED BY LICENSED ELECTRICAL CONTRACTOR IN A FIRST CLASS, WORKMANLIKE MANNER, THE COMPLETED SYSTEM SHALL BE FULLY OPERATIVE AND SUBJECT TO REGULATORY INSPECTION AND APPROVAL BY CONSTRUCTION MANAGER.
- 14. ALL WORK SHALL BE COORDINATED WITH OTHER TRADES TO AVOID INTERFERENCE WITH THE PROGRESS OF CONSTRUCTION. 15. CONTRACTOR SHALL GUARANTEE ANY/ALL MATERIALS AND WORK FREE FROM DEFECTS FOR A PERIOD OF NOT LESS THAN ONE
- 16. THE CORRECTION OF ANY DEFECTS SHALL BE COMPLETED WITHOUT ANY ADDITIONAL CHARGE AND SHALL INCLUDE THE REPLACEMENT OR THE REPAIR OF ANY OTHER PHASE OF THE INSTALLATION, WHICH MAY BEEN DAMAGED THEREIN.
- 17. ADEQUATE AND REQUIRED LIABILITY INSURANCE SHALL BE PROVIDED FOR PROTECTION AGAINST PUBLIC LOSS AND ANY/ALL PROPERTY DAMAGE FOR THE DURING OF WORK.
- 18. PROVIDE AND INSTALL CONDUIT, CONDUCTORS, PULL WIRES, BOXES, COVER PLATES AND DEVICES FOR ALL OUTLETS AS INDICATED.
- 19. DITCHING AND BACK FILL: CONTRACTOR SHALL PROVIDE FOR ALL UNDERGROUND INSTALLED CONDUIT AND/OR CABLES INCLUDING EXCAVATION AND BACKFILLING AND COMPACTION. REFER TO NOTES AND REQUIREMENTS, EXCAVATION, AND BACKFILLING
- 20. MATERIALS, PRODUCTS AND EQUIPMENT, INCLUDING ALL COMPONENTS THEREOF, SHALL BE NEW AND SHALL APPEAR ON LIST OF U.L. APPROVAL ITEMS AND SHALL MEET OR EXCEED THE REQUIREMENTS OF THE CEC AND NEMA.
- 21. CONTRACTOR SHALL SUBMIT SHOP DRAWING OR MANUFACTURERS CATALOG INFORMATION OF ANY/ALL LIGHTING FIXTURES, SWITCHES AND ALL OTHER ELECTRICAL ITEMS FOR APPROVAL BY THE CONSTRUCTION MANAGER PRIOR TO INSTALLATION.
- 22. ANY CUTTING OR PATCHING DEEMED NECESSARY FOR ELECTRICAL WORK IS THE ELECTRICAL CONTRACTOR RESPONSIBILITY AND SHALL BE INCLUDED IN THE COST FOR WORK AND PERFORMED TO THE SATISFACTION OF THE 'CONSTRUCTION MANAGER' UPON FINAL ACCEPTANCE.
- 23. THE ELECTRICAL CONTRACTOR SHALL LABEL ALL PANELS WITH ONLY TYPEWRITTEN DIRECTORIES. ALL ELECTRICAL WIRING SHALL BE THE RESPONSIBILITY OF THE ELECTRICAL CONTRACTOR.
- 24. DISCONNECT SWITCHES SHALL BE H.P. RATED HEAVY-DUTY, QUICK-MAKE AND QUICK-BREAK ENCLOSURES, AS REQUIRED BY EXPOSURE TYPE.
- 25. ALL CONNECTIONS SHALL BE MADE WITH A PROTECTIVE COATING OF AN ANTI-OXIDE COMPOUND SUCH AS "NON-OXIDE A" BY DEARBORNE CHEMICAL CO. COAT ALL WIRE SURFACES BEFORE CONNECTING . EXPOSED COPPER SURFACES, INCLUDING GROUND BARS, SHALL BE TREATED - NO SUBSTITUTIONS.
- 26. RACEWAYS: CONDUIT SHALL BE SCHEDULE 40 PVC MEETING OR EXCEEDING NEMA TC2 2020. CONTRACTOR SHALL PLUG AND CAP EACH END OF SPARE AND EMPTY CONDUITS AND PROVIDE TWO SEPARATE PULL STRINGS – 200 LBS TEST POLYETHYLENE CORD. ALL CONDUIT BENDS SHALL BE A MINIMUM OF 2 FT. RADIUS RGS CONDUITS WHEN SPECIFIED, SHALL MEET UL-6 FOR GALVANIZED STEEL . ALL FITTINGS SHALL BE SUITABLE FOR USE WITH THREADED RIDGE CONDUIT. COAT ALL THREADS WITH 'BRITE ZINC' OR ' GOLD GALV'
- 27. SUPPORT OF ALL ELECTRICAL WORK SHALL BE AS REQUIRED BY CEC.
- 28. CONDUCTORS: CONTRACTOR SHALL USE 98% CONDUCTIVITY COPPER TYPE THWN. INSULATION, 800 VOLT, COLOR CODED, USE SOLID CONDUCTORS FOR WIRE UP TO AND INCLUDING NO. 8 AWG. USE STRANDED CONDUCTORS FOR WIRE ABOVE NO. 8 AWG.
- 29. CONNECTORS FOR POWER CONDUCTORS, CONTRACTORS SHALL USE PRESSURE TYPE INSULATED TWIST-ON CONNECTORS FOR NO.10 AWG AND SMALLER USE SOLDERLESS MECHANICAL. TERMINAL LUGS FOR NO. 8 AWG AND LARGER.
- 30. SERVICE: 120/240V, SINGLE PHASE, 3 WIRE CONNECTION AVAILABLE FROM UTILITY COMPANY. OWNER OR OWNERS AGENT WILL APPLY FOR POWER.
- 31. TELEPHONE SERVICE: CONTRACTOR SHALL PROVIDE EMPTY CONDUITS WITH PULL STRINGS AS INDICATED ON DRAWINGS.
- 32. ELECTRICAL AND TELCO RACEWAYS TO BE BURIED A MINIMUM OF 2' DEPTH.
- 33. CONTRACTOR SHALL PLACE TWO LENGTHS OF WARNING TAPE AT A DEPTH OF 12" BELOW GROUND AND DIRECTLY ABOVE ELECTRICAL, AND TELCO SERVICE CONDUITS. CAUTIONS TAPE TO READ "CAUTION BURIED ELECTRIC" OR "BURIED TELECOMM".
- 34. ALL BOLTS SHALL BE STAINLESS STEEL.

240°

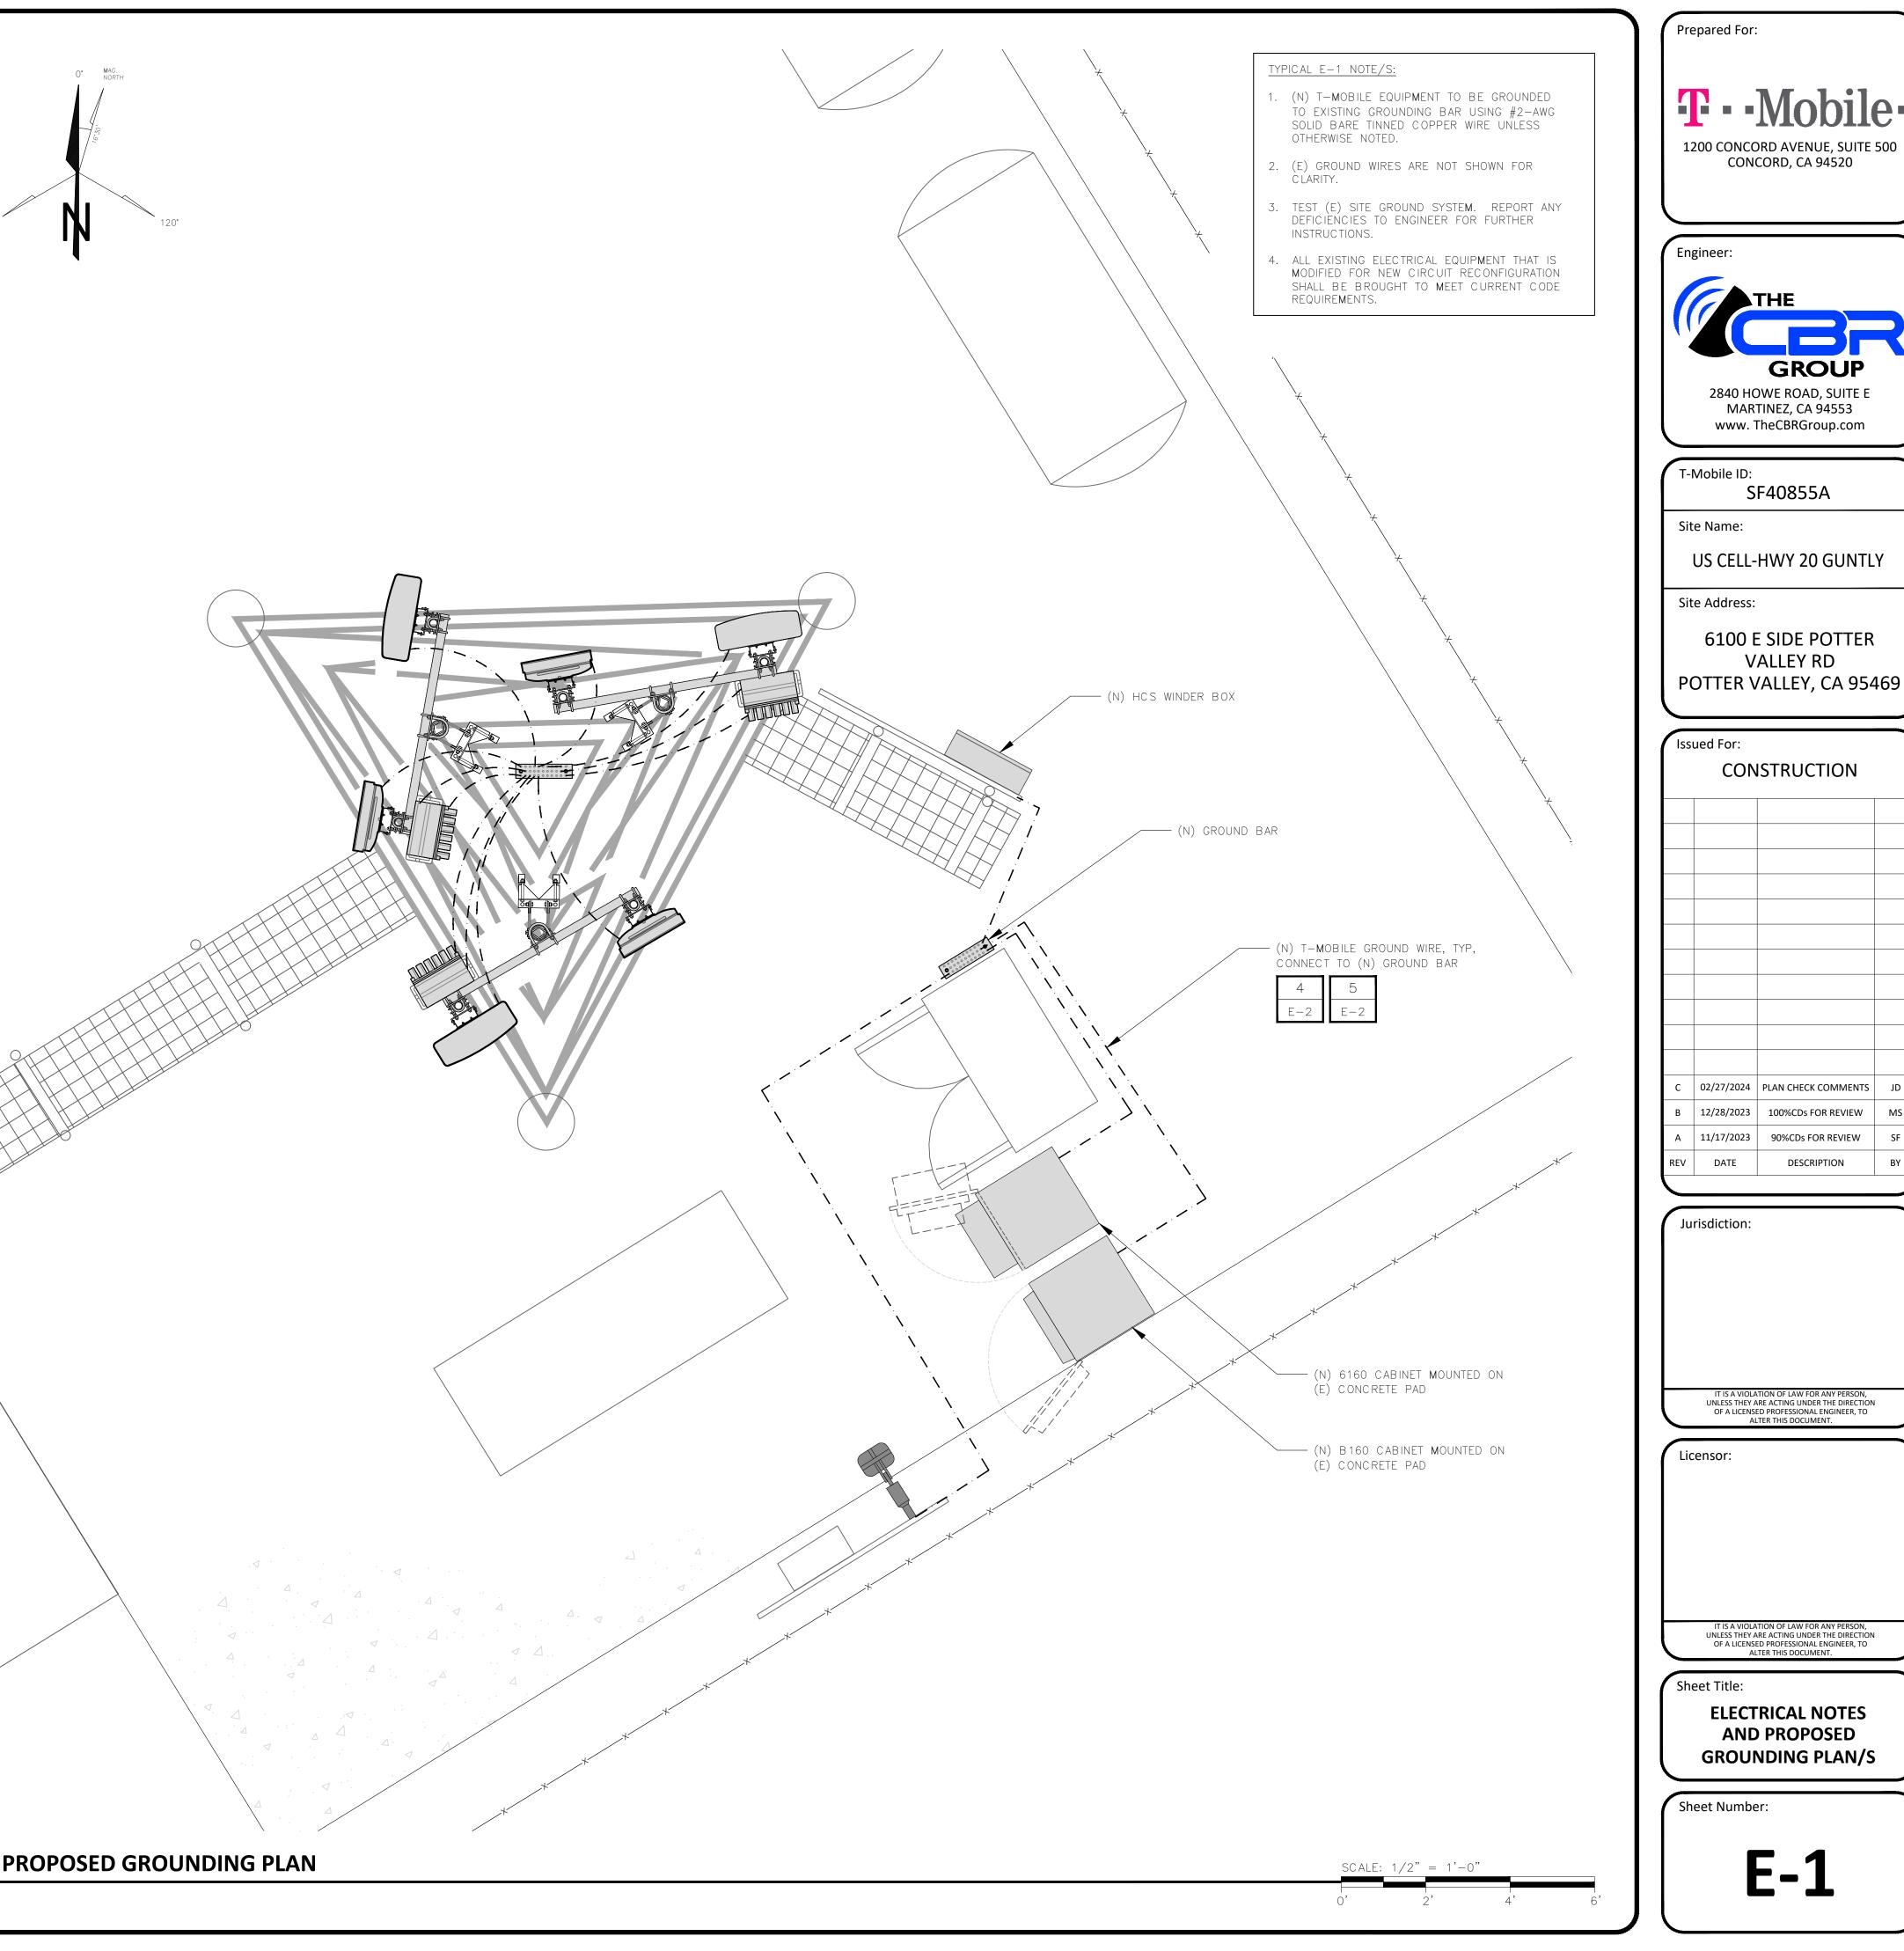

BY

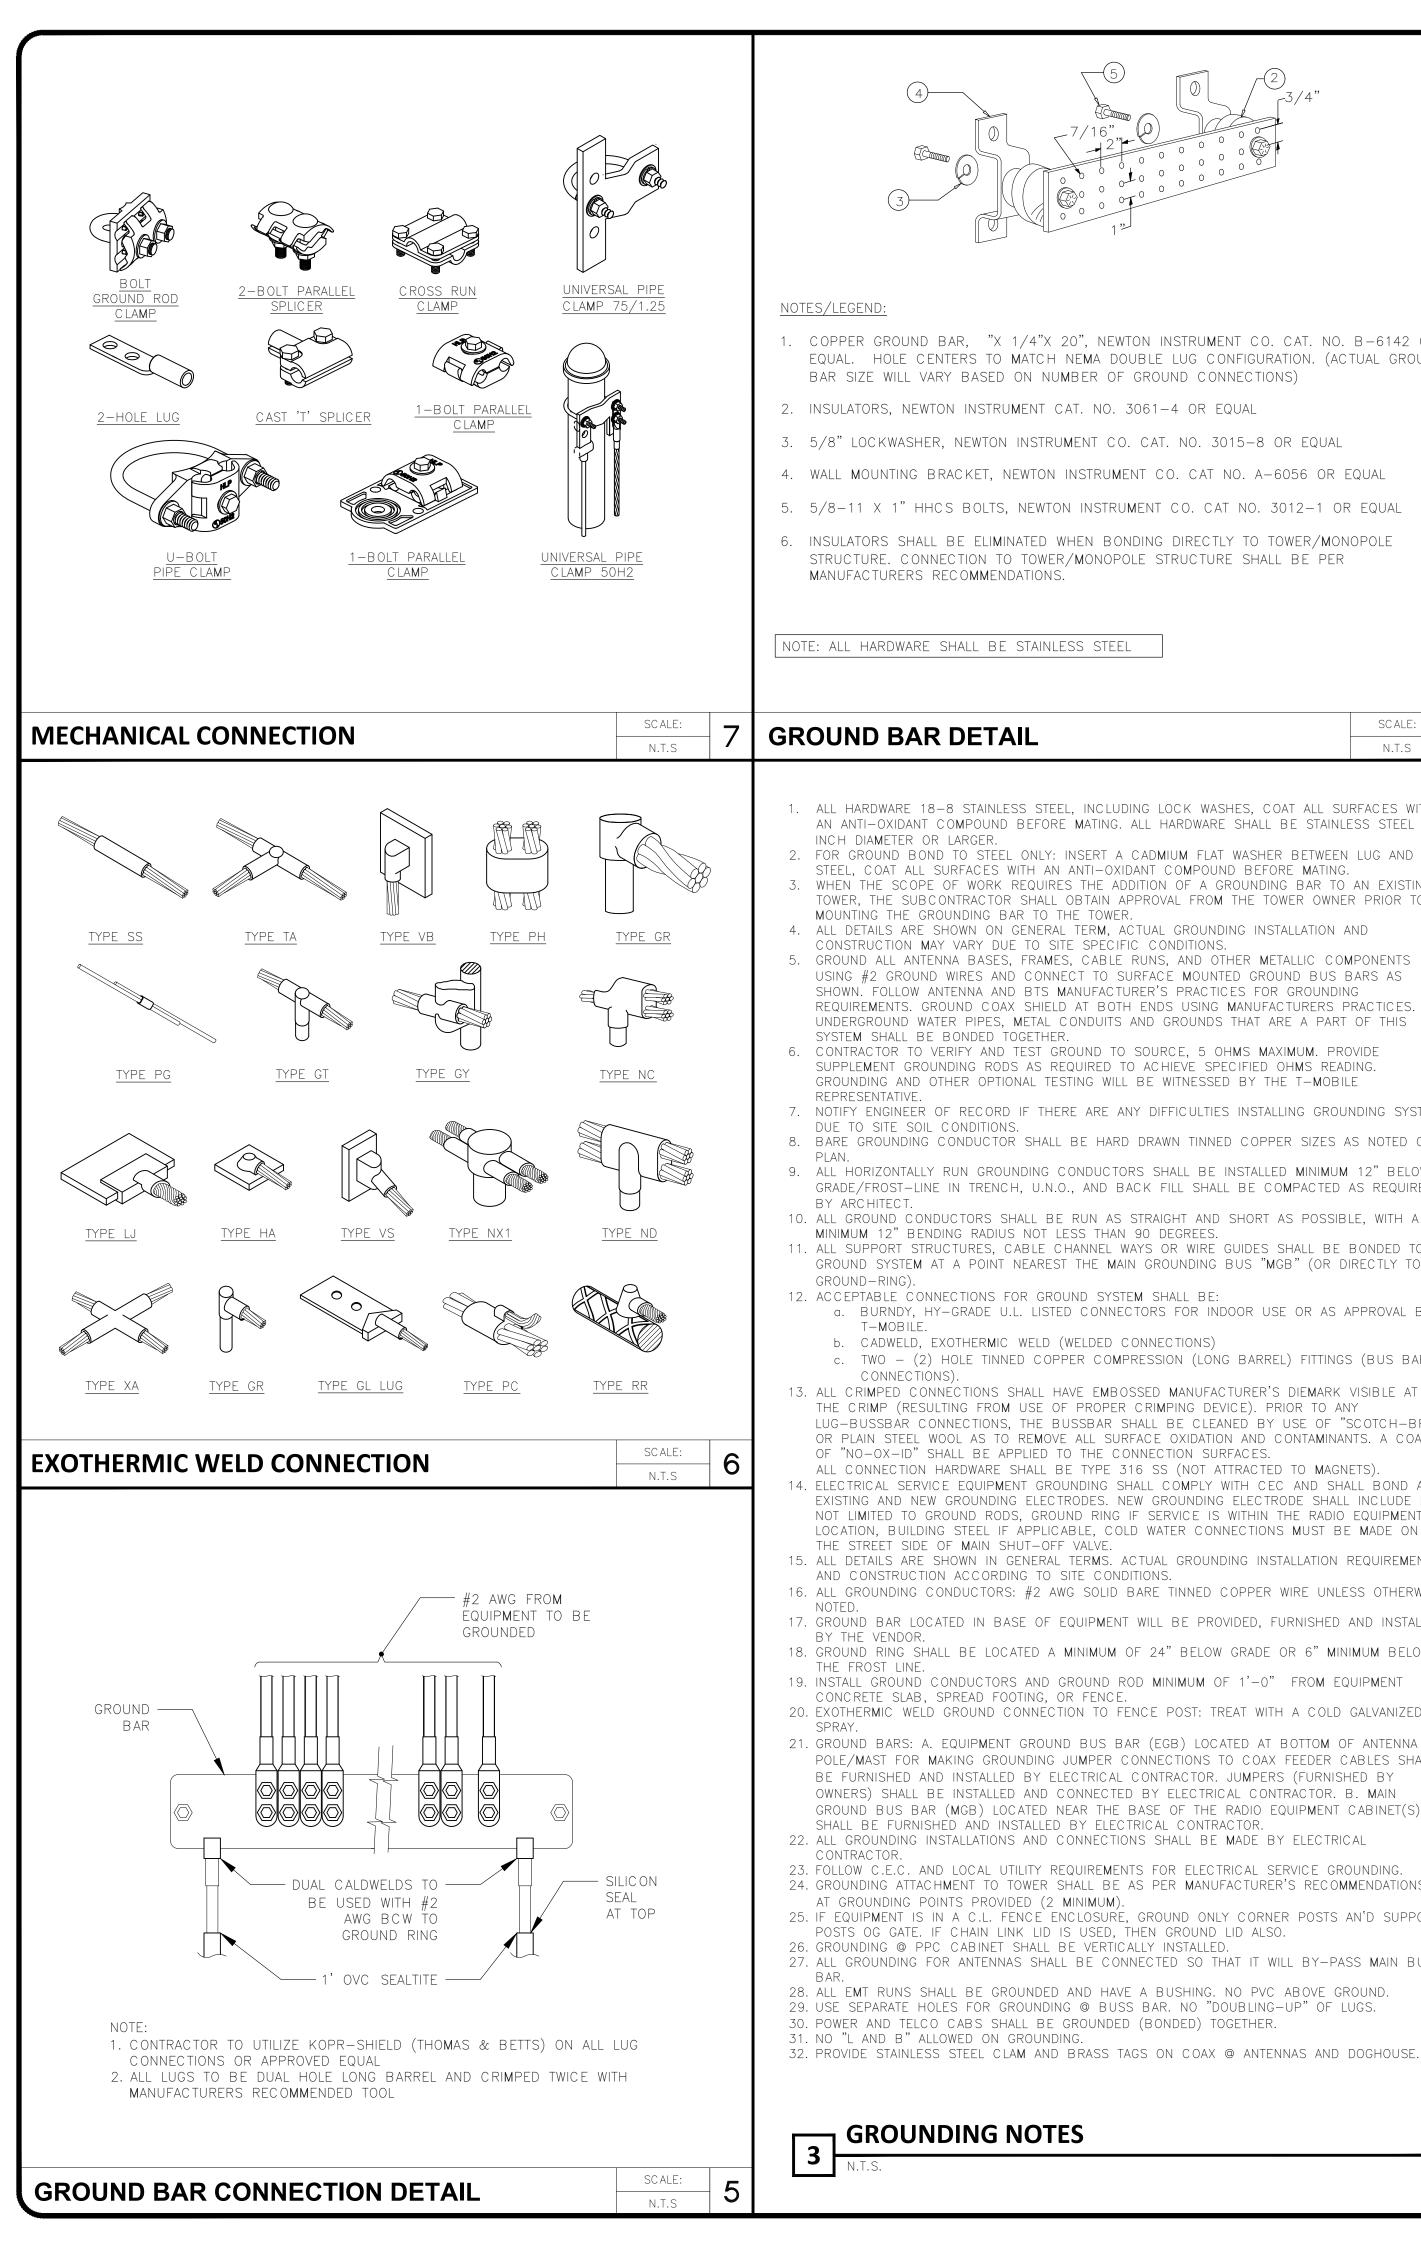

NEWTON INSTRUMENT CO. CAT. NO. B-6142 OR DOUBLE LUG CONFIGURATION. (ACTUAL GROUND OF GROUND CONNECTIONS) 0. 3061-4 OR EQUAL CO. CAT. NO. 3015-8 OR EQUAL UMENT CO. CAT NO. A-6056 OR EQUAL TRUMENT CO. CAT NO. 3012-1 OR EQUAL BONDING DIRECTLY TO TOWER/MONOPOLE OPOLE STRUCTURE SHALL BE PER	
TEEL SCALE: N.T.S	
ELUDING LOCK WASHES, COAT ALL SURFACES WITH NG. ALL HARDWARE SHALL BE STAINLESS STEEL 3/8 T A CADMIUM FLAT WASHER BETWEEN LUG AND OXIDANT COMPOUND BEFORE MATING. ADDITION OF A GROUNDING BAR TO AN EXISTING N APPROVAL FROM THE TOWER OWNER PRIOR TO WER. A, ACTUAL GROUNDING INSTALLATION AND ECIFIC CONDITIONS. BLE RUNS, AND OTHER METALLIC COMPONENTS O SURFACE MOUNTED GROUND BUS BARS AS ACTURER'S PRACTICES FOR GROUNDING BOTH ENDS USING MANUFACTURERS PRACTICES. ALL HTS AND GROUNDS THAT ARE A PART OF THIS	
TO SOURCE, 5 OHMS MAXIMUM. PROVIDE D TO ACHIEVE SPECIFIED OHMS READING. WILL BE WITNESSED BY THE T-MOBILE E ANY DIFFICULTIES INSTALLING GROUNDING SYSTEM	
HARD DRAWN TINNED COPPER SIZES AS NOTED ON CTORS SHALL BE INSTALLED MINIMUM 12" BELOW D BACK FILL SHALL BE COMPACTED AS REQUIRED AS STRAIGHT AND SHORT AS POSSIBLE, WITH A HAN 90 DEGREES. EL WAYS OR WIRE GUIDES SHALL BE BONDED TO MAIN GROUNDING BUS "MGB" (OR DIRECTLY TO	<u>N(</u> 1. 2. 3.
SYSTEM SHALL BE: NNECTORS FOR INDOOR USE OR AS APPROVAL BY O CONNECTIONS) OMPRESSION (LONG BARREL) FITTINGS (BUS BAR MBOSSED MANUFACTURER'S DIEMARK VISIBLE AT	4. 5. 6. 7.
PER CRIMPING DEVICE). PRIOR TO ANY R SHALL BE CLEANED BY USE OF "SCOTCH-BRITE" SURFACE OXIDATION AND CONTAMINANTS. A COATING CONNECTION SURFACES. E 316 SS (NOT ATTRACTED TO MAGNETS). G SHALL COMPLY WITH CEC AND SHALL BOND ALL S. NEW GROUNDING ELECTRODE SHALL INCLUDE BUT NG IF SERVICE IS WITHIN THE RADIO EQUIPMENT COLD WATER CONNECTIONS MUST BE MADE ON E. S. ACTUAL GROUNDING INSTALLATION REQUIREMENTS ONDITIONS. JD BARE TINNED COPPER WIRE UNLESS OTHERWISE MENT WILL BE PROVIDED, FURNISHED AND INSTALLED JM OF 24" BELOW GRADE OR 6" MINIMUM BELOW D ROD MINIMUM OF 1'-O" FROM EQUIPMENT ICE. D FENCE POST: TREAT WITH A COLD GALVANIZED S BAR (EGB) LOCATED AT BOTTOM OF ANTENNA I'R CONNECTIONS TO COAX FEEDER CABLES SHALL CAL CONTRACTOR. JUMPERS (FURNISHED BY CTED BY ELECTRICAL CONTRACTOR. B. MAIN HE BASE OF THE RADIO EQUIPMENT CABINET(S) LECTRICAL CONTRACTOR. CTIONS SHALL BE MADE BY ELECTRICAL MENTS FOR ELECTRICAL SERVICE GROUNDING. BE AS PER MANUFACTURER'S RECOMMENDATIONS OR	
BE AS PER MANUFACTURER'S RECOMMENDATIONS OR JM). URE, GROUND ONLY CORNER POSTS AN'D SUPPORT ID, THEN GROUND LID ALSO. RTICALLY INSTALLED. CONNECTED SO THAT IT WILL BY-PASS MAIN BUSS HAVE A BUSHING. NO PVC ABOVE GROUND. BUSS BAR. NO "DOUBLING-UP" OF LUGS. IDED (BONDED) TOGETHER.	

# 2 EXISTING PANEL SCHEDULE WITH NEW LOAD

(1) ADD (N) 125A-2P BREAKER AT POSITION 8-10 AND (N) 20A-1P BREAKER AT POSITION 7 FOR (N) 6160 CABINET.

ASSUMED LOAD FOR (E) BREAKER

\* (N) BREAKER IN (E) DISTRIBUTION PANEL

	LOAD		LOAD PER PHASE (VA)		TRIP		LOAD PER PHASE (VA)		LOAD			
	DESCRIPTION		POLE	PHASE				PHASE		- POLE	DESCRIPTION	
		DESCRIPTION	FULL	А	В			A	В	FULL	DESCRIPTION	
	1	(E) SURGE SUPPRESSOR		0		70	100		• 2800		(E) RBS 6102 CABINET	2
	3	(E) SURGE SUPPRESSUR	2		0	- 30	100	• 2800		- 2	(E) RES 6102 CABINET	4
	5	(E) RECEPTACLE	1	180		15	20		200	1	(E) SITE LIGHT	6
1	7	(N) RBS CABINET 6160 - B	1		1200	20	*105	8640			(N) RBS CABINET 6160 - A	8
	9	(E) SPARE	1	0		20	*125		8640	2	(N) RES CABINET 6160 - A	10
	11											12
			SUBTOTAL CONTINUOUS	0	1200			11440	11640	SUBTOTAL CONTINUOUS	TOTAL VA CONTINUOUS (x 1.25)	30350
			SUBTOTAL NON-CONTINUOUS	180	0			0	0	SUBTOTAL NON-CONTINUOU	TOTAL VA S NON-CONTINUOUS	180
	PANEL DESIGNATION: ELECTRICAL PANEL (ITEM			1)		MAIN L	UGS: N	/A				
	MAIN BREAKER:		200	AMP	CYCLE:		60	VOLTAGE:	120/240	TOTAL VA	70570	
	MAIN BREAKER A.I.C. RATING:		65,000	) A.I.C.	PHASE:		1			IOTAL VA	30530	
	BRANCH BREAKER SERIES A.I.C. RATING:		10,000 A.I.C.		WIRES:		3	NEUTRAL:	200 AMPS	TOTAL AMPS	127.2	
	BRANCH BREAKER TYPE:		-	_	MAIN C	OPPER	BUS:		200 A <b>m</b> p	IUTAL AIVIT S		

CONTRACTOR TO VERIFY NUMBER AND SIZE OF ALL CIRCUITS REQUIRED WITH T-MOBILE PRIOR TO START CONSTRUCTION.

EQUIPMENT TERMINATION LUGS AND CONDUCTORS ARE RATED AT A MINIMUM OF 75°C.

KAIC OF NEW BREAKER (S) TO MATCH EXISTING.


ALL GFCI RECEPTACLES TO HAVE A DEDICATED GROUND WIRE.

**¬ SINGLE LINE DIAGRAM** 

PULL ONE GROUND CONDUCTOR PER FLEXIBLE NONMETALLIC CONDUIT. FOR ALL OTHER CIRCUITS PULL A SEPARATE CONDUCTOR.

WIRES TO END OF FLEXIBLE NONMETALLIC CONDUIT. COIL 3'-0" AT END OF FLEXIBLE NONMETALLIC CONDUIT & TAG.


IOTES:

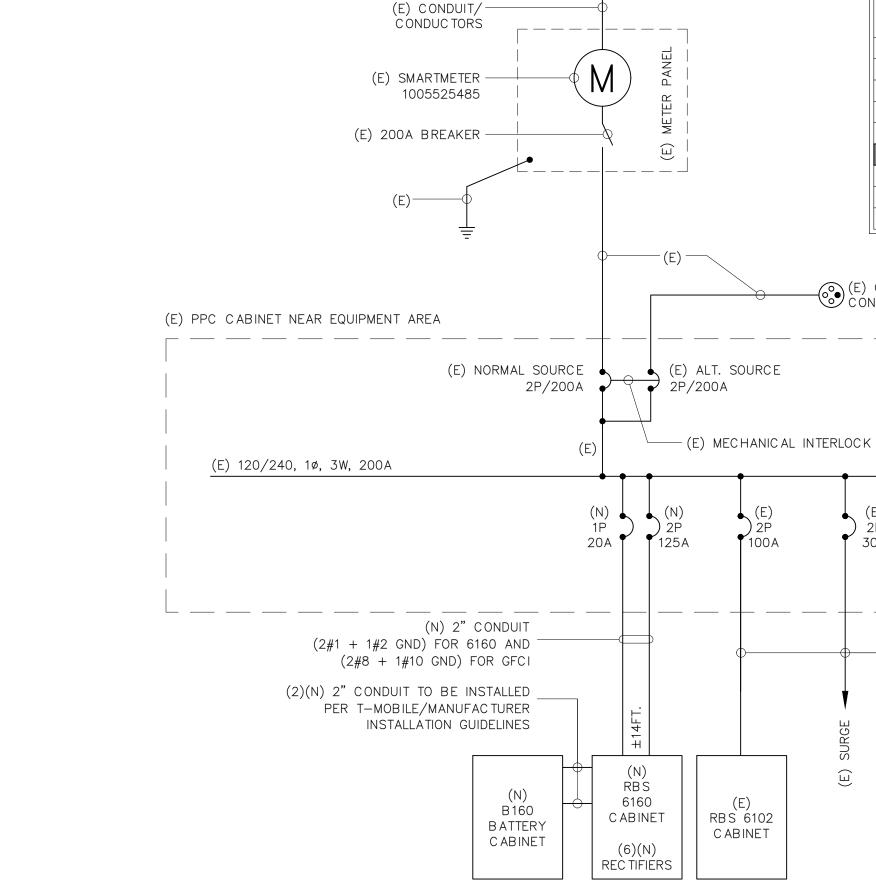

(E) 200A, 240V POWER SOURCE


FUSE FOR SPLIT-PHASE FEEDING 2W + PE						
AMOUNT OF RECTIFIERS	INPUT CURRENT (A)	RECO <b>mm</b> ended AC Fuse (A)				
1	18	25				
2	36	50				
3	54	80				
4	72	100				
5	90	125				
6	100	125				
7	126	150				
8	144	175				
9	162	200				


## (E) GENERATOR CONNECTOR

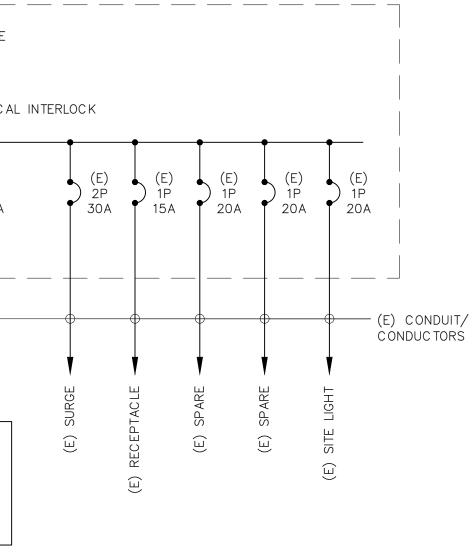



### ALL SERVICE EQUIPMENT AND INSTALLATIONS SHALL COMPLY WITH NEC, UTILITY COMPANY AND LOCAL CODE REQUIREMENTS.


	epared For:							
	<b>T</b> - Mobile 1200 CONCORD AVENUE, SUITE 500 CONCORD, CA 94520							
Eng	gineer:							
		THE						
			2					
		GROUP						
	MAR	OWE ROAD, SUITE E TINEZ, CA 94553						
	www.	TheCBRGroup.com						
(T-I	Mobile ID:	F40855A						
Sit	e Name:							
	US CELL-	HWY 20 GUNTL	Y					
Sit	e Address:							
		E SIDE POTTER						
	V	ALLEY RD						
		ALLEY, CA 954/	169 -					
Iss	ued For:		$\leq$					
	CON	ISTRUCTION						
С В	02/27/2024	PLAN CHECK COMMENTS 100%CDs FOR REVIEW	JD MS					
А	11/17/2023	90%CDs FOR REVIEW	SF					
REV	DATE	DESCRIPTION	BY					
	risdiction:		$\leq$					
Ju								
-	UNLESS THEY A	TION OF LAW FOR ANY PERSON, ARE ACTING UNDER THE DIRECTION						
$\geq$		ED PROFESSIONAL ENGINEER, TO LTER THIS DOCUMENT.	$\prec$					
Lic	ensor:							
		TION OF LAW FOR ANY PERSON,						
	UNLESS THEY A OF A LICENS	ARE ACTING UNDER THE DIRECTION ED PROFESSIONAL ENGINEER, TO 						
Sh	eet Title:							
			l,					
		L SCHEDULE, UNDING DETA	ILS					
Ch	eet Numbe	er:	$\prec$					
		E-2						

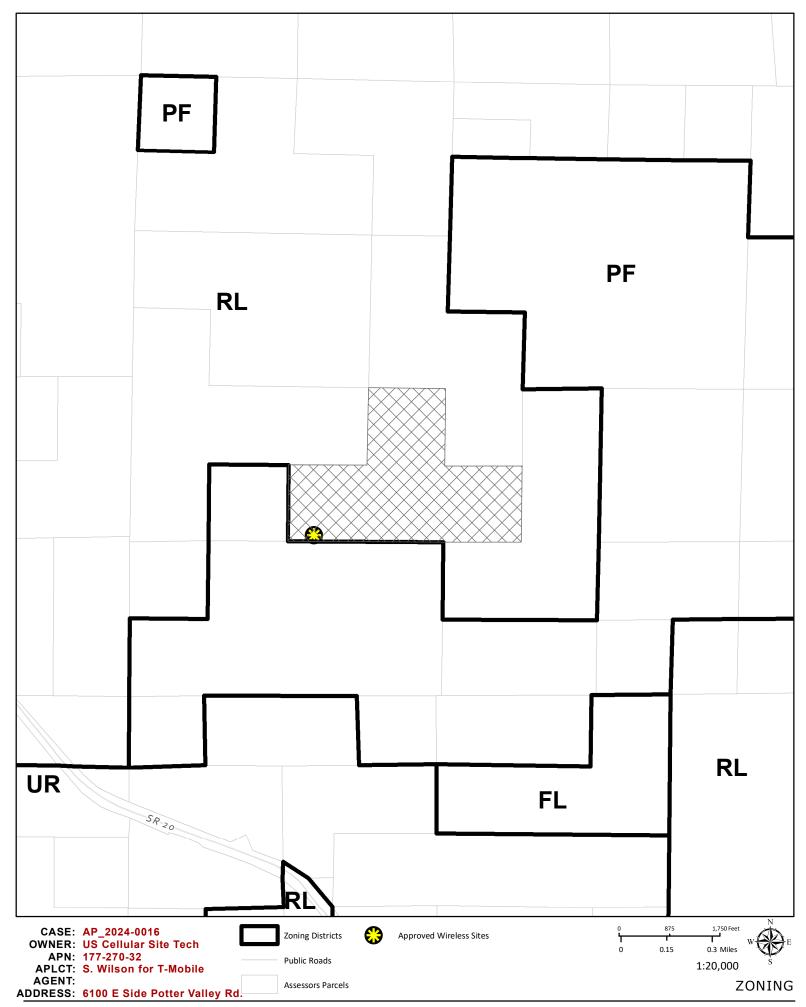


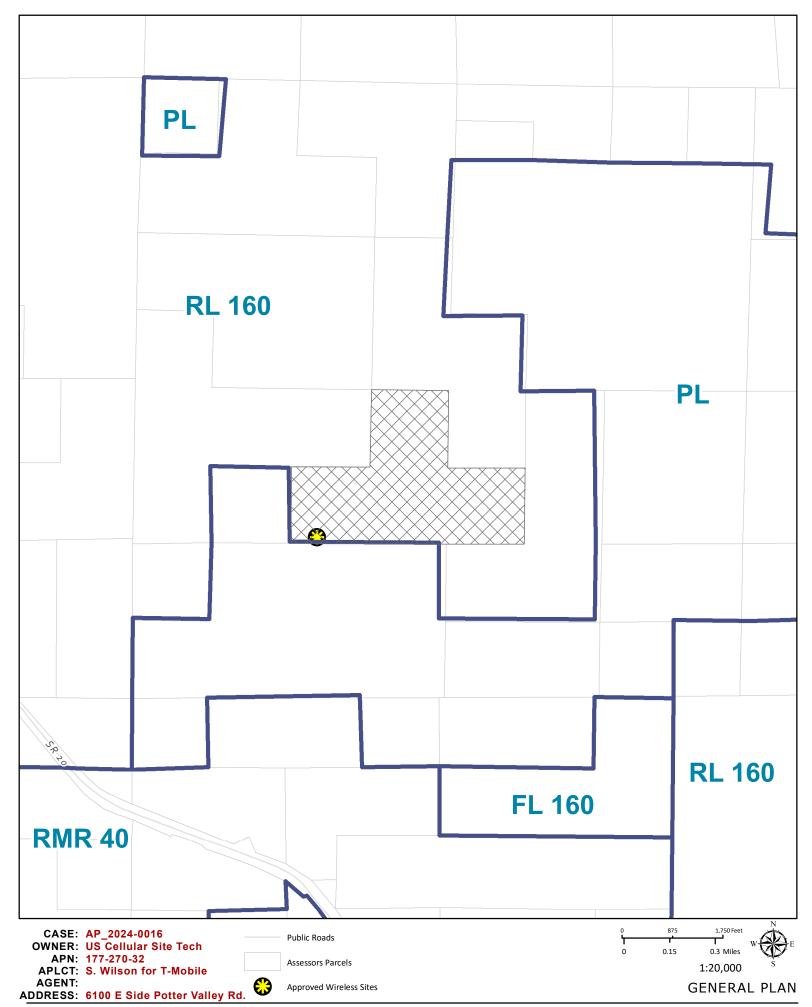


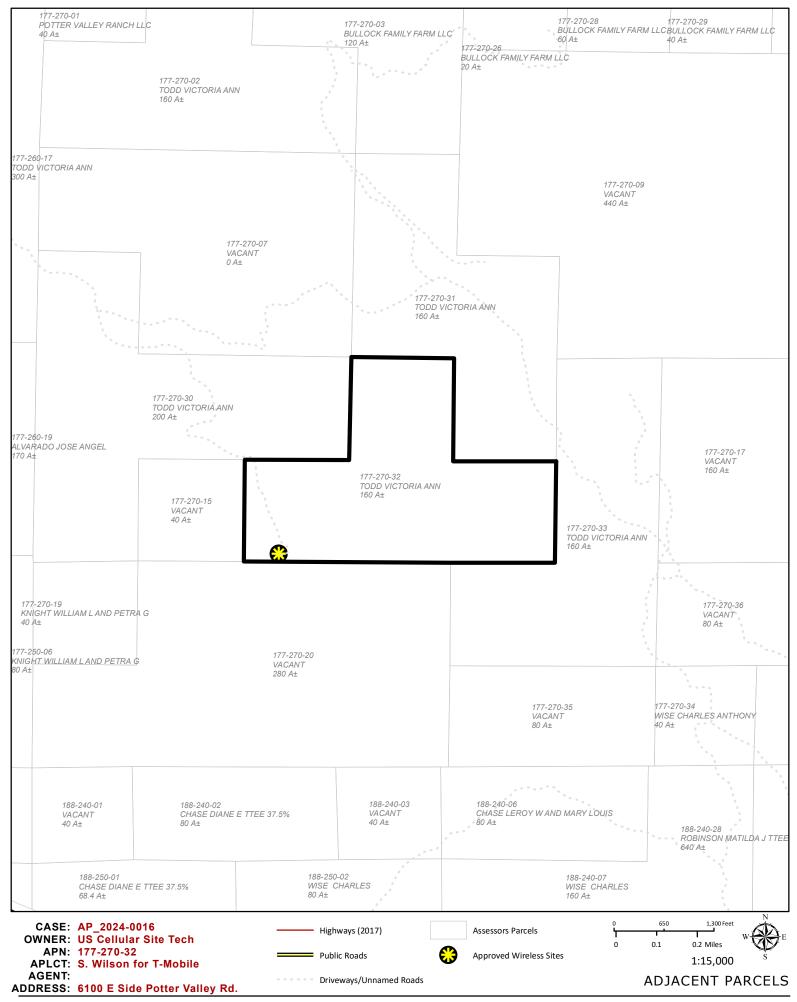


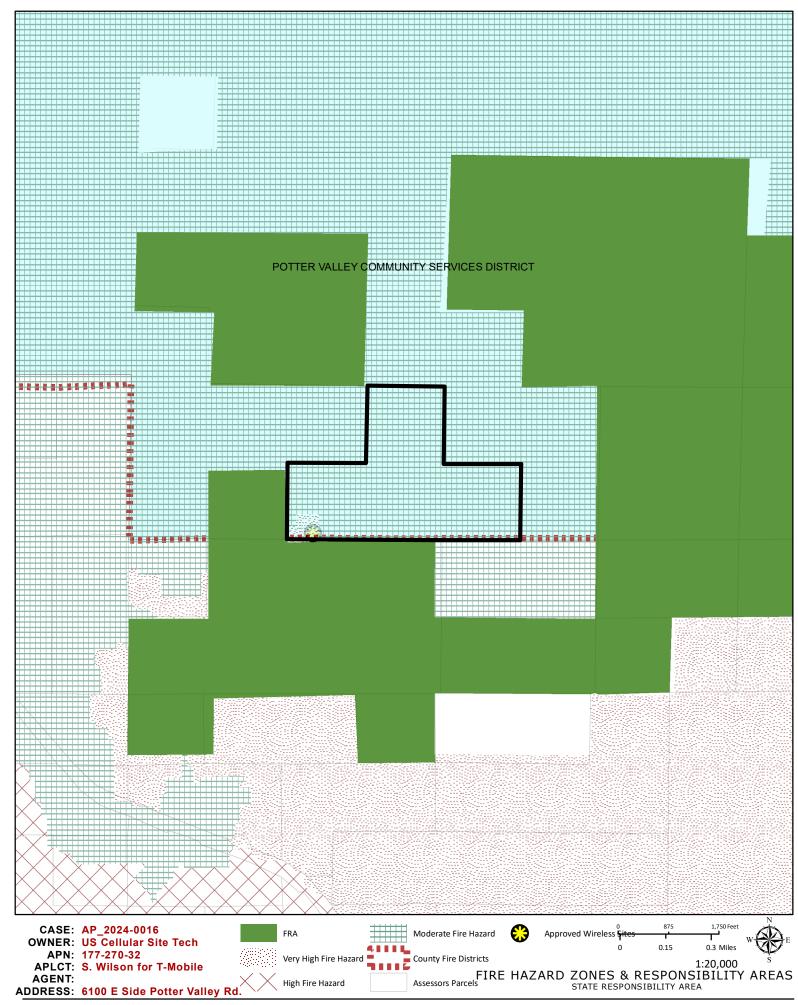


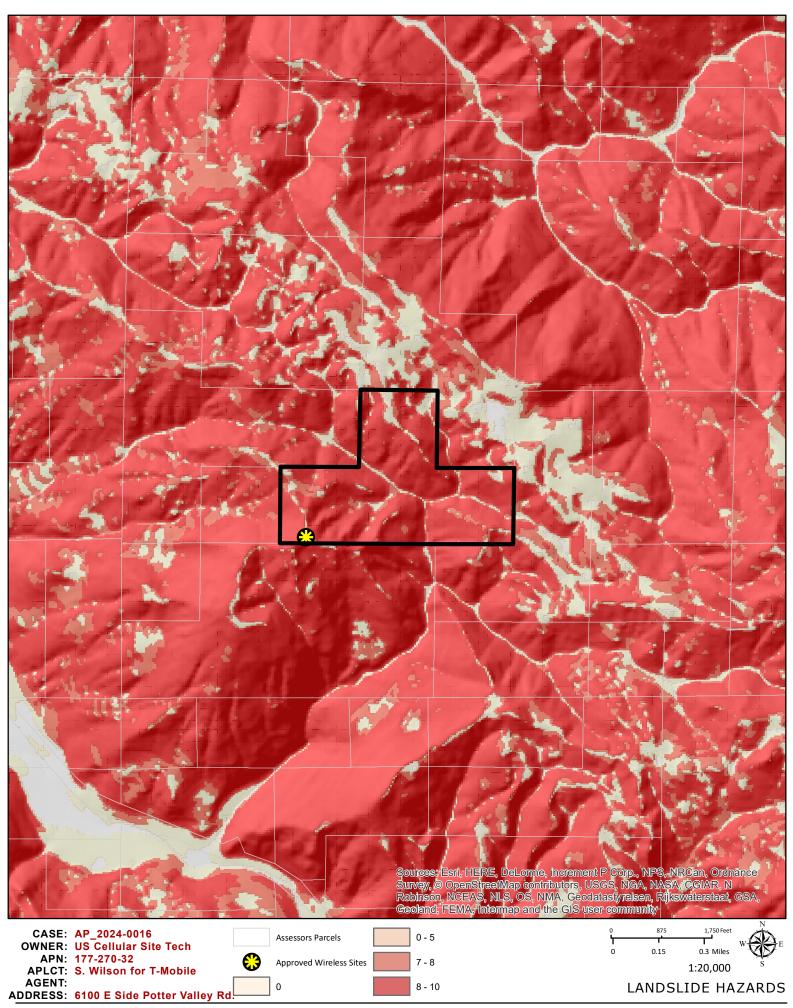


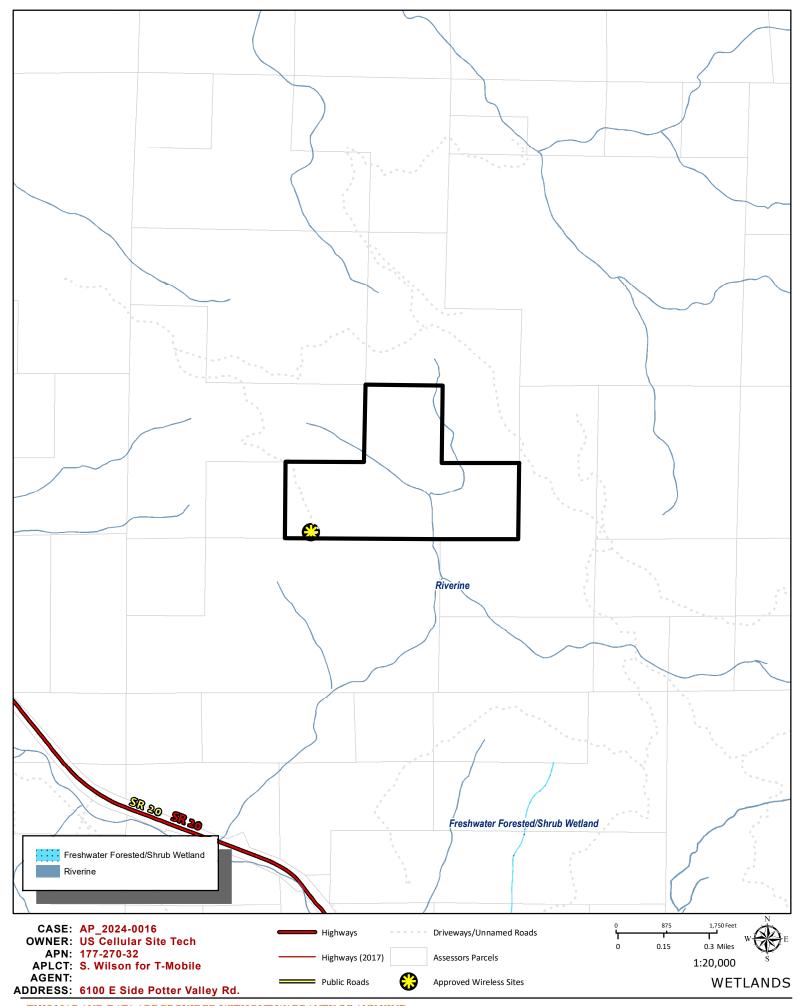


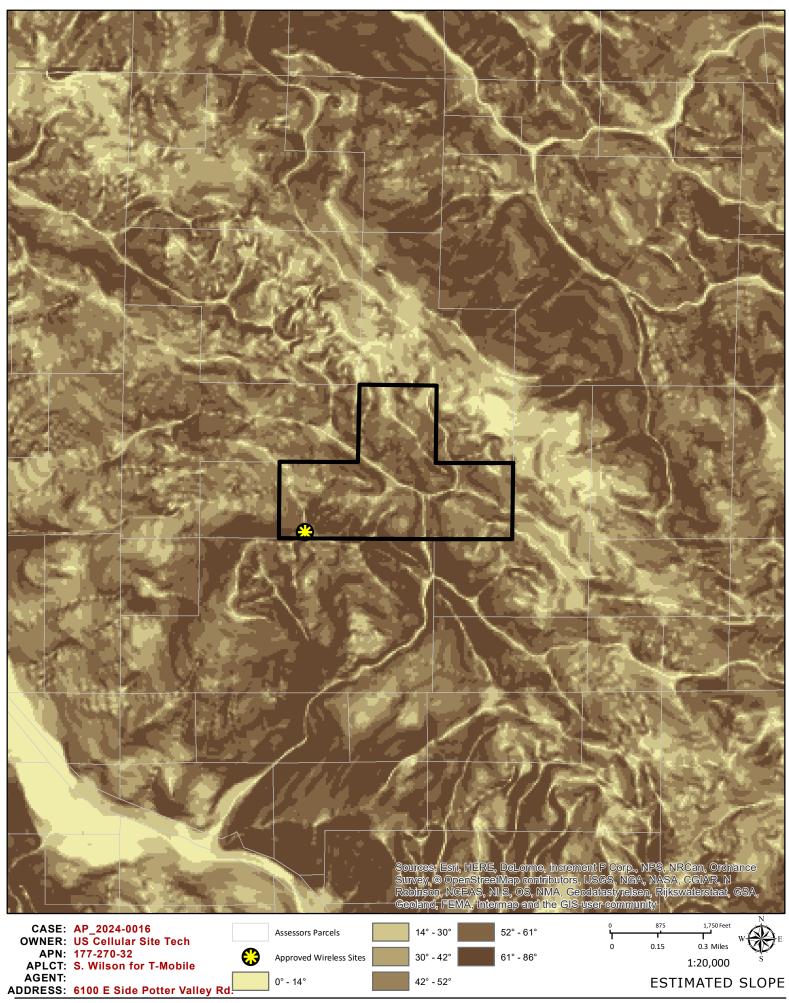

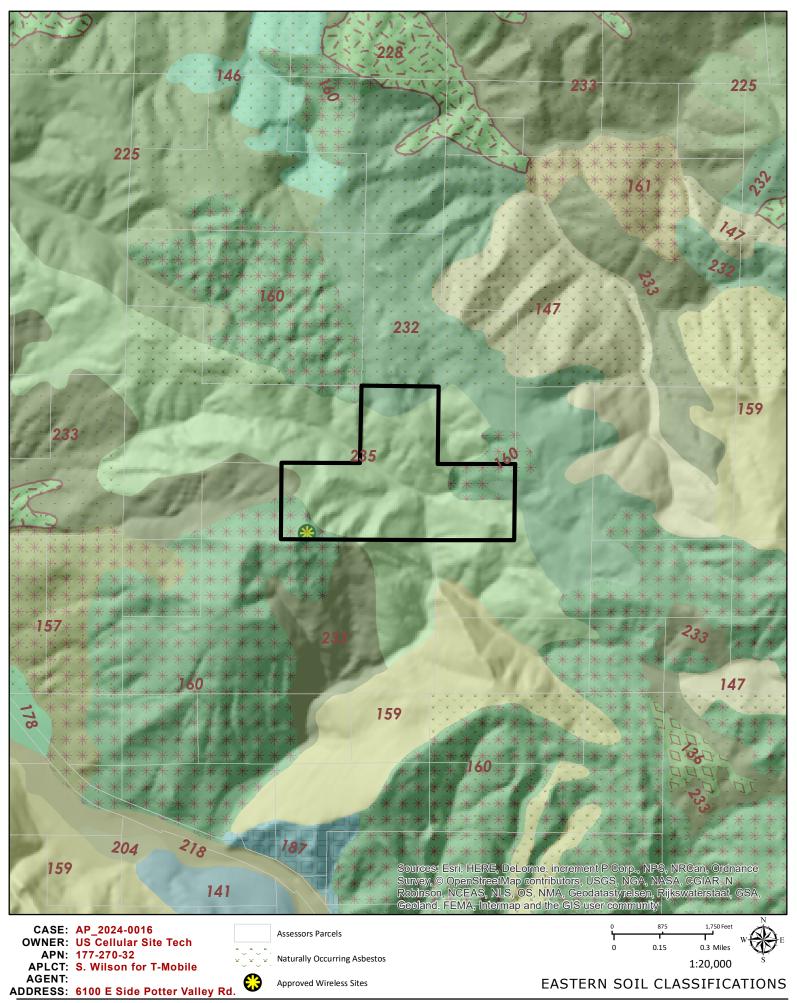

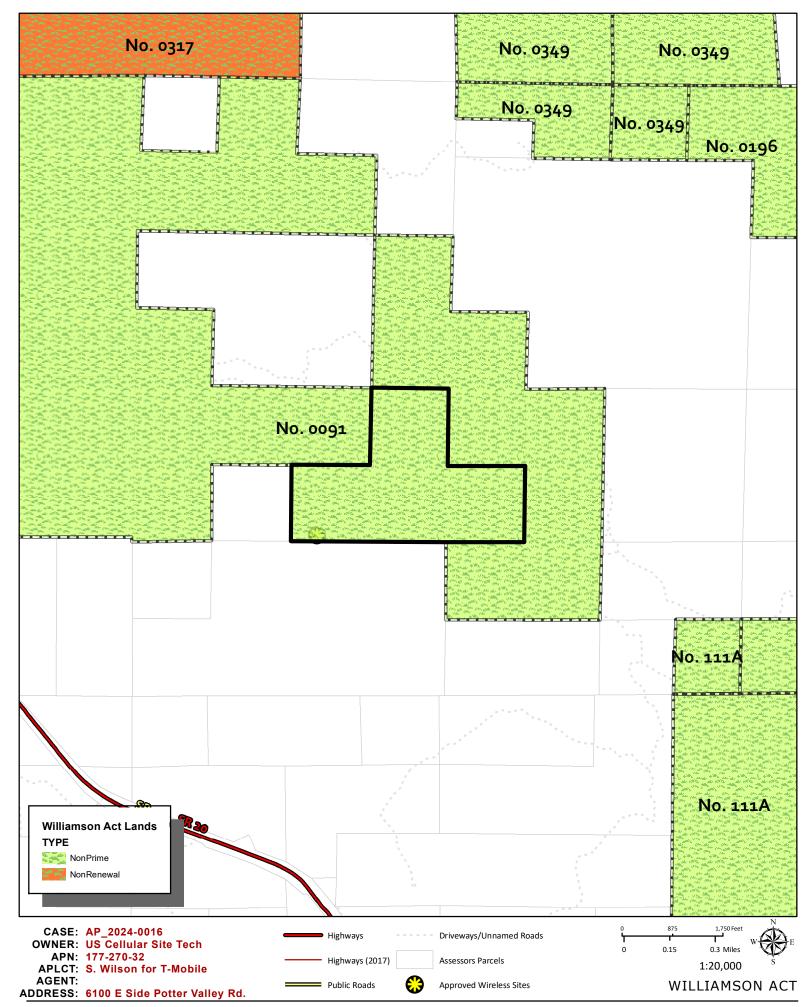

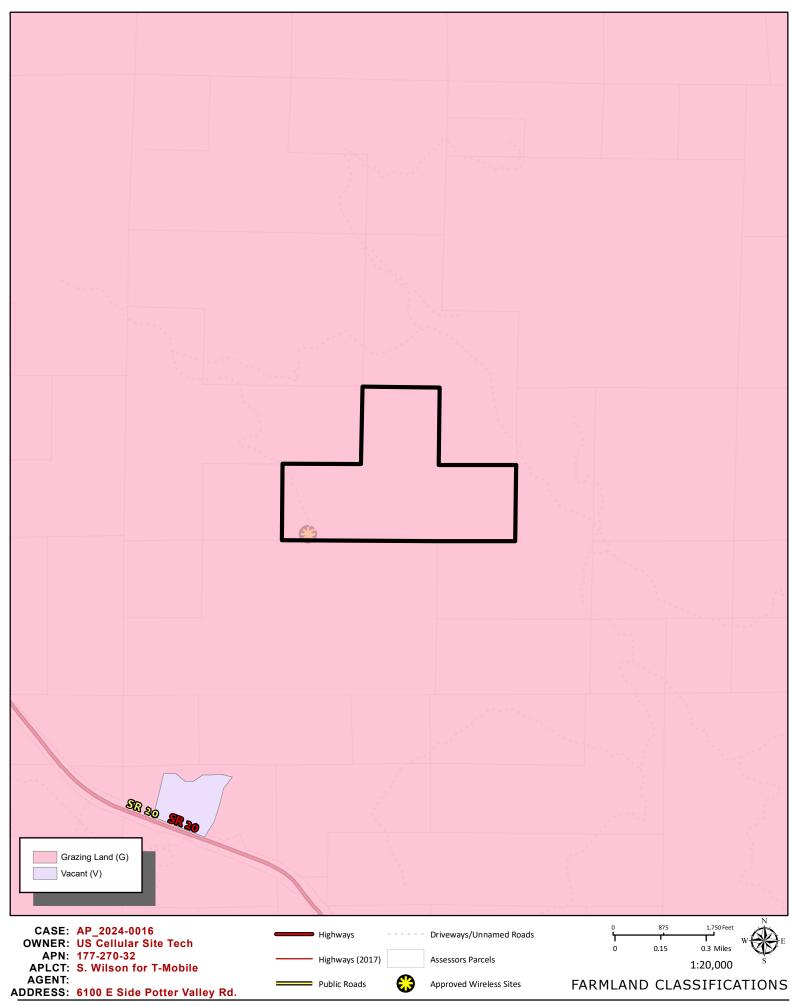

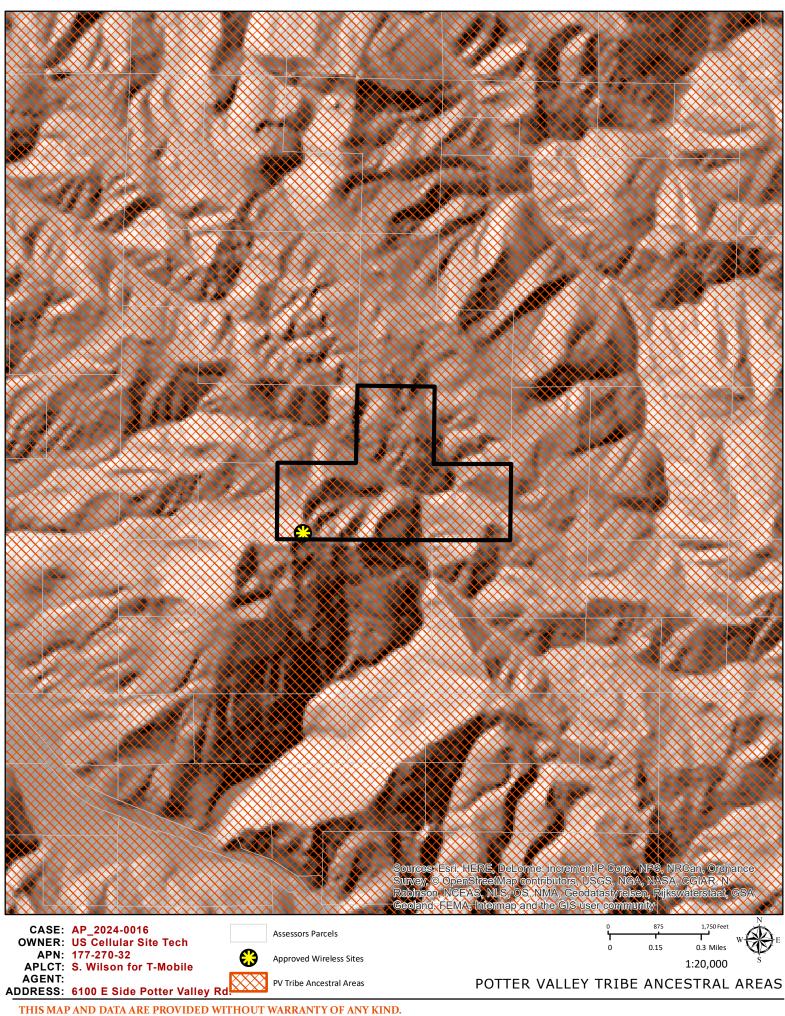

DO NOT USE THIS MAP TO DETERMINE LEGAL PROPERTY BOUNDARIES



Planning and Building Services

Case No <u>:</u>	
CalFire No:	
Date Filed:	
Fee:	
Receipt No:	
Received By:	
	Office use only

### **APPLICATION FORM**

APPLICANT Name:	S. Wilson for T	-Mobile		Phon	ne:
Mailing Address:	S. Wilsor	for T-Mobi	le		
City: Concord	1	State/Zip:	94520	email	il: S.Wilson@thecbrgroup.com
		ar Site Tec	h	Dhon	ne: (707) 498-7503
Mailing				FIIOII	<u>ie. (101) <del>4</del>30-1303</u>
				email	il:
AGENT Name:				Phon	ne:
Mailing Address:					
City:		State/Zip:		email	il:
Parcel Size: 1	60 Acres	(Sq. feet/Acre	es) Address of Prope	erty <u>:</u> 6	6100 E Side Potter Valley Road, Potter Valley
Assessor Parc	el Number(s):				177-270-32
TYPE OF APPL	ICATION:				
Administrati Agricultural CDP- Admir CDP- Stand Certificate o Developmer Exception	Preserve I Use 1 ard f Compliance		Flood Hazard General Plan Amendme Land Division-Minor Land Division-Parcel Land Division-Resubdiv Modification of Conditio Reversion to Acreage	rision	<ul> <li>Rezoning</li> <li>Use Permit-Cottage</li> <li>Use Permit-Minor</li> <li>Use Permit-Major</li> <li>Variance</li> <li>Other</li> </ul>
l certify that the	information subn	nitted with th	nis application is tru	e and ac	ccurate.
A. 4	Je		3/8/2024		
Signature of Applic	ant/Agent	Date		Signature	re of Owner Date

Z:\1.PBS Forms\COMPLETED Form\Planning Application-2015.docx Page - 1

### SITE AND PROJECT DESCRIPTION QUESTIONNAIRE

The purpose of this questionnaire is to relate information concerning your application to the Department of Planning and Building Services and other agencies who will be reviewing your project proposal. Please remember that the clearer picture that you give us of your project and the site, the easier it will be to promptly process your application. Please answer all questions. Those questions which do not pertain to your project please indicate "Not applicable" or "N/A".

### THE PROJECT

1.	Describe your project. Include secondary improvements such as wells, septic systems, grading, vegetation removal, roads, etc.							
ANTENNA AREA: 1. REPLACE (6)(E) ANTENNAS WITH (6)(N) ANTENNAS FINAL QTY: (6) -2. REPLACE (3)(E) RADIOS WITH (3)(N) RADIOS AND ADD (3)(N) RADIOS - TOTAL 6 3. REMOVE (6)(E) TMAS -4. REMOVE (12)(E) COAX CABLES								
	EQUIPMENT AREA:							
2. Str	uctures/Lot Coverage	Number (			Square Footage			
Si   Ma   Du   Du   M   Of	ngle Family obile Home uplex N/A lultifamily her:	Existing Shrub/Scrub 10	Proposed	Existing	Proposed	Total		
Area La Unimpro	ructures Paved ndscaped Area oved Area							
GRANE	) TOTAL (Equal to gross area or	f Parcel)						

3.	If the project is commercial, industrial or institutional, complete the following:	
	Estimated employees per shift: Existing: Unmanned wireless communications facility. Estimated shifts per day: Type of loading facilities proposed:	
4.	Will the proposed project be phased?  Yes X No If yes, explain your plans for phasing:	
5.	Will vegetation be removed on areas other than the building sites and roads? ☐Yes XNo Explain:	
6.	Will the project involve the use or disposal of potentially hazardous materials such as toxic substances, flammable or explosives?	S,
7.	How much off-street parking will be provided?          Number       Size         Number of covered spaces	
	Existing Number of Spaces Proposed Additional Spaces Total	
8.	Is any road construction or grading planned? Yes XNo If yes, grading and drainage plans may be required. Also, describe the terrain to be traversed (e.g., steep, moderate slope, flat, etc.).	
9.	For grading or road construction, complete the following:	
	A. Amount of cut       cubic yards         B. Amount of fill       cubic yards         C. Maximum height of fill slope       feet       N/A         D. Maximum height of cut slope       feet       Feet         E. Amount of import or export       cubic yards       cubic yards         F. Location of borrow or disposal site       cubic yards       cubic yards	
	·	

10.	Does the project involve sand removal, mining or gravel extraction?  Yes Yes Yes You Y
11.	Will the proposed development convert land currently or previously used for agriculture to another use?
	If yes, how many acres will be converted?acres. An agricultural economic feasibility study may be required.
12.	Will the development provide public or private recreational opportunities?  Yes  No If yes, explain below:
13.	Is the proposed development visible from State       14.       Is the proposed development visible from a park, beach or other recreational area?         □Yes       ☑No       □Yes       ☑No
15.	Does the development involve diking, filling, dredging or placing structures in open coastal water, wetlands, estuaries or lakes?
	Diking :       Yes       XNo       Placement of structures in:         Filling:       Yes       XNo       Open coastal waters         Dredging:       Yes       XNo       Wetlands         Estuaries       Iakes       Iakes
	If so, amount of material to be dredged or filled?cubic yards. Location of dredged material disposal site?
	Has a U.S. Army Corps of Engineers permit been applied for?  Yes  No
16.	Will there be any exterior lighting? □Yes □No If yes, describe below and identify the location of all exterior lighting on the plot plan and building plans. REPLACE (1)(E) HALOGEN WORK LIGHT WITH (1)(N) LED SERVICE LIGHT
17.	Utilities will be supplied to the site as follows: A. Electricity: []Utility Company (service exists to the parcel) []Utility Company (requires extension of service to site:feetmiles) []On Site Generation - Specify:
	B. Gas: Utility Company/Tank On Site Generation - Specify: XNone
	C. Telephone: Yes XNo
18.	What will be the method of sewage disposal?  Community sewage system - Specify supplier  Septic Tank  Other - Specify:
19.	What will be the domestic water source: Community water system - Specify supplier <u>N/A</u> Well Spring Other - Specify:

20.	Are there any associated projects and/or adjacent properties under your ownership? Yes XNo If yes, explain (e.g., Assessor's Parcel Number, address, etc.	):
- - -		
21.	List and describe any other related permits and other public approval required for this project, inc by other County departments, city, regional, state and federal agencies:	luding those required
. 22.	Describe the location of the site in terms of readily identifiable landmarks (e.g., mailboxes, mile p	osts, street
-	intersections, etc.): <u>From Ukiah head N. on 101 to Upper Lake/ Hwy. 20 exit. Head E on Hwy 20 past la Mendocino and Left at Potter Valley/ Lake Pillsbury exit. 1/2 mile on right is the gate "Cold Creek Compose". Follow road to site.</u>	
23.	Are there existing structures on the property? XYes No If yes, describe below, and identify the use of each structure on the plot plan or tentative map if t subdivision.	he proposal is for a
	See Site Plan in included Drawings.	
24.	Will any existing structures be demolished or removed? Yes XNo If yes, describe the type of development to be demolished or removed, including the relocation si	te, if applicable.
25.	Project Height. Maximum height of existing structures <u>150</u> feet. Maximum height of proposed st	tructures <u>150</u> feet.
26. N/A	A Gross floor area of existing structuressquare feet (including covered parking and accessory area of proposed structuressquare feet (including covered parking and accessory buildings)	
27. N/A	Lot area (within property lines):	
28.	Briefly describe the project site as it exists before the project, including information on existing struses, slopes, soil stability, plants and animals, and any cultural, historical or scenic aspects. Atta the site that you feel would be helpful.	
	Existing unmanned wireless facility.	
29.	Briefly describe the surrounding properties, including information on plants, animals and any cultu aspects. Indicate the type of land use (use chart below) and its general intensity. Attach any plattic that you feel would be helpful. Shrub/Scrub 106.95 ac (64.9%), Shrubland 145.21a	otographs of the vicinity
30.	Indicate the surrounding land uses: North East South	West
	Vacant VACANT VACANT Residential Agricultural Commercial Industrial	
	Institutional Timberland	A '
	Other Agricultural	Agricultural

Z:\1.PBS Forms\COMPLETED Form\Planning Application-2015.docx Page - 6





March 8, 2024

County of Mendocino Planning & Building Services 860 N Bush Street Ukiah, CA 95482 cliserm@mendocinocounty.org fordr@mendocinocounty.org

# Applicant:T-Mobile (Agent: The CBR Group)Site Address:6100 E Side Potter Valley Rd.Site ID:SF40855A / Project: SF40855A-0002367665

Re: Eligible Facilities Request - Modify Communications Facility at **6100 E Side Potter Valley Road, Potter Valley CA 95482**.

### To Whom it May Concern:

Please find along with this application the following supporting documents:

- 1. Planning Application
- 2. 100% CDs
- 3. Acknowledgement Deposit Form
- 4. Letter of Authorization (T-Mobile)
- 5. Lease Agreement
- 6. T-Mobile Radio Frequency Report
- 7. Section 6409(a) Eligible Facilities Request (EFR) Cover Letter
- A. T-Mobile is Filing an Eligible Facilities Request

The CBR Group on behalf of T-Mobile is submitting the attached Eligible Facilities Request application to add, remove, modify, or replace Transmission Equipment (the "Request") at a Tower located at 6100 E Side Potter Valley Rd, Potter Valley CA 95482.

This Request is governed by Section 6409 of the Middle-Class Tax Relief and Job Creation Act of 2012, commonly known as the "Spectrum Act" (Pub. Law No. 112-96, 126 Stat 156). Section 6409(a) of the Spectrum Act states that state and local governments "may not deny, and shall approve, any eligible facilities request for a modification of an existing wireless tower or base station that does not substantially change the physical dimensions of such tower or base station." Under Section 6409, an Eligible Facilities Request is any request to modify a Tower or Base Station that involves "collocations of new Transmission Equipment," "removal," or "replacement" of Transmission Equipment.

B. Why this Eligible Facilities Request Must Be Granted.

Consistent with federal law, the enclosed Request involves a proposal to collocate, remove, modify, or replace Transmission Equipment at an existing tower for use by a Federal Communications Commission ("FCC") licensed





wireless carrier. The existing Tower is a structure that is 150' high and presently contains wireless facilities. The existing Tower meets the Federal Communications Commission ("FCC") definition of a Tower.

In a Report and Order adopted on October 17, 2014, the FCC determined that any modification to an existing telecommunications Tower that meets the following six criteria does not substantially change the physical dimensions of the existing Tower and therefore is an Eligible Facilities Request which must be granted:

- The modifications to the Transmission Equipment do not increase the height of the Tower by twenty (20) feet or ten (10%) percent, whichever is greater.
- 2. The mounting of the proposed antenna does not involve adding an appurtenance to the body of the base station that would protrude from the edge of the base station more than 20 feet, or more than the width of the base station at the level of the appurtenance, whichever is greater; and
- 3. The modifications to the Transmission Equipment do not involve the installation of more than the standard number of equipment cabinets for the technology involved, not to exceed four.
- 4. The modifications to the Transmission Equipment do not entail any excavation or deployment outside of the Tower site.
- 5. The modifications to the Transmission Equipment do not defeat any existing concealment elements of the Tower.
- 6. The modifications to the Transmission Equipment comply with prior conditions of approval of the Tower, unless the non-compliance is due to an increase in height, increase in width, addition of equipment cabinets, or new excavation that does not exceed the corresponding "substantial change" thresholds in numbers 1-4.

The proposed project will involve Modification of an Existing Cell Site. This work does not constitute a substantial change under the criteria above because it:

1) Will not increase the height of the Tower by more than ten percent (10%) or ten (20) feet, whichever is greater.

**Details:** The proposed project will not increase the height of the Tower by more than ten percent (10%) or ten (20) feet, whichever is greater.

2) The modifications to the Transmission Equipment do not protrude from the edge of the Tower by twenty (20) feet or more than the width of the base station at the level where the transmission equipment modifications are made.

**Details:** The modifications to the Transmission Equipment do not protrude from the edge of the Tower by twenty (20) feet or more than the width of the base station.

3) Does not defeat any existing concealment elements.

**Details:** The proposed project will not defeat any existing concealment elements.

4) Does not entail any excavation outside the current Tower site.

**Details:** The proposed project will not involve excavations outside the current Tower site.





5) Does not involve the installation of more than the standard number of equipment cabinets for the technology involved, not to exceed four.

**Details:** The proposed project will involve the installation of 2 new cabinets and removal of 0 old cabinets.

6) The proposed project complies with prior conditions of approval of the Tower, except for any non-compliance that is due to an increase in height, increase in width, addition of equipment cabinets, or new excavation that does not exceed the thresholds above.

**Response:** The proposed project complies with prior conditions of approval of the Tower.

Similarly, the list of equipment that will be installed as part of this Request qualifies as Transmission Equipment, which the FCC defines as "any equipment that facilitates transmission for any Commission-licensed or authorized wireless communication service, including, but not limited to, radio transceivers, antennas and other relevant equipment associated with and necessary to their operation, including coaxial or fiber-optic cable, and regular and back-up power supply. This definition includes equipment used in any technological configuration associated with any Commission-authorized or unlicensed, terrestrial or satellite, including commercial mobile, private mobile, broadcast and public safety services, as well as fixed wireless services such as microwave backhaul or fixed broadband."

In sum, the modifications to the Transmission Equipment at the Tower located at **6100 E Side Potter Valley Road** fully conform to the requirements of the Spectrum Act. Accordingly, this Request must be approved within 60 days, as outlined below.

C. Notice of Federal Law Expedited Permit Processing and Deemed Granted

Under federal law, an Eligible Facilities Request is deemed granted sixty (60) days after a complete application is filed. Thus, if sixty days pass after the submission of the Request and the City/County has not acted to grant or deny the Request, it will be deemed granted. At that time, the applicant may advise the City/County that the application has been deemed granted. If the City/County wishes to contest whether Request has been deemed granted, the burden is on the City/County to file a lawsuit in a court of competent jurisdiction within 30 days after receipt of a written communication notifying it that the Request has been deemed granted.

T-Mobile is committed to working cooperatively with you to process this request in a timely and efficient manner. Please do not hesitate to contact me if you have questions.

Sincerely,

S.Wilson@thecbrgroup.com The CBR Group, authorized agent for T-Mobile

Attachments