COUNTY OF MENDOCINO DEPARTMENT OF PLANNING AND BUILDING SERVICES

860 NORTH BUSH STREET · UKIAH · CALIFORNIA · 95482 120 WEST FIR STREET · FT. BRAGG · CALIFORNIA · 95437 JULIA KROG, DIRECTOR TELEPHONE: 707-234-6650 FAX: 707-463-5709 FB PHONE: 707-964-5379 FB FAX: 707-961-2427 pbs@mendocinocounty.gov www.mendocinocounty.org/pbs

April 30, 2024

Department of Transportation Environmental Health - Ukiah Building Inspection - Ukiah Assessor Air Quality Management Department of Forestry/ CalFire
-Land Use
Department of Fish and Wildlife
Laytonville Municipal Advisory Council

Cloverdale Rancheria Redwood Valley Rancheria Sherwood Valley Band of Pomo Indians Long Valley Fire District

CASE#: AP_2024-0015 **DATE FILED:** 3/12/2024

OWNER: CROWN CASTLE GT COMPANY LLC

APPLICANT: T-MOBILE WEST LLC BY CROWN CASTLE USA INC.

AGENT: VICTORIA CHHUN, CROWN CASTLE

REQUEST: Administrative Permit to authorize an eligible facilities request for modifications to an existing wireless communication facility that includes the installation of one (1) microwave dish, one (1) microwave cable, and one (1) fiber cable on an existing sixty-five foot (65') tall monopole tower.

LOCATION: 9± miles northeast of Laytonville, on the north side of Spyrock Road (CR 323) 4.4± miles northeast

of its intersection with U.S. Route 101, located at 3750 Spyrock Road, Laytonville; (APN: 056-310-18).

SUPERVISORIAL DISTRICT:

STAFF PLANNER: LIAM CROWLEY **RESPONSE DUE DATE:** May 14, 2024

PROJECT INFORMATION CAN BE FOUND AT:

www.mendocinocounty.org

Select "Government" from the drop-down; then locate Planning and Building Services/Public Agency Referrals.

Mendocino County Planning & Building Services is soliciting your input, which will be used in staff analysis and forwarded to the appropriate public hearing. You are invited to comment on any aspect of the proposed project(s). Please convey any requirements or conditions your agency requires for project compliance to the project coordinator at the above address, or submit your comments by email to pbs@mendocinocounty.org. Please note the case number and name of the project coordinator with all correspondence to this department.

We have reviewed the above ap	oplication and recommend the following	g (please check one):
☐ No comment at this time.		
☐ Recommend conditional app	proval (attached).	
	al information (attach items needed, or ses in any correspondence you may ha	contact the applicant directly, copying ave with the applicant)
Recommend denial (Attach	reasons for recommending denial).	
☐ Recommend preparation of	an Environmental Impact Report (attac	ch reasons why an EIR should be required).
Other comments (attach as	necessary).	
REVIEWED BY:		
Signature	Department	Date

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APN/S: 056-310-18

PARCEL SIZE: 0.5± Acres

GENERAL PLAN: Remote Residential 20-Acre Minimum (RMR:40)

ZONING: Upland Residential (UR-20)

EXISTING USES: Wireless Communication Facility

DISTRICT: 4 (Gjerde)

RELATED CASES: See below.

	ADJACENT GENERAL PLAN	ADJACENT ZONING	ADJACENT LOT SIZES	ADJACENT USES
NORTH:	Remote Residential (RMR:20)	Upland Residential (UR-20)	20.12± Acres	Residential/Agricultural
EAST:	Remote Residential (RMR:20)	Upland Residential (UR-20)	20.12± Acres	Residential/Agricultural
SOUTH:	Remote Residential (RMR:20)	Upland Residential (UR-20)	20.12± Acres	Residential/Agricultural
WEST:	Remote Residential (RMR:20)	Upland Residential (UR-20)	20.12± Acres	Residential/Agricultural

REFERRAL AGENCIES

LOCAL

☒ Air Quality Management District☒ Assessor's Office☒ Building Division (Ukiah)

☑ Department of Transportation (DOT)

⊠ Environmental Health (EH)

☑ Long Valley Fire District☑ Laytonville MAC

STATE

☑ CALFIRE (Land Use)

□ California Dept. of Fish & Wildlife

TRIBAL

☑ Cloverdale Rancheria☑ Redwood Valley Rancheria

☑ Sherwood Valley Band of Pomo Indians

ADDITIONAL INFORMATION: Related projects include the following.

U 26-98: Use Permit in 2 phases: Phase 1 – to add three 15-foot antennas and one 3.88-inch GPS antenna to an existing 20 foot pole; Phase 2 – to replace the existing pole with a 75 foot monopole with nine 4-foot panel antennas, two 10-foot microwave dishes and four 15-foot whip antennas, not to exceed 90 feet. The Planning Commission approved only Phase 1 of this project on 05/06/1999.

UM 26-98/2002: Modification of use permit to allow the construction of a 12 foot by 15-foot equipment shelter and to mount one 3-inch GPS antenna and three additional 15-foot omni antennas to an existing 20-foot monopole at an existing telecommunications facility, for a total of six 15-foot omni antennas at the facility. Total project height of 35 feet will not be increase. Approved 10/03/2002.

U 5-2005: Use Permit to reinstate an expired Use Permit Modification (#UM 26-98/2002) for a wireless telecommunication site. No change is proposed to the existing facility consisting of three (3) 15-foot whip antennas and three (3) 4-foot panel antennas attached to a 20-foot monopole (for a total height of 35 feet), an 11'6" x 15' equipment shelter on a concrete slab, a generator, transformer and GPS antenna. Approved 10/20/2005. **U 3-2009:** Use Permit to replace an existing 30 foot tall monopole with a wireless telecommunication facility able to support two wireless providers (T-Mobile and Verizon Wireless) consisting of a 50-foot tall "monopine" (monopole designed to resemble a pine tree), six panel antennas, one microwave dish and ground based equipment. Approved 10/15/2009.

UM 3-2009/2012: Use Permit Modification to add one (1) 52.4 inch diameter microwave dish to an existing 45 foot tall "monopine" (monopole designed to resemble a pine tree). Approved 07/19/2012.

UM 3-2009/2014: Modification of existing Use Permit to extend the height of a tower from 50 feet to 70 feet. Also, installation of three (3) new antennas per sector for a total of nine (9) new antennas at the 58 foot centerline of the 70 foot monopole, and a 138 square foot equipment shelter to house a standard number of equipment cabinets and a 50 kilowatt diesel generator with a 132 gallon diesel fuel tank. Approved 12/18/2014.

UM_2020-0004: Modification of an existing Use Permit (UM 3-2009/2014), permitting AT&T Mobility to install new equipment in the existing compound area and increase the height of the existing tower by 20 ft. The request also includes installation of a 30 KW Generac Diesel Generator with a 190 gallon associated fuel storage tank, as well as various equipment and antenna additions to the tower itself. No action was taken by the Planning Commission, but the project was deemed approved on 03/18/2021.

AP_2016-0019: Administrative Permit to add a backup generator and propane fuel tank to an existing Cell Tower facility. Approved 10/06/2016.

STAFF PLANNER: LIAM CROWLEY DATE: 4/22/2024

ENVIRONMENTAL DATA

1. MAC:

GIS

Laytonville MAC

2. FIRE HAZARD SEVERITY ZONE:

CALFIRE FRAP maps/GIS

Moderate

3. FIRE RESPONSIBILITY AREA:

CALFIRE ERAP mans/GI

State Responsibility Area (SRA)

4. FARMLAND CLASSIFICATION:

GIS

Grazing Land (G)

5. FLOOD ZONE CLASSIFICATION:

FEMA Flood Insurance Rate Maps (FIRM)

None

6. COASTAL GROUNDWATER RESOURCE AREA:

Coastal Groundwater Study/GIS

N/A

7. SOIL CLASSIFICATION:

Mendocino County Soils Study Eastern/Western Parl Western Soil Class Unit No. 202

8. PYGMY VEGETATION OR PYGMY CAPABLE SOIL:

LCP maps, Pygmy Soils Maps; GIS

N/A

9. WILLIAMSON ACT CONTRACT:

GIS/Mendocino County Assessor's Office

No

10. TIMBER PRODUCTION ZONE:

GIS

No

11. WETLANDS CLASSIFICATION:

ois None

12. EARTHQUAKE FAULT ZONE:

Earthquake Fault Zone Maps; GIS

None

13. AIRPORT LAND USE PLANNING AREA:

Airport Land Use Plan; GI

None

14. SUPERFUND/BROWNFIELD/HAZMAT SITE:

GIS; General Plan 3-11

No

15. NATURAL DIVERSITY DATABASE:

CA Dept. of Fish & Wildlife Rarefind Database/GIS

None

16. STATE FOREST/PARK/RECREATION AREA ADJACENT:

GIS; General Plan 3-10

No

17. LANDSLIDE HAZARD:

Hazards and Landslides Map: GIS: Policy RM-61: General Plan 4-44

Nο

18. WATER EFFICIENT LANDSCAPE REQUIRED:

Policy RM-7; General Plan 4-34

No

19. WILD AND SCENIC RIVER:

www.rivers.gov (Eel Only): GIS

No

20. SPECIFIC PLAN/SPECIAL PLAN AREA:

Various Adonted Specific Plan Areas: GIS

No

21. STATE CLEARINGHOUSE REQUIRED:

Polic

No

22. OAK WOODLAND AREA:


No.

740

23. HARBOR DISTRICT:

Sec. 20.51

No

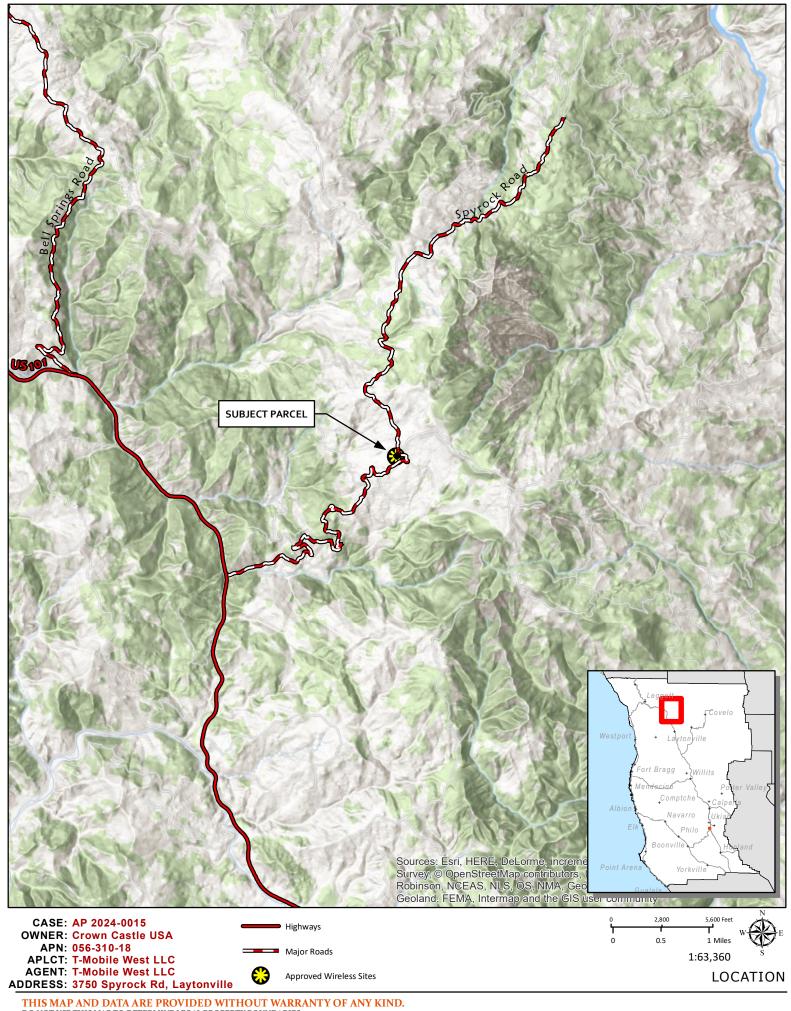






CASE: AP 2024-0015 **OWNER: Crown Castle USA**

APN: 056-310-18
APLCT: T-Mobile West LLC
AGENT: T-Mobile West LLC
ADDRESS: 3750 Spyrock Rd, Laytonville

Public Roads Approved Wireless Sites

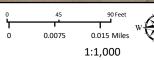

AERIAL IMAGERY

T--Mobile--

T-MOBILE SITE NUMBER: SF40873A

T-MOBILE SITE NAME: **CCI-CUMMINGS**

MICROWAVE UPGRADE T-MOBILE PROJECT:


BUSINESS UNIT #: 814448 3750 SPYROCK ROAD **SITE ADDRESS:**

LAYTONVILLE, CA 95454 **MENDOCINO COUNTY: MONOPOLE**

SITE TYPE:

65'-0" **TOWER HEIGHT:**

LOCATION MAP

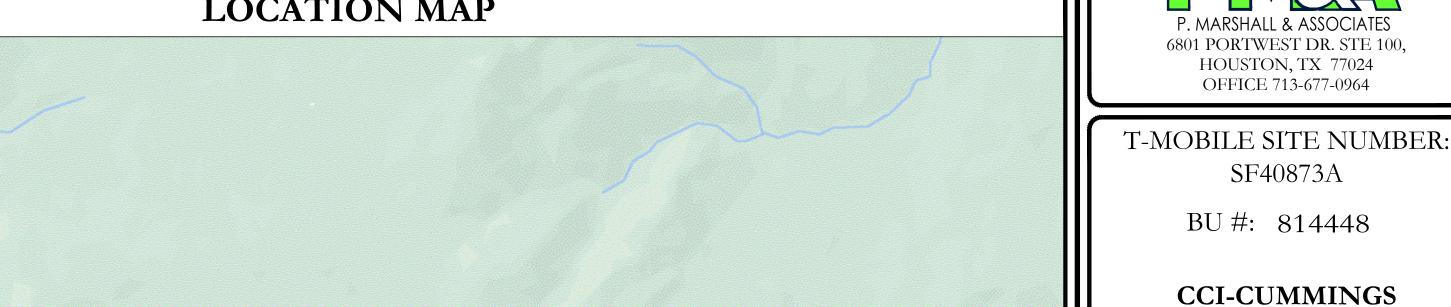

T··Mobile···

1200 CONCORD AVENUE, SUITE 500 CONCORD, CA 94520

1 PARK PLACE, SUITE 300

DUBLIN, CA 94568

HOUSTON, TX 77024

OFFICE 713-677-0964

SF40873A

BU #: 814448

CROWN

3750 SPYROCK ROAD LAYTONVILLE, CA 95454

> EXISTING 65'-0" MONOPOLE

_						
	ISSUED FOR:					
REV	DATE	DRWN	DESCRIPTION	DES./QA		
Α	02/20/24	MAS	PRELIMINARY	HS		
0	02/23/24	MAS	FINAL CD	HS		

Junction of Spyrock and Crestview (or... SITE ID: SF40873A LAT: 39.816058 LONG: -123.509414 Google Map data ©2024

3750 SPYROCK ROAD

CUMMINGS

SITE INFORMATION

SITE ADDRESS: LAYTONVILLE, CA 95454

COUNTY: MENDOCINO 056-310-18 MAP/PARCEL #: AREA OF CONSTRUCTION: **EXISTING** 39.816058 LATITUDE: LONGITUDE: -123.509414 NAD83 LAT/LONG TYPE: 3372.8' GROUND ELEVATION: CURRENT ZONING: UR 20

JURISDICTION: COUNTY OF MENDOCINO, CA

OCCUPANCY CLASSIFICATION: U TYPE OF CONSTRUCTION:

CROWN CASTLE USA INC.

SITE NAME:

A.D.A. COMPLIANCE: FACILITY IS UNMANNED AND NOT FOR

HUMAN HABITATION

CROWN CASTLE GT COMPANY LL PROPERTY OWNER:

4017 WASHINGTON RD MCMURRAY, PA 15317

TOWER OWNER: CROWN CASTLE USA, INC. 1 PARK PLACE, SUITE 300

DUBLIN, CA 94568

CARRIER/APPLICANT: T-MOBILE

1200 CONCORD AVENUE, SUITE 500 CONCORD, CA 94520

ELECTRIC PROVIDER: PACIFIC GAS & ELECTRIC

(800) 743-5000

TELCO PROVIDER:

ALL DRAWINGS CONTAINED HEREIN ARE FORMATTED FOR 22X34. CONTRACTOR SHALL VERIFY ALL PLANS AND EXISTING DIMENSIONS AND CONDITIONS ON E JOB SITE AND SHALL IMMEDIATELY NOTIFY THE ENGINEER IN WRITING OF ANY DISCREPANCIES BEFORE PROCEEDING WITH THE WORK OR BE RESPONSIBLE FOR SAME.

SHEET#

TITLE SHEET

SITE PLAN

GENERAL NOTES

OVERALL SITE PLAN

TOWER ELEVATIONS

GROUNDING DETAILS

GROUNDING DETAILS

FINAL MICROWAVE PLAN

CALL CALIFORNIA ONE CALL (800) 227-2600 CALL 3 WORKING DAYS

DRAWING INDEX

EXISTING & FINAL EQUIPMENT PLANS

FINAL MICROWAVE EQUIPMENT SCHEDULE

SKYWARE GLOBAL 1.2M KU-BAND MW SPECS

MICROWAVE CABLE SPECIFICATIONS

MICROWAVE GROUNDING DIAGRAM

SHEET DESCRIPTION



P. MARSHALL & ASSOCIATES, LLC

6801 PORTWEST DR, SUITE 100 HOUSTON, TX 77024 (713) 677-0964

PROJECT TEAM

CROWN CASTLE USA INC.

DISTRICT CONTACTS:

A&E FIRM:

1 PARK PLACE, SUITE 300 DUBLIN, CA 94568

PROJECT DESCRIPTION

BEFORE YOU DIG!

THE PURPOSE OF THIS PROJECT IS TO ENHANCE BROADBAND CONNECTIVITY AND CAPACITY TO THE EXISTING ELIGIBLE WIRELESS FACILITY.

TOWER SCOPE OF WORK:

• INSTALL (1) MICROWAVE

• INSTALL (1) MW CABLE: (1) 1/4" FIBER CABLE

GROUND SCOPE OF WORK: • NO GROUND WORK NEEDED

APPLICABLE CODES/REFERENCE DOCUMENTS

NO SCALE

ALL WORK SHALL BE PERFORMED AND MATERIALS INSTALLED IN ACCORDANCE WITH THE CURRENT EDITIONS OF THE FOLLOWING CODES AS ADOPTED BY THE LOCAL GOVERNING AUTHORITIES. NOTHING IN THESE PLANS IS TO BE CONSTRUED TO PERMIT WORK NOT CONFORMING TO THESE CODES:

CODE TYPE BUILDING

CODE

MECHANICAL ELECTRICAL

2022 CALIFORNIA BUILDING CODE (CBC)/2021 IBC 2022 CALIFORNIA MECHANICAL CODE (CMC)/2021 UMC 2022 CALIFORNIA ELECTRICAL CODE (CEC)/2020 NEC

REFERENCE DOCUMENTS:

STRUCTURAL ANALYSIS: TELAMON DATED: 02/05/24MOUNT ANALYSIS: TOWER ENGINEERING PROFESSIONAL

DATED: 01/24/24 ORDER ID: 661913 REVISION: 0



IT IS A VIOLATION OF LAW FOR ANY PERSON, UNLESS THEY ARE ACTING UNDER THE DIRECTION OF A LICENSED PROFESSIONAL ENGINEER, TO ALTER THIS DOCUMENT.

PROJECT NUMBER: **24CCTCAM-012**

SHEET NUMBER:

REVISION:

2022 CALIFORNIA FIRE CODE (CFC)/2021 IFC

PRIOR TO ACCESSING/ENTERING THE SITE YOU MUST CONTACT THE CROWN NOC AT (800) 788-7011 & CROWN CONSTRUCTION MANAGER.

CROWN CASTLE USA INC. SITE ACTIVITY REQUIREMENTS:

- NOTICE TO PROCEED- NO WORK SHALL COMMENCE PRIOR TO CROWN CASTLE USA INC. WRITTEN NOTICE TO PROCEED (NTP) AND THE ISSUANCE OF A PURCHASE ORDER. PRIOR TO ACCESSING/ENTERING THE SITE YOU MUST CONTACT THE CROWN CASTLE USA INC. NOC AT 800-788-7011 & THE CROWN CASTLE USA INC. CONSTRUCTION MANAGER.
- 2. "LOOK UP" CROWN CASTLE USA INC. SAFETY CLIMB REQUIREMENT: THE INTEGRITY OF THE SAFETY CLIMB AND ALL COMPONENTS OF THE CLIMBING FACILITY SHALL BE CONSIDERED DURING ALL STAGES OF DESIGN, INSTALLATION, AND INSPECTION. TOWER MODIFICATION, MOUNT REINFORCEMENTS, AND/OR EQUIPMENT INSTALLATIONS SHALL NOT COMPROMISE THE INTEGRITY OR FUNCTIONAL USE OF THE SAFETY CLIMB OR ANY COMPONENTS OF THE CLIMBING FACILITY ON THE STRUCTURE. THIS SHALL INCLUDE, BUT NOT BE LIMITED TO: PINCHING OF THE WIRE ROPE, BENDING OF THE WIRE ROPE FROM ITS SUPPORTS, DIRECT CONTACT OR CLOSE PROXIMITY TO THE WIRE ROPE WHICH MAY CAUSE FRICTIONAL WEAR, IMPACT TO THE ANCHORAGE POINTS IN ANY WAY, OR TO IMPEDE/BLOCK ITS INTENDED USE, ANY COMPROMISED SAFETY CLIMB, INCLUDING EXISTING CONDITIONS MUST BE TAGGED OUT AND REPORTED TO YOUR CROWN CASTLE USA INC. POC OR CALL THE NOC TO GENERATE A SAFETY CLIMB MAINTENANCE AND CONTRACTOR NOTICE TICKET.
- PRIOR TO THE START OF CONSTRUCTION, ALL REQUIRED JURISDICTIONAL PERMITS SHALL BE OBTAINED. THIS INCLUDES, BUT IS NOT LIMITED TO, BUILDING, ELECTRICAL, MECHANICAL, FIRE, FLOOD ZONE, ENVIRONMENTAL, AND ZONING. AFTER ONSITE ACTIVITIES AND CONSTRUCTION ARE COMPLETED, ALL REQUIRED PERMITS SHALL BE SATISFIED AND CLOSED OUT ACCORDING TO LOCAL JURISDICTIONAL REQUIREMENTS.
- ALL CONSTRUCTION MEANS AND METHODS: INCLUDING BUT NOT LIMITED TO, ERECTION PLANS, RIGGING PLANS, CLIMBING PLANS, AND RESCUE PLANS SHALL BE THE RESPONSIBILITY OF THE GENERAL CONTRACTOR RESPONSIBLE FOR THE EXECUTION OF THE WORK CONTAINED HEREIN, AND SHALL MEET ANSI/ASSE A10.48 (LATEST EDITION); FEDERAL, STATE, AND LOCAL REGULATIONS; AND ANY APPLICABLE INDUSTRY CONSENSUS STANDARDS RELATED TO THE CONSTRUCTION ACTIVITIES BEING PERFORMED. ALL RIGGING PLANS SHALL ADHERE TO ANSI/ASSE A 10.48 (LATEST EDITION) AND CROWN CASTLE USA INC. STANDARD CED-STD-10253, INCLUDING THE REQUIRED INVOLVEMENT OF A QUALIFIED ENGINEER FOR CLASS IV CONSTRUCTION, TO CERTIFY THE SUPPORTING STRUCTURE(S) IN ACCORDANCE WITH ANSI/TIA-322 (LATEST EDITION).
- ALL SITE WORK TO COMPLY WITH QAS-STD-10068 "INSTALLATION STANDARDS FOR CONSTRUCTION ACTIVITIES ON CROWN CASTLE USA INC. TOWER SITE," CED-STD-10294 "STANDARD FOR INSTALLATION OF MOUNTS AND APPURTENANCES," AND LATEST VERSION OF ANSI/TIA-1019-A-2012 "STANDARD FOR INSTALLATION, ALTERATION, AND MAINTENANCE OF ANTENNA SUPPORTING STRUCTURES AND ANTENNAS.
- IF THE SPECIFIED EQUIPMENT CAN NOT BE INSTALLED AS SHOWN ON THESE DRAWINGS, THE CONTRACTOR SHALL PROPOSE AN ALTERNATIVE INSTALLATION FOR APPROVAL BY CROWN CASTLE USA INC. PRIOR TO PROCEEDING WITH ANY SUCH CHANGE OF INSTALLATION.
- ALL MATERIALS FURNISHED AND INSTALLED SHALL BE IN STRICT ACCORDANCE WITH ALL APPLICABLE CODES, REGULATIONS AND ORDINANCES. CONTRACTOR SHALL ISSUE ALL APPROPRIATE NOTICES AND COMPLY WITH ALL LAWS, ORDINANCES, RULES, REGULATIONS AND LAWFUL ORDERS OF ANY PUBLIC AUTHORITY REGARDING THE PERFORMANCE OF THE WORK. ALL WORK CARRIED OUT SHALL COMPLY WITH ALL APPLICABLE MUNICIPAL AND UTILITY COMPANY SPECIFICATIONS AND LOCAL JURISDICTIONAL CODES, ORDINANCES AND APPLICABLE REGULATIONS.
- THE CONTRACTOR SHALL INSTALL ALL EQUIPMENT AND MATERIALS IN ACCORDANCE WITH MANUFACTURER'S RECOMMENDATIONS UNLESS SPECIFICALLY STATED OTHERWISE.
- THE CONTRACTOR SHALL CONTACT UTILITY LOCATING SERVICES PRIOR TO THE START OF CONSTRUCTION.
- ALL EXISTING ACTIVE SEWER, WATER, GAS, ELECTRIC AND OTHER UTILITIES WHERE ENCOUNTERED IN THE WORK, SHALL BE PROTECTED AT ALL TIMES AND WHERE REQUIRED FOR THE PROPER EXECUTION OF THE WORK, SHALL BE RELOCATED AS DIRECTED BY CONTRACTOR. EXTREME CAUTION SHOULD BE USED BY THE CONTRACTOR WHEN EXCAVATING OR DRILLING PIERS AROUND OR NEAR UTILITIES. CONTRACTOR SHALL PROVIDE SAFETY TRAINING FOR THE WORKING CREW. THIS WILL INCLUDE BUT NOT BE LIMITED TO A) FALL PROTECTION B) CONFINED SPACE C) ELECTRICAL SAFETY D) TRENCHING AND EXCAVATION E) CONSTRUCTION SAFETY PROCEDURES.
- 11. ALL SITE WORK SHALL BE AS INDICATED ON THE STAMPED CONSTRUCTION DRAWINGS AND PROJECT SPECIFICATIONS, LATEST APPROVED REVISION
- CONTRACTOR SHALL KEEP THE SITE FREE FROM ACCUMULATING WASTE MATERIAL, DEBRIS, AND TRASH AT THE COMPLETION OF THE WORK. IF NECESSARY, RUBBISH, STUMPS, DEBRIS, STICKS, STONES AND OTHER REFUSE SHALL BE REMOVED FROM THE SITE AND DISPOSED OF LEGALLY
- 13. ALL EXISTING INACTIVE SEWER, WATER, GAS, ELECTRIC AND OTHER UTILITIES, WHICH INTERFERE WITH THE EXECUTION OF THE WORK, SHALL BE REMOVED AND/OR CAPPED, PLUGGED OR OTHERWISE DISCONTINUED AT POINTS WHICH WILL NOT INTERFERE WITH THE EXECUTION OF THE WORK, SUBJECT TO THE APPROVAL OF CONTRACTOR, TOWER OWNER, CROWN CASTLE USA INC., AND/OR LOCAL UTILITIES.
- 14. THE CONTRACTOR SHALL PROVIDE SITE SIGNAGE IN ACCORDANCE WITH THE TECHNICAL SPECIFICATION FOR SITE SIGNAGE REQUIRED BY LOCAL JURISDICTION AND SIGNAGE REQUIRED ON INDIVIDUAL PIECES OF EQUIPMENT, ROOMS, AND SHELTERS.
- 15. THE SITE SHALL BE GRADED TO CAUSE SURFACE WATER TO FLOW AWAY FROM THE CARRIER'S EQUIPMENT AND TOWER AREAS. 16. THE SUB GRADE SHALL BE COMPACTED AND BROUGHT TO A SMOOTH UNIFORM GRADE PRIOR TO FINISHED SURFACE APPLICATION.
- 17. THE AREAS OF THE OWNERS PROPERTY DISTURBED BY THE WORK AND NOT COVERED BY THE TOWER, EQUIPMENT OR DRIVEWAY, SHALL BE GRADED TO A UNIFORM SLOPE, AND STABILIZED TO PREVENT EROSION AS SPECIFIED ON THE
- CONSTRUCTION DRAWINGS AND/OR PROJECT SPECIFICATIONS. CONTRACTOR SHALL MINIMIZE DISTURBANCE TO EXISTING SITE DURING CONSTRUCTION. EROSION CONTROL MEASURES, IF REQUIRED DURING CONSTRUCTION, SHALL BE IN CONFORMANCE WITH THE LOCAL GUIDELINES FOR EROSION AND SEDIMENT
- 19. THE CONTRACTOR SHALL PROTECT EXISTING IMPROVEMENTS, PAVEMENTS, CURBS, LANDSCAPING AND STRUCTURES. ANY
- DAMAGED PART SHALL BE REPAIRED AT CONTRACTOR'S EXPENSE TO THE SATISFACTION OF OWNER. 20. CONTRACTOR SHALL LEGALLY AND PROPERLY DISPOSE OF ALL SCRAP MATERIALS SUCH AS COAXIAL CABLES AND OTHER ITEMS REMOVED FROM THE EXISTING FACILITY. ANTENNAS REMOVED SHALL BE RETURNED TO THE OWNER'S DESIGNATED
- CONTRACTOR SHALL LEAVE PREMISES IN CLEAN CONDITION. TRASH AND DEBRIS SHOULD BE REMOVED FROM SITE ON A DAILY
- 22. NO FILL OR EMBANKMENT MATERIAL SHALL BE PLACED ON FROZEN GROUND, FROZEN MATERIALS, SNOW OR ICE SHALL NOT BE PLACED IN ANY FILL OR EMBANKMENT.

GENERAL NOTES:

- FOR THE PURPOSE OF CONSTRUCTION DRAWING, THE FOLLOWING DEFINITIONS SHALL APPLY: CONTRACTOR: GENERAL CONTRACTOR RESPONSIBLE FOR CONSTRUCTION
 - CARRIER: T-MORII F
- TOWER OWNER: CROWN CASTLE USA INC.

SHALL BE BROUGHT TO THE ATTENTION OF CROWN CASTLE.

- THESE DRAWINGS HAVE BEEN PREPARED USING STANDARDS OF PROFESSIONAL CARE AND COMPLETENESS NORMALLY EXERCISED UNDER SIMILAR CIRCUMSTANCES BY REPUTABLE ENGINEERS IN THIS OR SIMILAR LOCALITIES. IT IS ASSUMED THAT THE WORK DEPICTED WILL BE PERFORMED BY AN EXPERIENCED CONTRACTOR AND/OR WORKPEOPLE WHO HAVE A WORKING KNOWLEDGE OF THE APPLICABLE CODE STANDARDS AND REQUIREMENTS AND OF INDUSTRY ACCEPTED STANDARD GOOD PRACTICE. AS NOT EVERY CONDITION OR ELEMENT IS (OR CAN BE) EXPLICITLY SHOWN ON THESE DRAWINGS, THE CONTRACTOR SHALL USE INDUSTRY ACCEPTED STANDARD GOOD PRACTICE FOR MISCELLANEOUS WORK NOT EXPLICITLY SHOWN.
- THESE DRAWINGS REPRESENT THE FINISHED STRUCTURE. THEY DO NOT INDICATE THE MEANS OR METHODS OF CONSTRUCTION. THE CONTRACTOR SHALL BE SOLELY RESPONSIBLE FOR THE CONSTRUCTION MEANS, METHODS, TECHNIQUES, SEQUENCES, AND PROCEDURES THE CONTRACTOR SHALL PROVIDE ALL MEASURES NECESSARY FOR PROTECTION OF LIFE AND PROPERTY DURING CONSTRUCTION. SUCH MEASURES SHALL INCLUDE, BUT NOT BE LIMITED TO, BRACING, FORMWORK, SHORING, ETC. SITE VISITS BY THE ENGINEER OR HIS REPRESENTATIVE WILL NOT INCLUDE INSPECTION OF THESE ITEMS AND IS FOR STRUCTURAL OBSERVATION OF THE FINISHED STRUCTURE ONLY.
- NOTES AND DETAILS IN THE CONSTRUCTION DRAWINGS SHALL TAKE PRECEDENCE OVER GENERAL NOTES AND TYPICAL DETAILS. WHERE NO DETAILS ARE SHOWN, CONSTRUCTION SHALL CONFORM TO SIMILAR WORK ON THE PROJECT, AND/OR AS PROVIDED FOR IN THE CONTRACT DOCUMENTS. WHERE DISCREPANCIES OCCUR BETWEEN PLANS, DETAILS, GENERAL NOTES, AND SPECIFICATIONS, THE GREATER, MORE STRICT REQUIREMENTS, SHALL GOVERN, IF FURTHER CLARIFICATION IS REQUIRED CONTACT THE ENGINEER OF RECORD.
- SUBSTANTIAL EFFORT HAS BEEN MADE TO PROVIDE ACCURATE DIMENSIONS AND MEASUREMENTS ON THE DRAWINGS TO ASSIST IN THE FABRICATION AND/OR PLACEMENT OF CONSTRUCTION ELEMENTS BUT IT IS THE SOLE RESPONSIBILITY OF THE CONTRACTOR TO FIELD VERIFY THE DIMENSIONS, MEASUREMENTS, AND/OR CLEARANCES SHOWN IN THE CONSTRUCTION DRAWINGS PRIOR TO FABRICATION OR CUTTING OF ANY NEW OR EXISTING CONSTRUCTION ELEMENTS. IF IT IS DETERMINED THAT THERE ARE DISCREPANCIES AND/OR CONFLICTS WITH THE
- CONSTRUCTION DRAWINGS THE ENGINEER OF RECORD IS TO BE NOTIFIED AS SOON AS POSSIBLE. PRIOR TO THE SUBMISSION OF BIDS, THE BIDDING CONTRACTOR SHALL VISIT THE CELL SITE TO FAMILIARIZE WITH THE EXISTING CONDITIONS AND TO CONFIRM THAT THE WORK CAN BE ACCOMPLISHED AS SHOWN ON THE CONSTRUCTION DRAWINGS. ANY DISCREPANCY FOUND
- ALL MATERIALS FURNISHED AND INSTALLED SHALL BE IN STRICT ACCORDANCE WITH ALL APPLICABLE CODES, REGULATIONS AND ORDINANCES, CONTRACTOR SHALL ISSUE ALL APPROPRIATE NOTICES AND COMPLY WITH ALL LAWS, ORDINANCES, RULES, REGULATIONS AND LAWFUL ORDERS OF ANY PUBLIC AUTHORITY REGARDING THE PERFORMANCE OF THE WORK, ALL WORK CARRIED OUT SHALL COMPLY WITH ALL APPLICABLE MUNICIPAL AND UTILITY COMPANY SPECIFICATIONS AND LOCAL JURISDICTIONAL CODES, ORDINANCES AND APPLICABLE REGULATIONS
- UNLESS NOTED OTHERWISE, THE WORK SHALL INCLUDE FURNISHING MATERIALS, EQUIPMENT, APPURTENANCES AND LABOR NECESSARY TO COMPLETE ALL INSTALLATIONS AS INDICATED ON THE DRAWINGS.
- THE CONTRACTOR SHALL INSTALL ALL EQUIPMENT AND MATERIALS IN ACCORDANCE WITH MANUFACTURER'S RECOMMENDATIONS UNLESS SPECIFICALLY STATED OTHERWISE.
- 10. IF THE SPECIFIED EQUIPMENT CAN NOT BE INSTALLED AS SHOWN ON THESE DRAWINGS, THE CONTRACTOR SHALL PROPOSE AN ALTERNATIVE INSTALLATION FOR APPROVAL BY THE CARRIER AND CROWN CASTLE PRIOR TO PROCEEDING WITH ANY SUCH CHANGE OF INSTALLATION.
- CONTRACTOR IS TO PERFORM A SITE INVESTIGATION AND IS TO DETERMINE THE BEST ROUTING OF ALL CONDUITS FOR POWER, AND TELCO AND FOR GROUNDING CABLES AS SHOWN IN THE POWER, TELCO, AND GROUNDING PLAN DRAWINGS.
- 12. THE CONTRACTOR SHALL PROTECT EXISTING IMPROVEMENTS, PAVEMENTS, CURBS, LANDSCAPING AND STRUCTURES. ANY DAMAGED PART SHALL BE REPAIRED AT CONTRACTOR'S EXPENSE TO THE SATISFACTION OF CROWN CASTLE USA INC.
- 13. CONTRACTOR SHALL LEGALLY AND PROPERLY DISPOSE OF ALL SCRAP MATERIALS SUCH AS COAXIAL CABLES AND OTHER ITEMS REMOVED FROM THE EXISTING FACILITY. ANTENNAS REMOVED SHALL BE RETURNED TO THE OWNER'S DESIGNATED LOCATION.
- 14. CONTRACTOR SHALL LEAVE PREMISES IN CLEAN CONDITION. TRASH AND DEBRIS SHOULD BE REMOVED FROM SITE ON A DAILY BASIS.

CONCRETE, FOUNDATIONS, AND REINFORCING STEEL:

- ALL CONCRETE WORK SHALL BE IN ACCORDANCE WITH THE ACI 301, ACI 318, ACI 336, ASTM A184, ASTM A185 AND THE DESIGN AND CONSTRUCTION SPECIFICATION FOR CAST-IN-PLACE CONCRETE.
- UNLESS NOTED OTHERWISE, SOIL BEARING PRESSURE USED FOR DESIGN OF SLABS AND FOUNDATIONS IS ASSUMED TO BE 1000 psf. ALL CONCRETE SHALL HAVE A MINIMUM COMPRESSIVE STRENGTH (f'c) OF 3000 psi AT 28 DAYS, UNLESS NOTED OTHERWISE. NO MORE THAN 90 MINUTES SHALL ELAPSE FROM BATCH TIME TO TIME OF PLACEMENT UNLESS APPROVED BY THE ENGINEER OF RECORD. TEMPERATURE OF
- CONCRETE SHALL NOT EXCEED 90°f AT TIME OF PLACEMENT. CONCRETE EXPOSED TO FREEZE-THAW CYCLES SHALL CONTAIN AIR ENTRAINING ADMIXTURES. AMOUNT OF AIR ENTRAINMENT TO BE BASED ON SIZE OF AGGREGATE AND F3 CLASS EXPOSURE (VERY SEVERE). CEMENT USED TO BE TYPE II PORTLAND CEMENT WITH A MAXIMUM WATER-TO-CEMENT RATIO (W/C) OF 0.45.
- ALL STEEL REINFORCING SHALL CONFORM TO ASTM A615. ALL WELDED WIRE FABRIC (WWF) SHALL CONFORM TO ASTM A185. ALL SPLICES SHALL BE CLASS "B" TENSION SPLICES, UNLESS NOTED OTHERWISE, ALL HOOKS SHALL BE STANDARD 90 DEGREE HOOKS, UNLESS NOTED OTHERWISE. YIELD STRENGTH (Fy) OF STANDARD DEFORMED BARS ARE AS FOLLOWS:

1-1/2"

- #4 BARS AND SMALLER #5 BARS AND LARGER. THE FOLLOWING MINIMUM CONCRETE COVER SHALL BE PROVIDED FOR REINFORCING STEEL UNLESS SHOWN OTHERWISE ON DRAWINGS: CONCRETE CAST AGAINST AND PERMANENTLY EXPOSED TO EARTH....
 - #6 BARS AND LARGER..... #5 BARS AND SMALLER...

CONCRETE EXPOSED TO EARTH OR WEATHER:

- CONCRETE NOT EXPOSED TO EARTH OR WEATHER: SLAB AND WALLS.... 3/4" 1-1/2" BEAMS AND COLUMNS..
- A TOOLED EDGE OR A 3/4" CHAMFER SHALL BE PROVIDED AT ALL EXPOSED EDGES OF CONCRETE, UNLESS NOTED OTHERWISE, IN ACCORDANCE WITH ACI 301 SECTION 4.2.4.

GREENFIELD GROUNDING NOTES:

LOCATION.

- ALL GROUND ELECTRODE SYSTEMS (INCLUDING TELECOMMUNICATION, RADIO, LIGHTNING PROTECTION AND AC POWER GES'S) SHALL BE BONDED TOGETHER AT OR BELOW GRADE, BY TWO OR MORE COPPER BONDING CONDUCTORS IN ACCORDANCE WITH THE NEC. THE CONTRACTOR SHALL PERFORM IEEE FALL-OF-POTENTAL RESISTANCE TO EARTH TESTING (PER IEEE 1100 AND 81) FOR GROUND ELECTRODE SYSTEMS, THE CONTRACTOR SHALL FURNISH AND INSTALL SUPPLEMENTAL GROUND ELECTRODES AS NEEDED TO ACHIEVE A TEST RESULT
- THE CONTRACTOR IS RESPONSIBLE FOR PROPERLY SEQUENCING GROUNDING AND UNDERGROUND CONDUIT INSTALLATION AS TO PREVENT ANY LOSS OF CONTINUITY IN THE GROUNDING SYSTEM OR DAMAGE TO THE CONDUIT AND PROVIDE TESTING RESULTS.
- METAL CONDUIT AND TRAY SHALL BE GROUNDED AND MADE ELECTRICALLY CONTINUOUS WITH LISTED BONDING FITTINGS OR BY BONDING ACROSS THE DISCONTINUITY WITH #6 COPPER WIRE UL APPROVED GROUNDING TYPE CONDUIT CLAMPS. METAL RACEWAY SHALL NOT BE USED AS THE NEC REQUIRED EQUIPMENT GROUND CONDUCTOR. STRANDED COPPER CONDUCTORS WITH GREEN INSULATION, SIZED IN ACCORDANCE WITH THE NEC, SHALL BE FURNISHED AND INSTALLED WITH THE POWER CIRCUITS TO BTS
- EACH CABINET FRAME SHALL BE DIRECTLY CONNECTED TO THE MASTER GROUND BAR WITH GREEN INSULATED SUPPLEMENTAL EQUIPMENT GROUND WIRES, #6 STRANDED COPPER OR LARGER FOR INDOOR BTS; #2 BARE SOLID TINNED COPPER FOR OUTDOOR BTS. CONNECTIONS TO THE GROUND BUS SHALL NOT BE DOUBLED UP OR STACKED BACK TO BACK CONNECTIONS ON OPPOSITE SIDE OF THE GROUND BUS ARE PERMITTED.
- ALL EXTERIOR GROUND CONDUCTORS BETWEEN EQUIPMENT/GROUND BARS AND THE GROUND RING SHALL BE #2 SOLID TINNED COPPER UNLESS OTHERWISE INDICATED. ALUMINUM CONDUCTOR OR COPPER CLAD STEEL CONDUCTOR SHALL NOT BE USED FOR GROUNDING CONNECTIONS.
- USE OF 90° BENDS IN THE PROTECTION GROUNDING CONDUCTORS SHALL BE AVOIDED WHEN 45° BENDS CAN BE ADEQUATELY SUPPORTED.
- EXOTHERMIC WELDS SHALL BE USED FOR ALL GROUNDING CONNECTIONS BELOW GRADE. ALL GROUND CONNECTIONS ABOVE GRADE (INTERIOR AND EXTERIOR) SHALL BE FORMED USING HIGH PRESS CRIMPS.
- COMPRESSION GROUND CONNECTIONS MAY BE REPLACED BY EXOTHERMIC WELD CONNECTIONS.
- ICE BRIDGE BONDING CONDUCTORS SHALL BE EXOTHERMICALLY BONDED OR BOLTED TO THE BRIDGE AND THE TOWER GROUND BAR. APPROVED ANTIOXIDANT COATINGS (i.e. CONDUCTIVE GEL OR PASTE) SHALL BE USED ON ALL COMPRESSION AND BOLTED GROUND CONNECTIONS.
- ALL EXTERIOR GROUND CONNECTIONS SHALL BE COATED WITH A CORROSION RESISTANT MATERIAL.
- MISCELLANEOUS ELECTRICAL AND NON-ELECTRICAL METAL BOXES, FRAMES AND SUPPORTS SHALL BE BONDED TO THE GROUND RING, IN ACCORDANCE WITH THE NEC.

CONDUIT PROHIBITED BY LOCAL CODE) THE GROUND CONDUCTOR SHALL BE BONDED TO EACH END OF THE METAL CONDUIT.

- BOND ALL METALLIC OBJECTS WITHIN 6 ft OF MAIN GROUND RING WITH (1) #2 BARE SOLID TINNED COPPER GROUND CONDUCTOR. GROUND CONDUCTORS USED FOR THE FACILITY GROUNDING AND LIGHTNING PROTECTION SYSTEMS SHALL NOT BE ROUTED THROUGH METALLIC OBJECTS THAT FORM A RING AROUND THE CONDUCTOR, SUCH AS METALLIC CONDUITS, METAL SUPPORT CLIPS OR SLEEVES THROUGH WALLS OR FLOORS. WHEN IT IS REQUIRED TO BE HOUSED IN CONDUIT TO MEET CODE REQUIREMENTS OR LOCAL CONDITIONS, NON-METALLIC MATERIAL SUCH AS PVC CONDUIT SHALL BE USED. WHERE USE OF METAL CONDUIT IS UNAVOIDABLE (i.e., NONMETALLIC
- 20. ALL GROUNDS THAT TRANSITION FROM BELOW GRADE TO ABOVE GRADE MUST BE #2 BARE SOLID TINNED COPPER IN 3/4" NON-METALLIC, FLEXIBLE CONDUIT FROM 24" BELOW GRADE TO WITHIN 3" TO 6" OF CAD-WELD TERMINATION POINT. THE EXPOSED END OF THE CONDUIT MUST BE SEALED WITH SILICONE CAULK. (ADD TRANSITIONING GROUND STANDARD DETAIL AS WELL).
- 21. BUILDINGS WHERE THE MAIN GROUNDING CONDUCTORS ARE REQUIRED TO BE ROUTED TO GRADE, THE CONTRACTOR SHALL ROUTE TWO GROUNDING CONDUCTORS FROM THE ROOFTOP, TOWERS, AND WATER TOWERS GROUNDING RING, TO THE EXISTING GROUNDING SYSTEM, THE GROUNDING CONDUCTORS SHALL NOT BE SMALLER THAN 2/0 COPPER. ROOFTOP GROUNDING RING SHALL BE BONDED TO THE EXISTING GROUNDING SYSTEM, THE BUILDING STEEL COLUMNS, LIGHTNING PROTECTION SYSTEM, AND BUILDING MAIN WATER LINE (FERROUS OR NONFERROUS METAL PIPING ONLY).

ELECTRICAL INSTALLATION NOTES:

- ALL ELECTRICAL WORK SHALL BE PERFORMED IN ACCORDANCE WITH THE PROJECT SPECIFICATIONS, NEC AND ALL APPLICABLE FEDERAL, STATE, AND
- LOCAL CODES/ORDINANCES. CONDUIT ROUTINGS ARE SCHEMATIC. CONTRACTOR SHALL INSTALL CONDUITS SO THAT ACCESS TO EQUIPMENT IS NOT BLOCKED AND TRIP HAZARDS
- ARF FLIMINATED
- WIRING, RACEWAY AND SUPPORT METHODS AND MATERIALS SHALL COMPLY WITH THE REQUIREMENTS OF THE NEC. ALL CIRCUITS SHALL BE SEGREGATED AND MAINTAIN MINIMUM CABLE SEPARATION AS REQUIRED BY THE NEC.
- ALL EQUIPMENT SHALL BEAR THE UNDERWRITERS LABORATORIES LABEL OF APPROVAL, AND SHALL CONFORM TO REQUIREMENT OF THE NATIONAL ELECTRICAL CODE.
- ALL OVERCURRENT DEVICES SHALL HAVE AN INTERRUPTING CURRENT RATING THAT SHALL BE GREATER THAN THE SHORT CIRCUIT CURRENT TO WHICH THEY ARE SUBJECTED, 22,000 AIC MINIMUM. VERYIFY AVAILABLE SHORT CIRCUIT CURRENT DOES NOT EXCEED THE RATING OF ELECTRICAL
- EQUIPMENT IN ACCORDANCE WITH ARTICLE 110.24 NEC OR THE MOST CURRENT ADOPTED CODE PRE THE GOVERNING JURISDICTION. EACH END OF EVERY POWER PHASE CONDUCTOR, GROUNDING CONDUCTOR, AND TELCO CONDUCTOR OR CABLE SHALL BE LABELED WITH
- METHOD SHALL CONFORM WITH NEC AND OSHA. ALL ELECTRICAL COMPONENTS SHALL BE CLEARLY LABELED WITH LAMICOID TAGS SHOWING THEIR RATED VOLTAGE, PHASE CONFIGURATION, WIRE

COLOR-CODED INSULATION OR ELECTRICAL TAPE (3M BRAND, 1/2" PLASTIC ELECTRICAL TAPE WITH UV PROTECTION, OR EQUAL). THE IDENTIFICATION

- CONFIGURATION, POWER OR AMPACITY RATING AND BRANCH CIRCUIT ID NUMBERS (i.e. PANEL BOARD AND CIRCUIT ID'S).
- PANEL BOARDS (ID NUMBERS) SHALL BE CLEARLY LABELED WITH PLASTIC LABELS.
- ALL TIE WRAPS SHALL BE CUT FLUSH WITH APPROVED CUTTING TOOL TO REMOVE SHARP EDGES. ALL POWER AND EQUIPMENT GROUND WIRING IN TUBING OR CONDUIT SHALL BE SINGLE COPPER CONDUCTOR (#14 OR LARGER) WITH TYPE THHW,
- THWN. THWN-2, XHHW, XHHW-2, THW, THW-2, RHW, OR RHW-2 INSULATION UNLESS OTHERWISE SPECIFIED. 10. SUPPLEMENTAL EQUIPMENT GROUND WIRING LOCATED INDOORS SHALL BE SINGLE COPPER CONDUCTOR (#6 OR LARGER) WITH TYPE THHW, THWN,
- THWN-2, XHHW, XHHW-2, THW, THW-2, RHW, OR RHW-2 INSULATION UNLESS OTHERWISE SPECIFIED.
- POWER AND CONTROL WIRING IN FLEXIBLE CORD SHALL BE MULTI-CONDUCTOR, TYPE SOOW CORD (#14 OR LARGER) UNLESS OTHERWISE SPECIFIED. 12. POWER AND CONTROL WIRING FOR USE IN CABLE TRAY SHALL BE MULTI-CONDUCTOR, TYPE TC CABLE (#14 OR LARGER), WITH TYPE THHW, THWN,
- THWN-2, XHHW, XHHW-2, THW, THW-2, RHW, OR RHW-2 INSULATION UNLESS OTHERWISE SPECIFIED. 13. ALL POWER AND GROUNDING CONNECTIONS SHALL BE CRIMP-STYLE, COMPRESSION WIRE LUGS AND WIRE NUTS BY THOMAS AND BETTS (OR EQUAL).
- LUGS AND WIRE NUTS SHALL BE RATED FOR OPERATION NOT LESS THAN 75° C (90° C IF AVAILABLE).
- 14. RACEWAY AND CABLE TRAY SHALL BE LISTED OR LABELED FOR ELECTRICAL USE IN ACCORDANCE WITH NEMA, UL, ANSI/IEEE AND NEC.
- 15. ELECTRICAL METALLIC TUBING (EMT), INTERMEDIATE METAL CONDUIT (IMC), OR RIGID METAL CONDUIT (RMC) SHALL BE USED FOR EXPOSED INDOOR
- LOCATIONS. 16. ELECTRICAL METALLIC TUBING (EMT) OR METAL-CLAD CABLE (MC) SHALL BE USED FOR CONCEALED INDOOR LOCATIONS.
- 17. SCHEDULE 40 PVC UNDERGROUND ON STRAIGHTS AND SCHEDULE 80 PVC FOR ALL ELBOWS/90s AND ALL APPROVED ABOVE GRADE PVC CONDUIT. 18. LIQUID-TIGHT FLEXIBLE METALLIC CONDUIT (LIQUID-TITE FLEX) SHALL BE USED INDOORS AND OUTDOORS, WHERE VIBRATION OCCURS OR FLEXIBILITY IS
- 19. CONDUIT AND TUBING FITTINGS SHALL BE THREADED OR COMPRESSION-TYPE AND APPROVED FOR THE LOCATION USED. SET SCREW FITTINGS ARE NOT
- ACCEPTABLE.
- 20. CABINETS, BOXES AND WIRE WAYS SHALL BE LABELED FOR ELECTRICAL USE IN ACCORDANCE WITH NEMA, UL, ANSI/IEEE AND THE NEC. 21. WIREWAYS SHALL BE METAL WITH AN ENAMEL FINISH AND INCLUDE A HINGED COVER, DESIGNED TO SWING OPEN DOWNWARDS (WIREMOLD
- SPECMATE WIREWAY).
- 22. SLOTTED WIRING DUCT SHALL BE PVC AND INCLUDE COVER (PANDUIT TYPE E OR EQUAL).
- 23. CONDUITS SHALL BE FASTENED SECURELY IN PLACE WITH APPROVED NON-PERFORATED STRAPS AND HANGERS. EXPLOSIVE DEVICES (i.e. POWDER-ACTUATED) FOR ATTACHING HANGERS TO STRUCTURE WILL NOT BE PERMITTED. CLOSELY FOLLOW THE LINES OF THE STRUCTURE, MAINTAIN CLOSE PROXIMITY TO THE STRUCTURE AND KEEP CONDUITS IN TIGHT ENVELOPES. CHANGES IN DIRECTION TO ROUTE AROUND OBSTACLES SHALL BE MADE WITH CONDUIT OUTLET BODIES. CONDUIT SHALL BE INSTALLED IN A NEAT AND WORKMANLIKE MANNER. PARALLEL AND PERPENDICULAR TO STRUCTURE WALL AND CEILING LINES. ALL CONDUIT SHALL BE FISHED TO CLEAR OBSTRUCTIONS, ENDS OF CONDUITS SHALL BE TEMPORARILY CAPPED FLUSH TO FINISH GRADE TO PREVENT CONCRETE, PLASTER OR DIRT FROM ENTERING. CONDUITS SHALL BE RIGIDLY CLAMPED TO BOXES BY GALVANIZED
- MALLEABLE IRON BUSHING ON INSIDE AND GALVANIZED MALLEABLE IRON LOCKNUT ON OUTSIDE AND INSIDE. 24. EQUIPMENT CABINETS, TERMINAL BOXES, JUNCTION BOXES AND PULL BOXES SHALL BE GALVANIZED OR EPOXY-COATED SHEET STEEL. SHALL MEET OR EXCEED UL 50 AND BE RATED NEMA 1 (OR BETTER) FOR INTERIOR LOCATIONS AND NEMA 3R (OR BETTER) FOR EXTERIOR LOCATIONS.
- 25. METAL RECEPTACLE, SWITCH AND DEVICE BOXES SHALL BE GALVANIZED, EPOXY-COATED OR NON-CORRODING; SHALL MEET OR EXCEED UL 514A AND NEMA OS 1 AND BE RATED NEMA 1 (OR BETTER) FOR INTERIOR LOCATIONS AND WEATHER PROTECTED (WP OR BETTER) FOR EXTERIOR LOCATIONS.

NONMETALLIC RECEPTACLE, SWITCH AND DEVICE BOXES SHALL MEET OR EXCEED NEMA OS 2 (NEWEST REVISION) AND BE RATED NEMA 1 (OR BETTER)

APWA UNIFORM COLOR CODE

PROPOSED EXCAVATION

AND LIGHTING CABLES

MATERIALS

POTABLE WATER

SEWERS AND DRAIN LINES

SLURRY LINES

TEMPORARY SURVEY MARKINGS

ELECTRIC POWER LINES, CABLES, CONDUIT,

GAS, OIL, STEAM, PETROLEUM, OR GASEOUS

COMMUNICATION, ALARM OR SIGNAL LINES, CABLES, OR CONDUIT AND TRAFFIC LOOPS

RECLAIMED WATER, IRRIGATION, AND

- FOR INTERIOR LOCATIONS AND WEATHER PROTECTED (WP OR BETTER) FOR EXTERIOR LOCATIONS. THE CONTRACTOR SHALL NOTIFY AND OBTAIN NECESSARY AUTHORIZATION FROM THE CARRIER AND/OR CROWN CASTLE USA INC. BEFORE
- COMMENCING WORK ON THE AC POWER DISTRIBUTION PANELS. THE CONTRACTOR SHALL PROVIDE NECESSARY TAGGING ON THE BREAKERS, CABLES AND DISTRIBUTION PANELS IN ACCORDANCE WITH THE APPLICABLE CODES AND STANDARDS TO SAFEGUARD LIFE AND PROPERTY.
- 29. INSTALL LAMICOID LABEL ON THE METER CENTER TO SHOW "T-MOBILE".
- ALL EMPTY/SPARE CONDUITS THAT ARE INSTALLED ARE TO HAVE A METERED MULE TAPE PULL CORD INSTALLED.

	CONDUCTOR COLOR CODE					
	SYSTEM	CONDUCTOR	COLOR			
		A PHASE	BLACK			
	120/240V, 1Ø	B PHASE	RED			
	120/2401, 19	NEUTRAL	WHITE			
		GROUND	GREEN			
		A PHASE	BLACK			
		B PHASE	RED			
	120/208V, 3Ø	C PHASE	BLUE			
		NEUTRAL	WHITE			
		GROUND	GREEN			
		A PHASE	BROWN			
		B PHASE	ORANGE OR PURPLE			
	277/480V, 3Ø	C PHASE	YELLOW			
		NEUTRAL	GREY			
		GROUND	GREEN			
	DC VOLTAGE	POS (+)	RED**			
	DC VOLIAGE	NEG (-)	BLACK**			
	* SEE NEC 210.5(C)(1) AND (2)					

** POLARITY MARKED AT TERMINATION

ABBREVIATIONS:

ANT	ANTENNA
(E)	EXISTING
FIF	FACILITY INTERFACE FRAME
CENT	CENTED A TOD

- GLOBAL POSITIONING SYSTEM GLOBAL SYSTEM FOR MOBILE
- LONG TERM EVOLUTION
- MGB MASTER GROUND BAR MWMICROWAVE
- NATIONAL ELECTRIC CODE NEC
- PROPOSED POWER PLANT QTY QUANTITY
- RECT RECTIFIER RBS RADIO BASE STATION
- REMOTE ELECTRIC TILT RET RFDS RADIO FREQUENCY DATA SHEET
- RRH REMOTE RADIO HEAD RRU REMOTE RADIO UNIT
- SIAD SMART INTEGRATED DEVICE TMA TOWER MOUNTED AMPLIFIER
- TYP
- UMTS UNIVERSAL MOBILE TELECOMMUNICATIONS SYSTEM W.P. **WORK POINT**

1200 CONCORD AVENUE, SUITE 500 CONCORD, CA 94520





1 PARK PLACE, SUITE 300

P. MARSHALL & ASSOCIATES 6801 PORTWEST DR. STE 100 HOUSTON, TX 77024 OFFICE 713-677-0964

T-MOBILE SITE NUMBER: SF40873A

BU #: 814448

CCI-CUMMINGS

3750 SPYROCK ROAD LAYTONVILLE, CA 95454

> EXISTING 65'-0" MONOPOLE

ISSUED FOR:						
REV	DATE	DRWN	DESCRIPTION	DES./		
Α	02/20/24	MAS	PRELIMINARY	HS		
0	02/23/24	MAS	FINAL CD	HS		



IT IS A VIOLATION OF LAW FOR ANY PERSON. UNLESS THEY ARE ACTING UNDER THE DIRECTION OF A LICENSED PROFESSIONAL ENGINEER, TO ALTER THIS DOCUMENT.

PROJECT NUMBER: 24CCTCAM-012

SHEET NUMBER:

SITE PLAN DISCLAIMER:

PROPERTY LINES AND STRUCTURES HAVE BEEN DIGITIZED FROM PREVIOUS PLAN SETS. CROWN CASTLE USA INC. HAS NOT COMPLETED A SITE SURVEY AND THEREFORE MAKES NO CLAIMS AS TO THE ACCURACY OF INFORMATION DEPICTED ON THIS SHEET.

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1 PARK PLACE, SUITE 300 DUBLIN, CA 94568



P. MARSHALL & ASSOCIATES 6801 PORTWEST DR. STE 100, HOUSTON, TX 77024 OFFICE 713-677-0964

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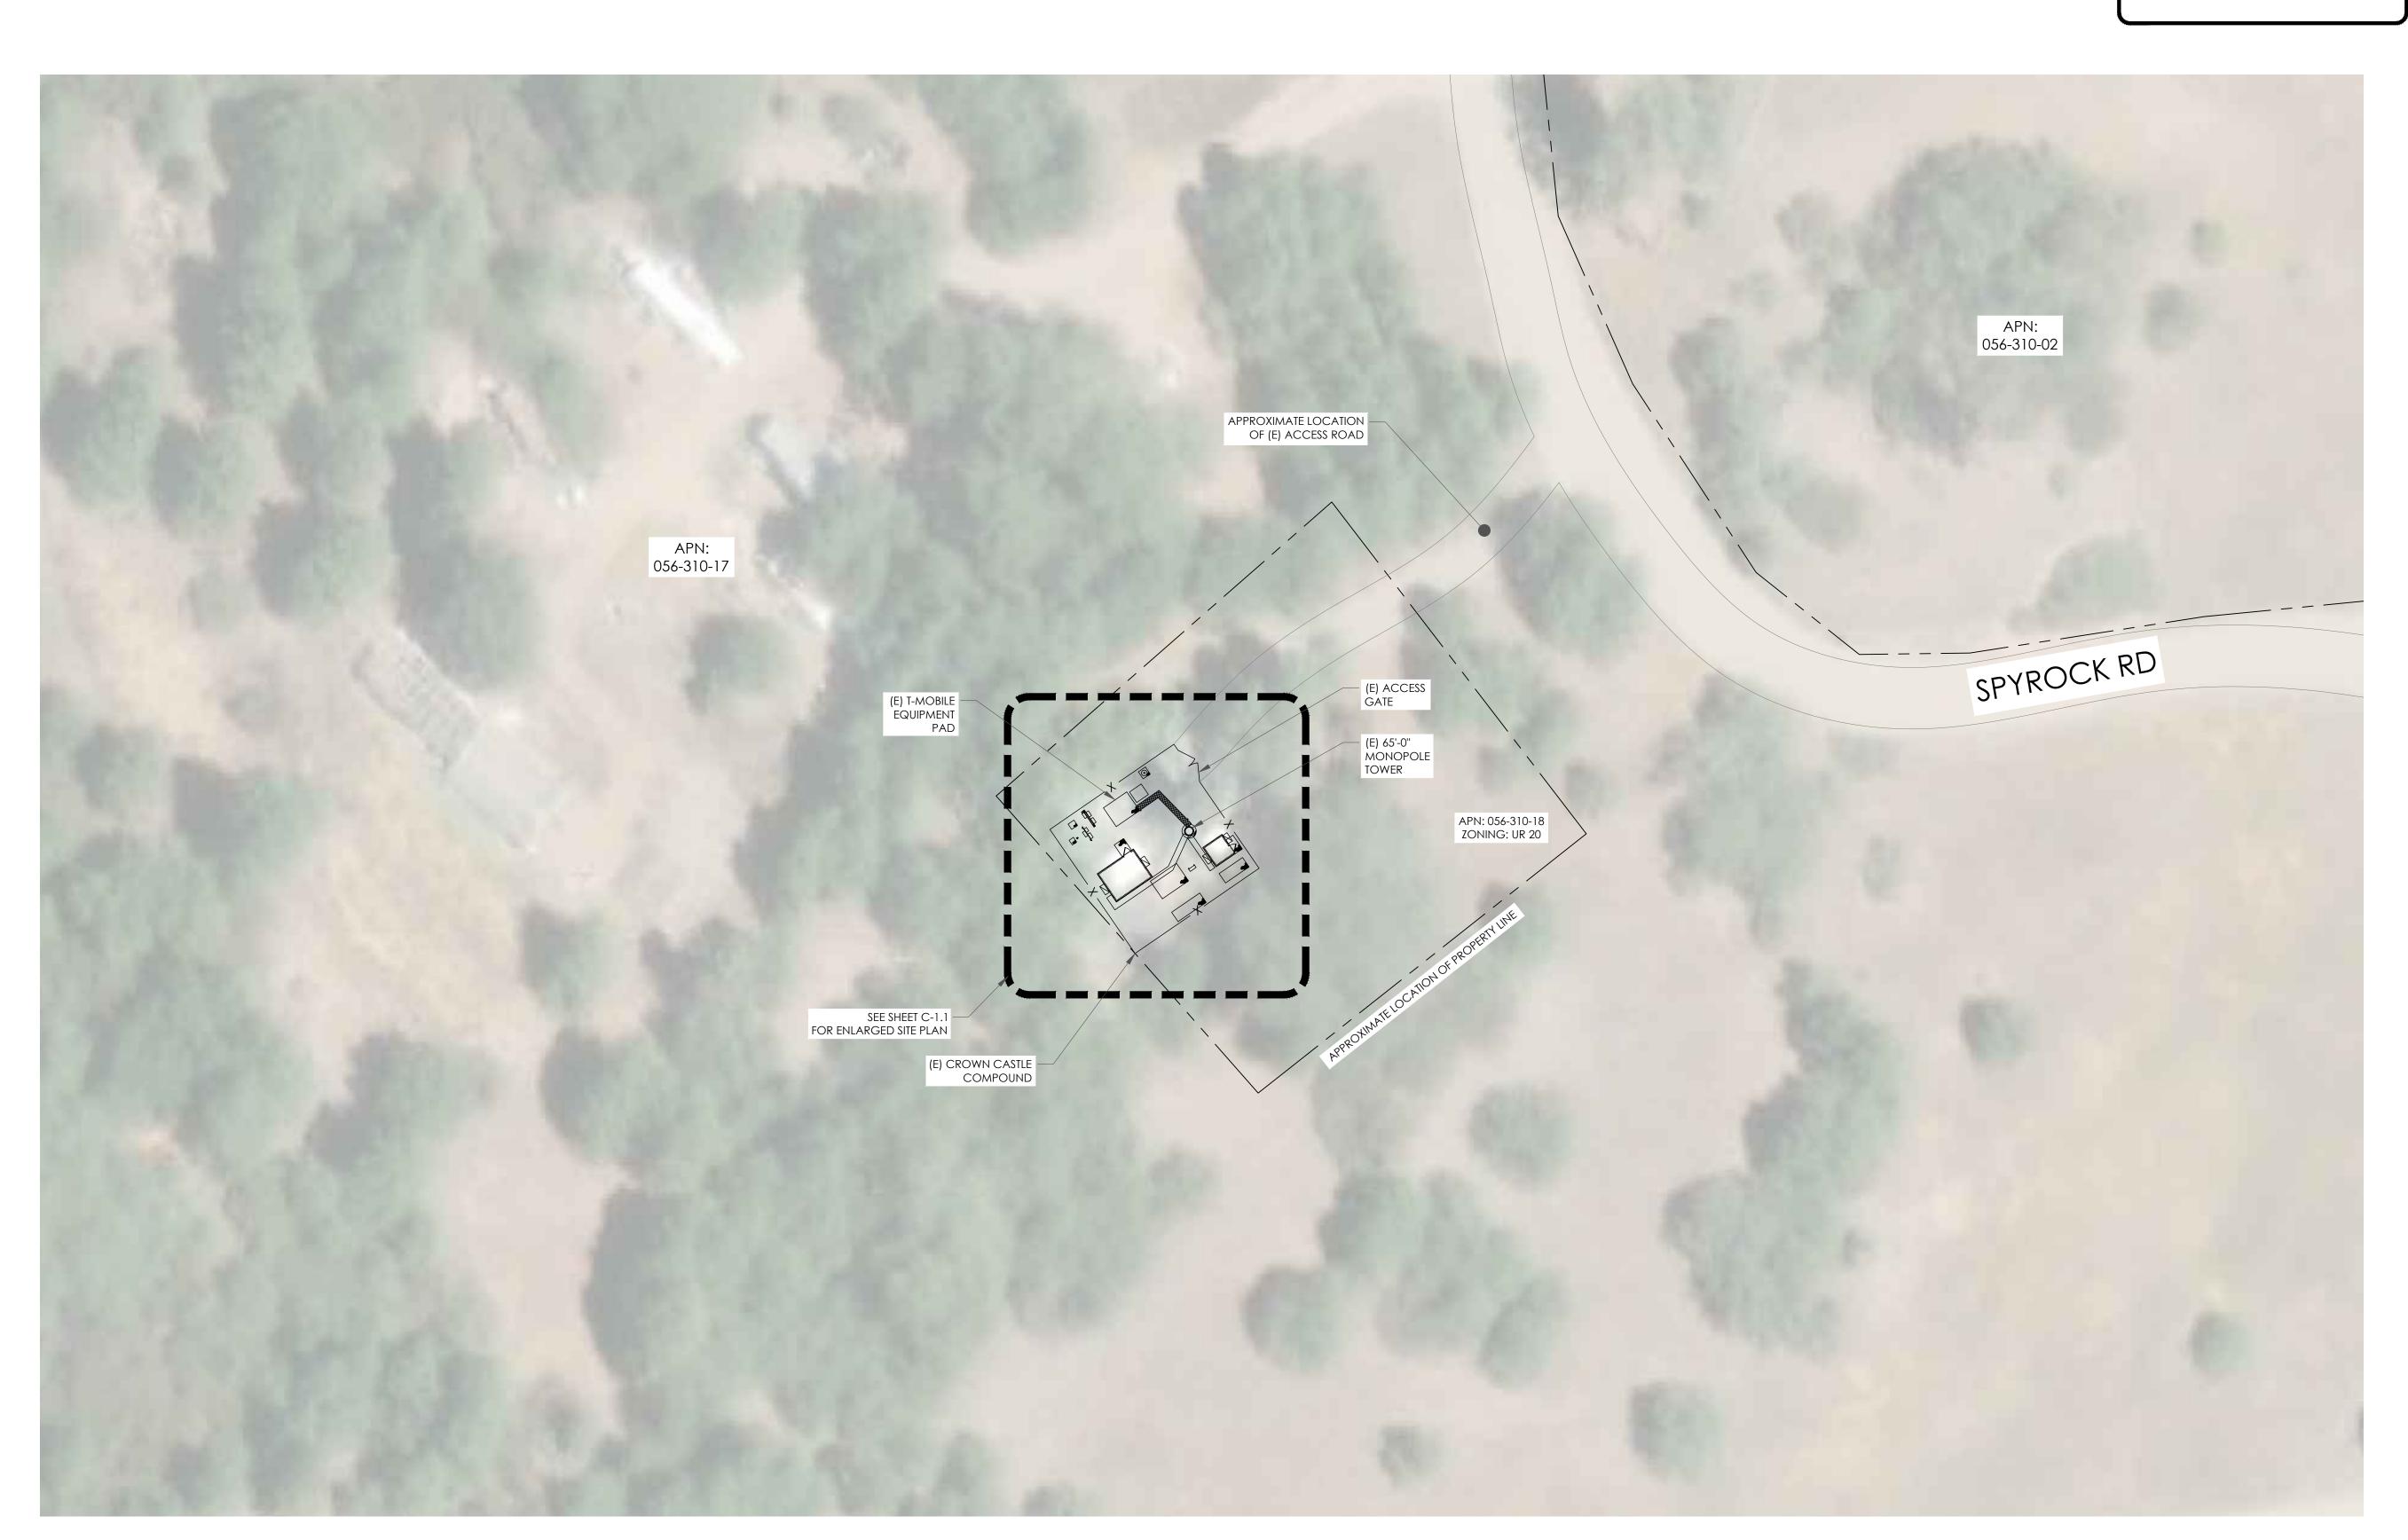


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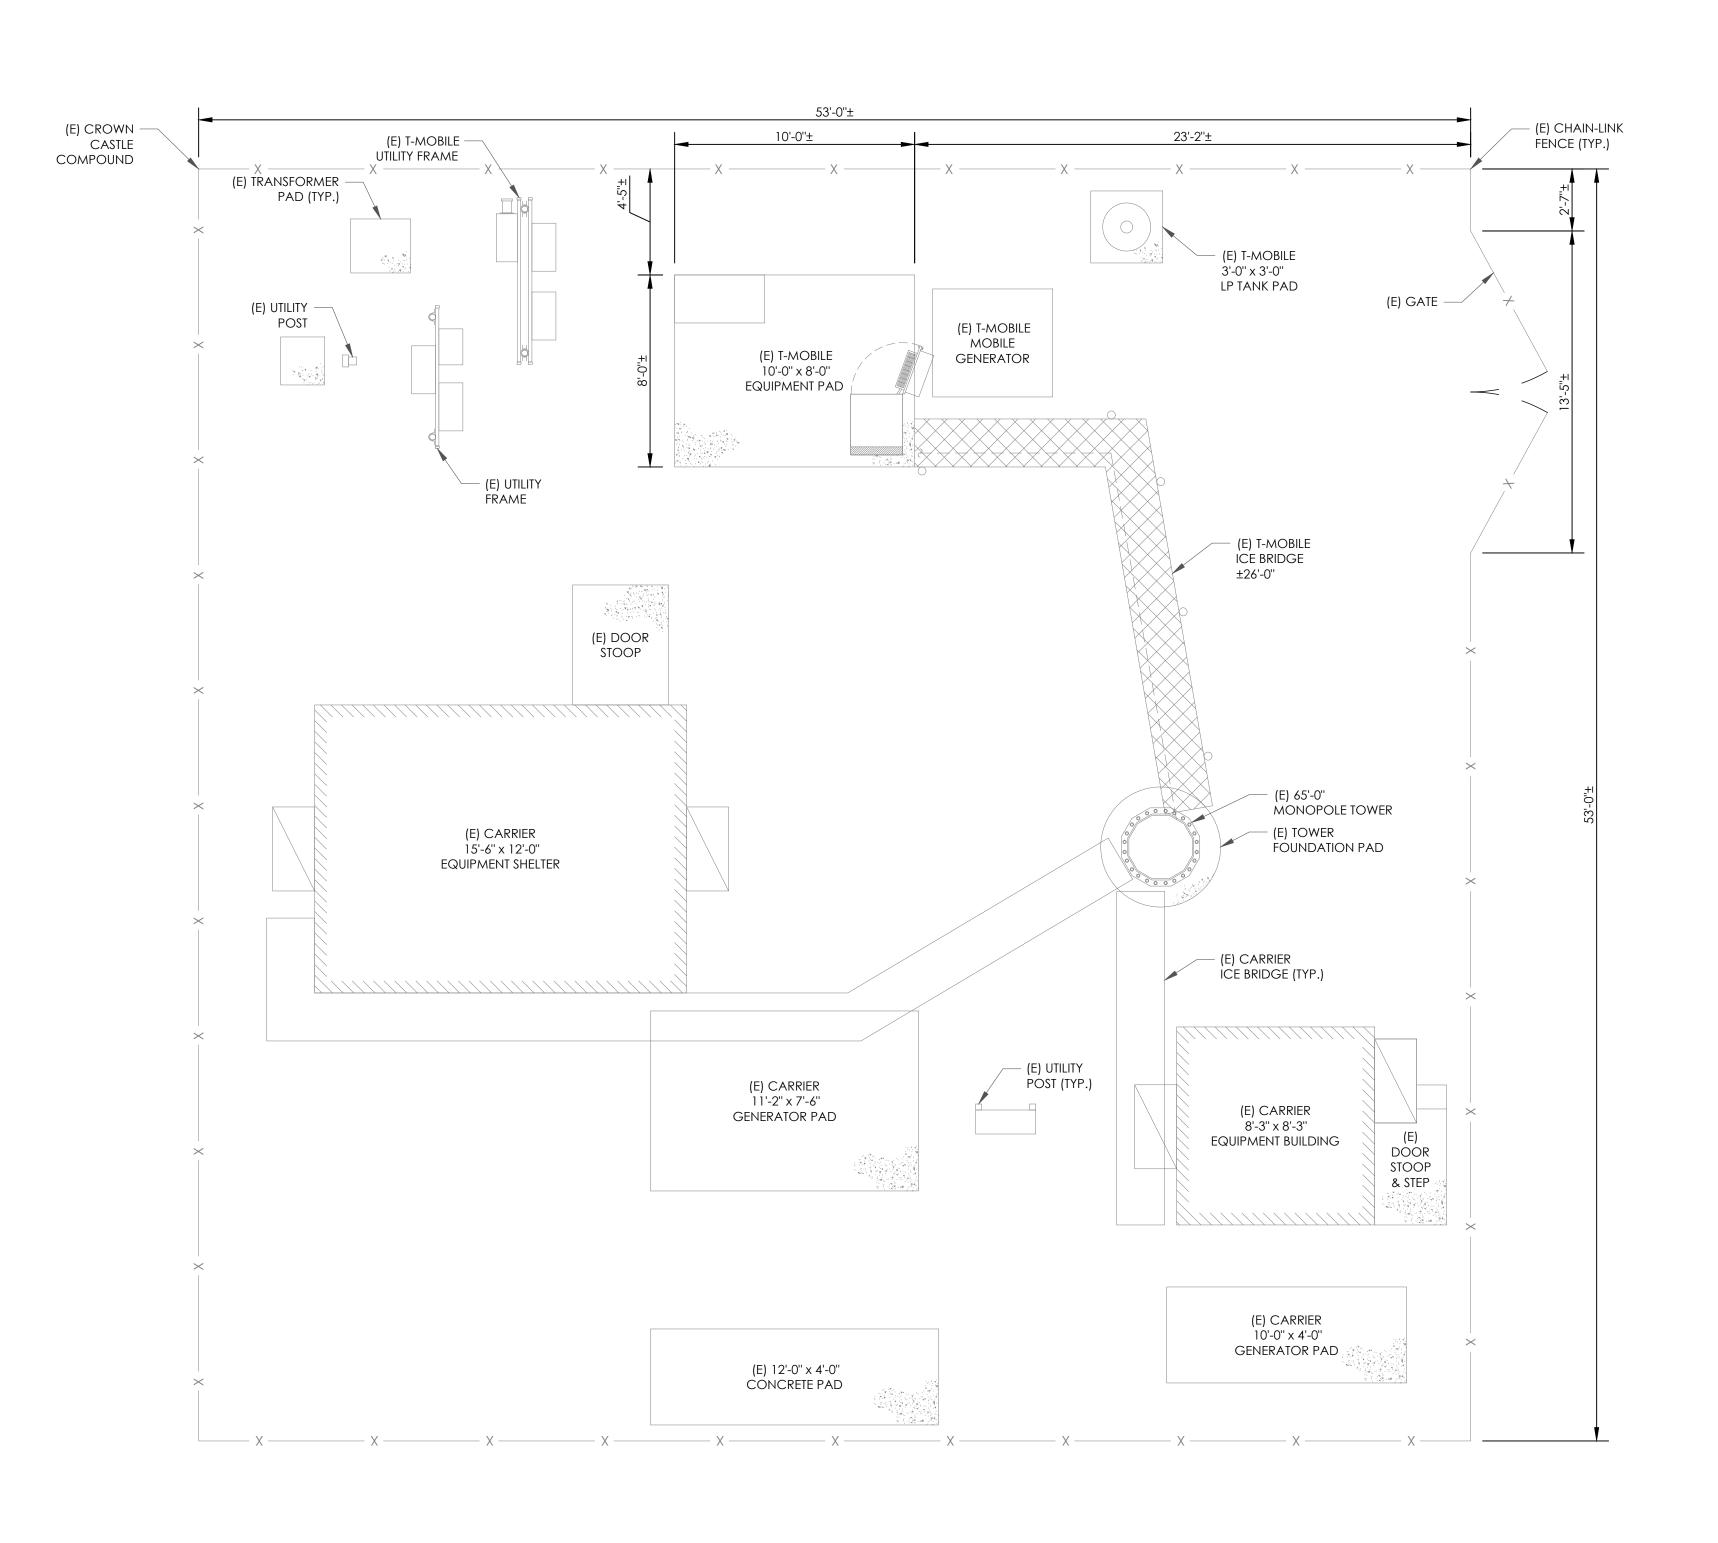
PROJECT NUMBER: 24CCTCAM-012

SHEET NUMBER:

C-1









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1 PARK PLACE, SUITE 300 DUBLIN, CA 94568



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3750 SPYROCK ROAD LAYTONVILLE, CA 95454

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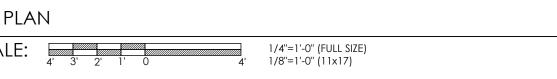


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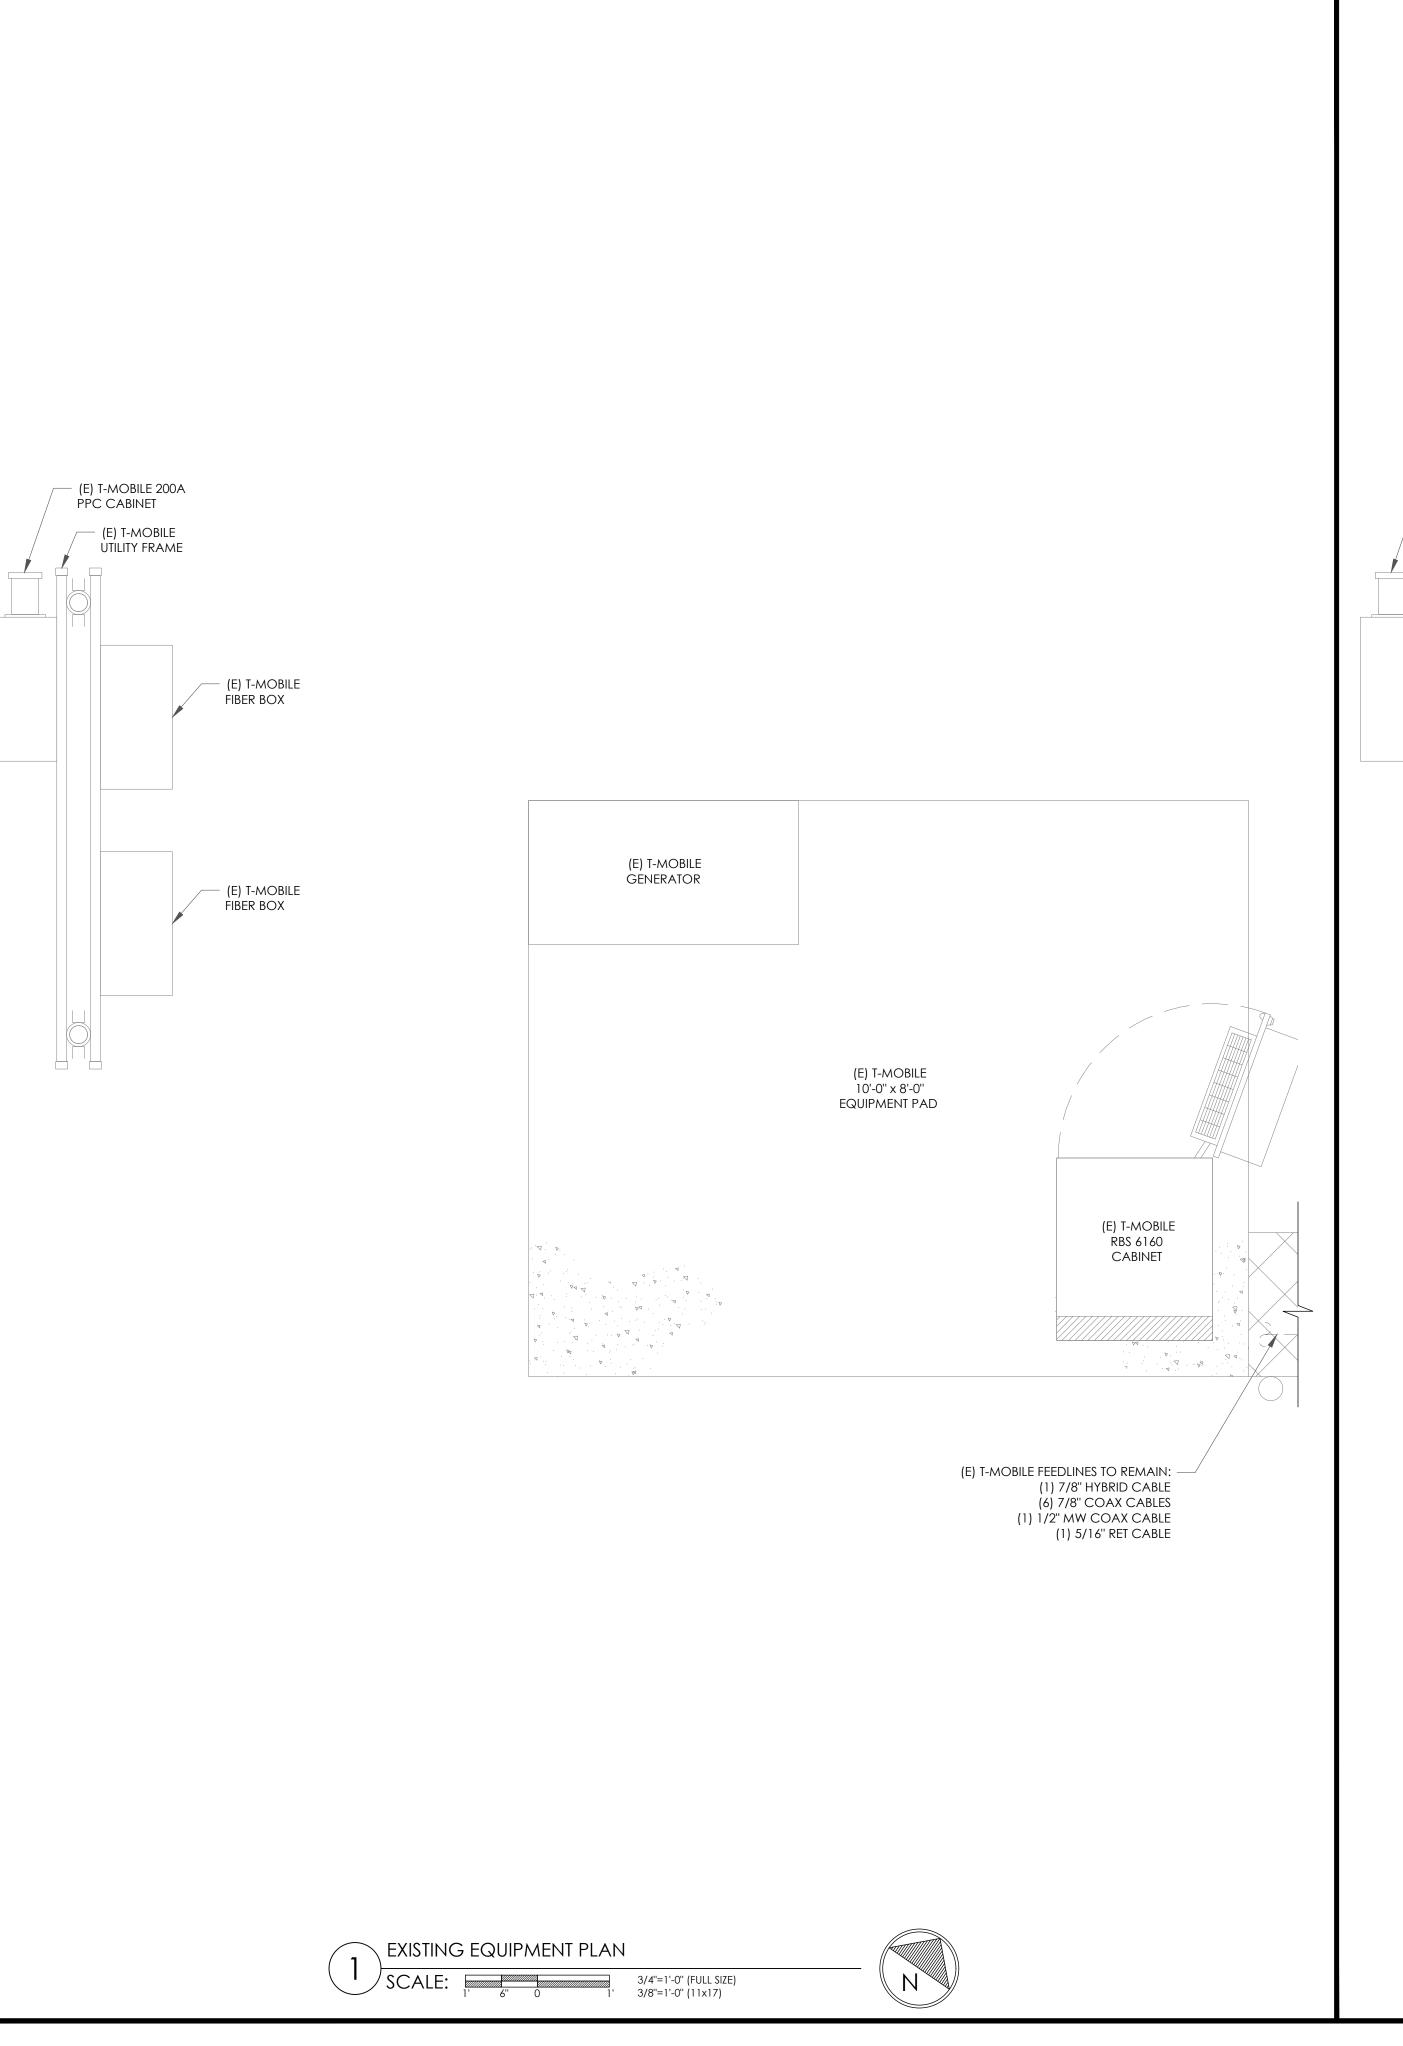
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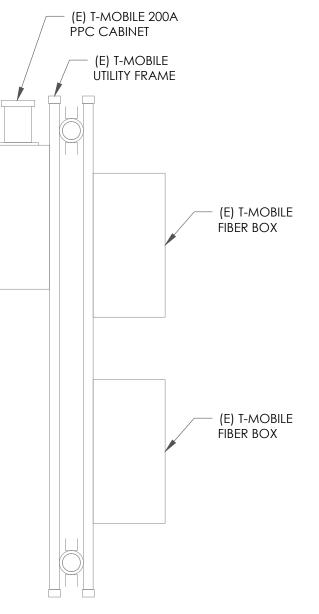
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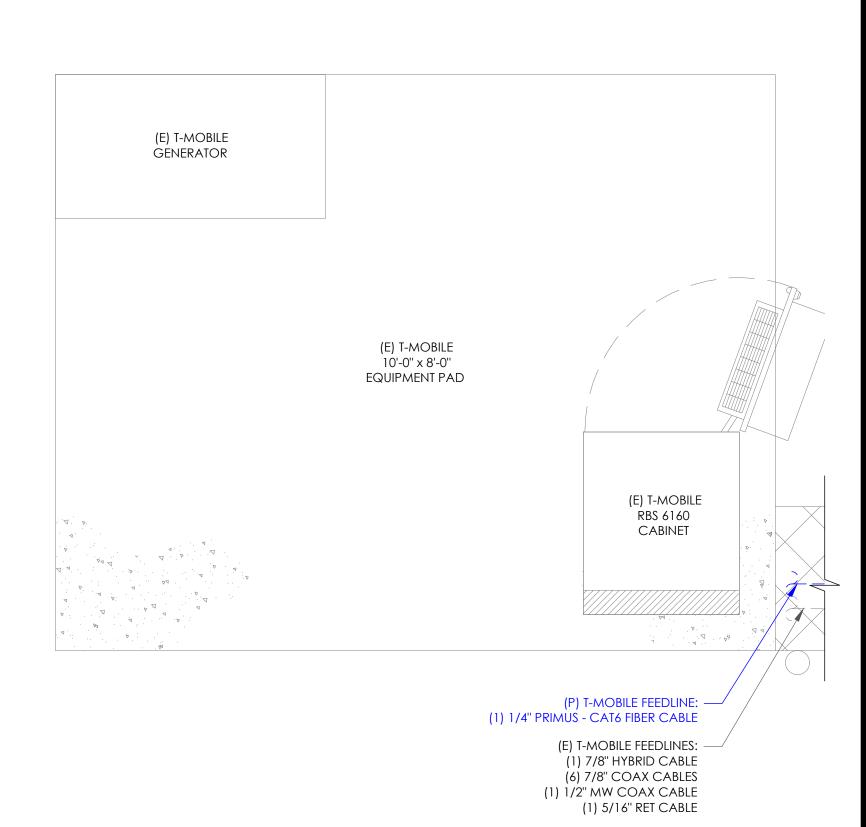
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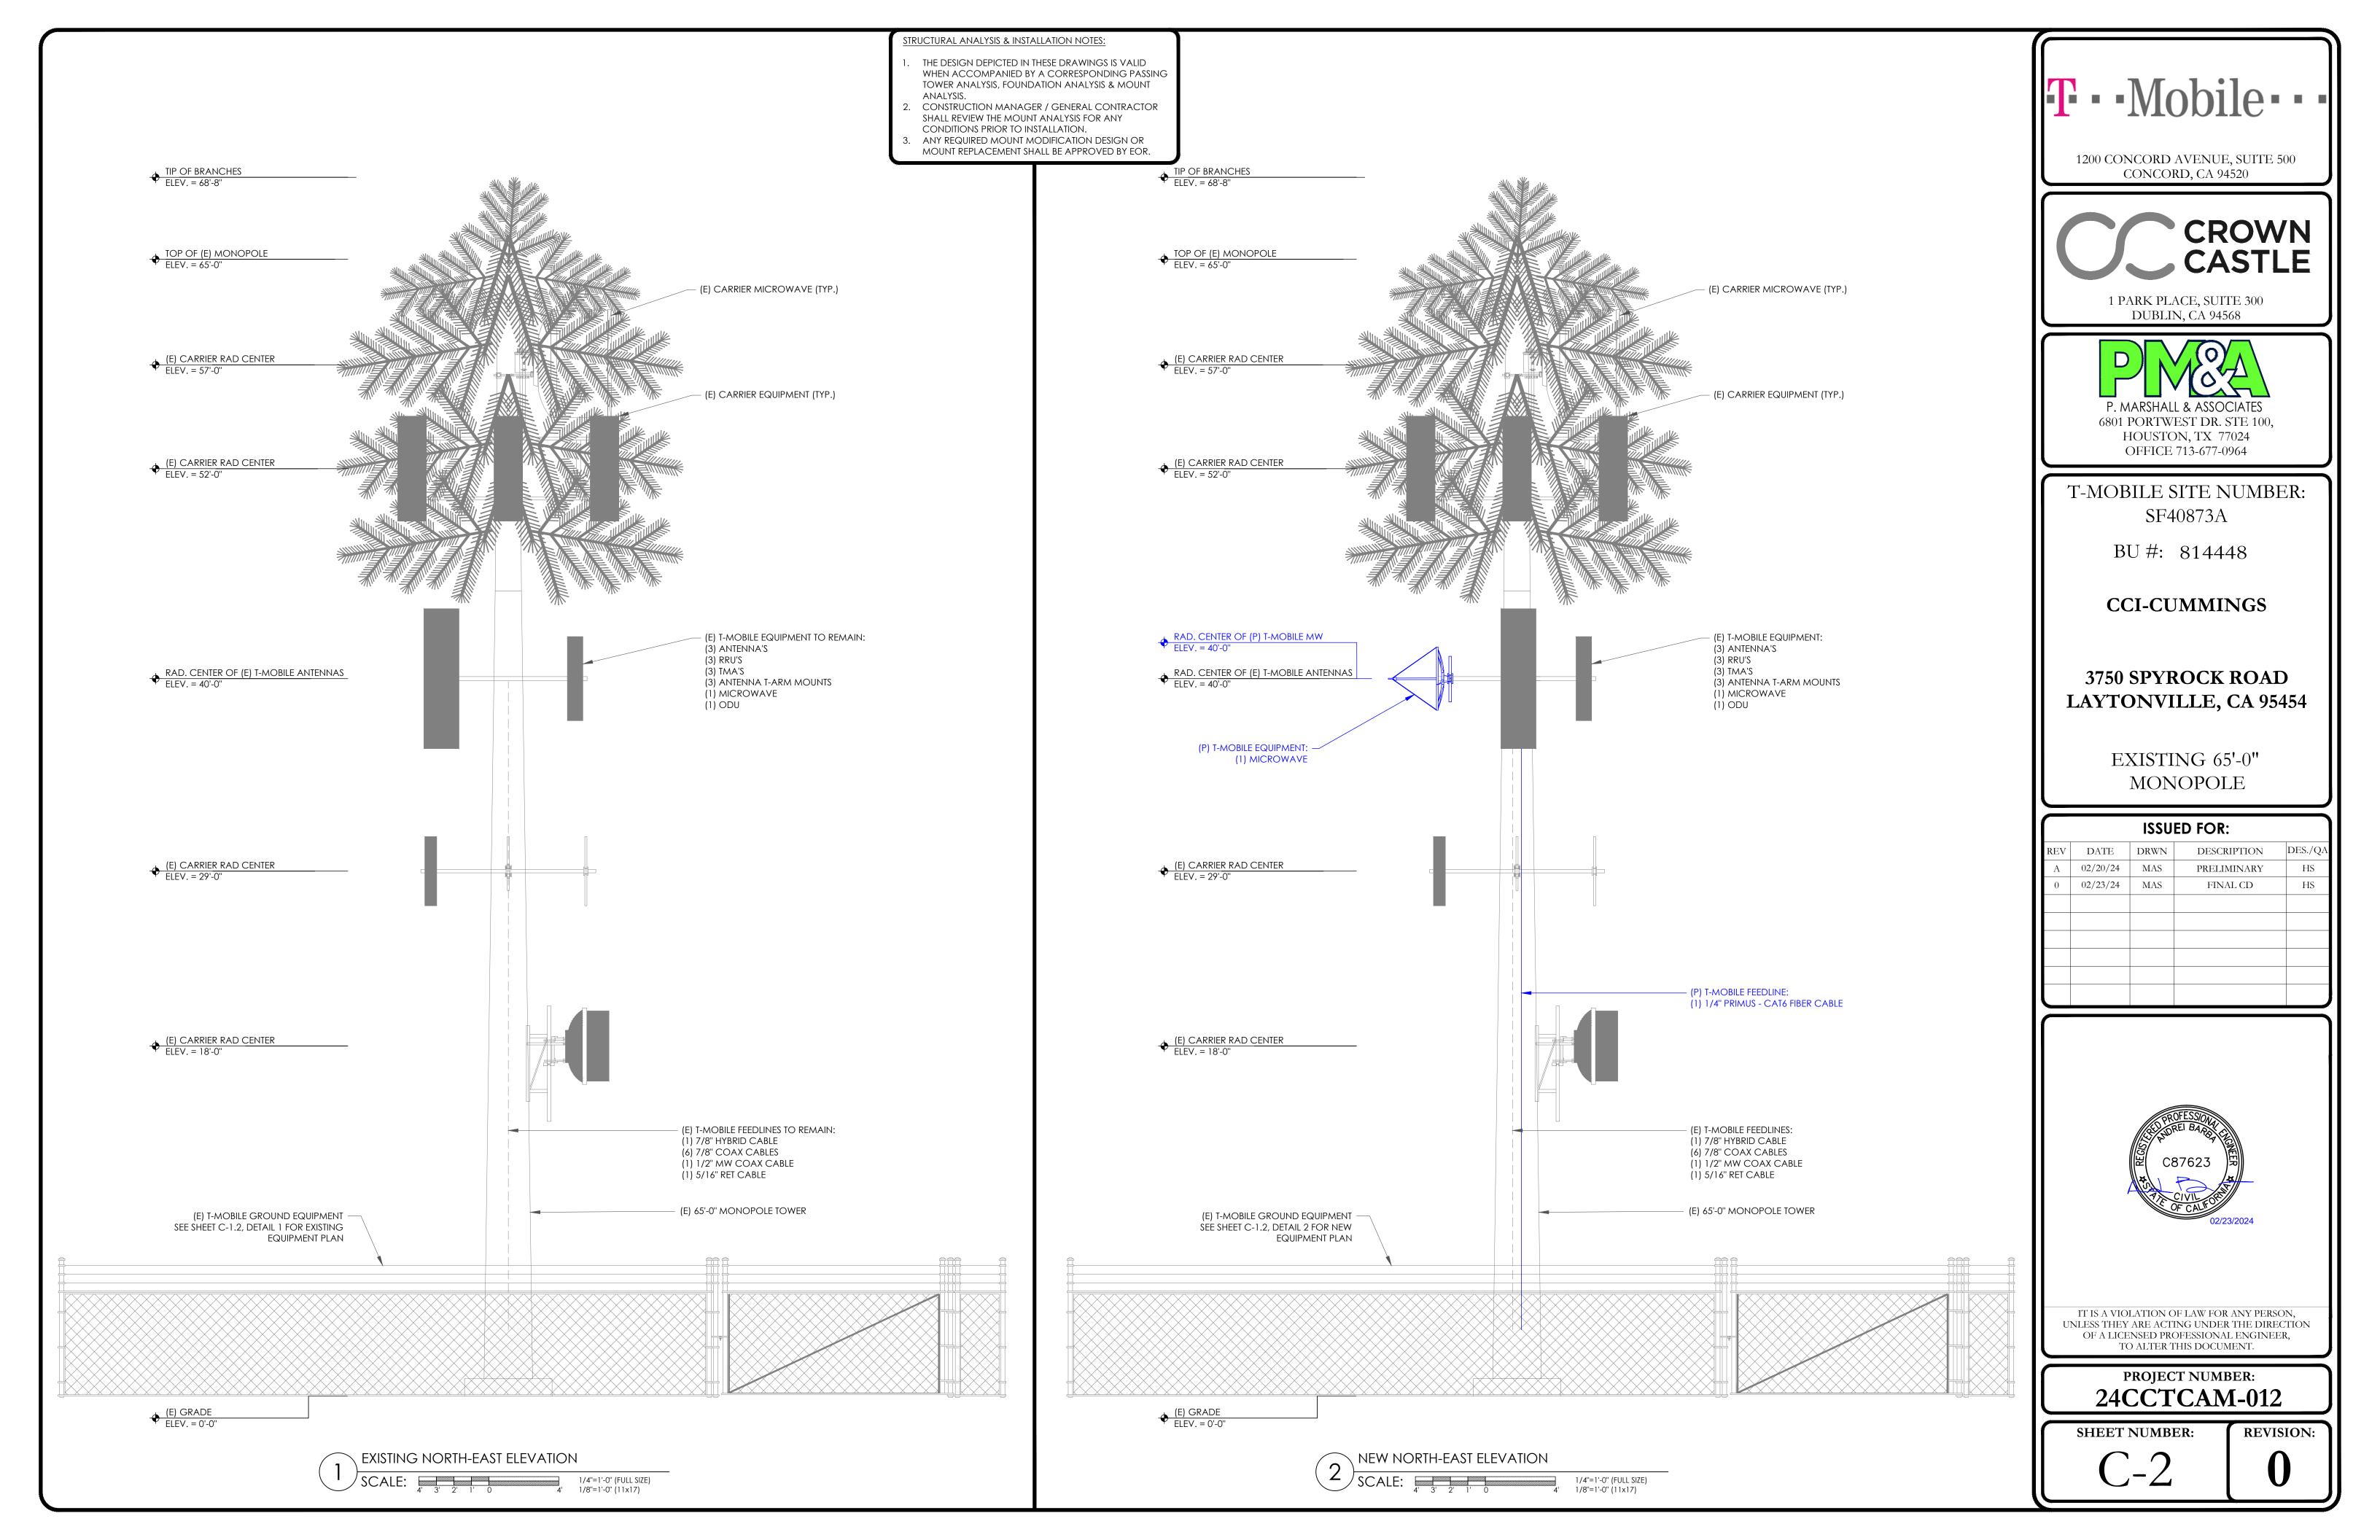
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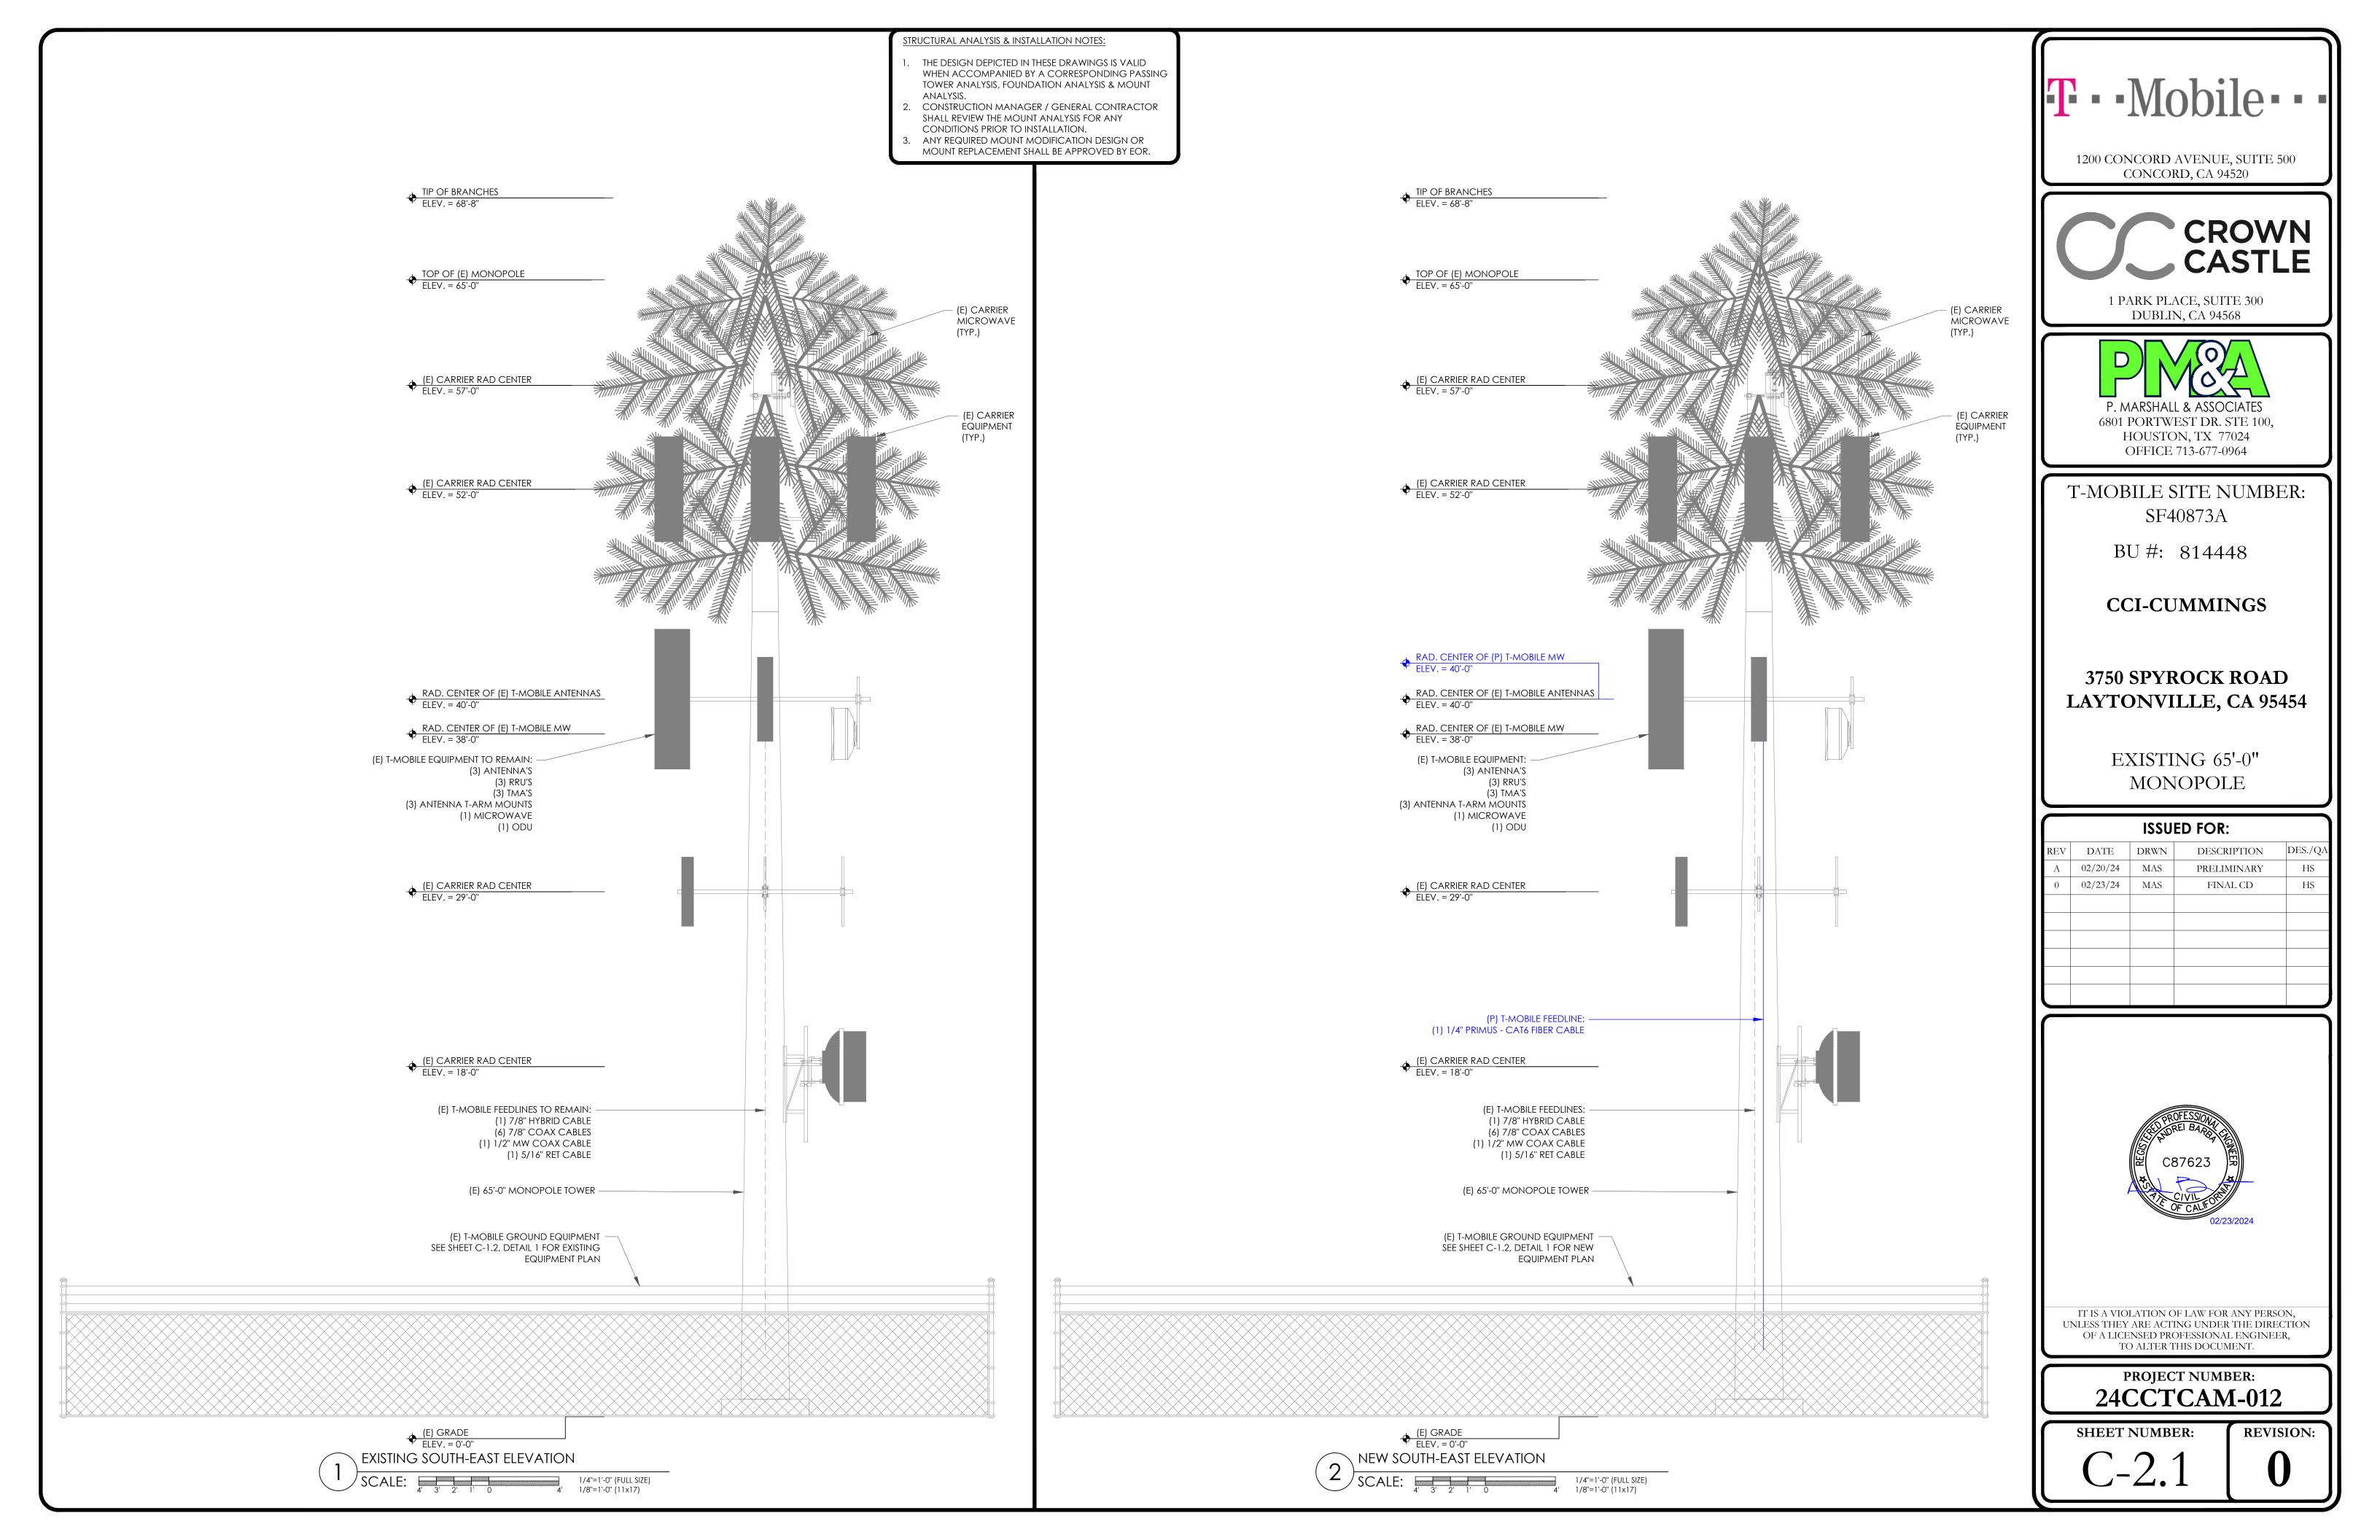
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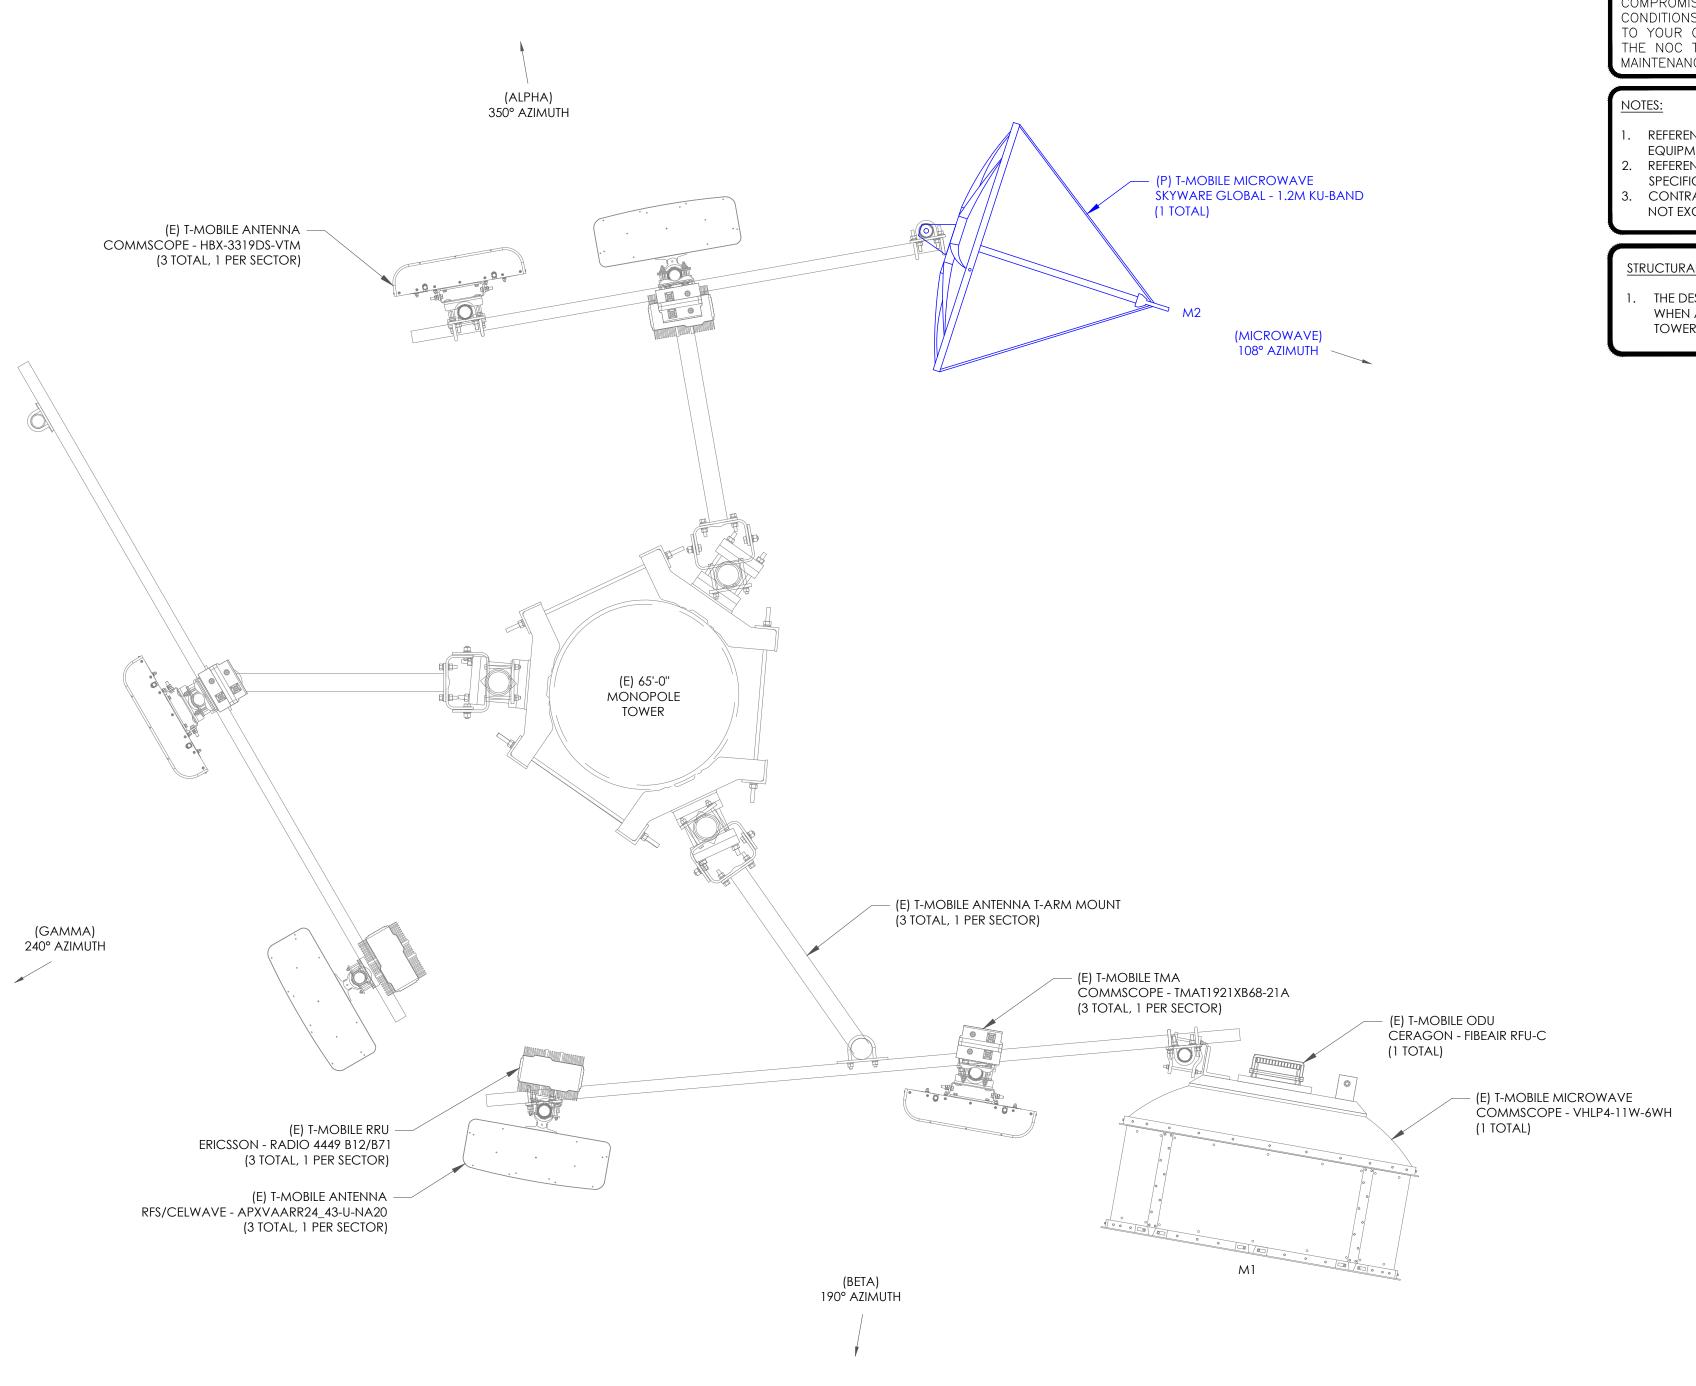
-1.2

NEW EQUIPMENT PLAN

— (N







"LOOK UP" — CROWN CASTLE USA INC. SAFETY CLIMB REQUIREMENT:

THE INTEGRITY OF THE SAFETY CLIMB AND ALL COMPONENTS OF THE CLIMBING FACILITY SHALL BE CONSIDERED DURING ALL STAGES OF DESIGN, INSTALLATION, AND INSPECTION. TOWER MODIFICATION, MOUNT REINFORCEMENTS, AND/OR EQUIPMENT INSTALLATIONS SHALL NOT COMPROMISE THE INTEGRITY OR FUNCTIONAL USE OF THE SAFETY CLIMB OR ANY COMPONENTS OF THE CLIMBING FACILITY ON THE STRUCTURE. THIS SHALL INCLUDE, BUT NOT BE LIMITED TO: PINCHING OF THE WIRE ROPE, BENDING OF THE WIRE ROPE FROM ITS SUPPORTS, DIRECT CONTACT OR CLOSE PROXIMITY TO THE WIRE ROPE WHICH MAY CAUSE FRICTIONAL WEAR, IMPACT TO THE ANCHORAGE POINTS IN ANY WAY, OR TO IMPEDE/BLOCK ITS INTENDED USE. ANY COMPROMISED SAFETY CLIMB, INCLUDING EXISTING CONDITIONS MUST BE TAGGED OUT AND REPORTED TO YOUR CROWN CASTLE USA INC. POC OR CALL THE NOC TO GENERATE A SAFETY CLIMB MAINTENANCE AND CONTRACTOR NOTICE TICKET.

- REFERENCE CROWN APPLIACTION 661913 FOR FINAL EQUIPMENT SCHEDULE.
- 2. REFERENCE SHEETS C-5 & C-5.1 FOR NEW EQUIPMENT SPECIFICATIONS.
- 3. CONTRACTOR TO VERIFY ALL ANTENNA TIP HEIGHTS DO NOT EXCEED BEACON BASE HEIGHT.

STRUCTURAL ANALYSIS NOTES:

1. THE DESIGN DEPICTED IN THESE DRAWINGS IS VALID WHEN ACCOMPANIED BY A CORRESPONDING PASSING TOWER ANALYSIS & FOUNDATION ANALYSIS.

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PROJECT NUMBER: 24CCTCAM-012

SHEET NUMBER:

C-3

REVISION:

FINAL MICROWAVE PLAN

" (FULL SIZE) " (11x17) N

FINAL MICROWAVE EQUIPMENT SCHEDULE MICROWAVE ANTENNA RADIO DIPLEXER TMA SURGE PROTECTION CABLES RAD CENTER POSITION LOCATION QTY. LOCATION QTY. SIZE LENGTH TECH. STATUS/MANUFACTURER MODEL AZIMUTH STATUS/MODEL STATUS STATUS STATUS/MODEL STATUS/TYPE MW COAX CABLE 1/2" MW (E) COMMSCOPE - VHLP4-11W-6WH 190° 38'-0" (E) CERAGON - FIBEAIR RFU-C M1 M1 5/16" MW RET CABLE 90' (N) SKYWARE GLOBAL - 1.2M KU-BAND 108° 40'-0" FIBER CABLE 1/4" 90'

<u>NOTE:</u> (E) - EXISTING

(N) - NEW



1200 CONCORD AVENUE, SUITE 500 CONCORD, CA 94520



1 PARK PLACE, SUITE 300 DUBLIN, CA 94568



6801 PORTWEST DR. STE 100, HOUSTON, TX 77024 OFFICE 713-677-0964

T-MOBILE SITE NUMBER: SF40873A

BU #: 814448

CCI-CUMMINGS

3750 SPYROCK ROAD LAYTONVILLE, CA 95454

> EXISTING 65'-0" MONOPOLE

ISSUED FOR:						
REV	DATE	DRWN	DESCRIPTION	DES./QA		
Α	02/20/24	MAS	PRELIMINARY	HS		
0	02/23/24	MAS	FINAL CD	HS		





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PROJECT NUMBER: 24CCTCAM-012

SHEET NUMBER:

Type 123 Class II / 1.2m Ku-Band Offset Antenna with XPC Feed



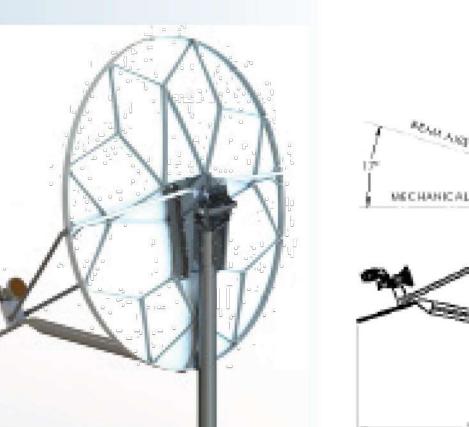

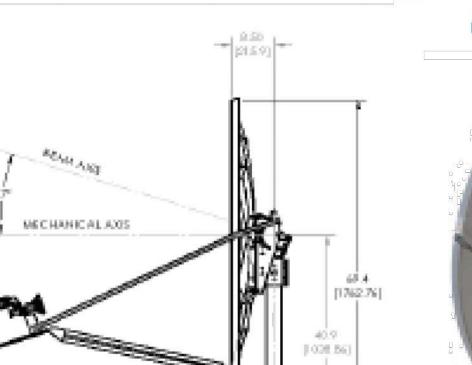

- All materials comply with EU directive No. 2002/95/EC (RoHS).
- Long focal length optics for low cross-pol perfomance.
- Fine azimuth and elevation adjustments.
- Available with Ku-band co-pol or cross-pol feeds.
- Galvanized 19 mm (.75") O.D. side feed support legs and 51 mm (2") O.D. lower feed support.
- Plated hardware for maximum corrosion resistance.



Class II system designed for typical 2 W and 4 W Ku-band Block Up-Converters (BUCs).*

*3.6 kg or 8 lb max. weight for RF



RF Performance

Ki i ci ioi illance	
Polarization	Linear, Orthogonal
The state of the s	43.3 dBi @ 14.3 GHz 41.8 dBi @ 12.0 GHz
20° < θ < 26.3°	o-Pol dBi) 29-25 log θ dBi 3.5 dBi 32-25 log θ dBi

Antenna Cross-Polarization>30 dB in 1 dB Contour

the fact and the fact and the fact and the fact
Antenna Noise Temperature 10° EL
VSWR Tx
Isolation (Port to Port) Tx
Feed Interface

(All specifications typical)

48° < θ < 180°.....-10 dBi

Reflector Material

Mechanical Performance

Antenna Optics One-Piece Offset Feed Prime Focus
Mount Type Elevation over Azimuth
Elevation Adjustment Range7° - 84° Continuous Fine Adjustment

Azimuth Adjustment Range 360° Continuous, ± 20° Fine Adjustment

Mast Pipe Interface

Enviromental Performance

Wind Loading Operational	50 mph (80 km/h)
Survival	125 mph (200 km/h)
Temperature	50°C to +80°C
Humidity	0 to 100% (Condensing)
Atmosphere	dard Hardware 500 Hrs uirements (ASTM B-117)
Solar Radiation	360 BTU/h/ ft²

REV 10/17-02

Shipping and handling

1315 Outlet Center Drive, Smithfield, NC 27577 T + 1 919 934 9711 F + 1 919 989 2274 Sales @ Skyware Global.com All designs, specification and availabilities of products and services presented in this bulletin are subject to change without notice. ©2016 Skyware Global

Shock and Vibration. As Encountered during

Page 1 of 1



1200 CONCORD AVENUE, SUITE 500 CONCORD, CA 94520



1 PARK PLACE, SUITE 300 DUBLIN, CA 94568



HOUSTON, TX 77024 OFFICE 713-677-0964

T-MOBILE SITE NUMBER: SF40873A

BU #: 814448

CCI-CUMMINGS

3750 SPYROCK ROAD LAYTONVILLE, CA 95454

> EXISTING 65'-0" MONOPOLE

	ISSUED FOR:					
REV	DATE	DRWN	DESCRIPTION	DES./Q		
Α	02/20/24	MAS	PRELIMINARY	HS		
0	02/23/24	MAS	FINAL CD	HS		



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> PROJECT NUMBER: **24CCTCAM-012**

SHEET NUMBER:



Specification for Hyper-Data 2000 CAT6 UTP Stranded LSZH Lan Cable

Spec. No. S901106 Version: B Date: March 25th, 2008

TIA/EIA-568-B.2-1: Patch Cable (Stranded Conductor), 24 AWG x 4P

1. Conductor: Stranded Bare Copper (7 x 32 AWG)

2. Insulation : HDPE (CMI-75E)

Nominal Wall Thickness: 0.178mm

Min. Thickness: 0.153mm

3. Color Code: Pair 1: Blue & White/Blue

Pair 2: Orange & White/Orange Pair 3: Green & White/Green Pair 4: Brown & White/Brown

4. Jacket (Grey): 75°C LSZH Compound

Nominal Wall Thickness: 0.585mm

Min. Thickness: 0.458mm Overall Diameter: 5.8mm ± 0.3mm

5. Electric Requirements: (Cable length: 100m)

Characteristic Impedance(Zo): $85\sim115\Omega$ (1~250 MHz)

DC. Resistance Capacitance Unbalance: 5%

Pair-to-Ground Capacitance Unbalance: 330 pF/100m Max.


Conductor Resistance: $14.00\Omega/100m\ 20^{\circ}$ Max.

Mutual Capacitance: 5.6nF/m Max.

Spark Test: 2.5kV

Nominal Velocity of Propagation (NVP): 69%


RoHS Compliant

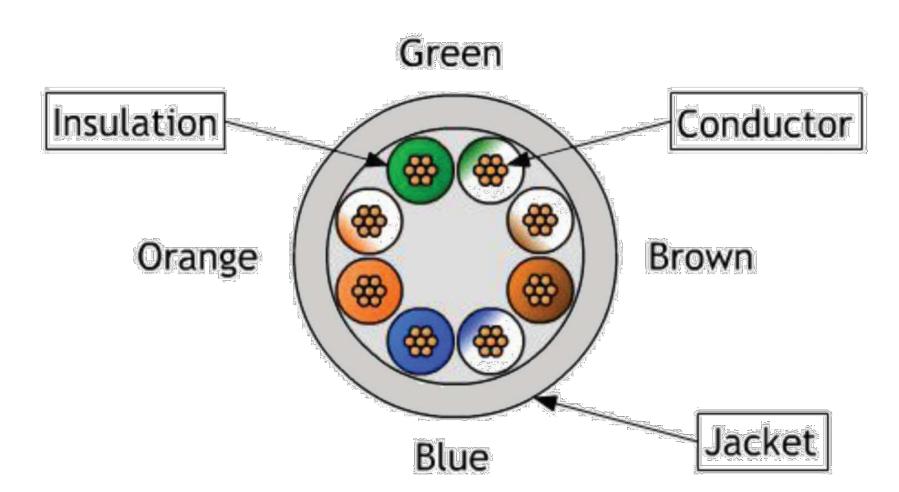

Frequency MHz	Att. Stranded	Pr-Pr NEXT	PS NEXT	Prop. Delay ns	Delay Skew ns	Return Loss	Pr-Pr ELFEXT	PS ELFEXT
1	2.4	74.3	72.3	538.5	45	20.0	67.8	64.8
10	7.1	59.3	57.3	545.0	45	25.0	47.8	44.8
20	10.2	54.8	52.8	539.9	45	25.0	41.8	38.8
31.25	12.8	51.9	49.9	540.2	45	23.3	37.9	34.9
62.5	18.5	47.4	45.4	540.8	45	20.7	31.9	28.9
100	23.8	44.3	42.3	541.4	45	19.0	27.8	24.8
200	34.8	39.8	37.8	542.5	45	16.4	21.8	18.8
250	39.4	38.3	36.3	543.0	45	15.6	19.8	16.8

DISCLAIMER: This PDF is for information only and R&M Electrical Group Ltd can not be held liable for any information therein.



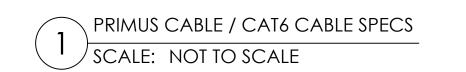



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P. MARSHALL & ASSOCIATES 6801 PORTWEST DR. STE 100, HOUSTON, TX 77024 OFFICE 713-677-0964

T-MOBILE SITE NUMBER: SF40873A

BU #: 814448

CCI-CUMMINGS

3750 SPYROCK ROAD LAYTONVILLE, CA 95454

EXISTING 65'-0"
MONOPOLE

ISSUED FOR:					
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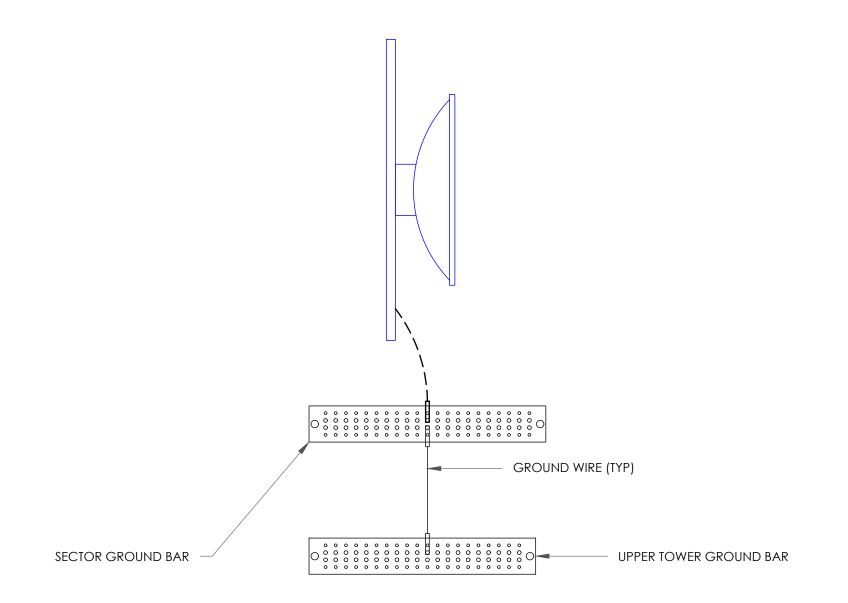
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PROJECT NUMBER: 24CCTCAM-012

SHEET NUMBER:

C-6

0



NOTE

ALL NEW GROUNDS TO BE #6 STRANDED COPPER WITH GREEN INSULATION UNLESS NOTED OTHERWISE.



1200 CONCORD AVENUE, SUITE 500 CONCORD, CA 94520





P. MARSHALL & ASSOCIATES 6801 PORTWEST DR. STE 100, HOUSTON, TX 77024 OFFICE 713-677-0964

T-MOBILE SITE NUMBER: SF40873A

BU #: 814448

CCI-CUMMINGS

3750 SPYROCK ROAD LAYTONVILLE, CA 95454

EXISTING 65'-0"
MONOPOLE

	ISSUED FOR:					
REV	DATE	DRWN	DESCRIPTION	DES./QA		
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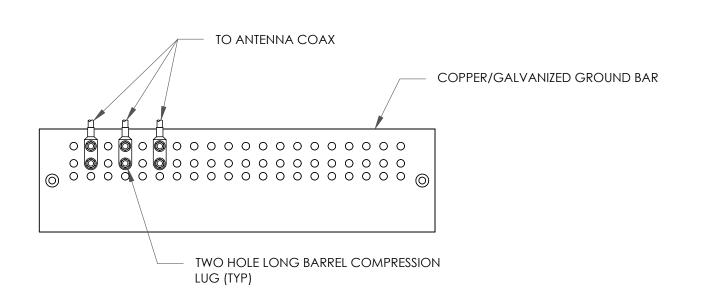
SHEET NUMBER:

 G^{-1}

REVISION:

MICROWAVE GROUNDING DIAGRAM

SCALE: NOT TO SCALE



TO TOWER MOUNTED EQUIPMENT -

TO ANTENNA

STANDARD COAX

(TYP)

CABLE GROUND KIT

#6 STRANDED CU WIRE WITH

COAX CABLE

(TYP FOR ALL)

KITS AT THE MIDPOINT. PROVIDE AS REQUIRED.

ANSI/TIA 222 AND NFPA 780.

TO BTS EQUIPMENT VIA

GROUND WIRE

INSPECTION WELL

NOTE 3

TRAY OR ICE BRIDGE

GREEN, 600V, THWN INSULATION

(OR AS PROVIDED WITH GROUND

- 1. DOUBLING UP "OR STACKING" OF CONNECTIONS IS NOT PERMITTED.
- EXTERIOR ANTIOXIDANT JOINT COMPOUND TO BE USED ON ALL EXTERIOR CONNECTIONS.
- 3. GROUND BAR SHALL NOT BE ISOLATED FROM TOWER. MOUNT DIRECTLY TO ANTENNA MOUNT STEEL.



MONOPOLE

ANTENNA GROUND BAR

(BONDED TO TOWER STEEL)

2 HOLE LUG (TYP)

MECHANICAL CONNECTION

COAX GROUND BAR WITH

INSULATORS, CONNECTED

2/0 TINNED BARE

MONOPOLE PIER

GROUND WIRE SEE NOTE 3

- EXOTHERMIC WELD (TYP)

COPPER WIRE

DIRECTLY TO THE BOTTOM OF MONOPOLE. SEE NOTE 1.

LOCATED AT MCL



TO ANTENNA COAX

1. EXTERIOR ANTIOXIDANT JOINT COMPOUND TO BE USED ON ALL EXTERIOR CONNECTIONS.

3. GROUND BAR SHALL BE ISOLATED FROM BUILDING OR SHELTER.

<u>NOTES:</u>


TWO HOLE LONG BARREL COMPRESSION LUG (TYP)

2. GROUND BAR SHALL NOT BE ISOLATED FROM TOWER. MOUNT DIRECTLY TO TOWER STEEL (TOWER ONLY).


COPPER/GALVANIZED GROUND BAR

#2 SOLID TINNED COPPER


CONDUCTOR TO TOWER/SHELTER
GROUND RING (2 TYP. FOR BOTTOM
GROUND BAR ONLY)

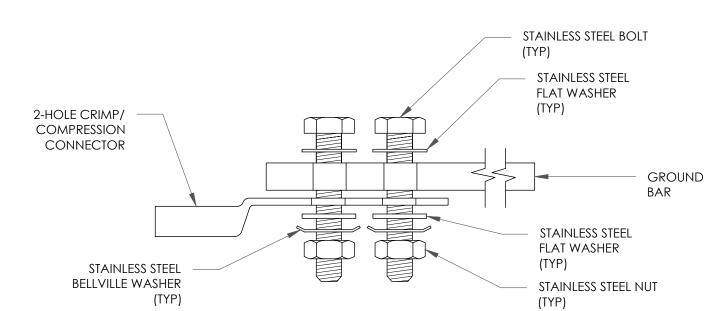

SINGLE CONNECTOR AT GROUND BARS

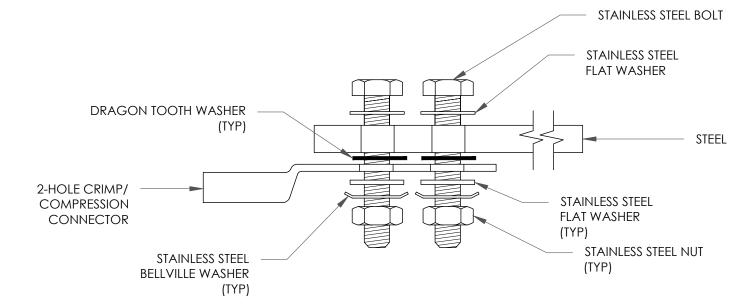

SINGLE CONNECTOR AT STEEL OBJECTS

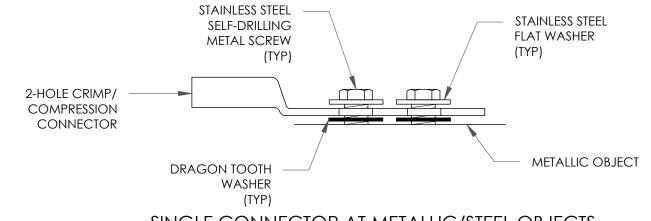

SINGLE CONNECTOR AT METALLIC/STEEL OBJECTS

TYPICAL MICROWAVE CABLE GROUNDING SCALE: NOT TO SCALE

1. NUMBER OF GROUNDING BARS MAY VARY DEPENDING ON THE TYPE OF TOWER, ANTENNA LOCATIONS AND

2. ONLY MECHANICAL CONNECTIONS ARE ALLOWED TO BE MADE TO CROWN CASTLE USA INC. TOWERS. ALL

3. ALL TOWER GROUNDING SYSTEMS SHALL COMPLY WITH THE REQUIREMENTS OF THE RECOGNIZED EDITION OF

MECHANICAL CONNECTIONS SHALL BE TREATED WITH AN ANTI-OXIDANT COATING.

CONNECTION ORIENTATION. COAXIAL CABLES EXCEEDING 200 FEET ON THE TOWER SHALL HAVE GROUND



NOT USED SCALE: NOT TO SCALE

NOT USED

SCALE: NOT TO SCALE



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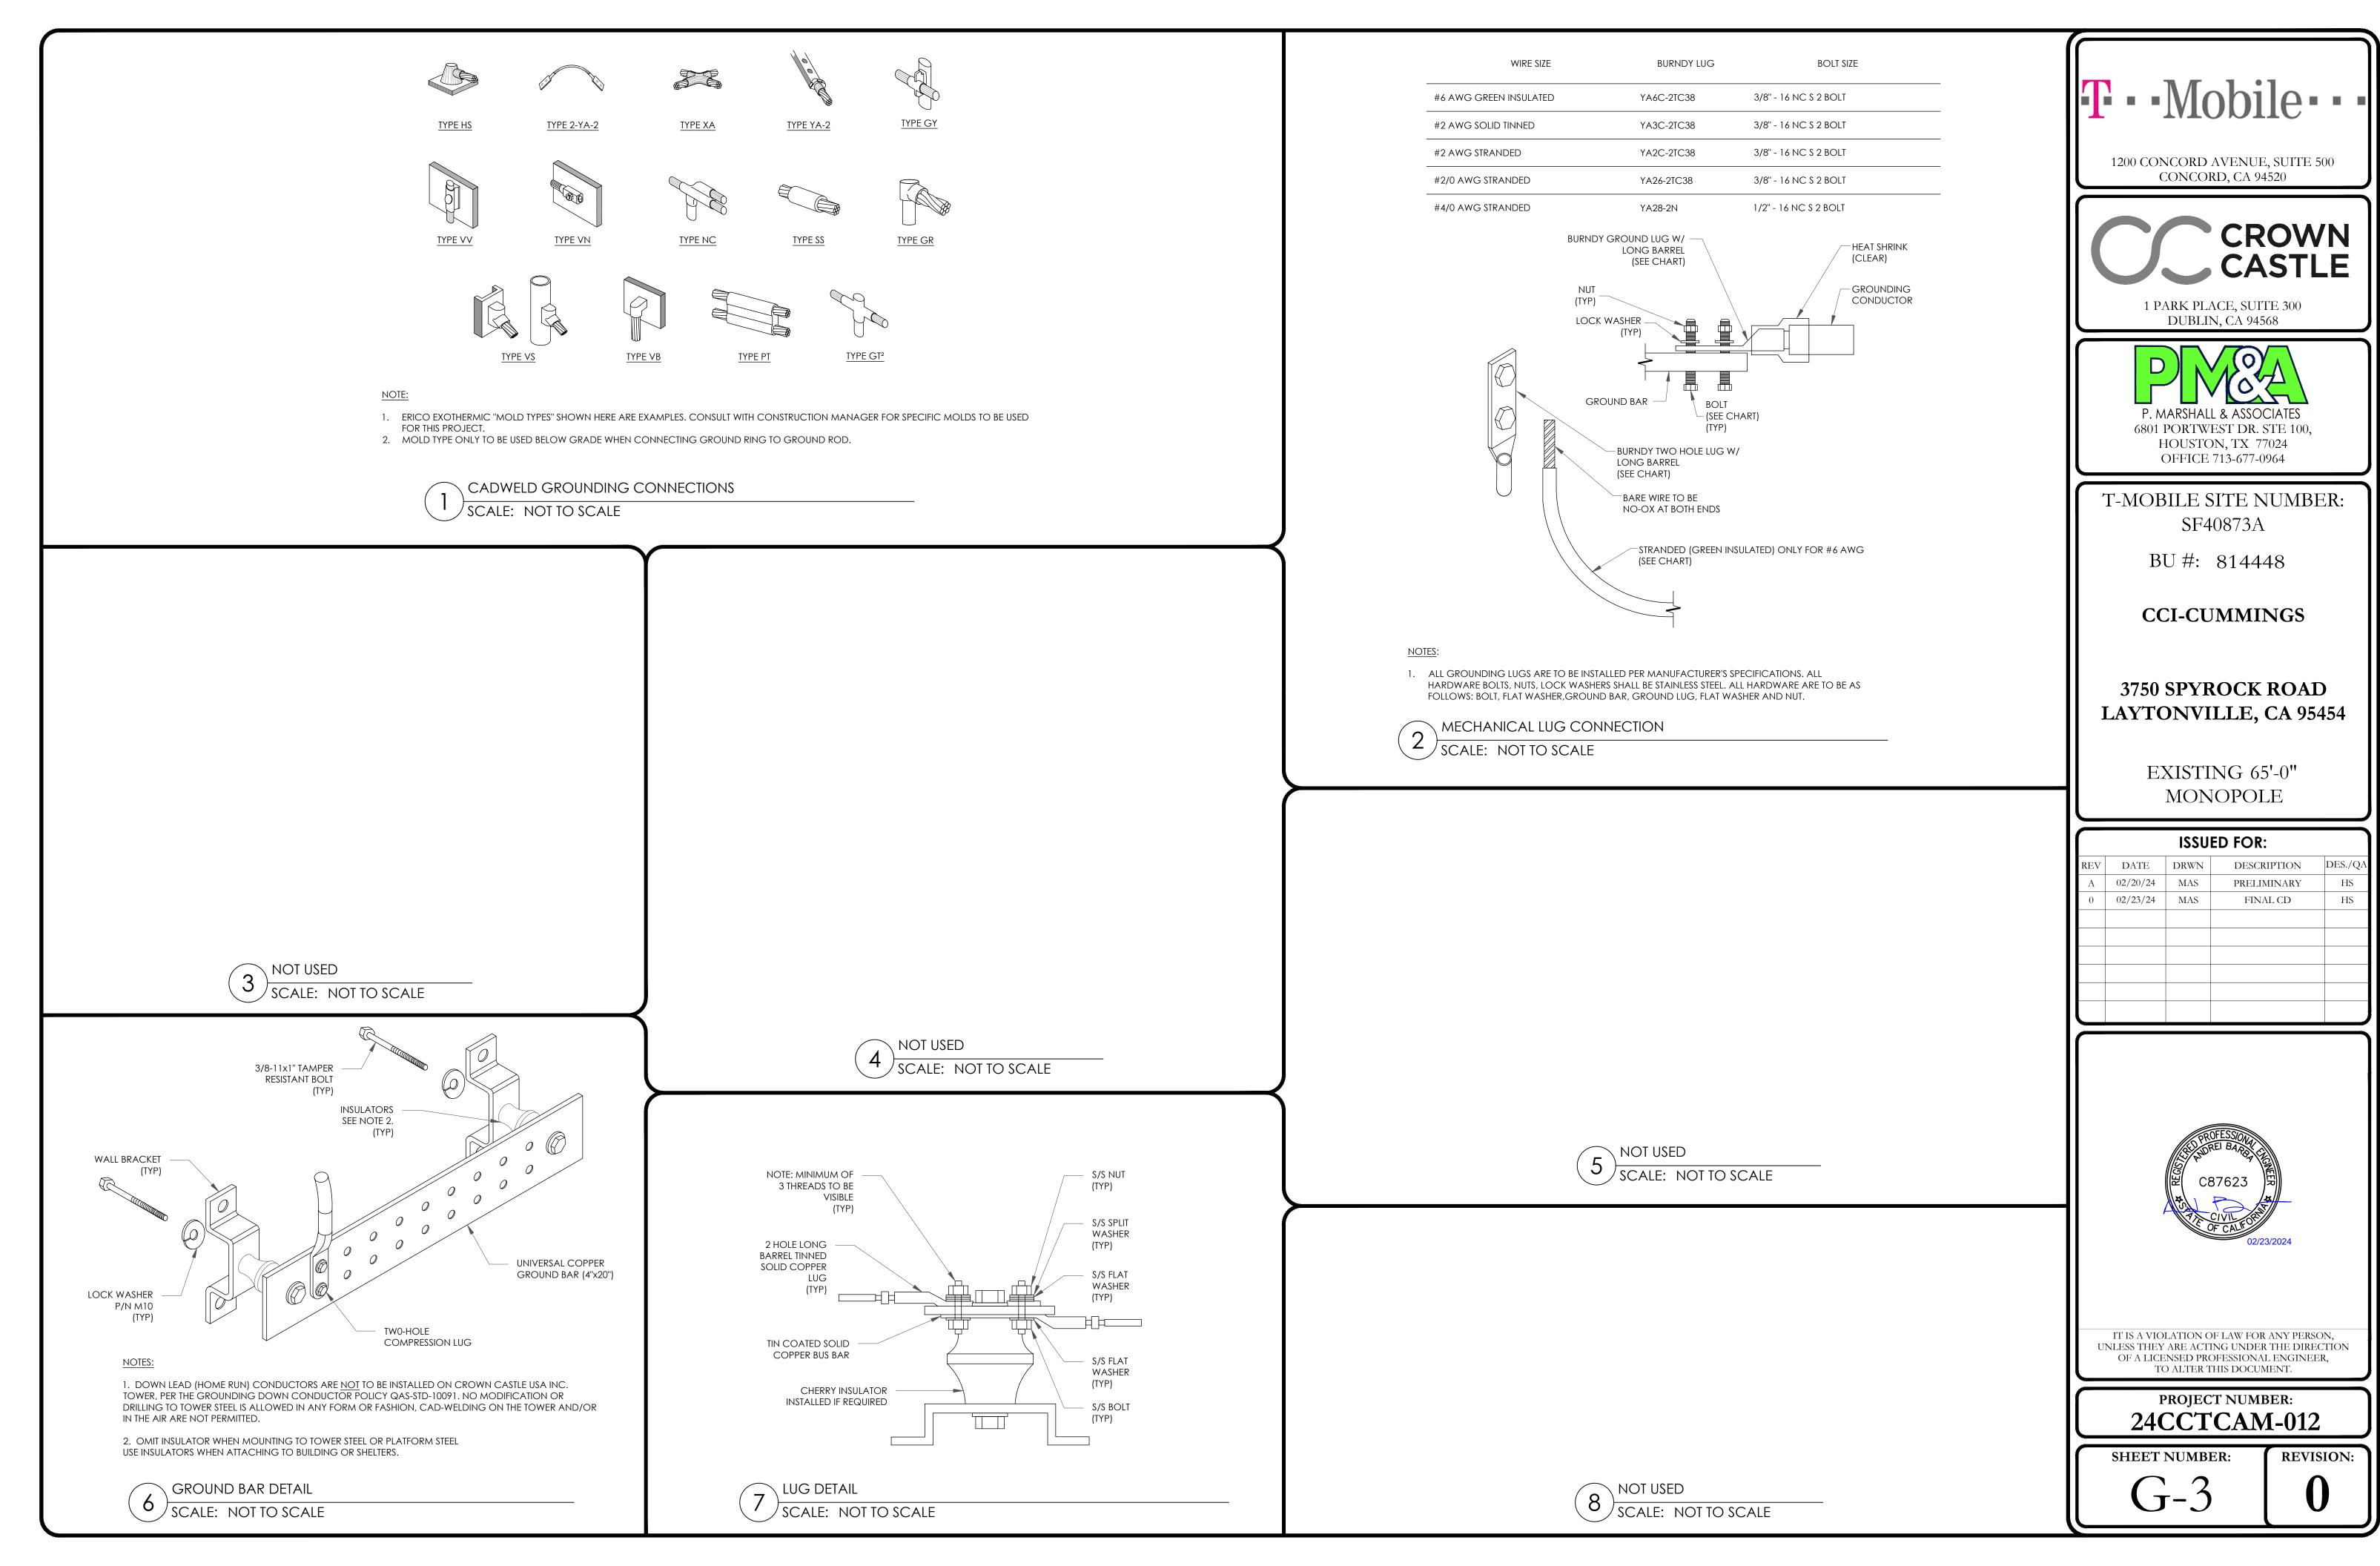
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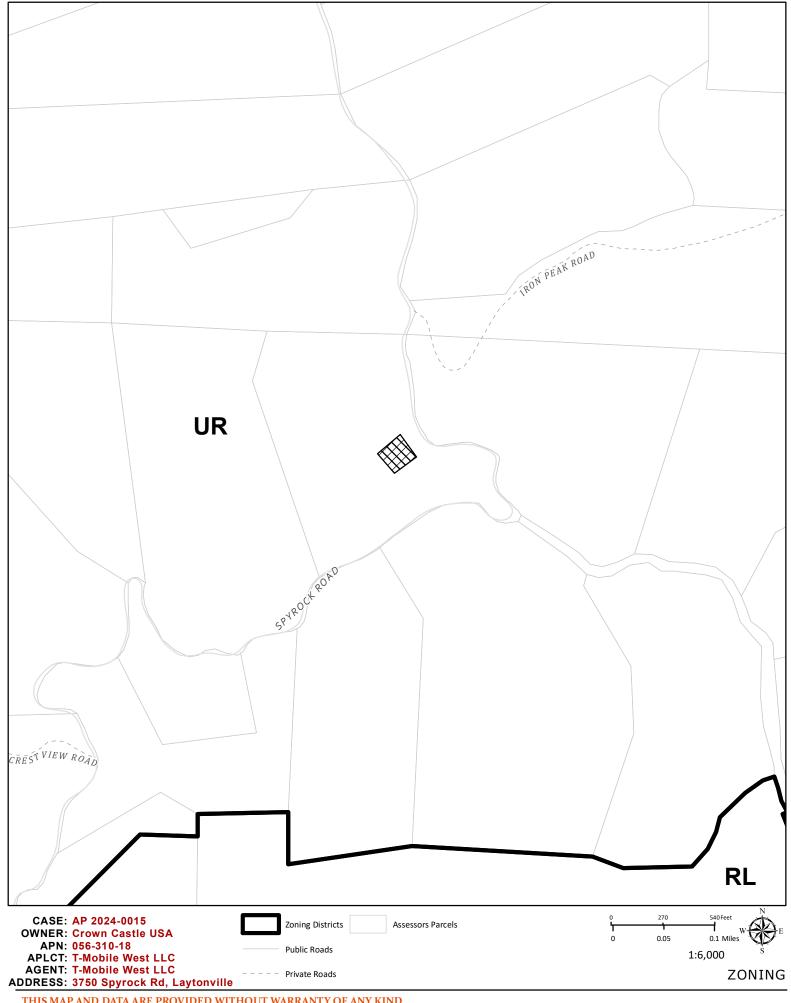



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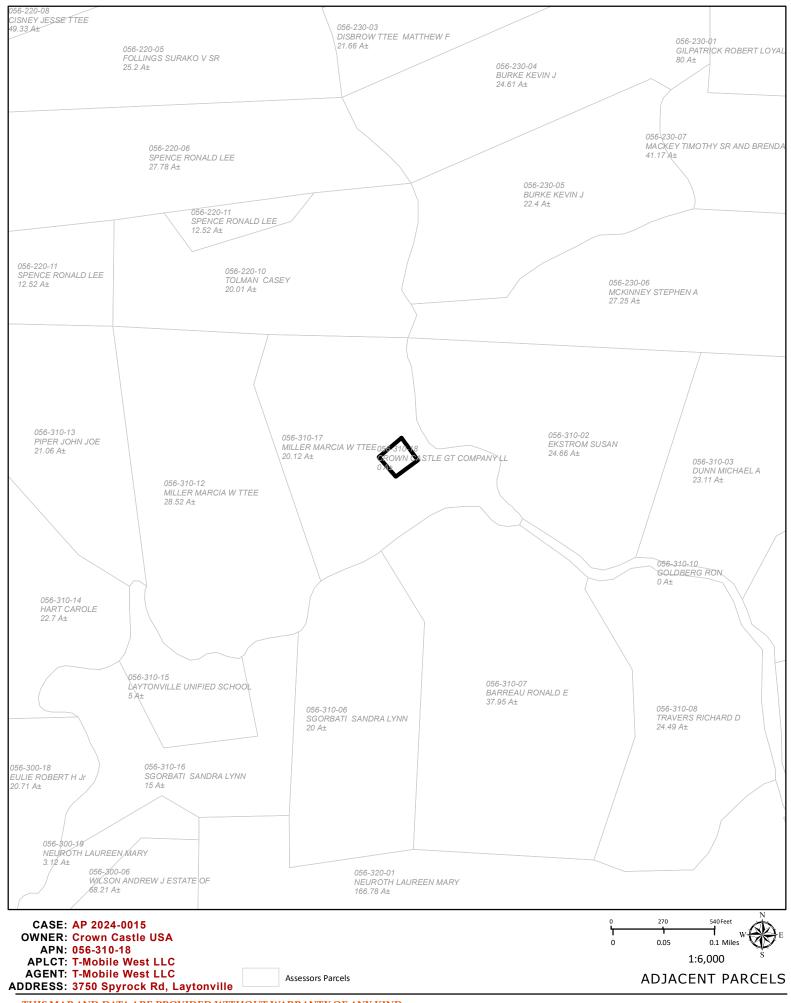
> PROJECT NUMBER: **24CCTCAM-012**


SHEET NUMBER:









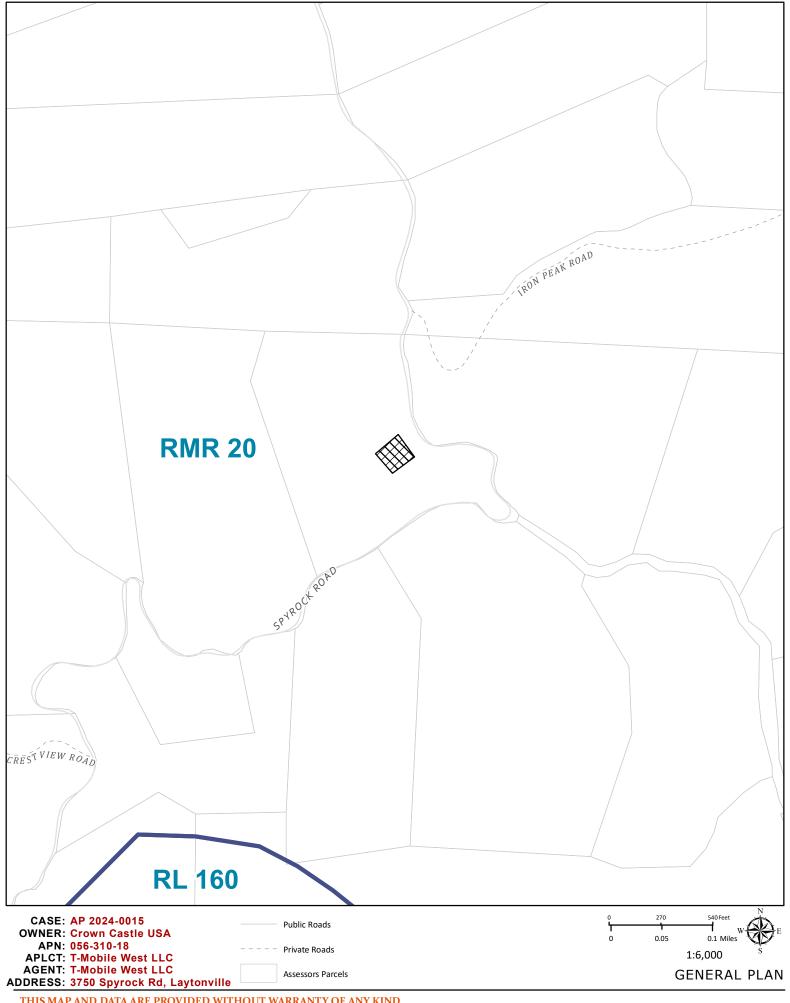


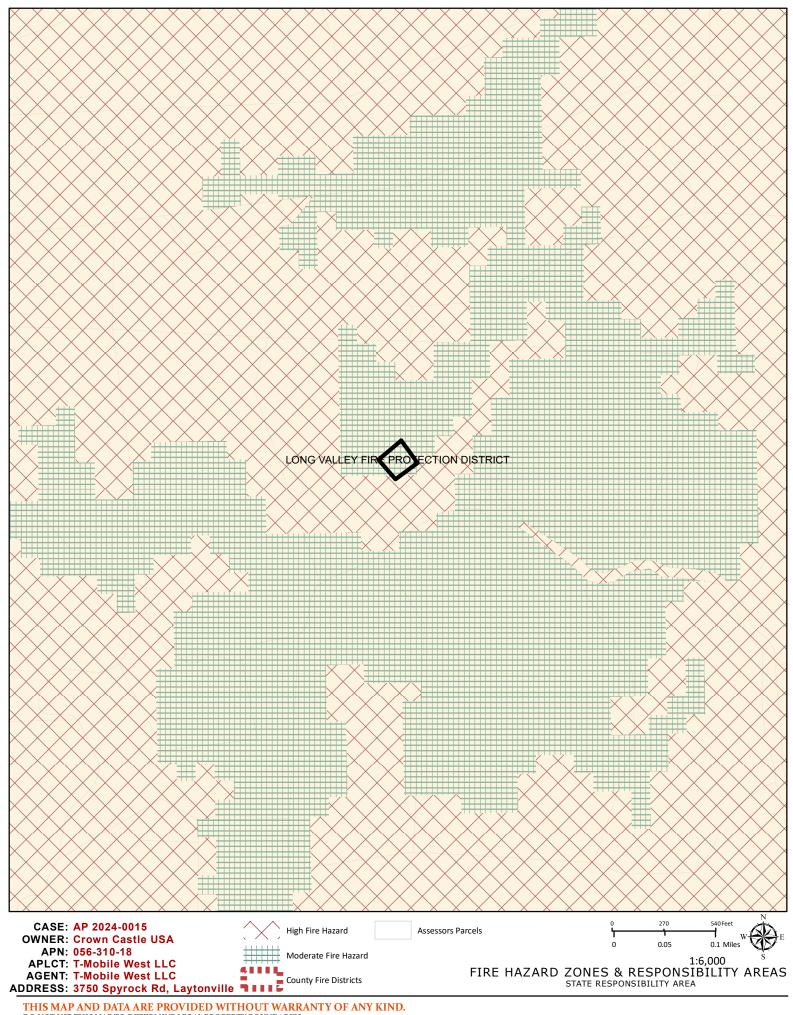



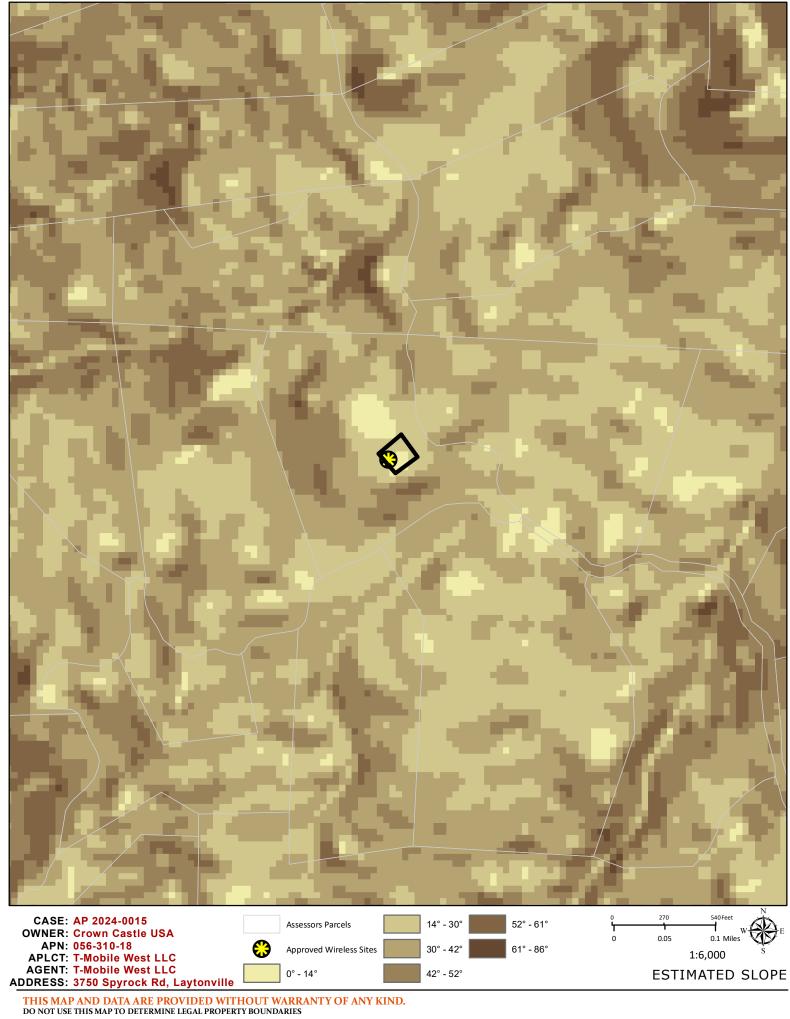

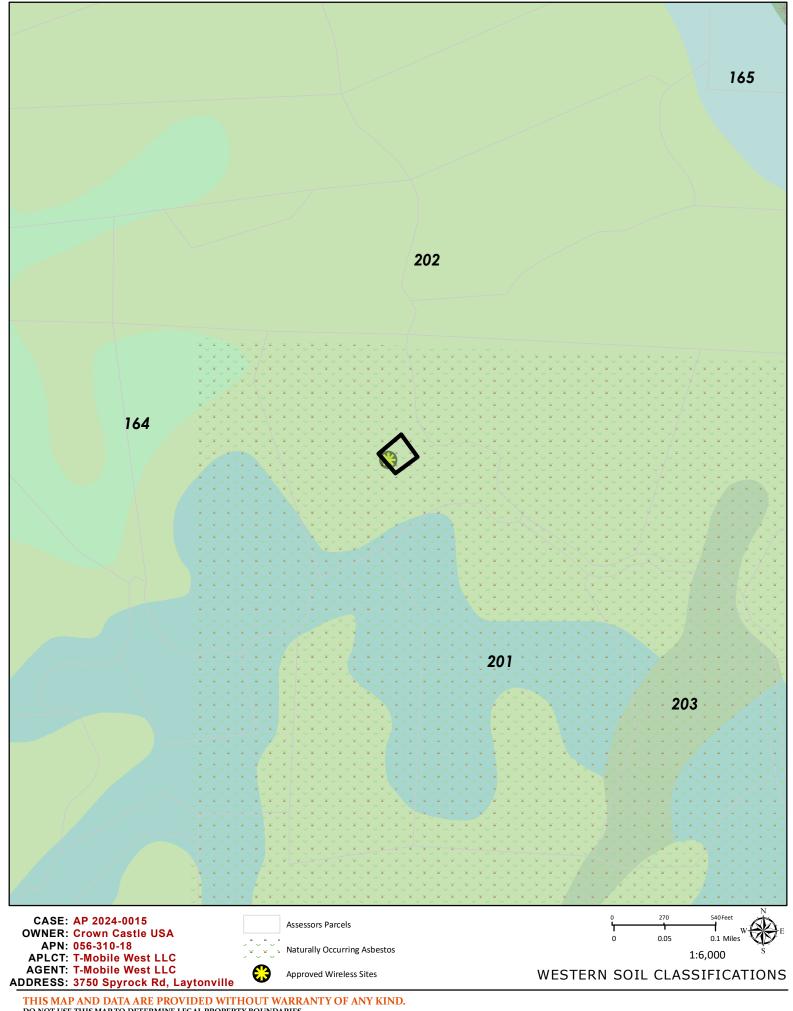


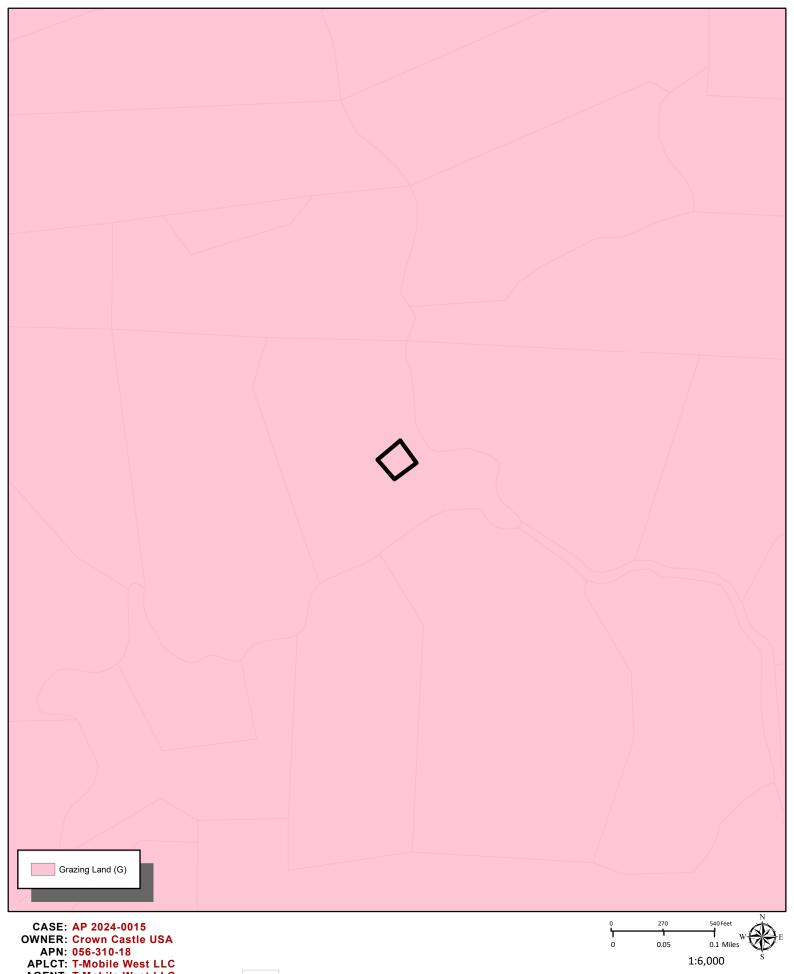

AGENT: T-Mobile West LLC
ADDRESS: 3750 Spyrock Rd, Laytonville

Assessors Parcels


FARMLAND CLASSIFICATIONS

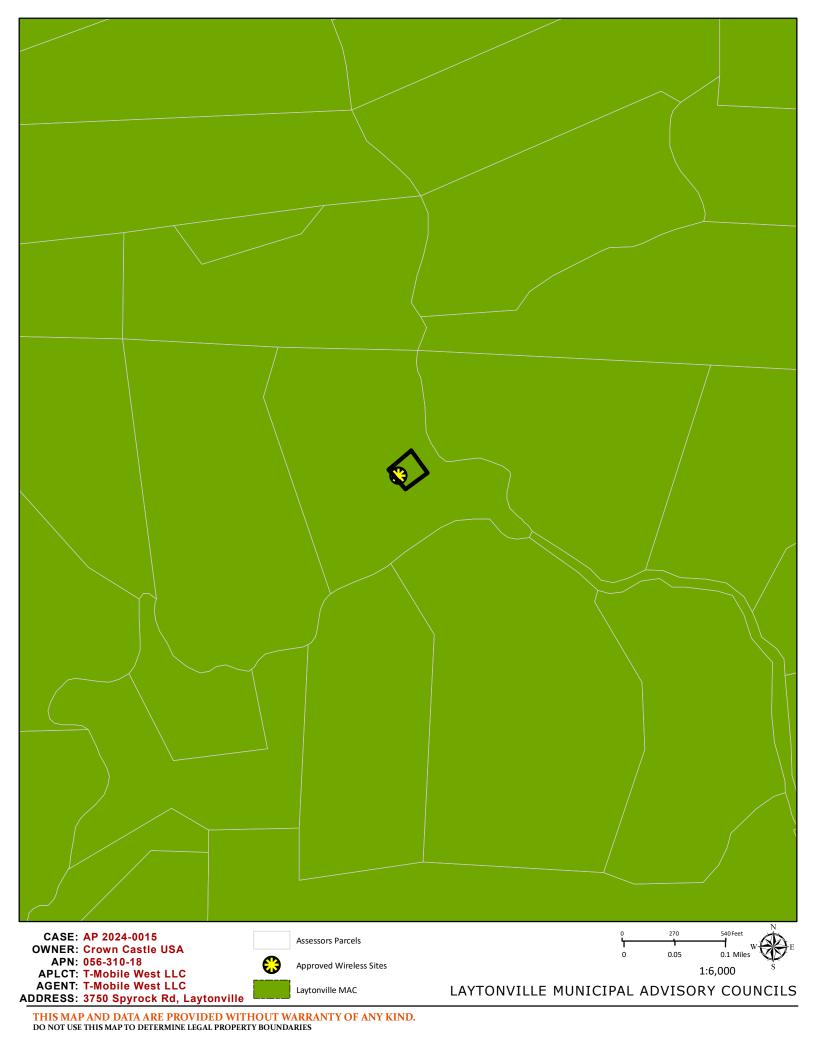



Phone: (678) 366-1259 www.crowncastle.com

	Project Data Sheet					
Business Unit (BU) 814448						
Application/Order Number	661913					
Crown Castle Site Name	CUMMINGS					
Customer Site Number	SF40873A					
Site Address	3750 Spyrock Road					
Site City, State, Zip	Laytonville, CA 95454					
Parcel Tax ID	056-310-18-00					
Applicant / Agent	T-Mobile West LLC by Crown Castle USA Inc.					
Agent Address	8020 Katy Fwy					
Agent phone number	(678) 366-1259					
Carrier						
	Add or replace antennas and ancillary equipment as per plans for an existing					
Scope of work	carrier on an existing wireless communication facility.					
Proporty Owner	CROWN CASTLE USA INC					
Property Owner Address						
Property Owner Address	POST OFFICE BOX 203112, HOUSTON, TX 77216-3112					
Structure Type	MONOPOLE					
Structure Height	65 FT					
Antenna Equipment Height	40					
Size of Compound Sq. Ft.	2,792 sq ft					
Latitude 39° 48′ 57.81″						
Longitude -123° 30′ 33.89″						
Zoning Jurisdiction	COUNTY OF MENDOCINO, CA					
Zoning Jurisdiction Address	860 NORTH BUSH STREET, UKIAH, CA 95482					
Permitting Jurisdiction	COUNTY OF MENDOCINO, CA					
Permitting Jurisdiction Address	860 NORTH BUSH STREET, UKIAH, CA 95482					

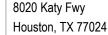



Phone: (678) 366-1259 www.crowncastle.com

March 1, 2024

COUNTY OF MENDOCINO, CA Dept of Planning and Building Services 860 NORTH BUSH STREET UKIAH, CA 95482

Via Electronic Delivery

*******NOTICE OF ELIGIBLE FACILITIES REQUEST********

RE: Request for Minor Modification to Existing Wireless Facility – Section 6409

Notice of Request for Approval of Emergency Standby Generator – CA AB 2421

Site Address: 3750 Spyrock Road, Laytonville, CA 95454

Crown Site Number: 814448 / Crown Site Name: CUMMINGS Customer Site Number: SF40873A / Application Number: 661913

Attention Reviewing Parties:

On behalf of T-Mobile West LLC ("T-Mobile" or "Applicant"), Crown Castle USA Inc. ("Crown Castle") is pleased to submit this request to modify the existing wireless facility noted above through the collocation, replacement and/or removal of the Applicant's equipment as an eligible facilities request for a minor modification under Section 6409¹ and the rules of the Federal Communications Commission ("FCC").²


Section 6409 mandates that state and local governments must approve any eligible facilities request for the modification of an existing wireless tower or base station that does not substantially change the physical dimensions of such tower or base station. Under Section 6409, to toll the review period, if the reviewing authority determines that the application is incomplete, it must provide written notice to the applicant within 30 days, which clearly and specifically delineates all missing documents or information reasonably related to whether the request meets the federal requirements.³ Additionally, if a state or local government, fails to issue any approvals required for this request within 60 days, these approvals are deemed granted. The FCC has clarified that the 30-day and 60-day deadlines begins when an applicant: (1) takes the first step required under state or local law; and (2) submits information sufficient to inform the jurisdiction that this modification qualifies under the federal law⁴.

To further secure public safety and welfare during times of fire emergencies, California AB 2421 provides for local administrative non-discretionary review of emergency standby generators as a permitted use, which a local agency shall review on an administrative, nondiscretionary basis. This law further allows applicants to concurrently seek landowner

¹ Middle Class Tax Relief and Job Creation Act of 2012, Pub. L. No. 112-96, § 6409 (2012) (codified at 47 U.S.C. § 1455).

² Acceleration of Broadband Deployment by Improving Wireless Facility Siting Policies, 29 FCC Rcd. 12865 (2014) (codified at 47 CFR § 1.6100); and Implementation of State & Local Governments' Obligation to Approve Certain Wireless Facility Modification Requests Under Section 6409(a) of the Spectrum Act of 2012, WT Docket No. 19-250 (June 10, 2020).

³ See 47 CFR § 1.6100 (c)(3). ⁴ See 2020 Upgrade Order at paragraph 16.

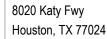



Phone: (678) 366-1259

consent, and states that such emergency standby generator application is deemed approved if not ruled upon within (60) days after a complete application is received by the local jurisdiction, excluding tolling. As indicated in the attached checklist, this application qualifies for review under this important law as well.

Please note that with the submission of this letter and enclosed items, the thirty and sixty-day review periods have started. Based on this filing, the deadline for written notice of incomplete application is March 31, 2024, and the deadline for issuance of approval is April 30, 2024.



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The proposed scope of work for this project includes:

The installation of a backup power supply as per plans for an existing wireless carrier at an existing wireless communication facility.

At the end of this letter is a checklist of the applicable substantial change criteria under Section 6409. Additionally, please find enclosed the following information in support of this request:

- (1);
- (2) Construction Drawings;
- (3) Structural Analysis; and
- (4) Section 6409 Substantial Change Checklist and CA AB 2421 Checklist.

As these documents indicate, this modification is an "eligible facilities request" as defined in the FCC's rules to which the 60-day deadline for approval applies. Further, the modification is a permitted under California AB 2421 that for which approval is administrative and nondiscretionary. Accordingly, Applicant requests all authorization necessary for this proposed modification.

Our goal is to work with you to obtain approvals earlier than the deadline. We will respond promptly to any request for related information you may have in connection with this request. Please let us know how we can work with you to expedite the approval process. We look forward to working with you on this important project, which will improve wireless telecommunication services in your community using collocation on existing infrastructure. If you have any questions, please do not hesitate to contact me.

Regards,

Victoria Chhun

Victoria Chhun Permitting Specialist Crown Castle, Agent for Applicant (678) 366-1259 Victoria.Chhun@crowncastle.com



Phone: (678) 366-1259 www.crowncastle.com

Section 6409 Substantial Change Checklist Towers Outside of the Public Right of Way

The Federal Communications Commission has determined that a modification substantially changes the physical dimension of a wireless tower or base station under 47 U.S.C. § 1455(a) if it meets one of six enumerated criteria under 47 C.F.R. § 1.6100.

Criteria for Towers Outside the Public Rights of Way

YES/NO Does the modification increase the height of the tower by more than the greater of:	
NO	(a) 10%
110	(b) or, the height of an additional antenna array plus separation of up to 20 feet from the top of
	the nearest existing antenna?
YES/NO	Does the modification add an appurtenance to the body of the tower that would protrude from the
NO	edge of the tower more than 20 feet or more than the width of the tower structure at the level of the
110	appurtenance, whichever is greater?
YES/NO	Does the modification involve the installation of more than the standard number of new equipment
NO	cabinets for the technology involved or add more than four new equipment cabinets?
YES/NO	Does the modification entail any excavation or deployment outside the current site by more than 30
NO	feet in any direction, not including any access or utility easements?
YES/NO	Does the modification defeat the concealment elements of the eligible support structure?
NO	
YES/NO	Does the modification violate conditions associated with the siting approval with the prior approval the
NO	tower or base station other than as specified in 47 C.F.R. § 1.6100(c)(7)(i) – (iv)?

If all questions in the above section are answered "NO," then the modification does <u>not</u> constitute a substantial change to the existing tower under 47 C.F.R. § 1.6100.

California AB 2421 Streamlined Permitting of Generators

YES/NO	Is the proposed generator rated above 50 horsepower?
NO	
YES/NO	Does the proposed generator have a double-wall storage tank that exceeds 300 gallons?
NO	
YES/NO	Is the proposed generator located more than 100 feet from the physical structure of the macro cell tower
NO	or base station?
YES/NO	Are the physical dimensions of the emergency standby generator and storage tank cumulatively larger
NO	than 250 cubic feet in volume?

If all questions in the above section are answered "NO", then the generator project is entitled to streamlined permitting under CA AB 2421.



PLANNING & BUILDING SERVICES

CASE NO:	
DATE FILED:	
FEE:	
RECEIPT NO:	
RECEIVED BY:	
	Office Use Only

APPLICATION FORM

APPLICANT:							
{Name:} Victoria Chhun O	N BEHALF OF	T-Mobile We	st Phone: 678-366-	1259			
Mailing Address: 8020 Ka							
Houston	State/Zip:	(/77024	Email: VICTORIA.CHHUN@CROWNCASTLE.COM				
PROPERTY OWNER:							
Name: CROWN CASTLI	E USA INC		Phone: 678-366-7	1259			
Mailing Address: POST C	OFFICE BOX	(203112					
City: HOUSTON	State/Zip:	77216	Email:				
AGENT:							
Name:			Phone:				
Mailing Address:							
City:	State/Zip:		Email:				
City:	MBER/S: 056-3	310-18-00					
TYPE OF APPLICATION:							
■ Administrative Permit		– Minor– Major– Parcel– Re-Subdivisionof Conditions	 Use Permit − Cottage Use Permit − Minor Use Permit − Major Use Permit − Modification Variance Other 				

I certify that the information submitted with this application is true and accurate.

Signature of Applicant/Agent

Form Ver. 071421

Date

03/01/2024

Signature of Owner

03/01/2024

SITE AND PROJECT DESCRIPTION QUESTIONNAIRE

The purpose of this questionnaire is to relate information concerning your application to the Department of Planning and Building Services and other agencies who will be reviewing your project proposal. Please remember that the clearer picture that you give us of your project and the site, the easier it will be to promptly process your application. Please answer all questions. Those questions which do not pertain to your project please indicate "Not applicable" or "N/A".

THE PROJECT

OWER SCOPE OF WORK:	· INSTALL (1) MIC	CROWAVE · INSTA	ALL (1) MW CA	BLE: (1) 1/4" FI	BER CAE	
	, ,		,	, ,		
	<u> </u>		T			
Structures/Lot Coverage	NO. O	F UNITS	5	QUARE FOOTAGE		
Structures/Lot Coverage	NO. O	F UNITS PROPOSED	EXISTING	SQUARE FOOTAGE PROPOSED	TOTAL	
		T			TOTAI	
Single Family		T			TOTAI	
Single Family Mobile Home		T			TOTAL	
Single Family Mobile Home Duplex		T			TOTAI	
Single Family Mobile Home Duplex Multifamily		T			TOTAL	
Single Family Mobile Home Duplex Multifamily Other:		T			TOTAI	
Single Family Mobile Home Duplex Multifamily Other:	EXISTING	T			TOTAL	
Single Family Mobile Home Duplex Multifamily Other:	EXISTING	T			TOTAI	
Single Family Mobile Home Duplex Multifamily Other:	EXISTING	T			TOTAL	
Single Family Mobile Home Duplex Multifamily Other: Other:	EXISTING of Parcel):	PROPOSED	EXISTING	PROPOSED	TOTA	
Structures/Lot Coverage Single Family Mobile Home Duplex Multifamily Other: Other: RAND TOTAL (Equal to gross area of the project commercial, industrices the project stimated No. of Employees per shift	EXISTING of Parcel):	PROPOSED	EXISTING	PROPOSED	TOTAI	
Single Family Mobile Home Duplex Multifamily Other: Other: RAND TOTAL (Equal to gross area of the project commercial, industri	EXISTING of Parcel):	PROPOSED	EXISTING	PROPOSED	TOTAL	

4. Will the pro	ject be phased? (Work being	done over separate periods of tin	ne)
■ NO	☐ YES If yes, explain yo	ur plans for phasing:	
5. Will vegeta ■ NO	tion be removed on areas oth YES If yes, explain:	er than the building sites and roa	ds?
6. Will the pro	pject involve the use or dispos YES If yes, explain:	al of potentially hazardous mater	ials such as toxic substances, flammables, or explosives?
	off-street parking will be proving No. of covered spaces: No. of uncovered spaces: No. of standard spaces: No. of accessible spaces: Existing no. of spaces: Proposed additional spaces: Total:	Number NA NA NA NA NA NA NA NA NA N	Size
■ NO			.g., steep, moderate slope, flat, etc.)
9. For grading	or road construction, comple	te the following:	
Amount of	f cut: NA	cubic vards	
	f fill: NA		
	nt of fill slope: NA		
	nt of cut slope: NA		
_			
	f horrow or disposal site: NA	cubic yards	
LOCATION O	LOGITOW OF DISDOSALSITE: NA		

=	oject involve sand removal, mining or gravel extraction? If yes, detailed extraction, reclamation and monitoring plans
may be require	a. □ YES
11. Will the pro ■ NO	posed development convert land currently or previously used for agriculture to another use? \square YES
12. Will the dev	elopment provide public or private recreation opportunities?
■ NO	☐ YES If yes, explain how:
NA	
13. Is the propo ■ NO	sed development visible from State Route 1 or other scenic route?
14. Is the propo	sed development visible from a park, beach or other recreational area? \square YES
15. Does the de	velopment involve diking, filling, dredging or placing structures in open coastal water, wetlands, estuaries or lakes?
Diking: Filling:	□ NO □ YES □ NO □ YES
Dredging:	■ NO □ YES
Structures:	☐ Open Coastal Waters ☐ Wetlands ☐ Estuaries ☐ Lakes
If so, what is	the amount of material to be dredged/filled?:cubic yards
Location of o	lredged material disposal site?:
Has a U.S. Ar	my Corps of Engineers permit been applied for? \square NO \square YES
16. Will there b	e any exterior lighting?
■ NO	\square YES If yes, describe below and identify the location of all exterior lighting on the plot and building plans.
	be supplied to the site as follows:
Electricity:	 ■ Utility Company (service exists to parcel) □ Utility Company (requires extension of service to site): feet □ On Site Generation – Specify:
Gas:	 ☐ Utility Company/Tank ☐ On Site Generation – Specify: ■ None
Telephone:	■ NO □ YES

Company with Converse Content (and eifer a complian).
☐ Community Sewage System (specify supplier):
☐ Septic Tank ☐ Other (specify):
■ Other (specify).
19. What will be the domestic water source:
☐ Community Water System (specify supplier):
□ Well
□ Spring
Other (specify):
20. Are there any associated projects and/or adjacent properties under your ownership?
■ NO
24 List and describe any other valeted consists and other multipersonal neurity of fauthic ancient including these variety by other
21. List and describe any other related permits and other public approval required for this project, including those required by other County departments, city, regional, State and Federal agencies:
EXISTING CELL TOWER
22. Describe the location of the site in terms of readily identifiable landmarks: (e.g., mailboxes, mile posts, street intersections, etc.)
EXISTING CELL TOWER
22. And the respective at weather any the property of the send the property is favor and division, describe helps, and identify the send of
23. Are there existing structures on the property? If yes and the proposal is for a subdivision, describe below and identify the use of
each structure on the plat plan or tentative man
each structure on the plot plan or tentative map.
each structure on the plot plan or tentative map. NO YES
■ NO □ YES
■ NO
■ NO □ YES
NO YES 24. Will any existing structure be demolished or removed? If yes, describe the type of development to be demolished or removed, including the relocation site, if applicable.
NO YES 24. Will any existing structure be demolished or removed? If yes, describe the type of development to be demolished or removed, including the relocation site, if applicable.
NO YES 24. Will any existing structure be demolished or removed? If yes, describe the type of development to be demolished or removed, including the relocation site, if applicable.

25. What is th	e maximun	n height of a	II structures	?					
Existing: 6		feet							
Proposed:	65	feet							
26. What is th	e gross floo	or areas of al	l structures,	including cov	vered parki	ng and accesso	ory buildings	?	
Existing: 2		square feet	•						
Proposed:	2792	square feet							
27. What is th	e total lot a	area within p	roperty line	s?					
Total Lot A	rea: ²⁷⁹²		□ acres □ sq	uare feet					
soil stability, p be helpful:	olants and a	animals, and	any cultural	, historical or		-	_	tructures and their uses, ohs of the site that you fe	-
THERE WILL BE N	O GROUND WO	RK OR DISTURB	ANCE TO THE SC	DIL					
-			•	_		•	•	Itural, historic or scenic a the vicinity that you feel	-
30. Indicate th	ne surrounc	ling land use	es:						
			Agriculture	Commercial		Public Facility	Timberland	Other	
North:									
East:									
South:									
West:									