



COUNTY OF MENDOCINO
DEPARTMENT OF PLANNING AND BUILDING SERVICES

860 NORTH BUSH STREET · UKIAH · CALIFORNIA · 95482
120 WEST FIR STREET · FT. BRAGG · CALIFORNIA · 95437

JULIA KROG, DIRECTOR
TELEPHONE: 707-234-6650
FAX: 707-463-5709
FB PHONE: 707-964-5379
FB FAX: 707-961-2427
pbs@mendocinocounty.gov
www.mendocinocounty.org/pbs

March 25, 2024

Department of Transportation
Environmental Health - Ukiah
Building Inspection - Ukiah
Assessor

Department of Forestry/ CalFire
-Land Use
Department of Fish and Wildlife
Cloverdale Rancheria
Potter Valley Tribe

Redwood Valley Rancheria
Sherwood Valley Band of Pomo Indians
Potter Valley Community Services

CASE#: AP_2024-0013

DATE FILED: 2/13/2024

OWNER: JOEL LLAMAS

APPLICANT/AGENT: VICTORIA CHHUN

REQUEST: Administrative Permit to authorize an eligible facilities request for modifications to an existing wireless communication facility that includes the removal and replacement of three (3) antennas, one (1) microwave dish, three (3) T-arm mounts, lighting, and one (1) cabinet with two (2) cabinets. The modifications also include the installation of three (3) RRUs and various modifications to appurtenant equipment.

ENVIRONMENTAL DETERMINATION: Categorically Exempt

LOCATION: 1± mile northeast of Potter Valley, on the east side of Eel River Road (CR 240B) 0.6± miles north of its intersection with Main Street (CR 245), located at 12531 Eel River Road, Potter Valley; (APN: 175-010-10).

SUPERVISORIAL DISTRICT: 1

STAFF PLANNER: LIAM CROWLEY

RESPONSE DUE DATE: April 8, 2024

PROJECT INFORMATION CAN BE FOUND AT:

www.mendocinocounty.org

Select "Government" from the drop-down; then locate Planning and Building Services/Public Agency Referrals.

Mendocino County Planning & Building Services is soliciting your input, which will be used in staff analysis and forwarded to the appropriate public hearing. You are invited to comment on any aspect of the proposed project(s). Please convey any requirements or conditions your agency requires for project compliance to the project coordinator at the above address, or submit your comments by email to pbs@mendocinocounty.org. Please note the case number and name of the project coordinator with all correspondence to this department.

We have reviewed the above application and recommend the following (please check one):

- No comment at this time.
Recommend conditional approval (attached).
Applicant to submit additional information (attach items needed, or contact the applicant directly, copying Planning and Building Services in any correspondence you may have with the applicant)
Recommend denial (Attach reasons for recommending denial).
Recommend preparation of an Environmental Impact Report (attach reasons why an EIR should be required).
Other comments (attach as necessary).

REVIEWED BY:

Signature Department Date

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**APPLICANT/
AGENT:** VICTORIA CHHUN

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LOCATION: 1± mile northeast of Potter Valley, on the east side of Eel River Road (CR 240B) 0.6± miles north of its intersection with Main Street (CR 245), located at 12531 Eel River Road, Potter Valley; (APN: 175-010-10).

APN/S: 175-010-10

PARCEL SIZE: 40± Acres

GENERAL PLAN: Rangeland (RL:160)

ZONING: Rangeland (R-L)

EXISTING USES: Wireless Communication Facility, Agriculture

DISTRICT: 1 (McGourty)

RELATED CASES: See below.

	<u>ADJACENT GENERAL PLAN</u>	<u>ADJACENT ZONING</u>	<u>ADJACENT LOT SIZES</u>	<u>ADJACENT USES</u>
NORTH:	Rangeland (RL:160)	Rangeland (R-L)	40± Acres	Agricultural
EAST:	Rangeland (RL:160)	Rangeland (R-L)	80± Acres	Agricultural
SOUTH:	Agricultural (AG:40)	Agricultural (A-G)	43± Acres	Agricultural
WEST:	Rangeland (RL:160)	Rangeland (R-L)	7± Acres	Agricultural

REFERRAL AGENCIES

LOCAL

- Air Quality Management District
- Assessor's Office
- Building Division (Ukiah)
- Department of Transportation (DOT)
- Environmental Health (EH)

- Potter Valley Community Services District

STATE

- CALFIRE (Land Use)
- California Dept. of Fish & Wildlife

TRIBAL

- Cloverdale Rancheria
 - Potter Valley Tribe
 - Redwood Valley Rancheria
 - Sherwood Valley Band of Pomo Indians
-

ADDITIONAL INFORMATION: Related applications include the following:

- **AP_2022-0030:** Administrative Permit to replace an existing microwave unit along with two ODUs and various ancillary equipment to an existing sixty-five foot tall monopole. All work completed within the existing 2,304 square foot lease area. Approved 01/23/23.
- **AP_2020-0020:** Administrative Permit to add a 30 kW electricity generator with a 300 gallon belly tank that includes extended vents. Generator installed on a new five foot by ten foot concrete pad within the existing wireless communications lease area. Approved 09/28/2020.
- **UR_2019-0004:** Use Permit Renewal for continued operation of an existing 65 ft. tall cellular antenna tower with various antennae and ground based equipment located within a 2,455 sq. ft. lease area surrounded by fencing. No modifications are proposed with this renewal, as it serves to extend the expiration date. Approved 12/04/2019. This permit extended the expiration date of the underlying use permit to 07/16/2029.
- **AP_2017-0097:** Administrative Permit to add 6 new antennas and RRH units and one surge protector, mounted at the 46-foot centerline on an existing 65-foot tall monopole. Associated ground equipment will be located inside a 240 square-foot lease area located within the greater 2,500 square-foot lease area controlled by Crown Castle. Approved 02/05/2018.
- **AP_2016-0035:** Administrative Permit to replace remove and replace cross arms, install five (5) new antennas and reposition existing antennas to accommodate new antennas, install five (5) new RRUs, install one (1) DUS-41 with new 6601 V1 chassis with new DUS-41 in the exiting bottom of UMTS Purcell cabinet, install one (1) new surge suppressor, install two (2) new power trunks and one (1) new fiber trunk, install one (1) new DC12, install new pipe mounts for each new antenna position, relocate existing H-frame and existing RRUs mounted on H-frame, extend existing cable bridge to allocate new cable route, relocate existing GPS unit, and install one (1) new BBU with four (4) strings on an existing 65'0" monopole. Approved 02/16/2017.
- **AP_2016-0020:** Administrative Permit to add a backup generator and propane fuel tank to an existing Cell Tower facility. Approved 10/04/2016.
- **AP 34-2014:** Administrative Permit for installation of three (3) 8 foot tall antennas at the 55 foot level on an existing 65 foot tall monopole. Approved 02/06/2015.
- **AP 22-2014:** Administrative Permit to allow installation of one (1) microwave dish to an existing 65± foot tall monopole and installation of associated equipment. Approved 08/29/2014.
- **UM 16-2006/2009:** Use Permit Modification to allow for the addition of three (3) panel antennas and one (1) microwave dish to an existing 65 foot tall monopole and placement of a battery backup power system and four (4) equipment cabinets within a 2,500 square foot leased area. Approved 07/16/2009.
- **U 16-2006:** Use Permit to authorize construction and operation of a telecommunication facility to support a wireless provider (Edge Wireless), consisting of a 65-foot tall monopole, 12 panel antennas, a microwave dish, and ground-based equipment. Approved 07/19/2007.

STAFF PLANNER: LIAM CROWLEY

DATE: 3/21/2024

ENVIRONMENTAL DATA

1. MAC:

GIS

None

2. FIRE HAZARD SEVERITY ZONE:

CALFIRE FRAP maps/GIS

High

3. FIRE RESPONSIBILITY AREA:

CALFIRE FRAP maps/GIS

State Responsibility Area (SRA)

4. FARMLAND CLASSIFICATION:

GIS

Grazing Land (G)

5. FLOOD ZONE CLASSIFICATION:

FEMA Flood Insurance Rate Maps (FIRM)

None

6. COASTAL GROUNDWATER RESOURCE AREA:

Coastal Groundwater Study/GIS

N/A

7. SOIL CLASSIFICATION:

Mendocino County Soils Study Eastern/Western Part

Eastern Soil Map Unit No. 232

8. PYGMY VEGETATION OR PYGMY CAPABLE SOIL:

LCP maps, Pygmy Soils Maps; GIS

N/A

9. WILLIAMSON ACT CONTRACT:

GIS/Mendocino County Assessor's Office

Yes

10. TIMBER PRODUCTION ZONE:

GIS

No

11. WETLANDS CLASSIFICATION:

GIS

Fluvial Natural Stream 580± feet south of site

12. EARTHQUAKE FAULT ZONE:

Earthquake Fault Zone Maps; GIS

No

13. AIRPORT LAND USE PLANNING AREA:

Airport Land Use Plan; GIS

None

14. SUPERFUND/BROWNFIELD/HAZMAT SITE:

GIS; General Plan 3-11

No

15. NATURAL DIVERSITY DATABASE:

CA Dept. of Fish & Wildlife Rarefind Database/GIS

None

16. STATE FOREST/PARK/RECREATION AREA ADJACENT:

GIS; General Plan 3-10

No

17. LANDSLIDE HAZARD:

Hazards and Landslides Map; GIS; Policy RM-61; General Plan 4-44

No

18. WATER EFFICIENT LANDSCAPE REQUIRED:

Policy RM-7; General Plan 4-34

No

19. WILD AND SCENIC RIVER:

www.rivers.gov (Eel Only); GIS

No

20. SPECIFIC PLAN/SPECIAL PLAN AREA:

Various Adopted Specific Plan Areas; GIS

No

21. STATE CLEARINGHOUSE REQUIRED:

Policy

No

22. OAK WOODLAND AREA:

USDA

No

23. HARBOR DISTRICT:

Sec. 20.512

No



**Planning and Building
Services**

Case No:	
CalFire No:	
Date Filed:	
Fee:	
Receipt No:	
Received By:	
<i>Office use only</i>	

APPLICATION FORM

APPLICANT

Name: Victoria Chhun Phone: 678-366-1259

Mailing Address: 8020 Katy Fwy

City: Houston State/Zip: TX/77024 email: Victoria.Chhun@crowncastle.com

PROPERTY OWNER

Name: GLOBAL SIGNAL ACQUISITIONS IV LLC Phone: 678-366-1259

Mailing Address: PO BOX 277455, ATLANTA, GA 30384-7455

City: Atlanta State/Zip: GA 30384 email: _____

AGENT

Name: Victoria Chhun Phone: 678-366-1259

Mailing Address: 8020 Katy Fwy Houston, TX 77024

City: _____ State/Zip: _____ email: _____

Parcel Size: 2304 SQ FT (Sq. feet/Acres) Address of Property: 12531 EEL RIVER ROAD, POTTER VALLEY, CA 95469

Assessor Parcel Number(s): 175-010-10-00

TYPE OF APPLICATION:

- | | | |
|--|--|---|
| <input type="checkbox"/> Administrative Permit | <input type="checkbox"/> Flood Hazard | <input type="checkbox"/> Rezoning |
| <input type="checkbox"/> Agricultural Preserve | <input type="checkbox"/> General Plan Amendment | <input type="checkbox"/> Use Permit-Cottage |
| <input type="checkbox"/> Airport Land Use | <input type="checkbox"/> Land Division-Minor | <input type="checkbox"/> Use Permit-Minor |
| <input type="checkbox"/> CDP- Admin | <input type="checkbox"/> Land Division- Major | <input type="checkbox"/> Use Permit-Major |
| <input type="checkbox"/> CDP- Standard | <input type="checkbox"/> Land Division-Parcel | <input type="checkbox"/> Variance |
| <input type="checkbox"/> Certificate of Compliance | <input type="checkbox"/> Land Division-Resubdivision | <input checked="" type="checkbox"/> Other |
| <input type="checkbox"/> Development Review | <input type="checkbox"/> Modification of Conditions | |
| <input type="checkbox"/> Exception | <input type="checkbox"/> Reversion to Acreage | |

I certify that the information submitted with this application is true and accurate.

02/12/2024
Date

02/12/2024
Date

SITE AND PROJECT DESCRIPTION QUESTIONNAIRE

The purpose of this questionnaire is to relate information concerning your application to the Department of Planning and Building Services and other agencies who will be reviewing your project proposal. Please remember that the clearer picture that you give us of your project and the site, the easier it will be to promptly process your application. Please answer all questions. Those questions which do not pertain to your project please indicate "Not applicable" or "N/A".

THE PROJECT

1. Describe your project. Include secondary improvements such as wells, septic systems, grading, vegetation removal, roads, etc.

TOWER SCOPE OF WORK:

- ~~· REMOVE (3) ANTENNA'S~~
- ~~· REMOVE (6) TMA'S~~
- ~~· REMOVE (1) 4' MICROWAVE DISH~~
- ~~· REMOVE (6) 7/8" COAX CABLES~~
- ~~· REMOVE (3) T-ARM MOUNTS~~
- ~~· INSTALL (3) DOUBLE T-ARM ANTENNA MOUNTS~~
- ~~· INSTALL (3) ANTENNA'S~~
- ~~· INSTALL (3) RRU'S~~
- ~~· INSTALL (1) 2' MICROWAVE DISH~~
- ~~· INSTALL (2) 1-5/8" HCS 6X24 4AWG CABLES~~

GROUND SCOPE OF WORK:

- ~~· RELOCATE (2) BB 6630 & (1) DUG20 FROM (E) RBS 6102 TO NEW RBS 6160 CABINET~~
- ~~· REMOVE (1) RBS 6102 CABINET~~
- ~~· REMOVE (6) GENERIC AWS/PCS DIPLEXERS~~
- ~~· INSTALL (1) RBS 6160 CABINET W/ (1) RP 6651, (1) CSR IXRE V2 ROUTER & (1) RBS 6601~~
- ~~· INSTALL (1) B160 BATTERY CABINET~~
- ~~· INSTALL (1) HOFFMAN HCS CABLE WINDER/SLACK CAN ON (E) ICE BRIDGE POST UNISTRUT~~
- ~~· REPLACE (E) TECH LIGHTS W/ (N) LED TECH LIGHT~~

2. Structures/Lot Coverage	Number of Units		Square Footage		
	Existing	Proposed	Existing	Proposed	Total
<input type="checkbox"/> Single Family <input type="checkbox"/> Mobile Home <input type="checkbox"/> Duplex <input type="checkbox"/> Multifamily <input checked="" type="checkbox"/> Other: existing cell tower <input type="checkbox"/> Other: _____	existing cell tower				
Total Structures Paved Area Landscaped Area Unimproved Area					
GRAND TOTAL (Equal to gross area of Parcel)					

3. If the project is commercial, industrial or institutional, complete the following:
 existing cell tower, **COMMERCIAL**
 Estimated employees per shift: _____
 Estimated shifts per day: _____
 Type of loading facilities proposed: _____

4. Will the proposed project be phased? Yes No If yes, explain your plans for phasing:

5. Will vegetation be removed on areas other than the building sites and roads? Yes No Explain:

6. Will the project involve the use or disposal of potentially hazardous materials such as toxic substances, flammables, or explosives? Yes No If yes, explain:

7. How much off-street parking will be provided? NA

	Number	Size
Number of covered spaces	_____	_____
Number of uncovered spaces	_____	_____
Number of standard spaces	_____	_____
Number of handicapped spaces	_____	_____
Existing Number of Spaces	_____	
Proposed Additional Spaces	_____	
Total	_____	

8. Is any road construction or grading planned? Yes No If yes, grading and drainage plans may be required. Also, describe the terrain to be traversed (e.g., steep, moderate slope, flat, etc.).
 NA

9. For grading or road construction, complete the following:
- A. Amount of cut _____ cubic yards
 - B. Amount of fill _____ cubic yards
 - C. Maximum height of fill slope _____ feet
 - D. Maximum height of cut slope _____ feet
 - E. Amount of import or export _____ cubic yards
 - F. Location of borrow or disposal site _____

10. Does the project involve sand removal, mining or gravel extraction? Yes No
If yes, detailed extraction, reclamation and monitoring plans may be required?
11. Will the proposed development convert land currently or previously used for agriculture to another use?
 Yes No
If yes, how many acres will be converted? _____ acres. An agricultural economic feasibility study may be required.
12. Will the development provide public or private recreational opportunities? Yes No
If yes, explain below:

13. Is the proposed development visible from State Highway 1 or other scenic route?
 Yes No

14. Is the proposed development visible from a park, beach or other recreational area?
 Yes No

15. Does the development involve diking, filling, dredging or placing structures in open coastal water, wetlands, estuaries or lakes?

Diking : Yes No
Filling: Yes No
Dredging: Yes No

Placement of structures in:
 open coastal waters
 wetlands
 estuaries
 lakes

If so, amount of material to be dredged or filled? _____ cubic yards.
Location of dredged material disposal site? _____

Has a U.S. Army Corps of Engineers permit been applied for? Yes No

16. Will there be any exterior lighting? Yes No If yes, describe below and identify the location of all exterior lighting on the plot plan and building plans.
REPLACE (E) TECH LIGHTS W/ (N) LED TECH LIGHT

17. Utilities will be supplied to the site as follows:
A. Electricity:
 Utility Company (service exists to the parcel)
 Utility Company (requires extension of service to site: _____ feet _____ miles)
 On Site Generation - Specify: _____
B. Gas:
 Utility Company/Tank
 On Site Generation - Specify: _____
 None
C. Telephone: Yes No

18. What will be the method of sewage disposal?
 Community sewage system - Specify supplier _____
 Septic Tank
 Other - Specify: _____

19. What will be the domestic water source:
 Community water system - Specify supplier _____
 Well
 Spring
 Other - Specify: _____

20. Are there any associated projects and/or adjacent properties under your ownership?
 Yes No If yes, explain (e.g., Assessor's Parcel Number, address, etc.):

21. List and describe any other related permits and other public approval required for this project, including those required by other County departments, city, regional, state and federal agencies:

22. Describe the location of the site in terms of readily identifiable landmarks (e.g., mailboxes, mile posts, street intersections, etc.):

23. Are there existing structures on the property? Yes No
If yes, describe below, and identify the use of each structure on the plot plan or tentative map if the proposal is for a subdivision.

24. Will any existing structures be demolished or removed? Yes No
If yes, describe the type of development to be demolished or removed, including the relocation site, if applicable.

25. Project Height. Maximum height of existing structures _____ feet. Maximum height of proposed structures _____ feet.

26. Gross floor area of existing structures _____ square feet (including covered parking and accessory buildings). Gross floor area of proposed structures _____ square feet (including covered parking and accessory buildings).

27. Lot area (within property lines): _____ square feet acres.

28. Briefly describe the project site as it exists before the project, including information on existing structures and their uses, slopes, soil stability, plants and animals, and any cultural, historical or scenic aspects. Attach any photographs of the site that you feel would be helpful.

29. Briefly describe the surrounding properties, including information on plants, animals and any cultural, historic or scenic aspects. Indicate the type of land use (use chart below) and its general intensity. Attach any photographs of the vicinity that you feel would be helpful.

30. Indicate the surrounding land uses:

	North	East	South	West
Vacant	_____	_____	_____	_____
Residential Agricultural	_____	_____	_____	_____
Commercial Industrial	_____	_____	_____	_____
Institutional Timberland	_____	_____	_____	_____
Other	_____	_____	_____	_____



T-MOBILE SITE NUMBER: SF40959A
T-MOBILE SITE NAME: CROWN: AT&T NEW POTTER VALLEY
T-MOBILE PROJECT: ANCHOR

BUSINESS UNIT #: 857683
SITE ADDRESS: 12531 EEL RIVER ROAD
 POTTER VALLEY, CA 95469
COUNTY: MENDOCINO
SITE TYPE: MONOPOLE
TOWER HEIGHT: 65'-0"



1200 CONCORD AVE., SUITE 500
 CONCORD, CA 94520



1 PARK PLACE, SUITE 300
 DUBLIN, CA 94568



P. MARSHALL & ASSOCIATES
 6801 PORTWEST DR. STE 100,
 HOUSTON, TX 77024
 OFFICE 713-677-0964

T-MOBILE SITE NUMBER:
 SF40959A

BU #: 857683

**CROWN: AT&T NEW
 POTTER VALLEY**

**12531 EEL RIVER ROAD
 POTTER VALLEY, CA 95469**

EXISTING 65'-0" MONOPOLE

ISSUED FOR:

REV	DATE	DRWN	DESCRIPTION	DES./QA
A	12/20/23	AW	PRELIMINARY	HS
0	01/31/24	SM	FINAL CD	HS

SITE INFORMATION


CROWN CASTLE USA INC. CA371 - POTTER VALLEY
SITE NAME:
SITE ADDRESS: 12531 EEL RIVER ROAD
 POTTER VALLEY, CA 95469
COUNTY: MENDOCINO
MAP/PARCEL #: 17501010
AREA OF CONSTRUCTION: EXISTING
LATITUDE: 39.331355
LONGITUDE: -123.09814
LAT/LONG TYPE: NAD83
GROUND ELEVATION: 1080.0'
CURRENT ZONING: RL
JURISDICTION: COUNTY OF MENDOCINO
OCCUPANCY CLASSIFICATION: U
TYPE OF CONSTRUCTION: IIB
A.D.A. COMPLIANCE: FACILITY IS UNMANNED AND NOT FOR
 HUMAN HABITATION
PROPERTY OWNER: LLAMAS JOEL
 300 GOLD GULCH RD
 UKIAH, CA 95482
TOWER OWNER: CROWN CASTLE USA, INC.
 1 PARK PLACE, SUITE 300
 DUBLIN, CA 94568
CARRIER/APPLICANT: T-MOBILE
 1200 CONCORD AVE., SUITE 500
 CONCORD, CA 94520
ELECTRIC PROVIDER: PACIFIC GAS & ELECTRIC
 (800) 743-5000
TELCO PROVIDER: AT&T
 (844) 288-2020

DRAWING INDEX

SHEET #	SHEET DESCRIPTION
T-1	TITLE SHEET
T-2	GENERAL NOTES
C-1	OVERALL SITE PLAN
C-1.1	ENLARGED SITE PLAN
C-1.2	EXISTING & FINAL EQUIPMENT PLANS
C-2 - C-2.1	TOWER ELEVATIONS
C-3	ANTENNA PLANS
C-4	EXISTING EQUIPMENT SCHEDULE
C-4.1	FINAL EQUIPMENT SCHEDULE
C-5	ANTENNA, RRU SPECS & MOUNTING DETAILS
C-6	COMMSCOPE VHLPX2-11W/B MICROWAVE SPECS
C-7	ERICSSON RBS 6160 & B160 CABINET SPECS
C-8	CABINET ANCHOR DETAIL & BATTERY SPECS
C-9	EQUIPMENT, LED LIGHT & HCS CABLE SPECS
C-10	HCS CABLE WINDER/SLACK CAN SPECS
C-11 - C-11.1	SITE PRO 1 ANTENNA MOUNT SPECIFICATIONS
E-1	PANEL SCHEDULE & ONE-LINE DIAGRAM
G-1	EQUIPMENT GROUNDING PLAN
G-2	ANTENNA GROUNDING SCHEMATIC
G-3 - G-4	GROUNDING DETAILS

ALL DRAWINGS CONTAINED HEREIN ARE FORMATTED FOR 22X34. CONTRACTOR SHALL VERIFY ALL PLANS AND EXISTING DIMENSIONS AND CONDITIONS ON THE JOB SITE AND SHALL IMMEDIATELY NOTIFY THE ENGINEER IN WRITING OF ANY DISCREPANCIES BEFORE PROCEEDING WITH THE WORK OR BE RESPONSIBLE FOR SAME.

LOCATION MAP

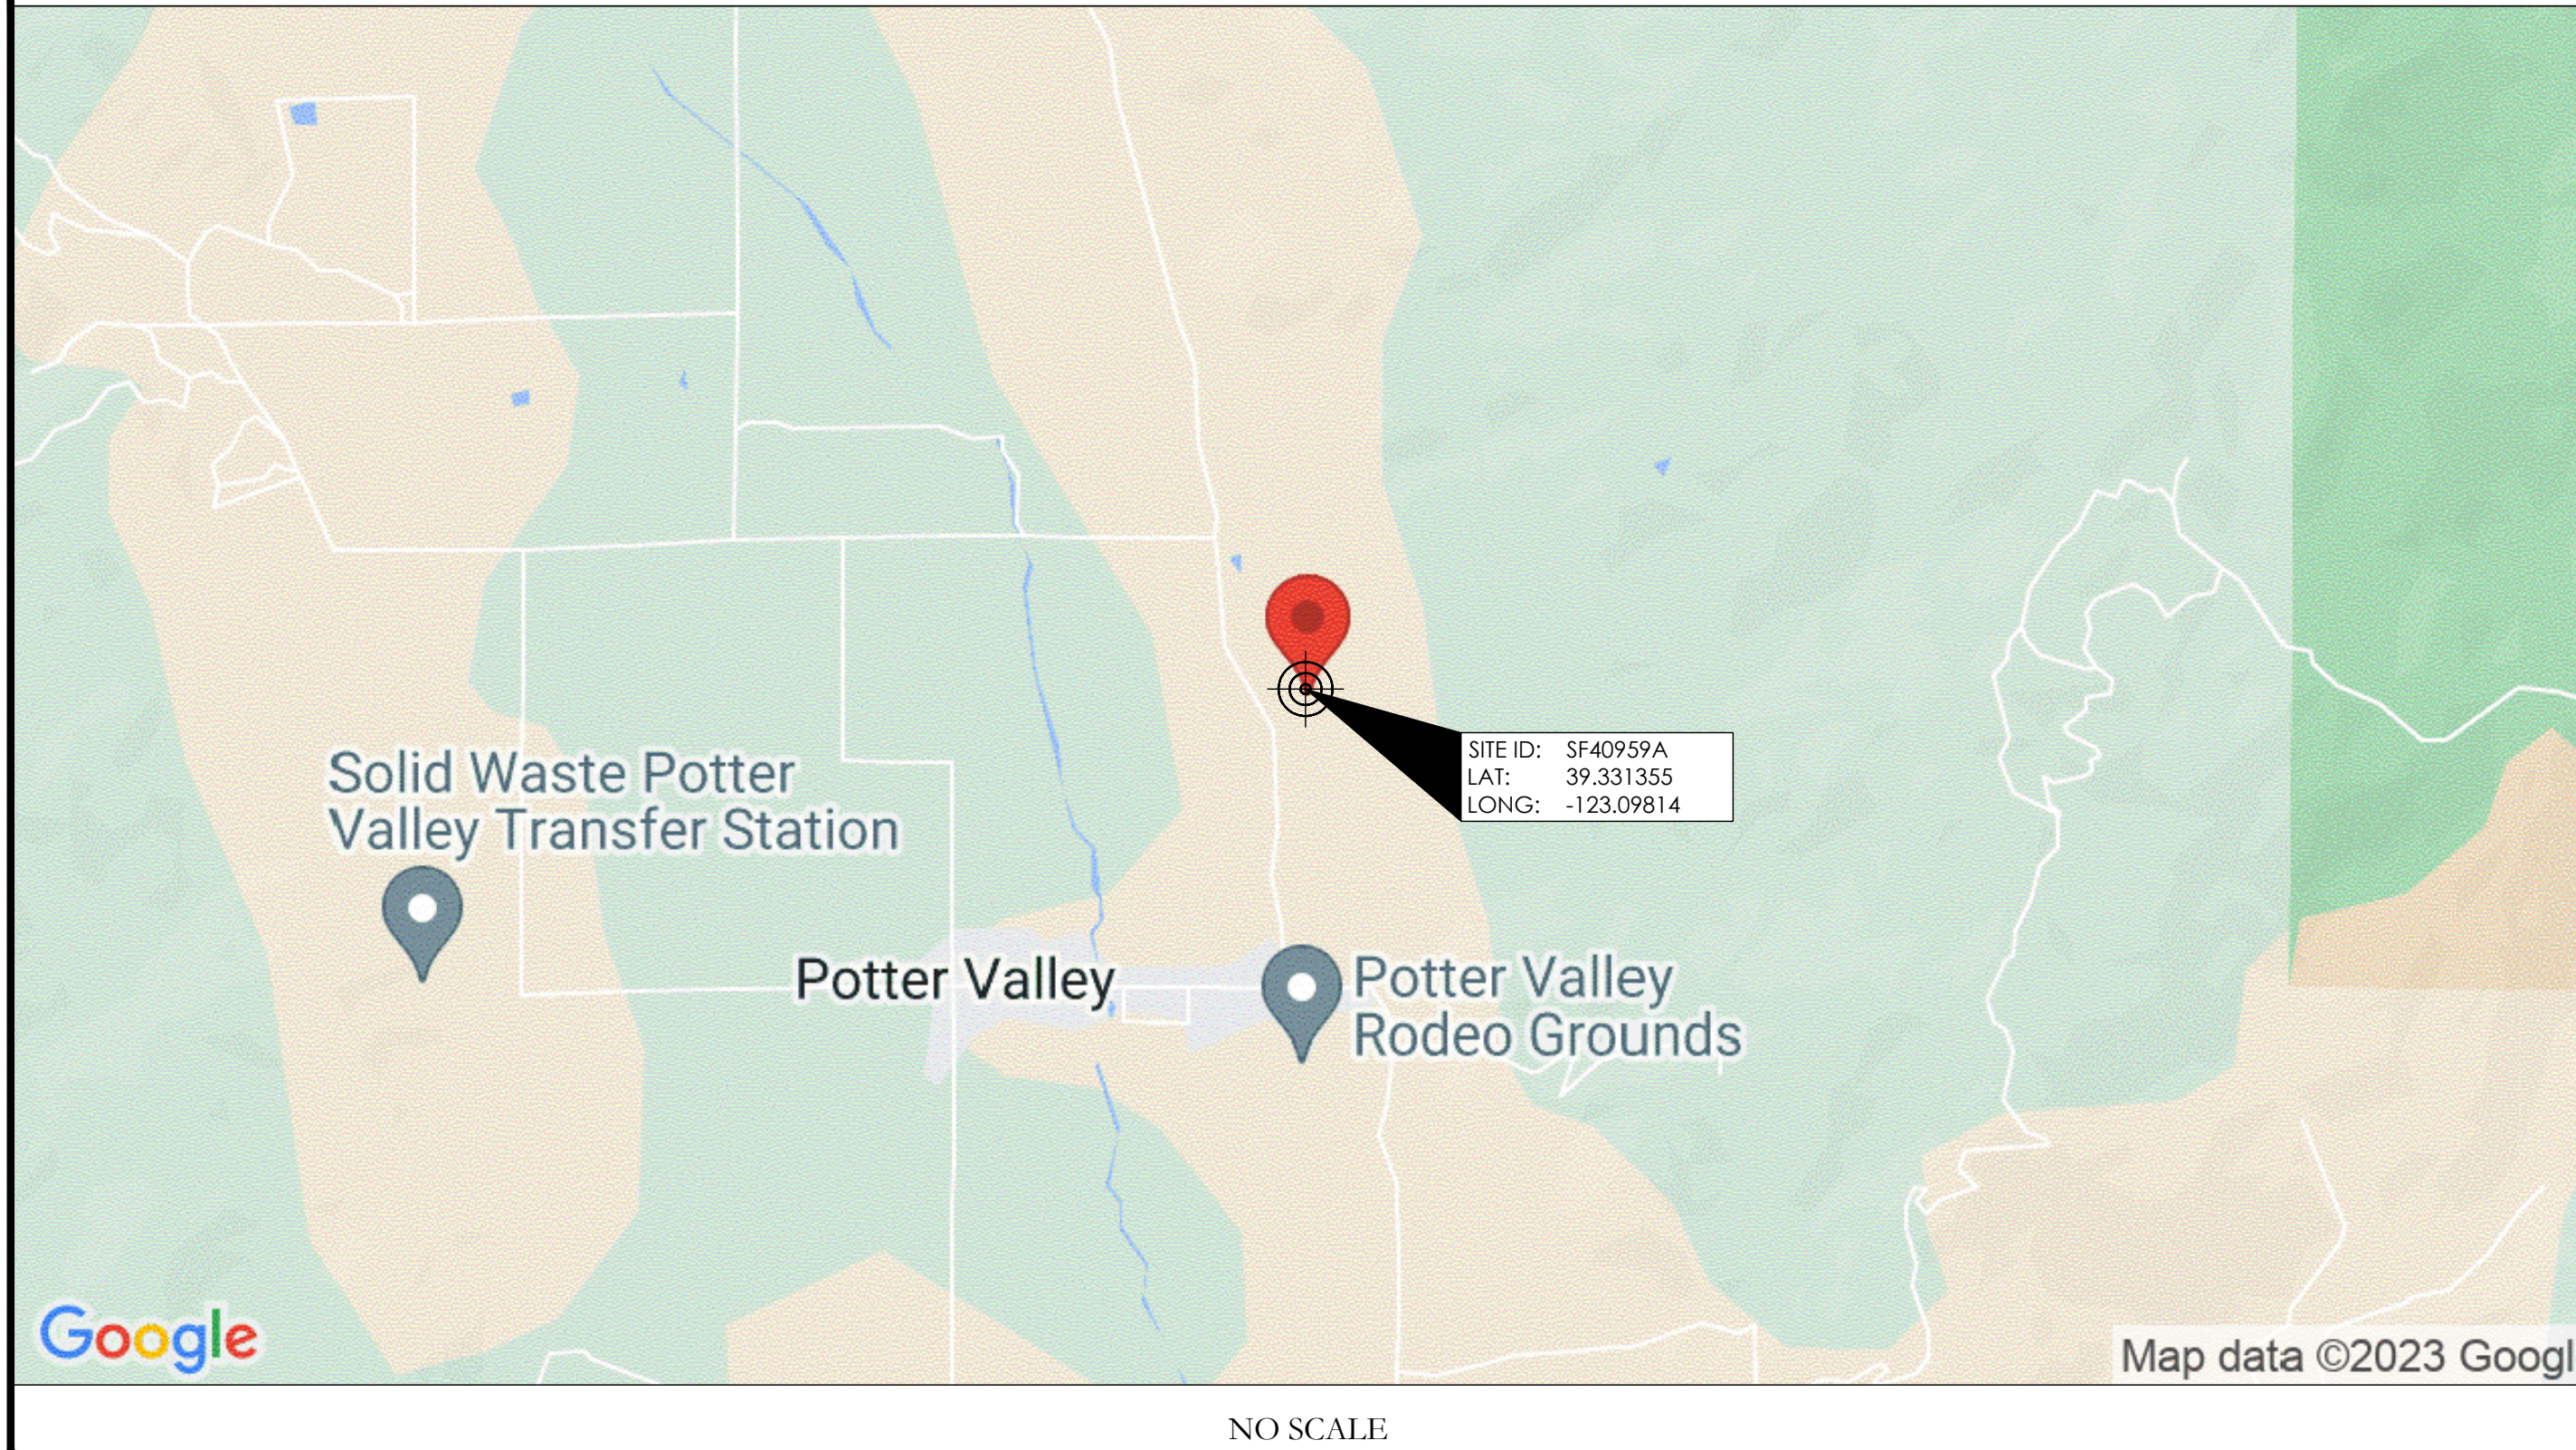

PROJECT TEAM

A&E FIRM: P. MARSHALL & ASSOCIATES, LLC
 6801 PORTWEST DR, SUITE 100
 HOUSTON, TX 77024
 (713) 677-0964
CROWN CASTLE USA INC.
DISTRICT CONTACTS: 1 PARK PLACE, SUITE 300
 DUBLIN, CA 94568

PROJECT DESCRIPTION

THE PURPOSE OF THIS PROJECT IS TO ENHANCE BROADBAND CONNECTIVITY AND CAPACITY TO THE EXISTING ELIGIBLE WIRELESS FACILITY.

TOWER SCOPE OF WORK:

- REMOVE (3) ANTENNA'S
- REMOVE (6) TMA'S
- REMOVE (1) 4' MICROWAVE DISH
- REMOVE (6) 7/8" COAX CABLES
- REMOVE (3) T-ARM MOUNTS
- INSTALL (3) DOUBLE T-ARM ANTENNA MOUNTS
- INSTALL (3) ANTENNA'S
- INSTALL (3) RRUS
- INSTALL (1) 2' MICROWAVE DISH
- INSTALL (2) 1-5/8" HCS 6X24 4AWG CABLES

GROUND SCOPE OF WORK:

- RELOCATE (2) BB 6630 & (1) DUG20 FROM (E) RBS 6102 TO NEW RBS 6160 CABINET
- REMOVE (1) RBS 6102 CABINET
- REMOVE (6) GENERIC AWS/PCS DIPLEXERS
- INSTALL (1) RBS 6160 CABINET W/ (1) RP 6651, (1) CSR IXRE V2 ROUTER & (1) RBS 6601
- INSTALL (1) B160 BATTERY CABINET
- INSTALL (1) HOFFMAN HCS CABLE WINDER/SLACK CAN ON (E) ICE BRIDGE POST UNISTRUT
- REPLACE (E) TECH LIGHTS W/ (N) LED TECH LIGHT

APPLICABLE CODES/REFERENCE DOCUMENTS

ALL WORK SHALL BE PERFORMED AND MATERIALS INSTALLED IN ACCORDANCE WITH THE CURRENT EDITIONS OF THE FOLLOWING CODES AS ADOPTED BY THE LOCAL GOVERNING AUTHORITIES. NOTHING IN THESE PLANS IS TO BE CONSTRUED TO PERMIT WORK NOT CONFORMING TO THESE CODES:

CODE TYPE	CODE
BUILDING	2022 CALIFORNIA BUILDING CODE (CBC)/2021 IBC
MECHANICAL	2022 CALIFORNIA MECHANICAL CODE (CMC)/2021 UMC
ELECTRICAL	2022 CALIFORNIA ELECTRICAL CODE (CEC)/2020 NEC
FIRE	2022 CALIFORNIA FIRE CODE (CFE)/2021 IFC

REFERENCE DOCUMENTS:

STRUCTURAL ANALYSIS: MORRISON HERSHFELD
 DATED: 12/14/23
 MOUNT ANALYSIS: TRYLON
 DATED: 12/06/2023
 RFDS REVISION: 6
 DATED: 01/18/24
 ORDER ID: 657872
 REVISION: 1

SITE ACCESS:
 PRIOR TO ACCESSING/ENTERING THE SITE YOU MUST CONTACT THE CROWN NOC AT (800) 788-7011 & CROWN CONSTRUCTION MANAGER.

ELECTRICAL NOTES:
 POWER DESIGN FOR ANY AC ELECTRICAL POWER CHANGE IS TO BE PERFORMED BY OTHERS AND IS SHOWN REFERENCE PURPOSES ONLY. T-MOBILE IS SOLELY RESPONSIBLE FOR THE ELECTRICAL POWER DESIGN.




IT IS A VIOLATION OF LAW FOR ANY PERSON, UNLESS THEY ARE ACTING UNDER THE DIRECTION OF A LICENSED PROFESSIONAL ENGINEER, TO ALTER THIS DOCUMENT.

PROJECT NUMBER:
23CCTCAM-127

SHEET NUMBER: T-1
REVISION: 0




CALL CALIFORNIA ONE CALL
 (800) 227-2600
 CALL 3 WORKING DAYS
 BEFORE YOU DIG!

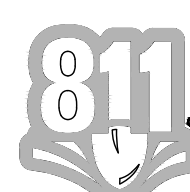


SITE PLAN DISCLAIMER:

PROPERTY LINES AND STRUCTURES HAVE BEEN DIGITIZED FROM PREVIOUS PLAN SETS. CROWN CASTLE USA INC. HAS NOT COMPLETED A SITE SURVEY AND THEREFORE MAKES NO CLAIMS AS TO THE ACCURACY OF INFORMATION DEPICTED ON THIS SHEET.

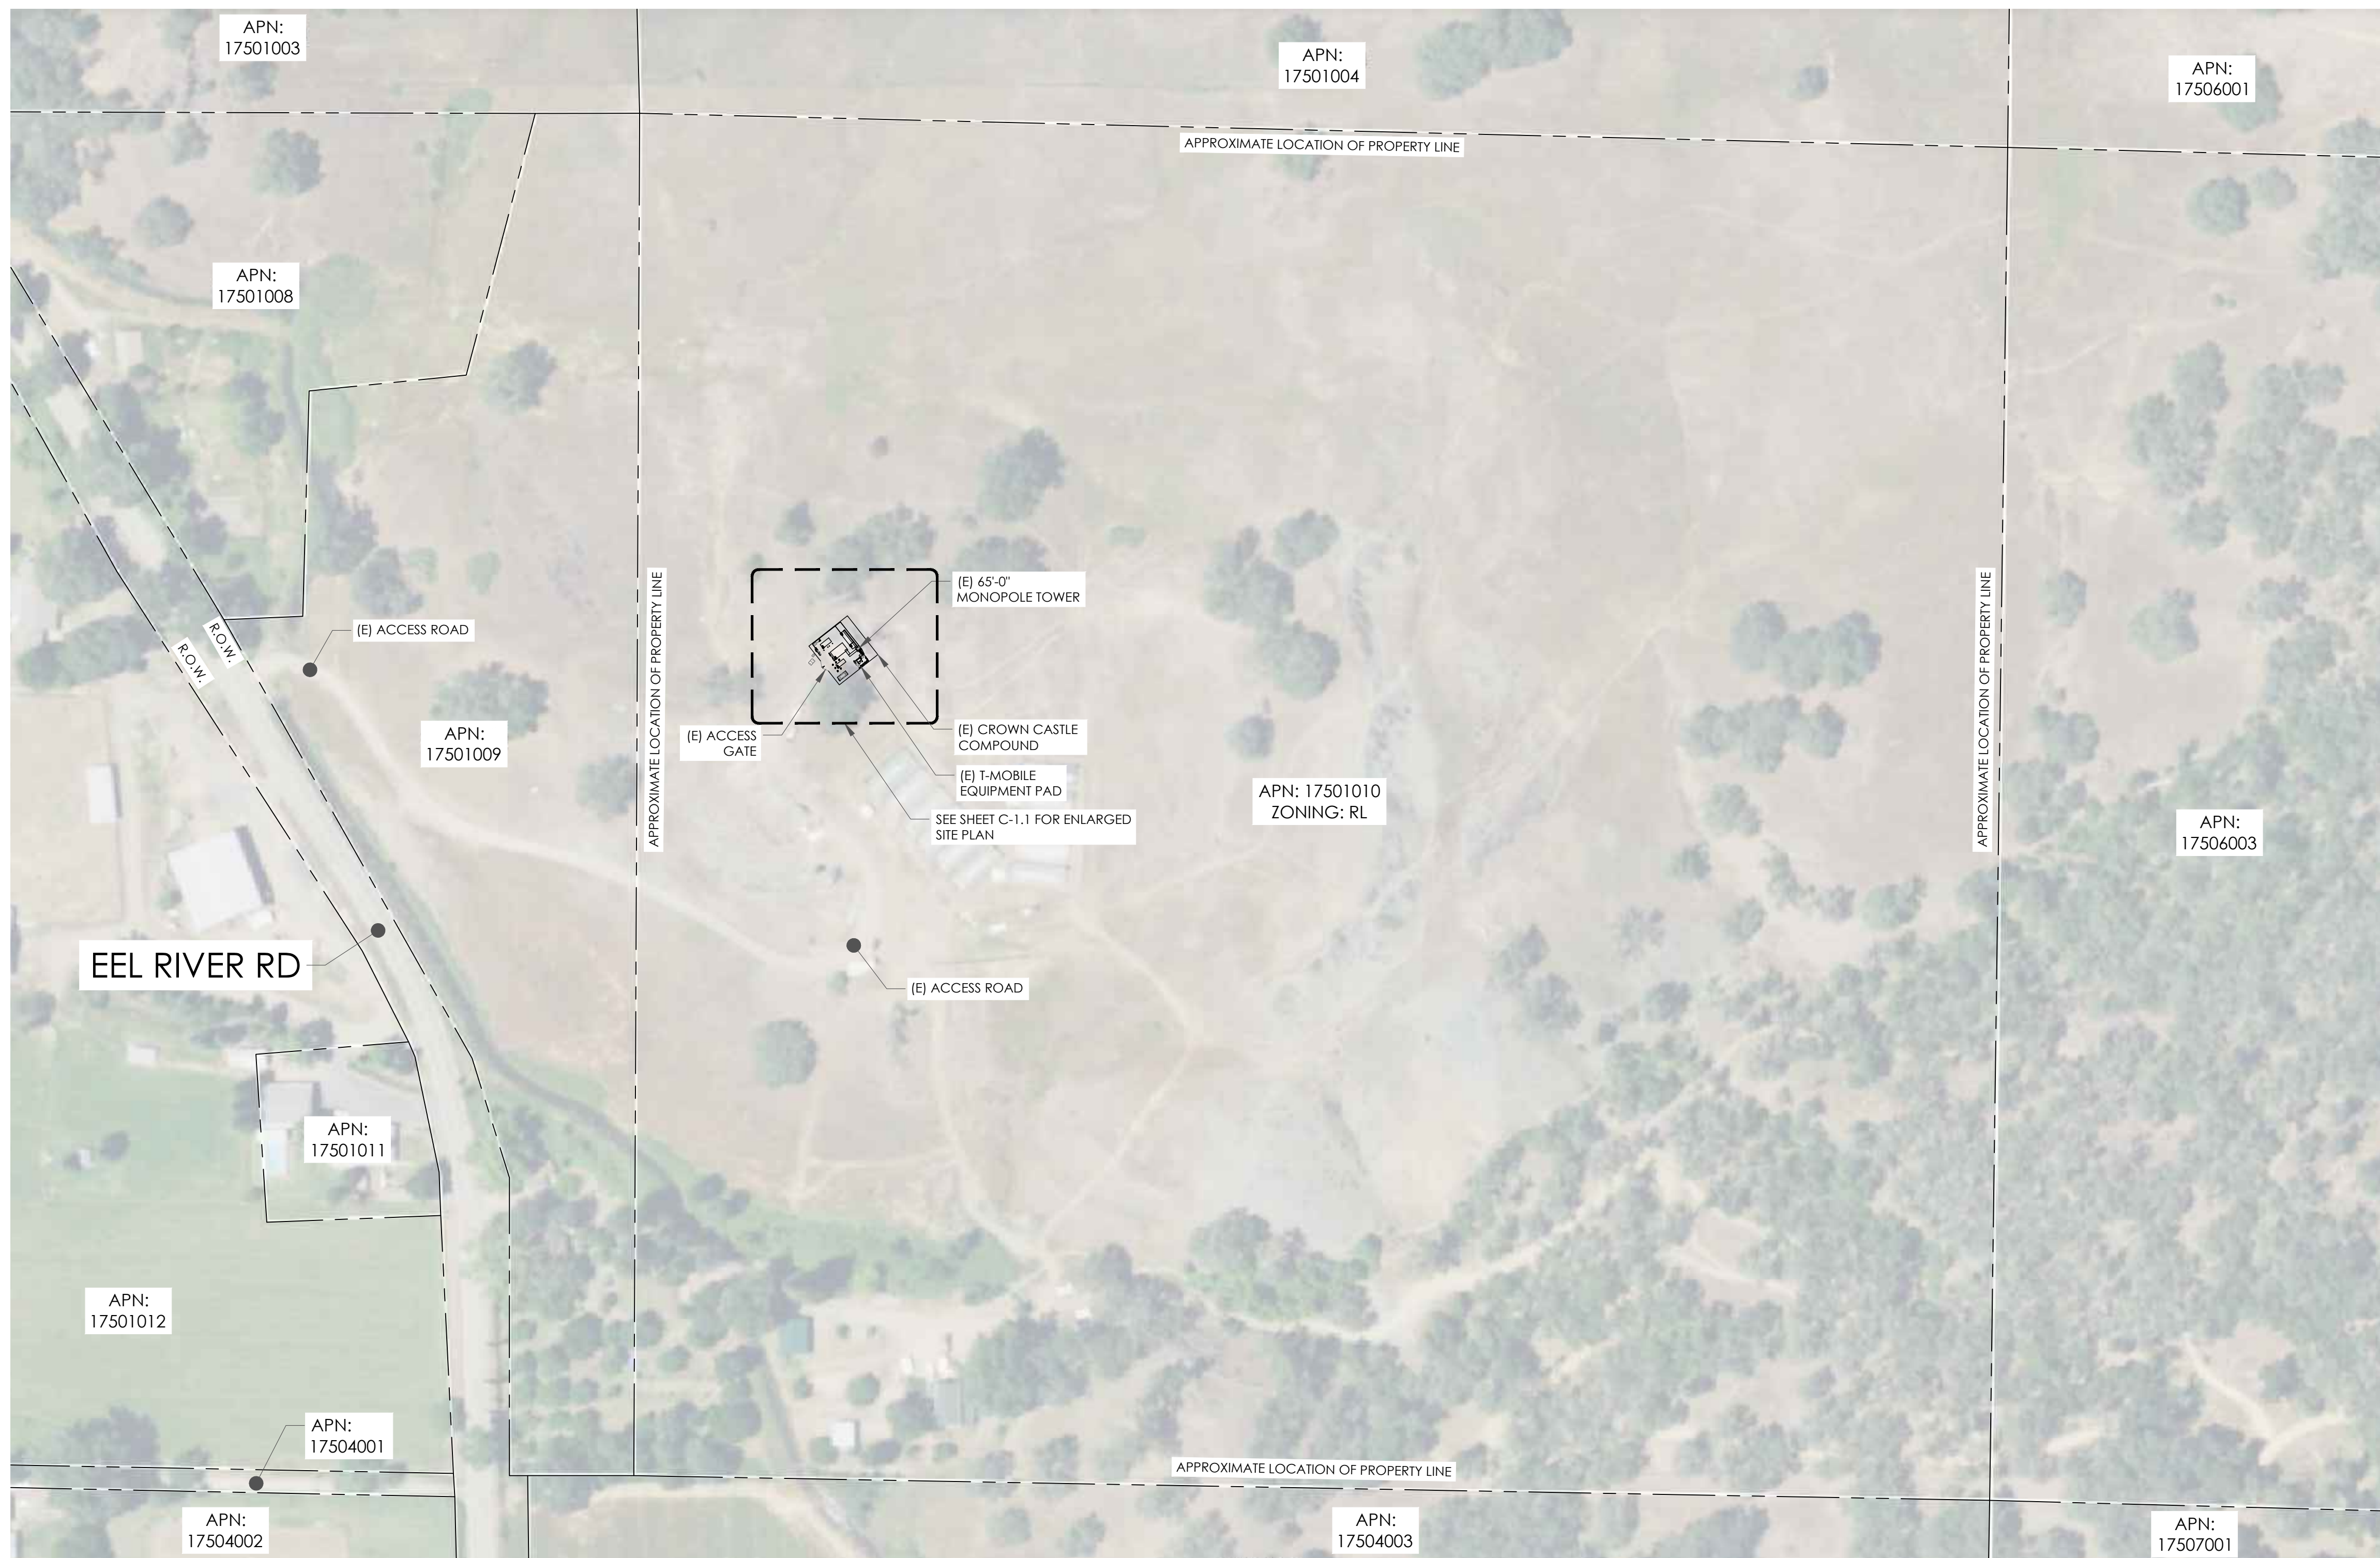

1 OVERALL SITE PLAN
 SCALE: 1" = 100'-0" (FULL SIZE)
 1" = 200'-0" (11x17)

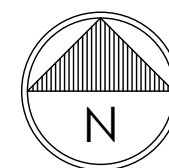

T-Mobile

1200 CONCORD AVE., SUITE 500
 CONCORD, CA 94520

CROWN CASTLE

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 DUBLIN, CA 94568

PM&A

P. MARSHALL & ASSOCIATES
 6801 PORTWEST DR. STE 100,
 HOUSTON, TX 77024
 OFFICE 713-677-0964

T-MOBILE SITE NUMBER:
 SF40959A

BU #: 857683


**CROWN: AT&T NEW
 POTTER VALLEY**

**12531 EEL RIVER ROAD
 POTTER VALLEY, CA 95469**

EXISTING 65'-0" MONOPOLE

ISSUED FOR:


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A	12/20/23	AW	PRELIMINARY	HS
0	01/31/24	SM	FINAL CD	HS

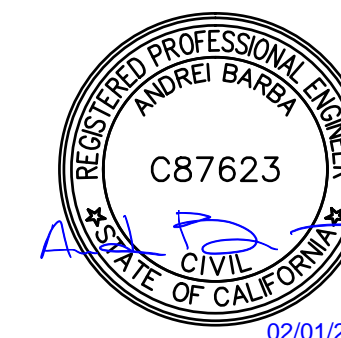


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**PROJECT NUMBER:
 23CCTCAM-127**

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1 ENLARGED SITE PLAN
 SCALE: 1"=3'-0" (FULL SIZE)
 1"=6'-0" (11x17)

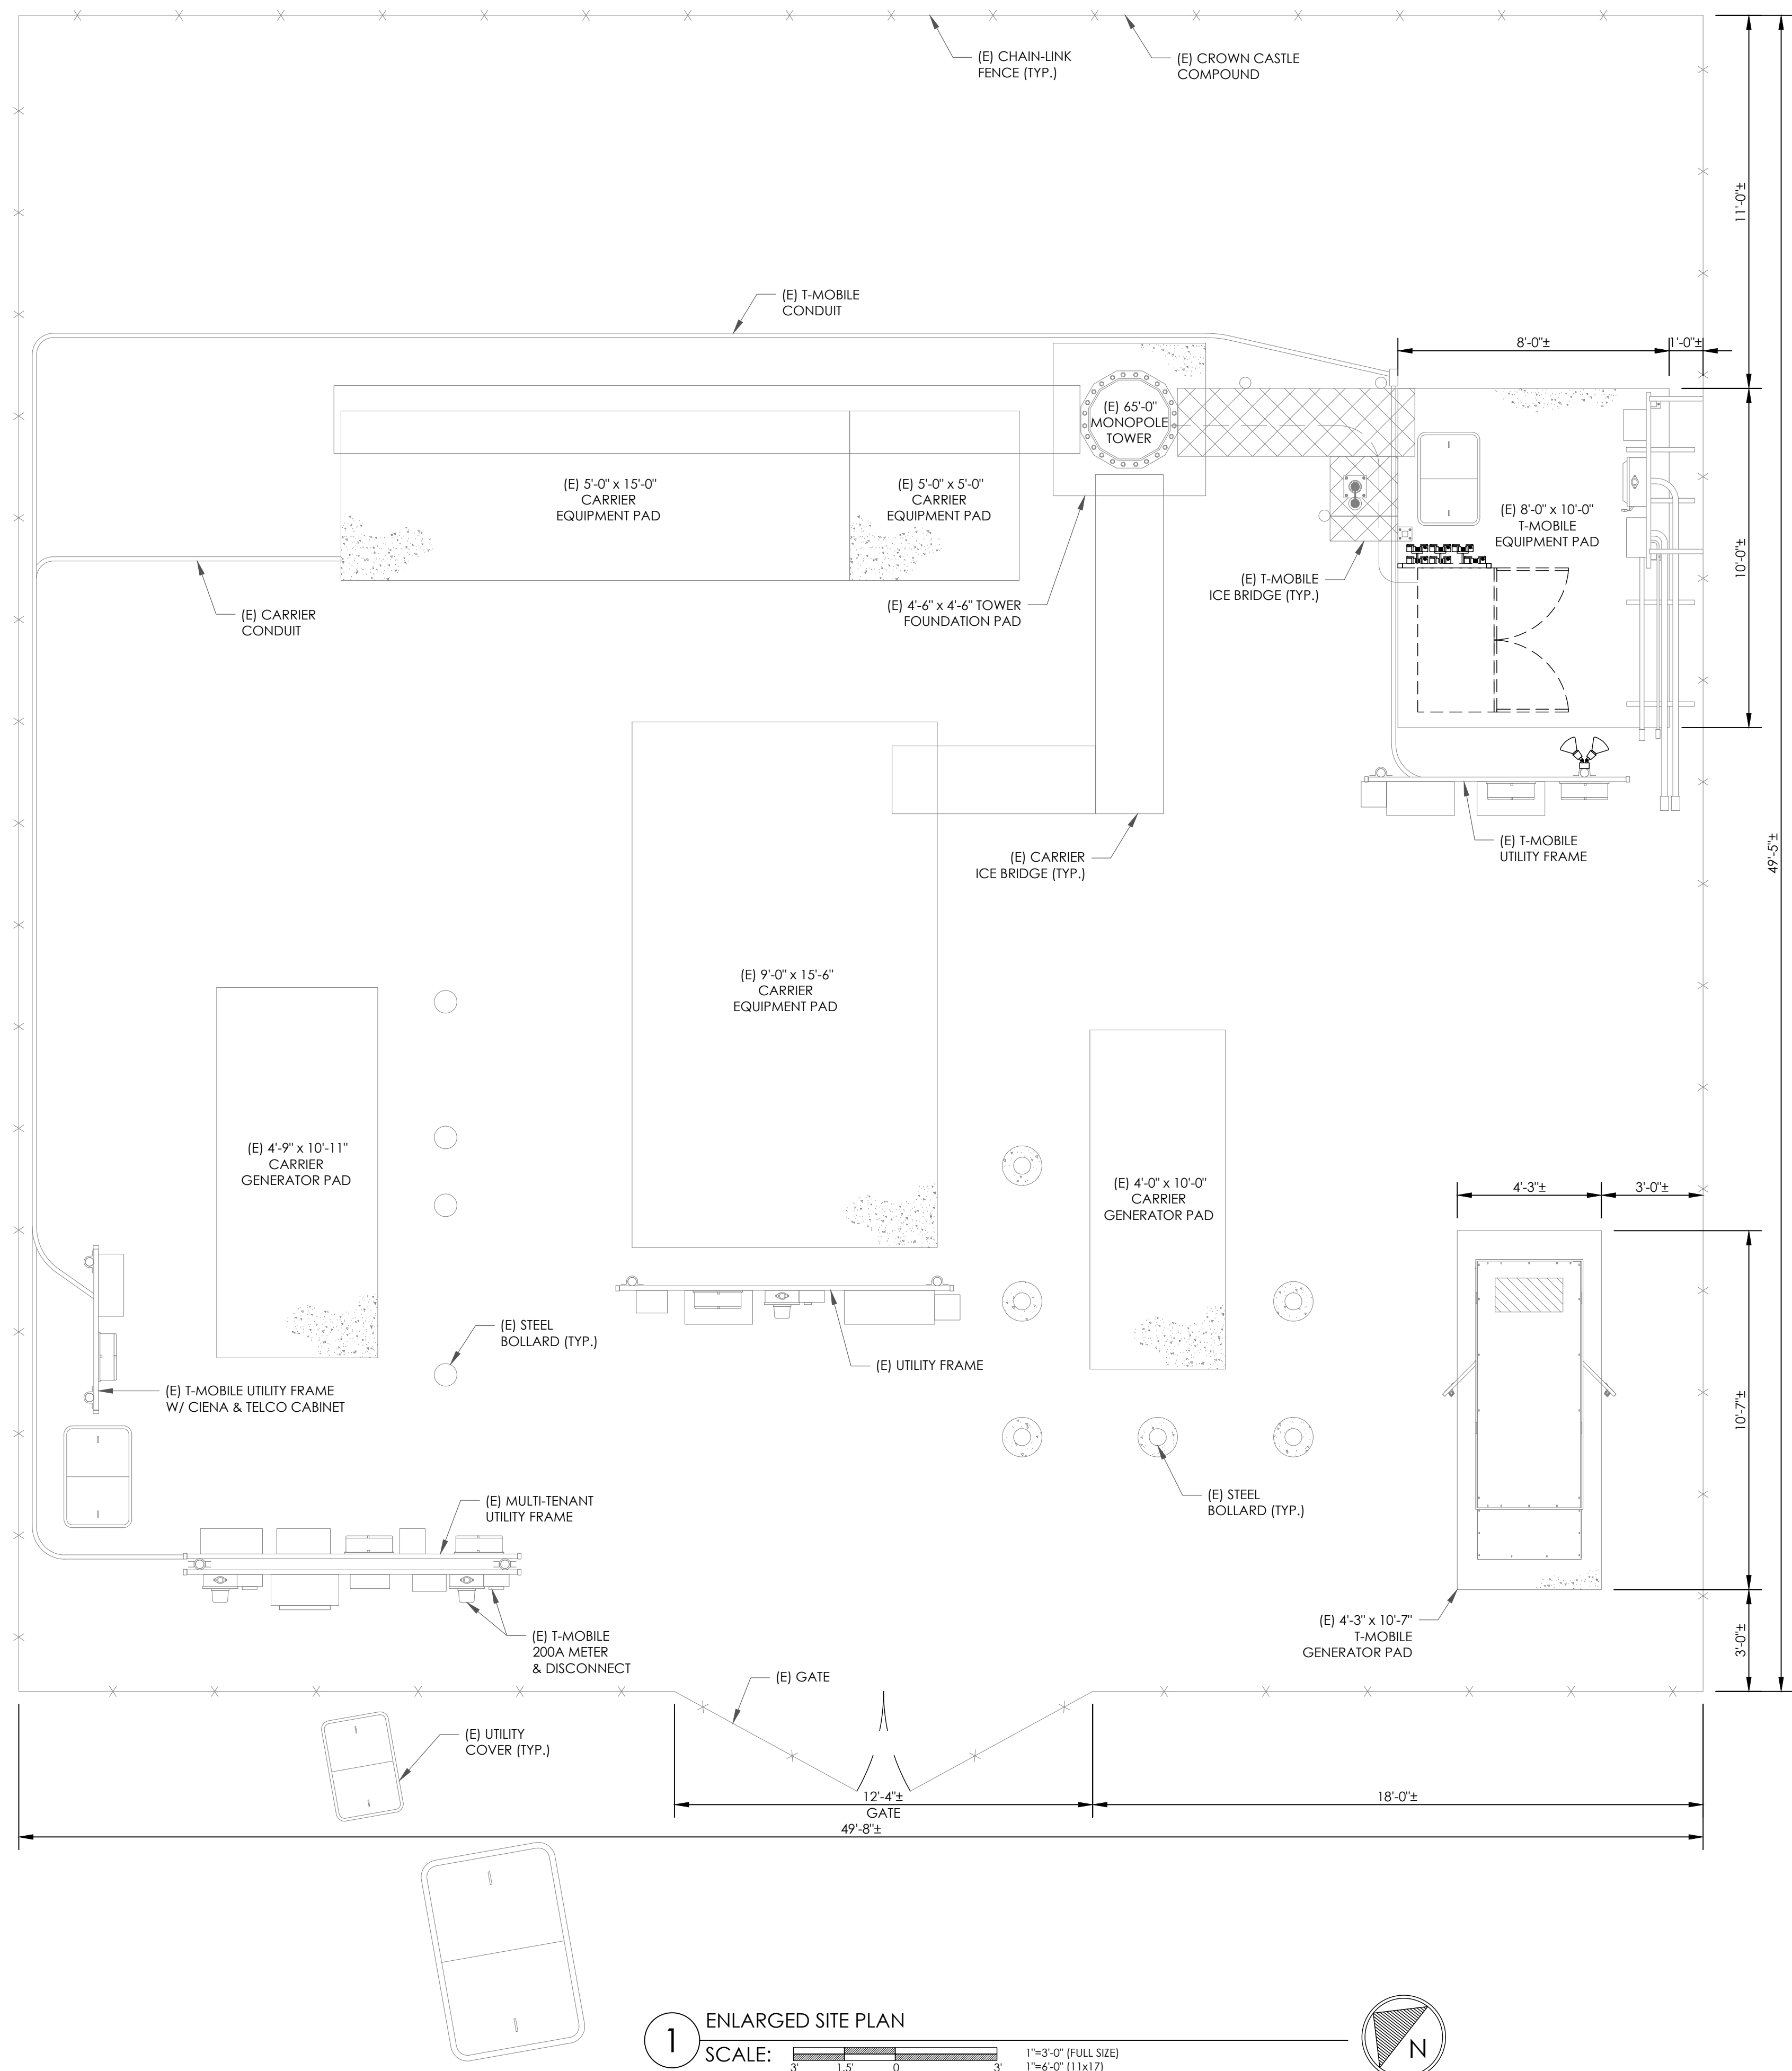

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1 PARK PLACE, SUITE 300
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PMA

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 6801 PORTWEST DR. STE 100,
 HOUSTON, TX 77024
 OFFICE 713-677-0964

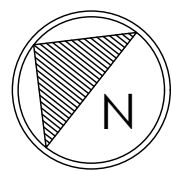T-MOBILE SITE NUMBER:
 SF40959A

BU #: 857683
**CROWN: AT&T NEW
 POTTER VALLEY**

12531 EEL RIVER ROAD
 POTTER VALLEY, CA 95469

EXISTING 65'-0" MONOPOLE

ISSUED FOR:

REV	DATE	DRWN	DESCRIPTION	DES./QA
A	12/20/23	AW	PRELIMINARY	HS
0	01/31/24	SM	FINAL CD	HS




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23CCTCAM-127


SHEET NUMBER: **C-1.1** REVISION: **0**

ELECTRICAL NOTES:

1. POWER DESIGN FOR ANY AC ELECTRICAL POWER CHANGE IS TO BE PERFORMED BY OTHERS AND IS FOR REFERENCE PURPOSES ONLY. T-MOBILE IS SOLELY RESPONSIBLE FOR THE ELECTRICAL POWER DESIGN.
2. ALL NEW AC POWER CONDUITS TO BE RIDGE CONDUITS.
3. GC TO FOLLOW THE 6160 & B160 INSTALLATION GUIDELINES.
4. GC TO FIELD VERIFY TECH LIGHTING AND IF NEEDED, CHANGE OUT TO LED LUMINARIE W/ 90-MINUTE TIMER SWITCH.

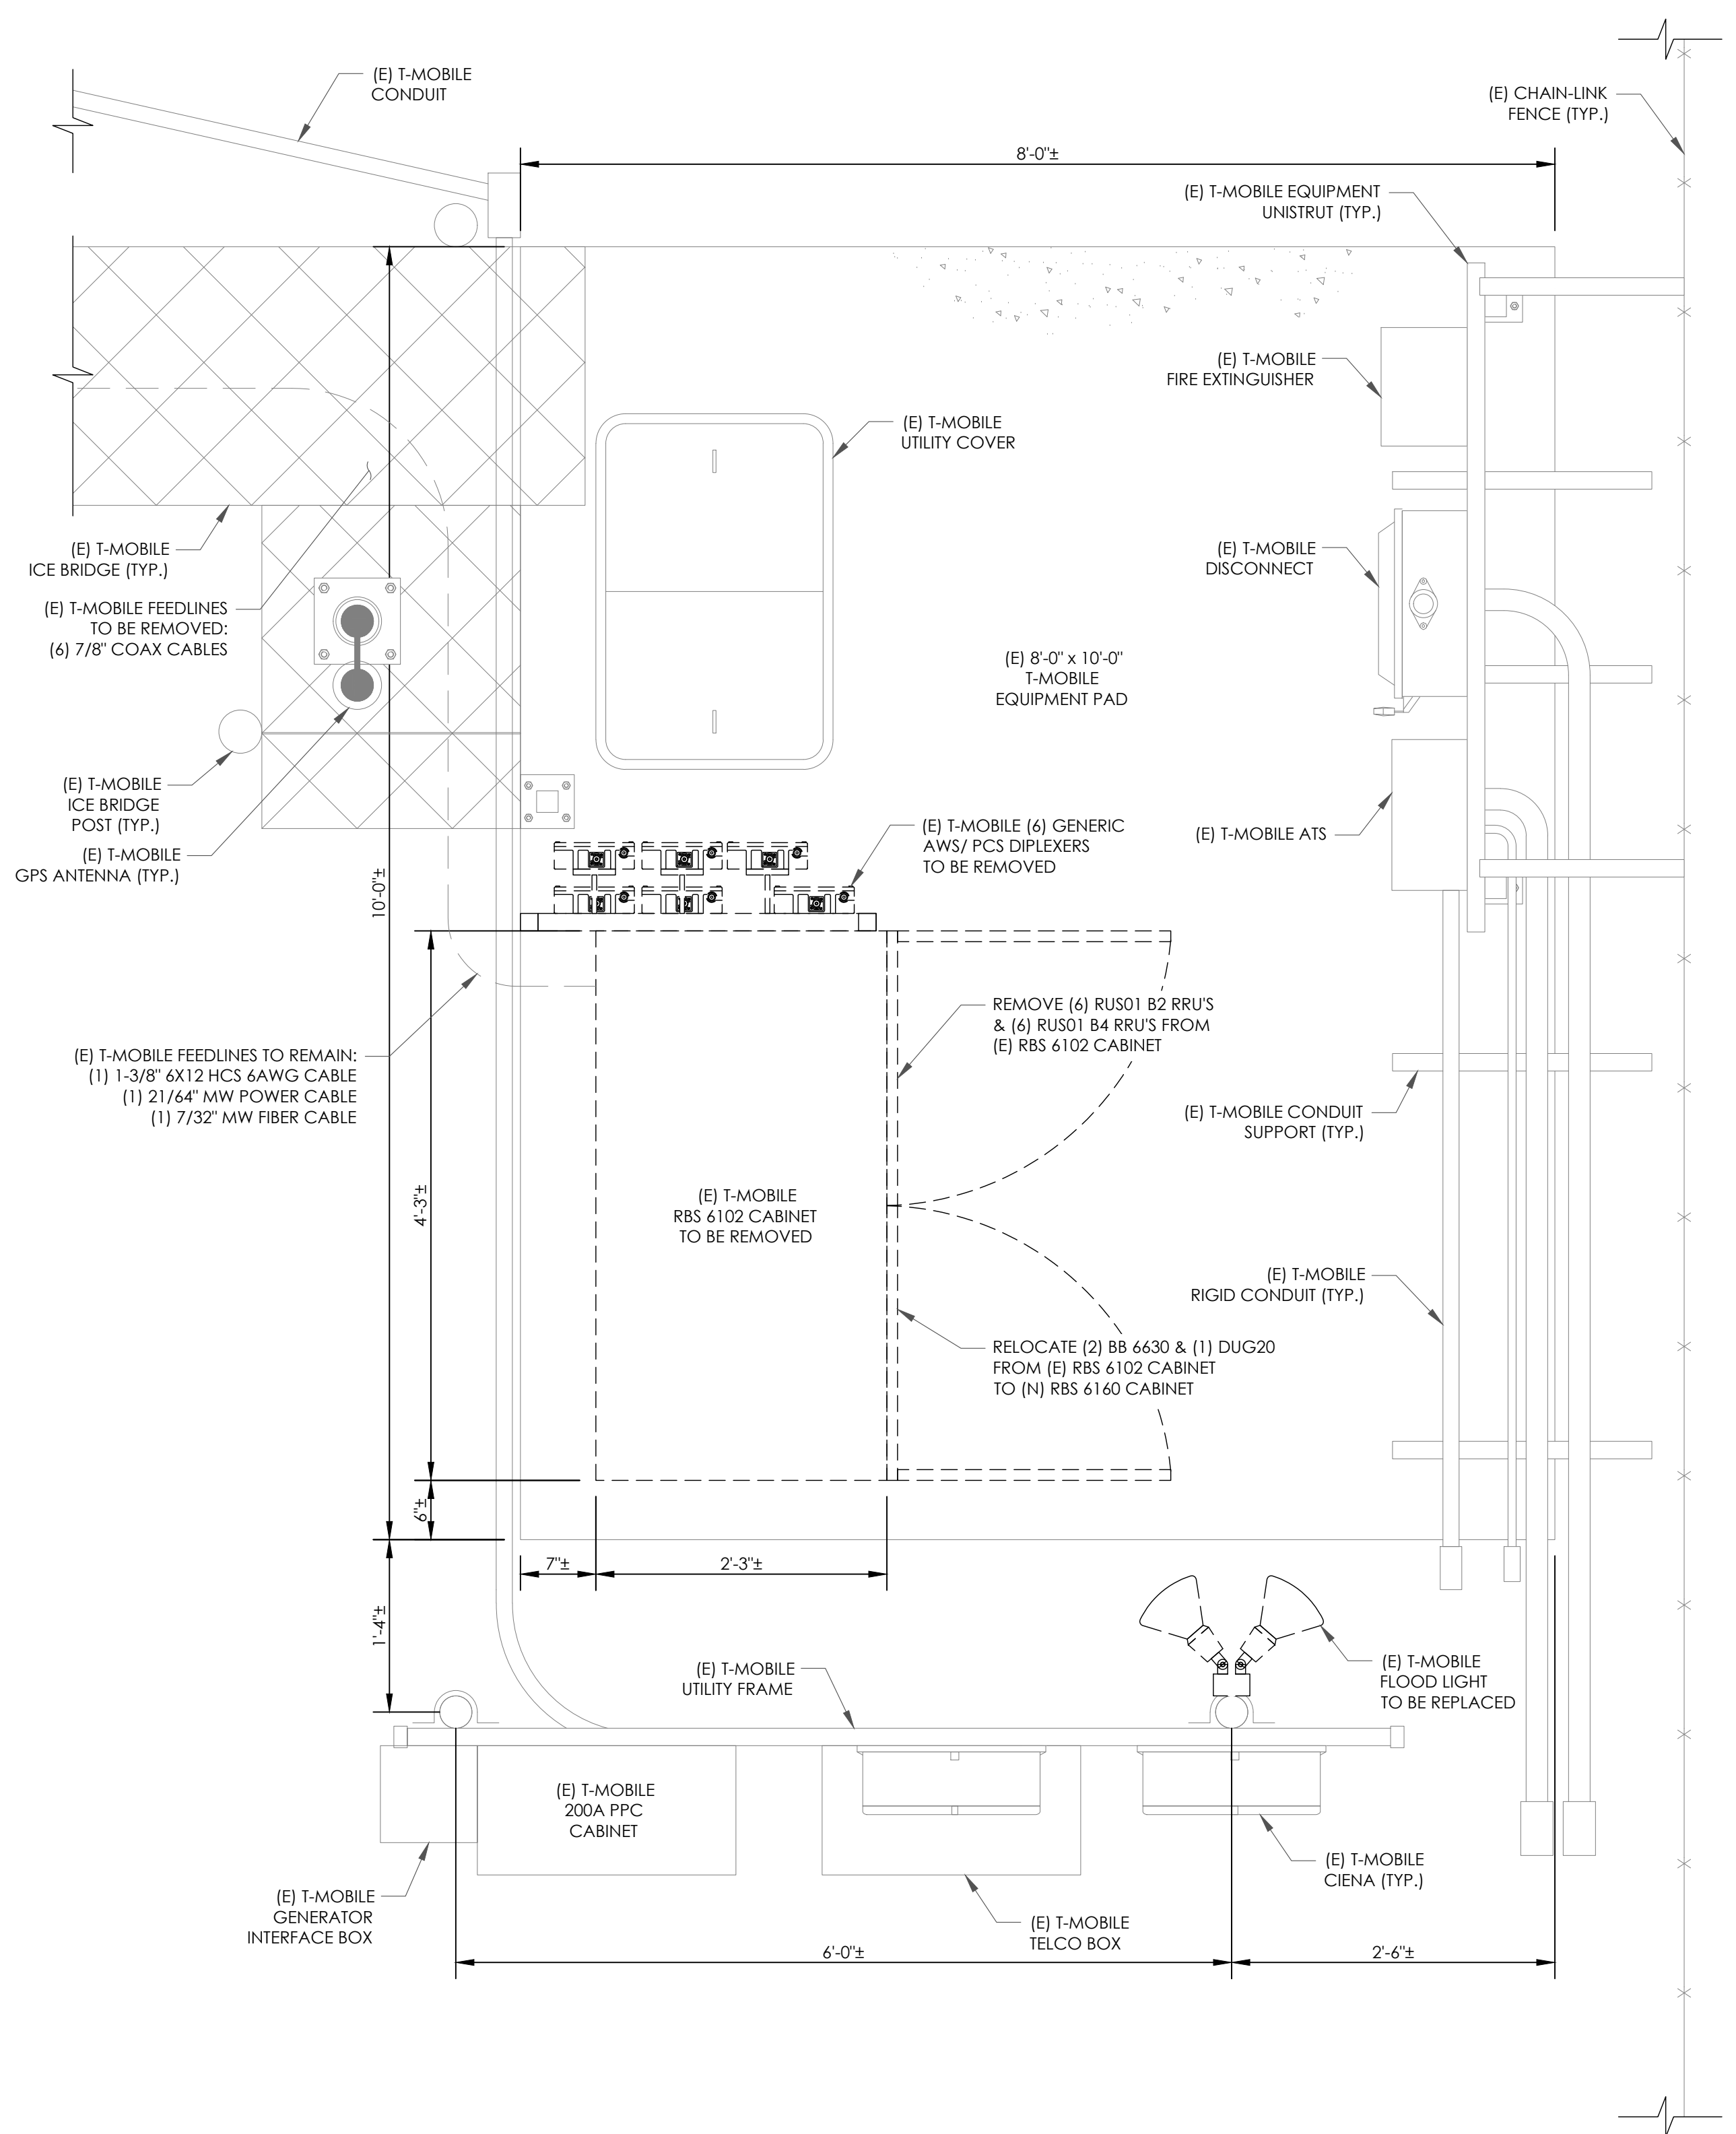

1 EXISTING EQUIPMENT PLAN
 SCALE: 1"=1'-0" (FULL SIZE)
 1/2"=1'-0" (11x17)

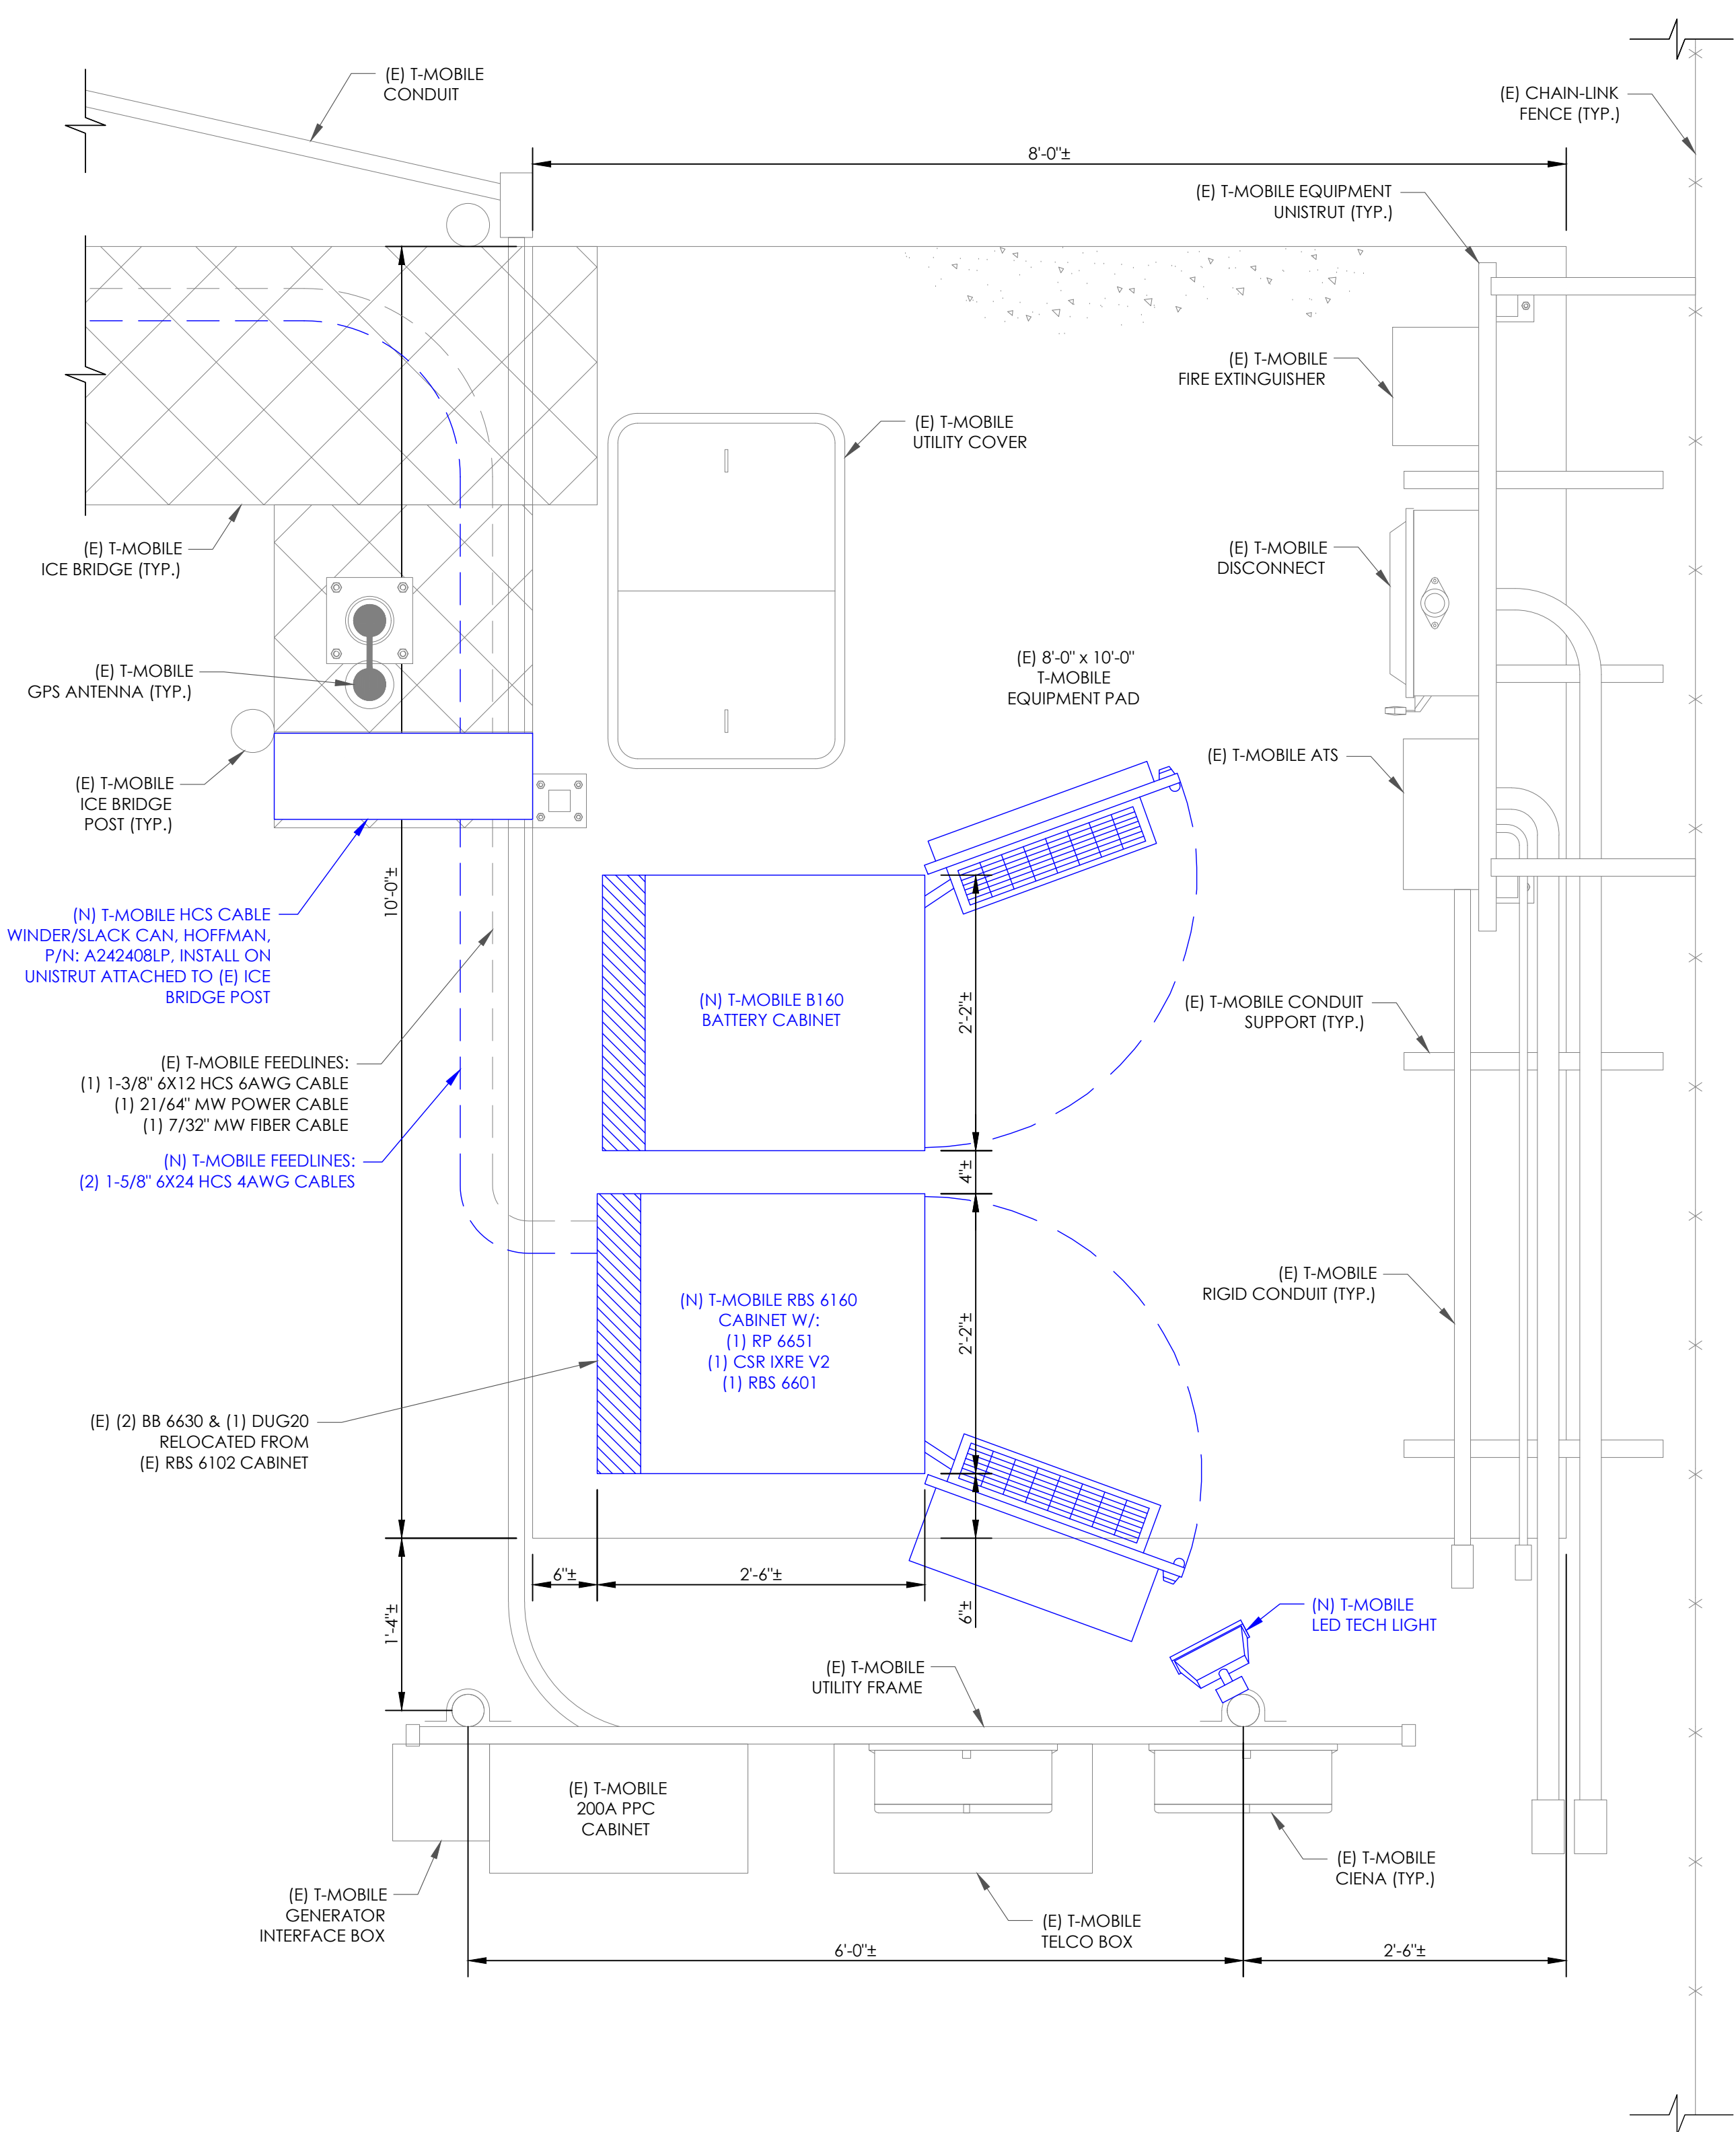

2 NEW EQUIPMENT PLAN
 SCALE: 1"=1'-0" (FULL SIZE)
 1/2"=1'-0" (11x17)

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 HOUSTON, TX 77024
 OFFICE 713-677-0964

T-MOBILE SITE NUMBER:
 SF40959A

BU #: 857683
**CROWN: AT&T NEW
 POTTER VALLEY**

12531 EEL RIVER ROAD
 POTTER VALLEY, CA 95469

EXISTING 65'-0" MONOPOLE

ISSUED FOR:

REV	DATE	DRWN	DESCRIPTION	DES./QA
A	12/20/23	AW	PRELIMINARY	HS
0	01/31/24	SM	FINAL CD	HS

REGISTERED PROFESSIONAL ENGINEER
 ANDREI BARBO
 CIVIL
 STATE OF CALIFORNIA
 C87623
 02/01/2024


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PROJECT NUMBER:
23CCTCAM-127


SHEET NUMBER: **C-1.2**
 REVISION: **0**

STRUCTURAL ANALYSIS & INSTALLATION NOTES:

1. THE DESIGN DEPICTED IN THESE DRAWINGS IS VALID WHEN ACCOMPANIED BY A CORRESPONDING PASSING TOWER ANALYSIS, FOUNDATION ANALYSIS & MOUNT ANALYSIS.
2. CONSTRUCTION MANAGER / GENERAL CONTRACTOR SHALL REVIEW THE MOUNT ANALYSIS FOR ANY CONDITIONS PRIOR TO INSTALLATION.
3. ANY REQUIRED MOUNT MODIFICATION DESIGN OR MOUNT REPLACEMENT SHALL BE APPROVED BY EOR.

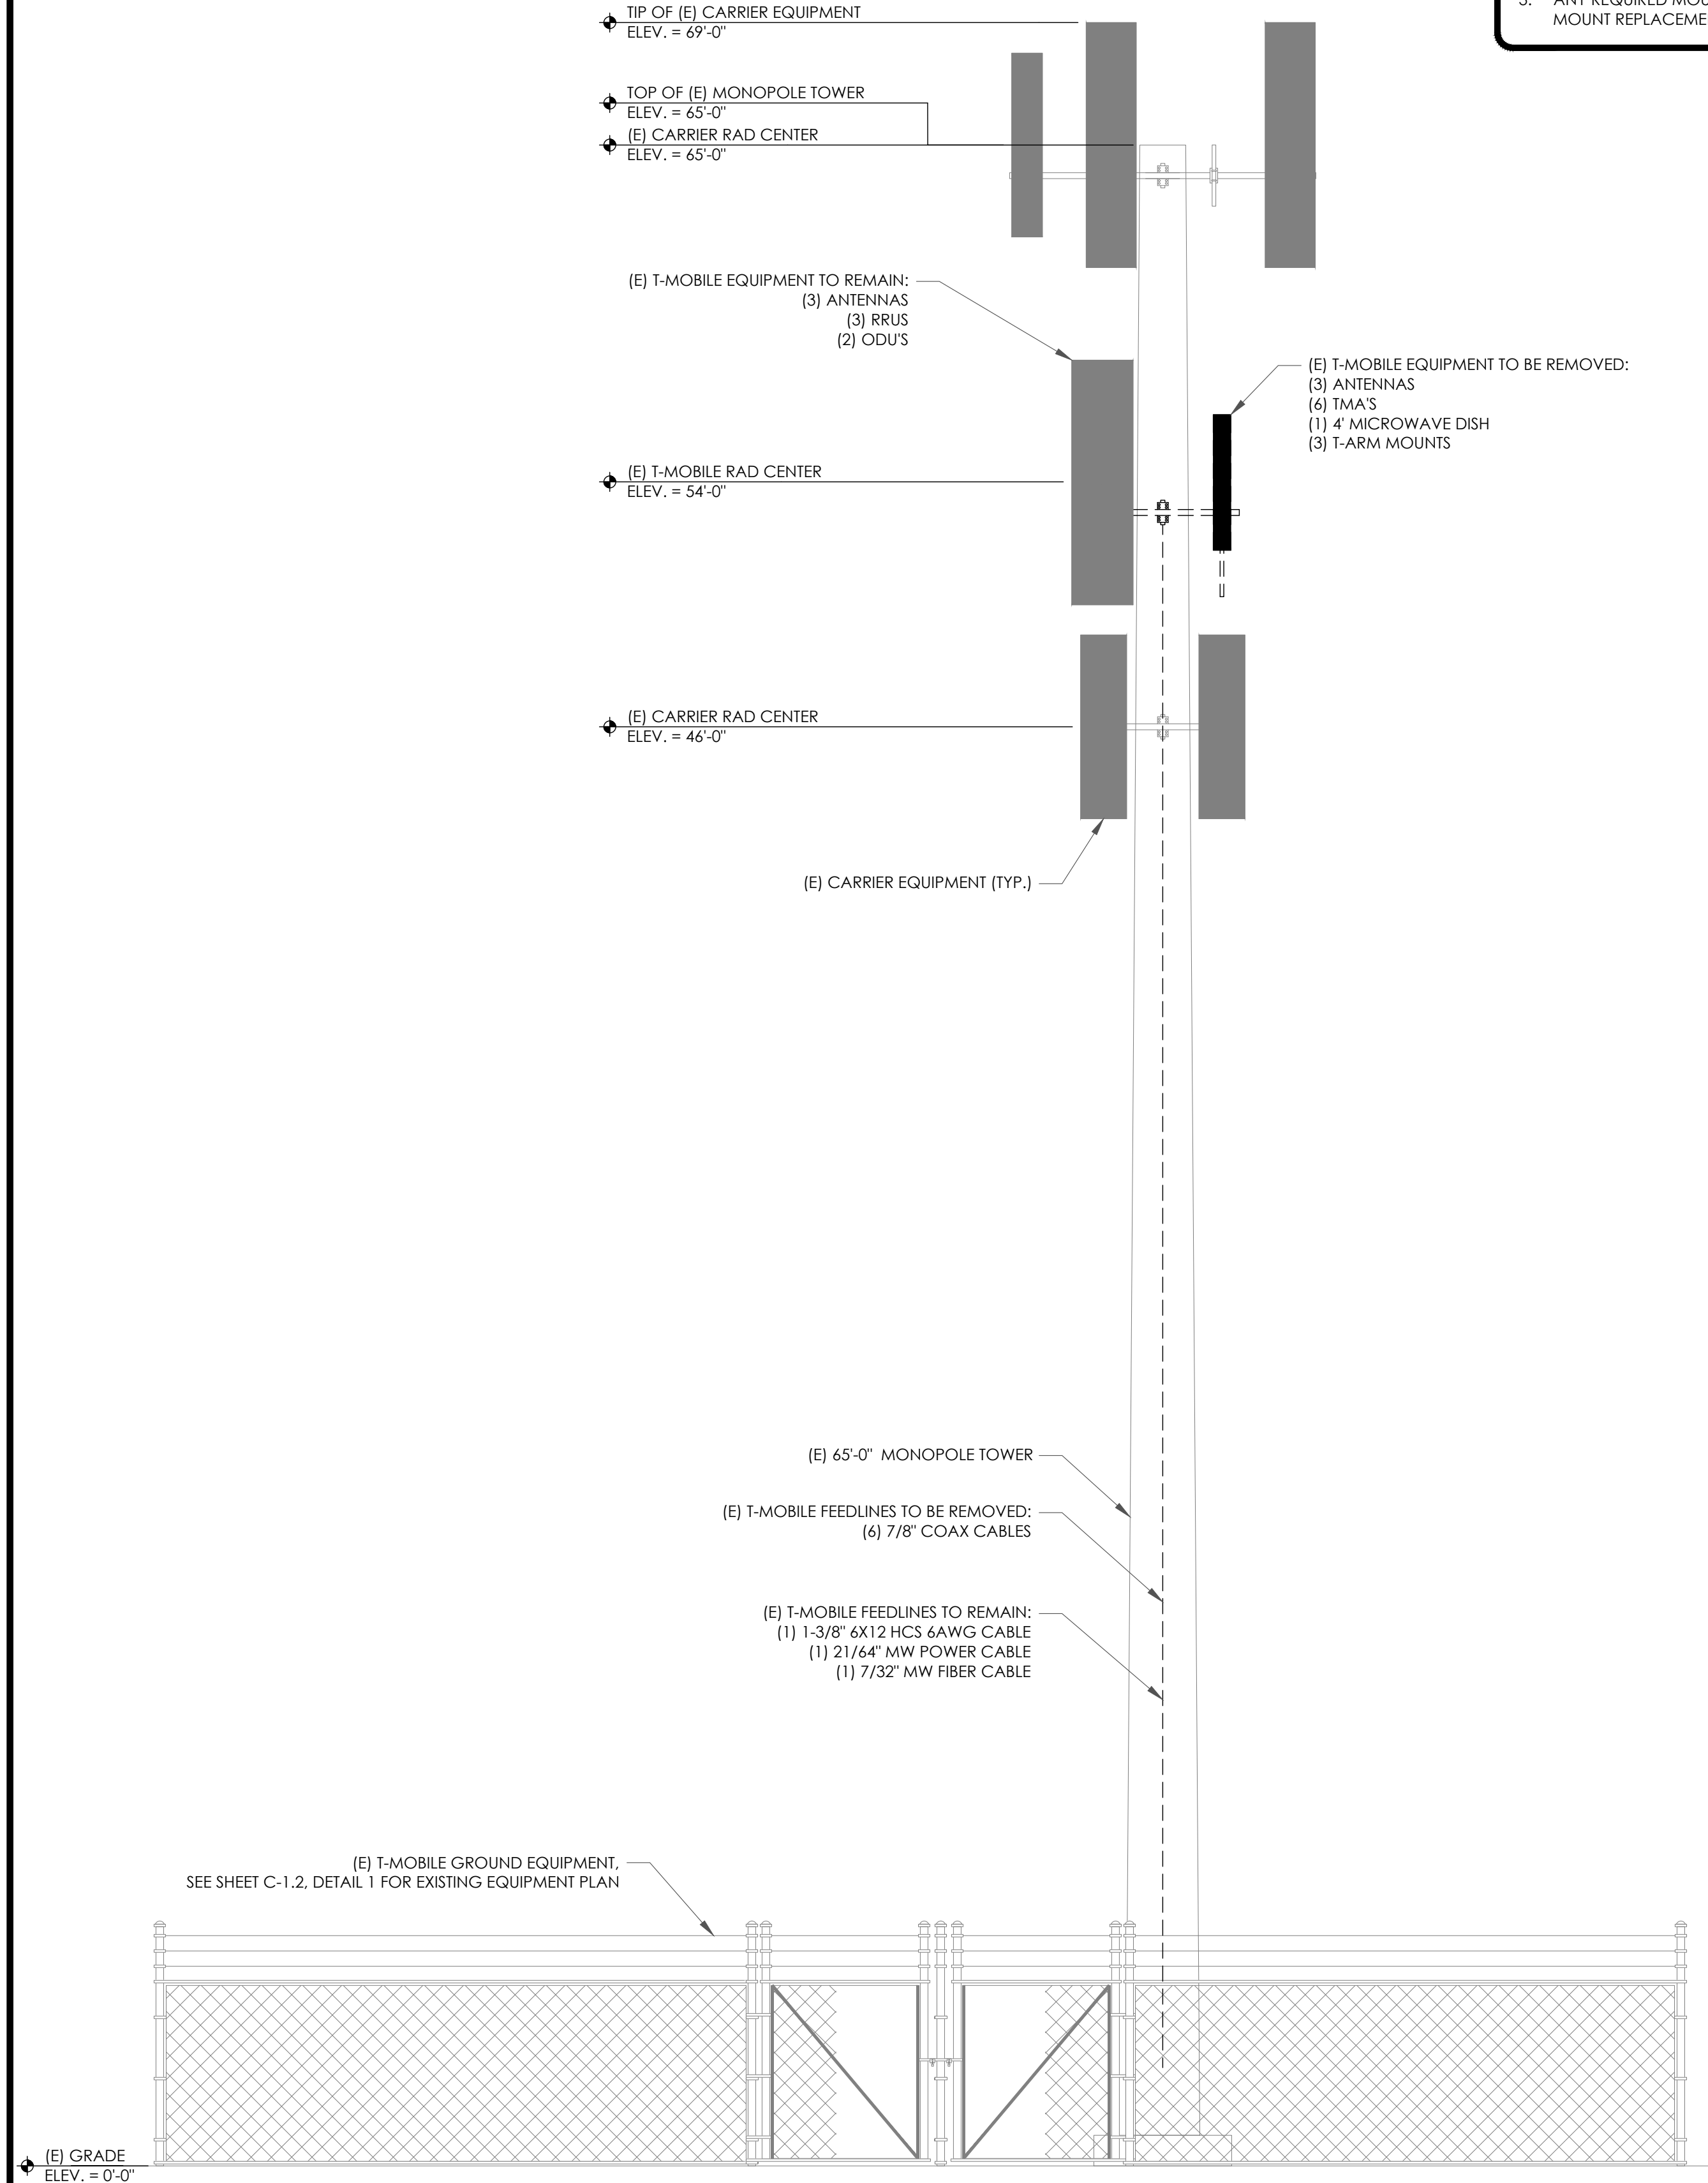

1 EXISTING SOUTH-WEST ELEVATION
SCALE: 1/4"=1'-0" (FULL SIZE)
1/8"=1'-0" (11x17)

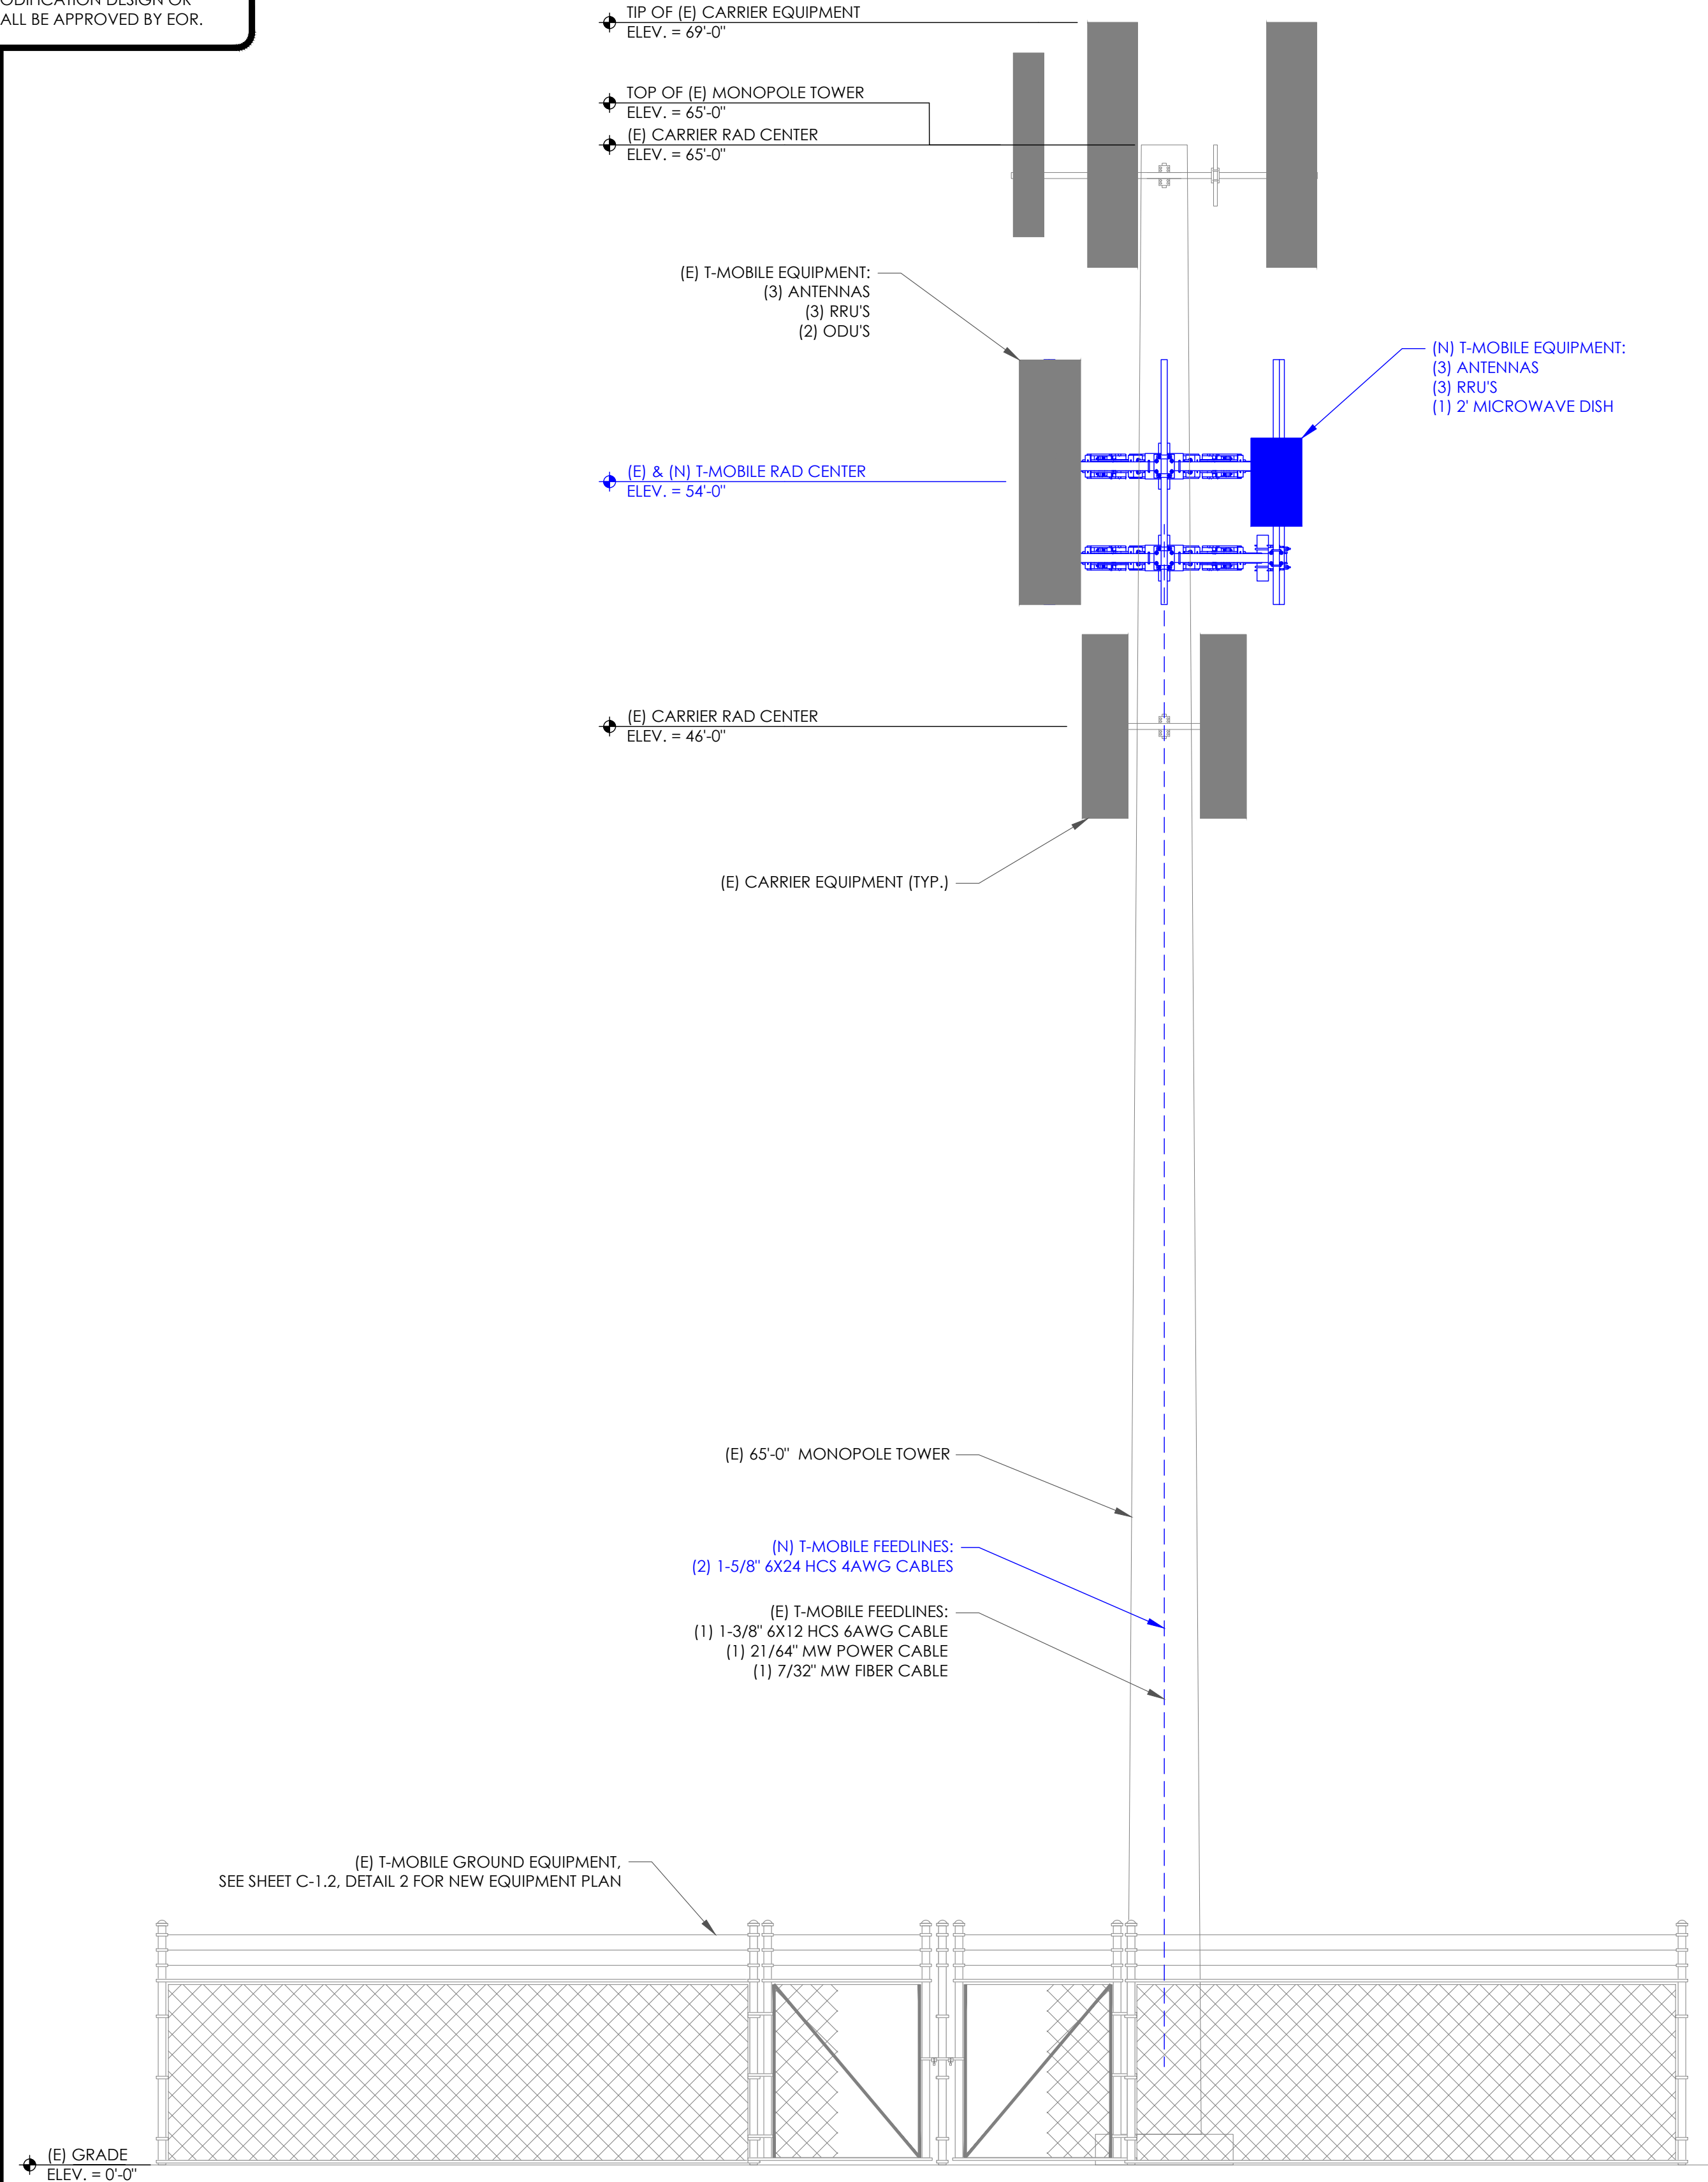

2 NEW SOUTH-WEST ELEVATION
SCALE: 1/4"=1'-0" (FULL SIZE)
1/8"=1'-0" (11x17)

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CROWN CASTLE
1 PARK PLACE, SUITE 300
DUBLIN, CA 94568

PMA & A
P. MARSHALL & ASSOCIATES
6801 PORTWEST DR. STE 100,
HOUSTON, TX 77024
OFFICE 713-677-0964

T-MOBILE SITE NUMBER:
SF40959A

BU #: 857683
CROWN: AT&T NEW POTTER VALLEY

12531 EEL RIVER ROAD
POTTER VALLEY, CA 95469

EXISTING 65'-0" MONOPOLE

ISSUED FOR:

REV	DATE	DRWN	DESCRIPTION	DES./QA
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0	01/31/24	SM	FINAL CD	HS

REGISTERED PROFESSIONAL ENGINEER
ANDREI BARBO
C87623
ASSOCIATE CIVIL ENGINEER
STATE OF CALIFORNIA
02/01/2024


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23CCTCAM-127


SHEET NUMBER: **C-2** REVISION: **0**

STRUCTURAL ANALYSIS & INSTALLATION NOTES:

1. THE DESIGN DEPICTED IN THESE DRAWINGS IS VALID WHEN ACCOMPANIED BY A CORRESPONDING PASSING TOWER ANALYSIS, FOUNDATION ANALYSIS & MOUNT ANALYSIS.
2. CONSTRUCTION MANAGER / GENERAL CONTRACTOR SHALL REVIEW THE MOUNT ANALYSIS FOR ANY CONDITIONS PRIOR TO INSTALLATION.
3. ANY REQUIRED MOUNT MODIFICATION DESIGN OR MOUNT REPLACEMENT SHALL BE APPROVED BY EOR.

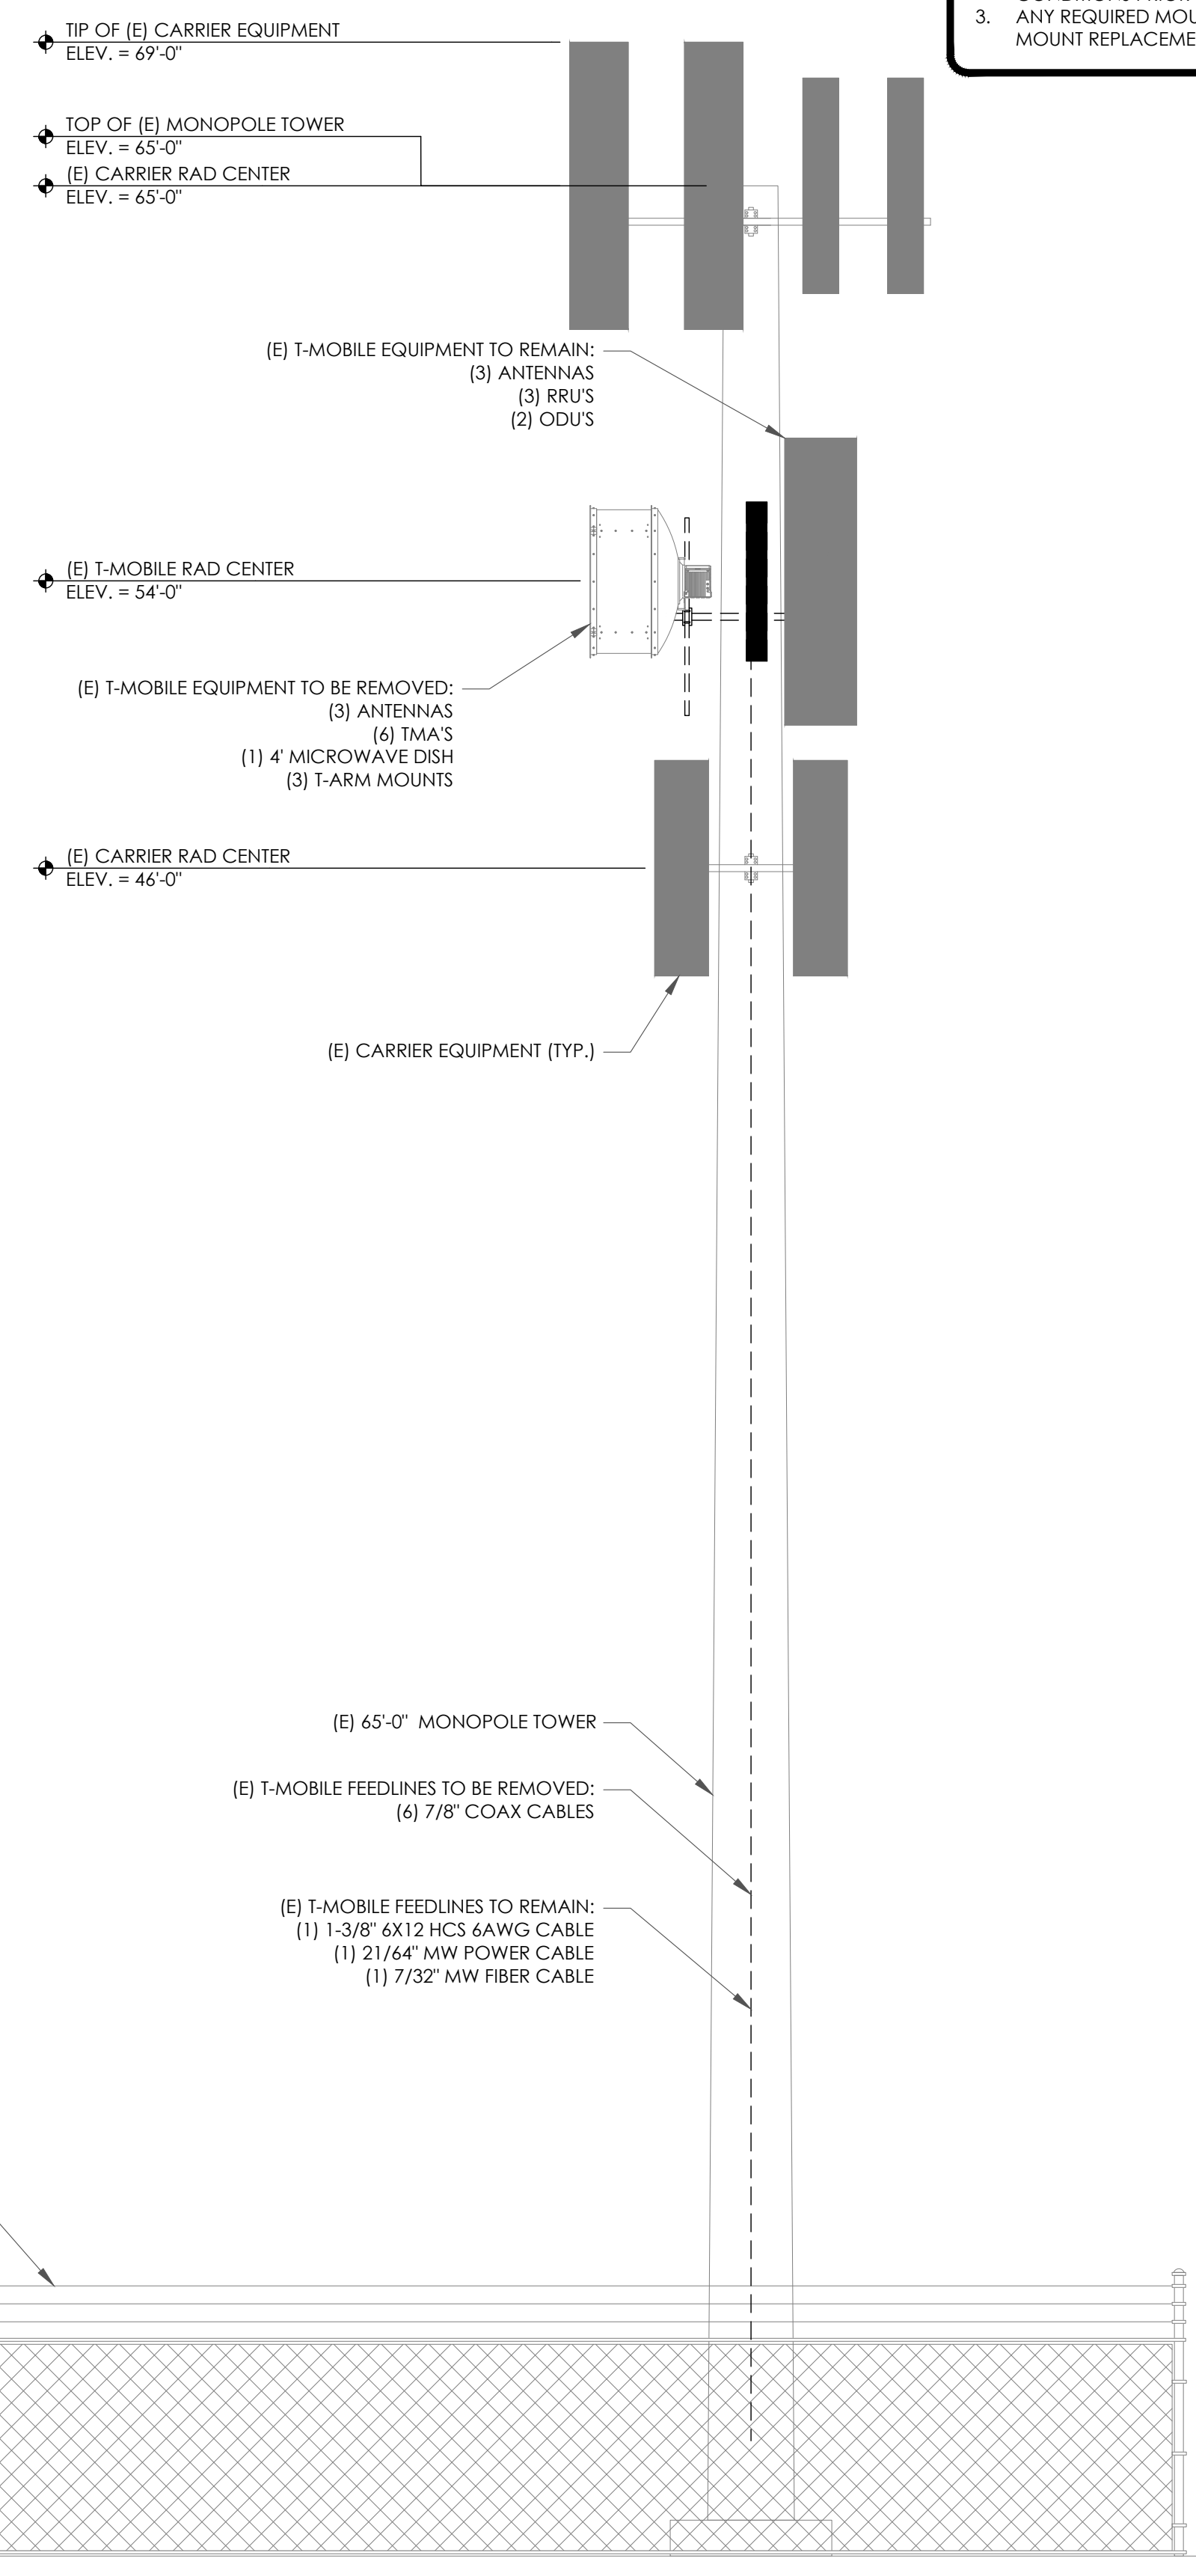

1 EXISTING SOUTH-EAST ELEVATION
SCALE: 1/4"=1'-0" (FULL SIZE)
1/8"=1'-0" (11x17)

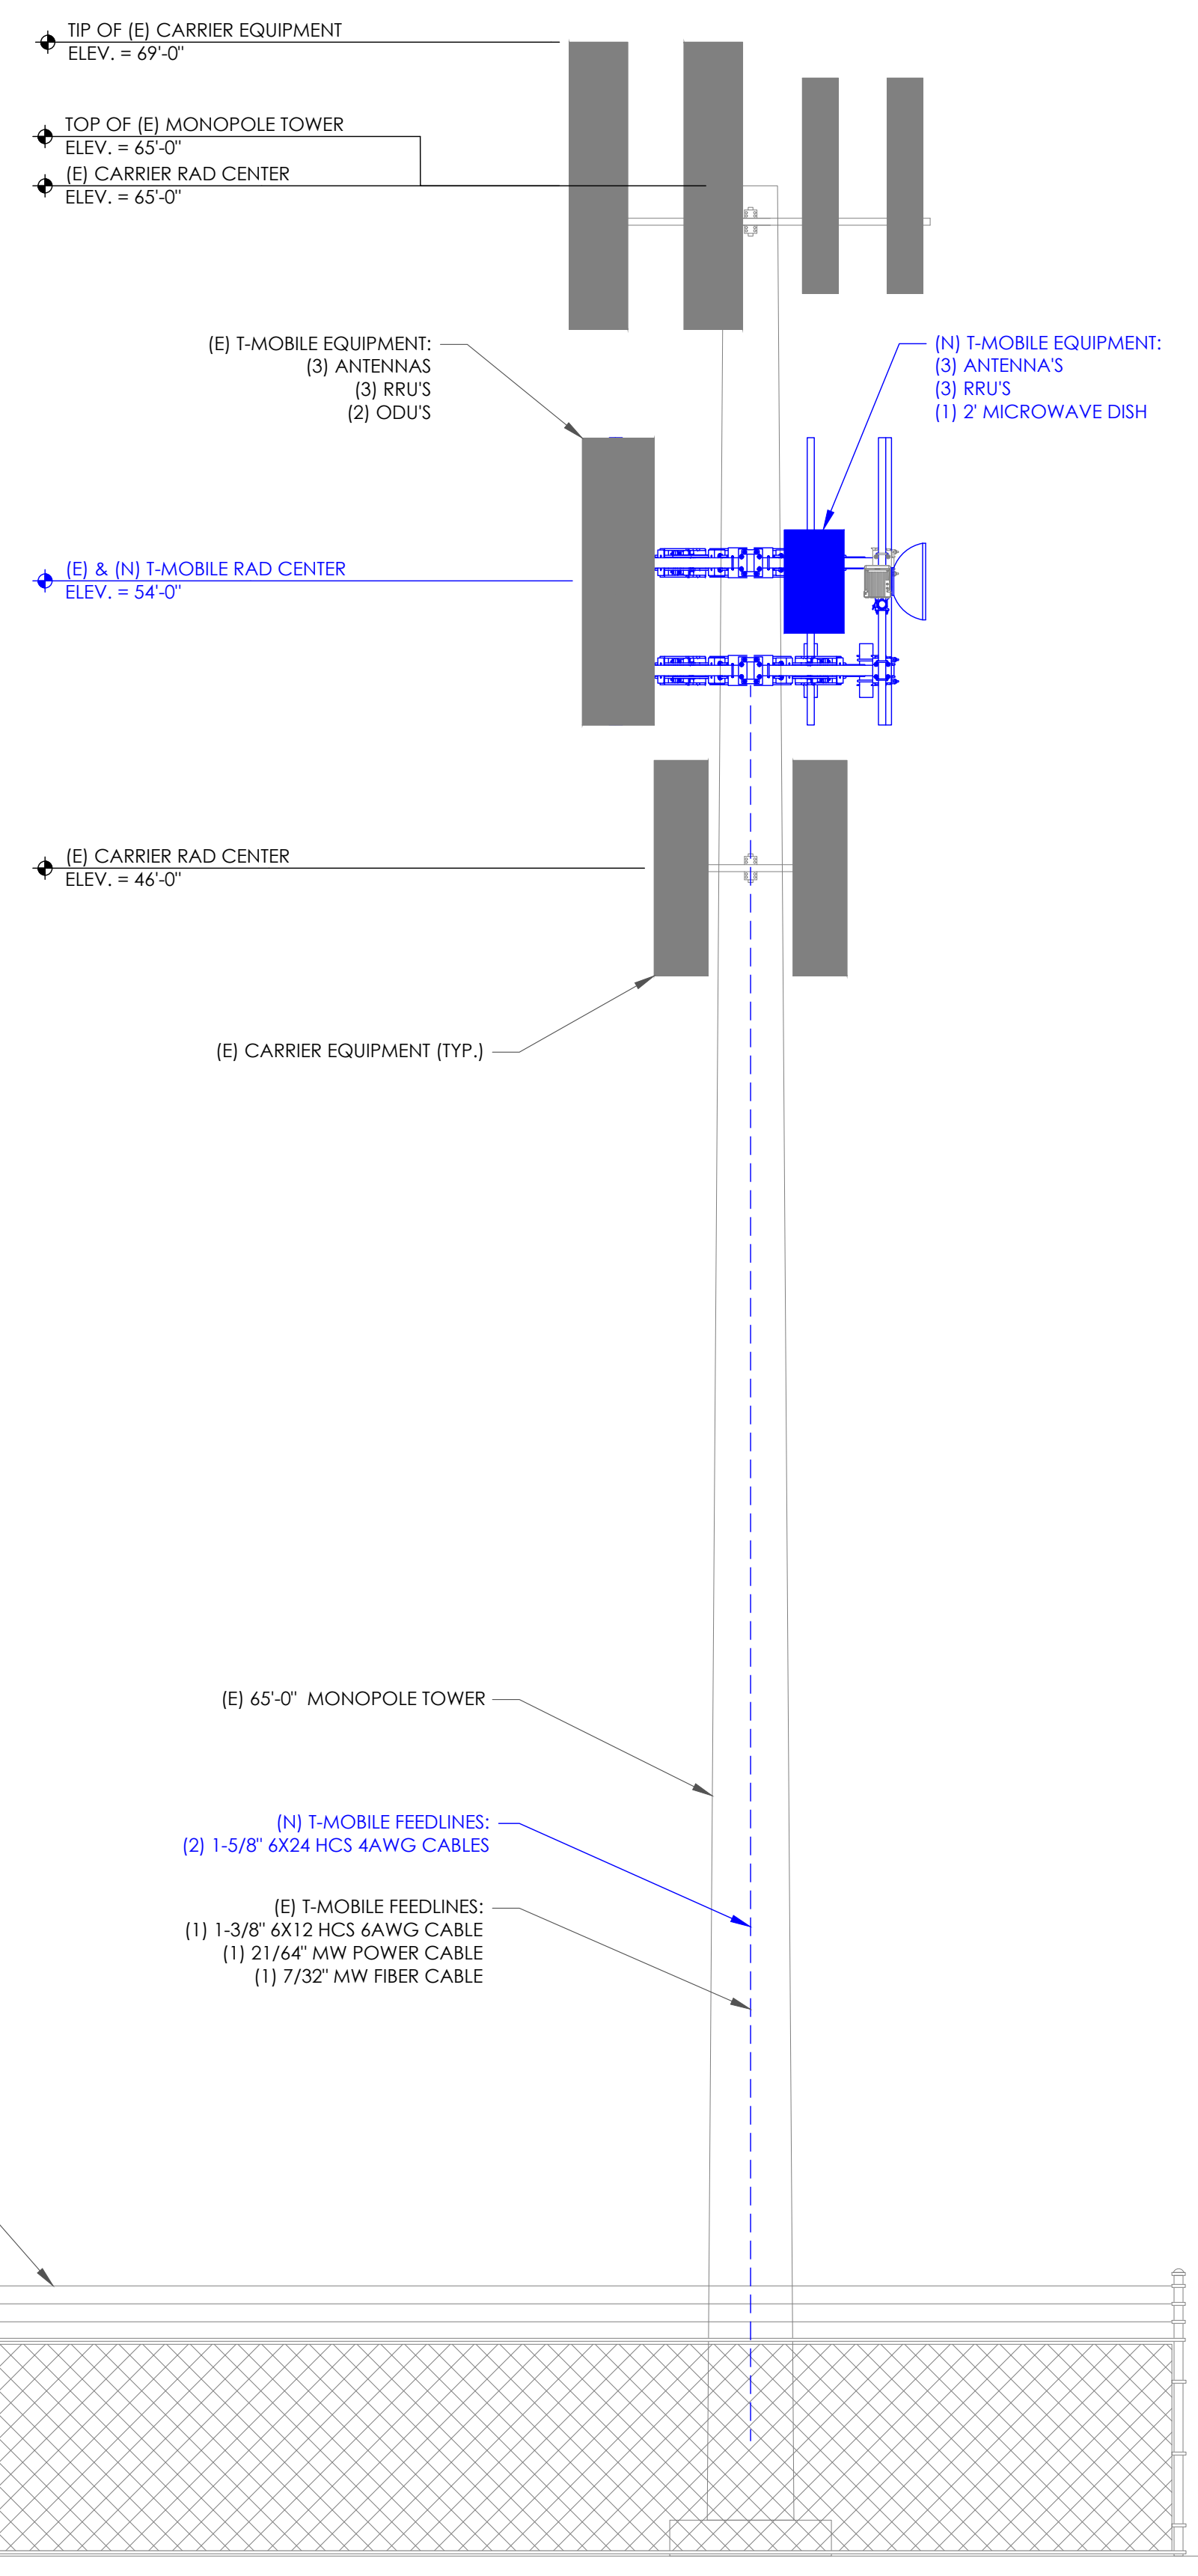

2 NEW SOUTH-EAST ELEVATION
SCALE: 1/4"=1'-0" (FULL SIZE)
1/8"=1'-0" (11x17)

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P. MARSHALL & ASSOCIATES
6801 PORTWEST DR. STE 100,
HOUSTON, TX 77024
OFFICE 713-677-0964

T-MOBILE SITE NUMBER:
SF40959A

BU #: 857683
CROWN: AT&T NEW POTTER VALLEY

12531 EEL RIVER ROAD
POTTER VALLEY, CA 95469

EXISTING 65'-0" MONOPOLE

ISSUED FOR:


REV	DATE	DRWN	DESCRIPTION	DES./QA
A	12/20/23	AW	PRELIMINARY	HS
0	01/31/24	SM	FINAL CD	HS

REGISTERED PROFESSIONAL ENGINEER
ANDREI BARBO
C87623
CIVIL
STATE OF CALIFORNIA
02/01/2024



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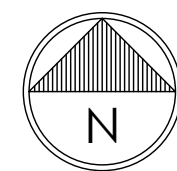
SHEET NUMBER: **C-2.1** REVISION: **0**



1 EXISTING ANTENNA PLAN
SCALE: 3/4"=1'-0" (FULL SIZE)
3/8"=1'-0" (11x17)

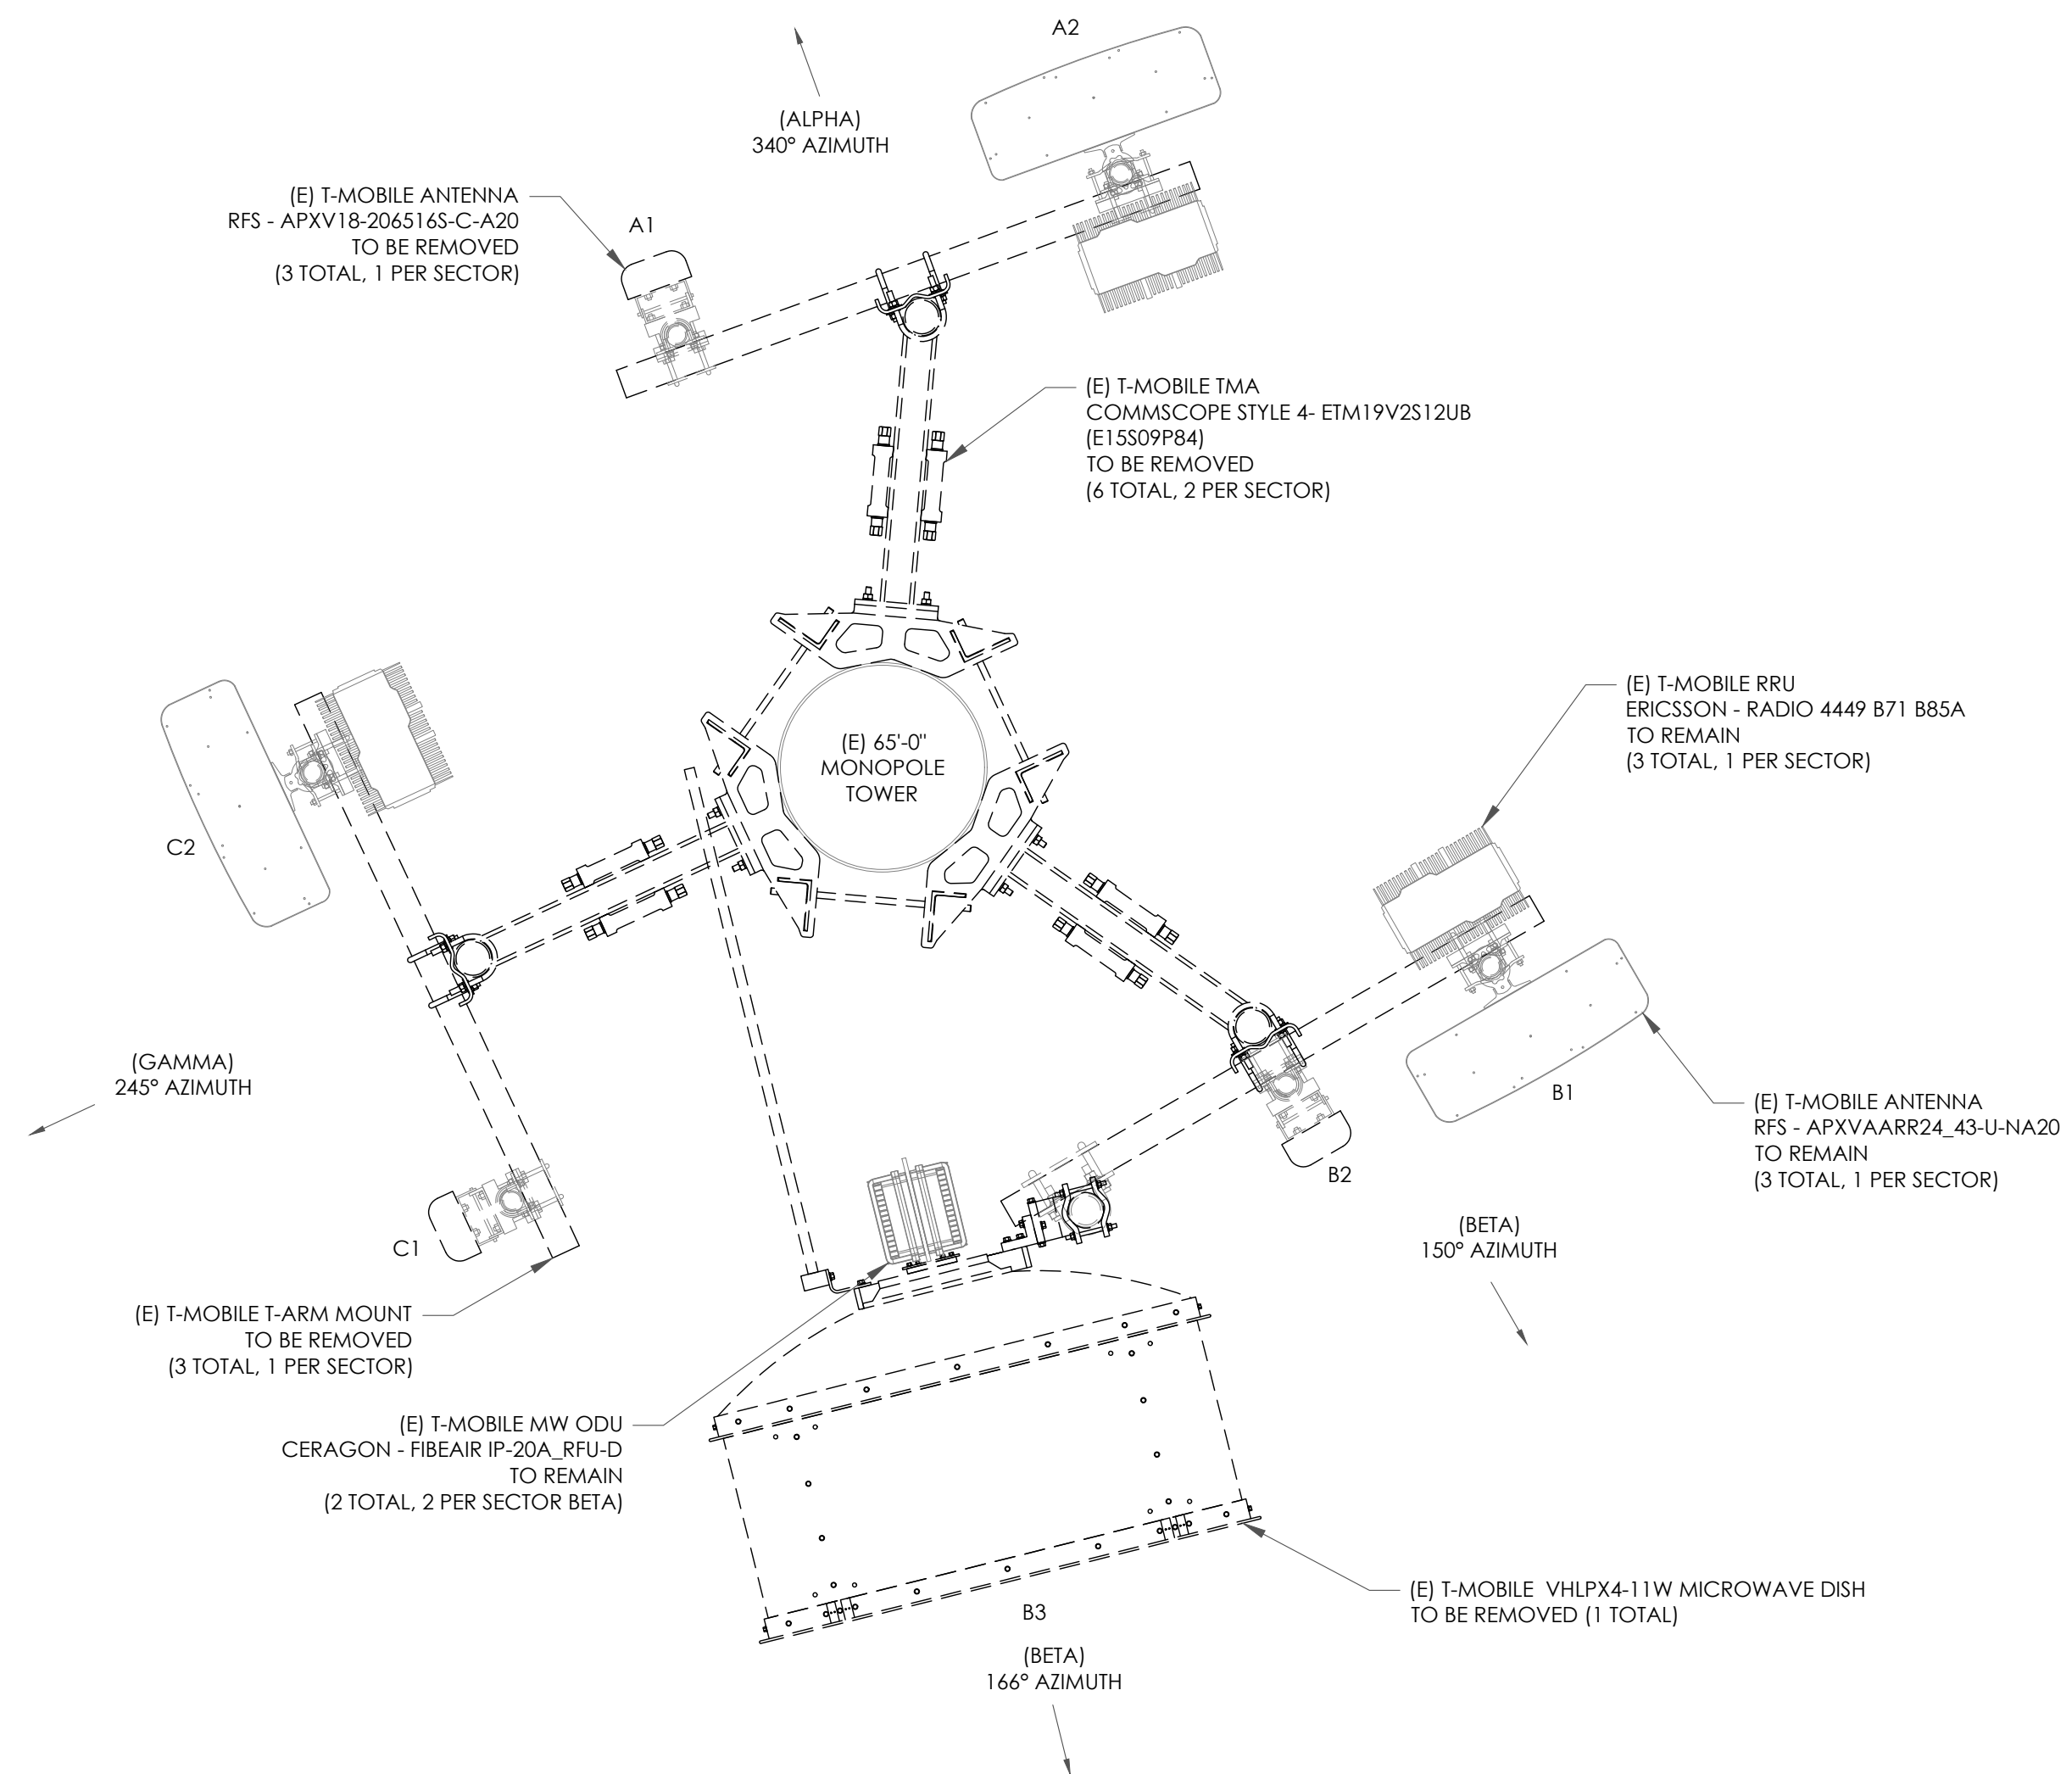

2 NEW ANTENNA PLAN
SCALE: 3/4"=1'-0" (FULL SIZE)
3/8"=1'-0" (11x17)

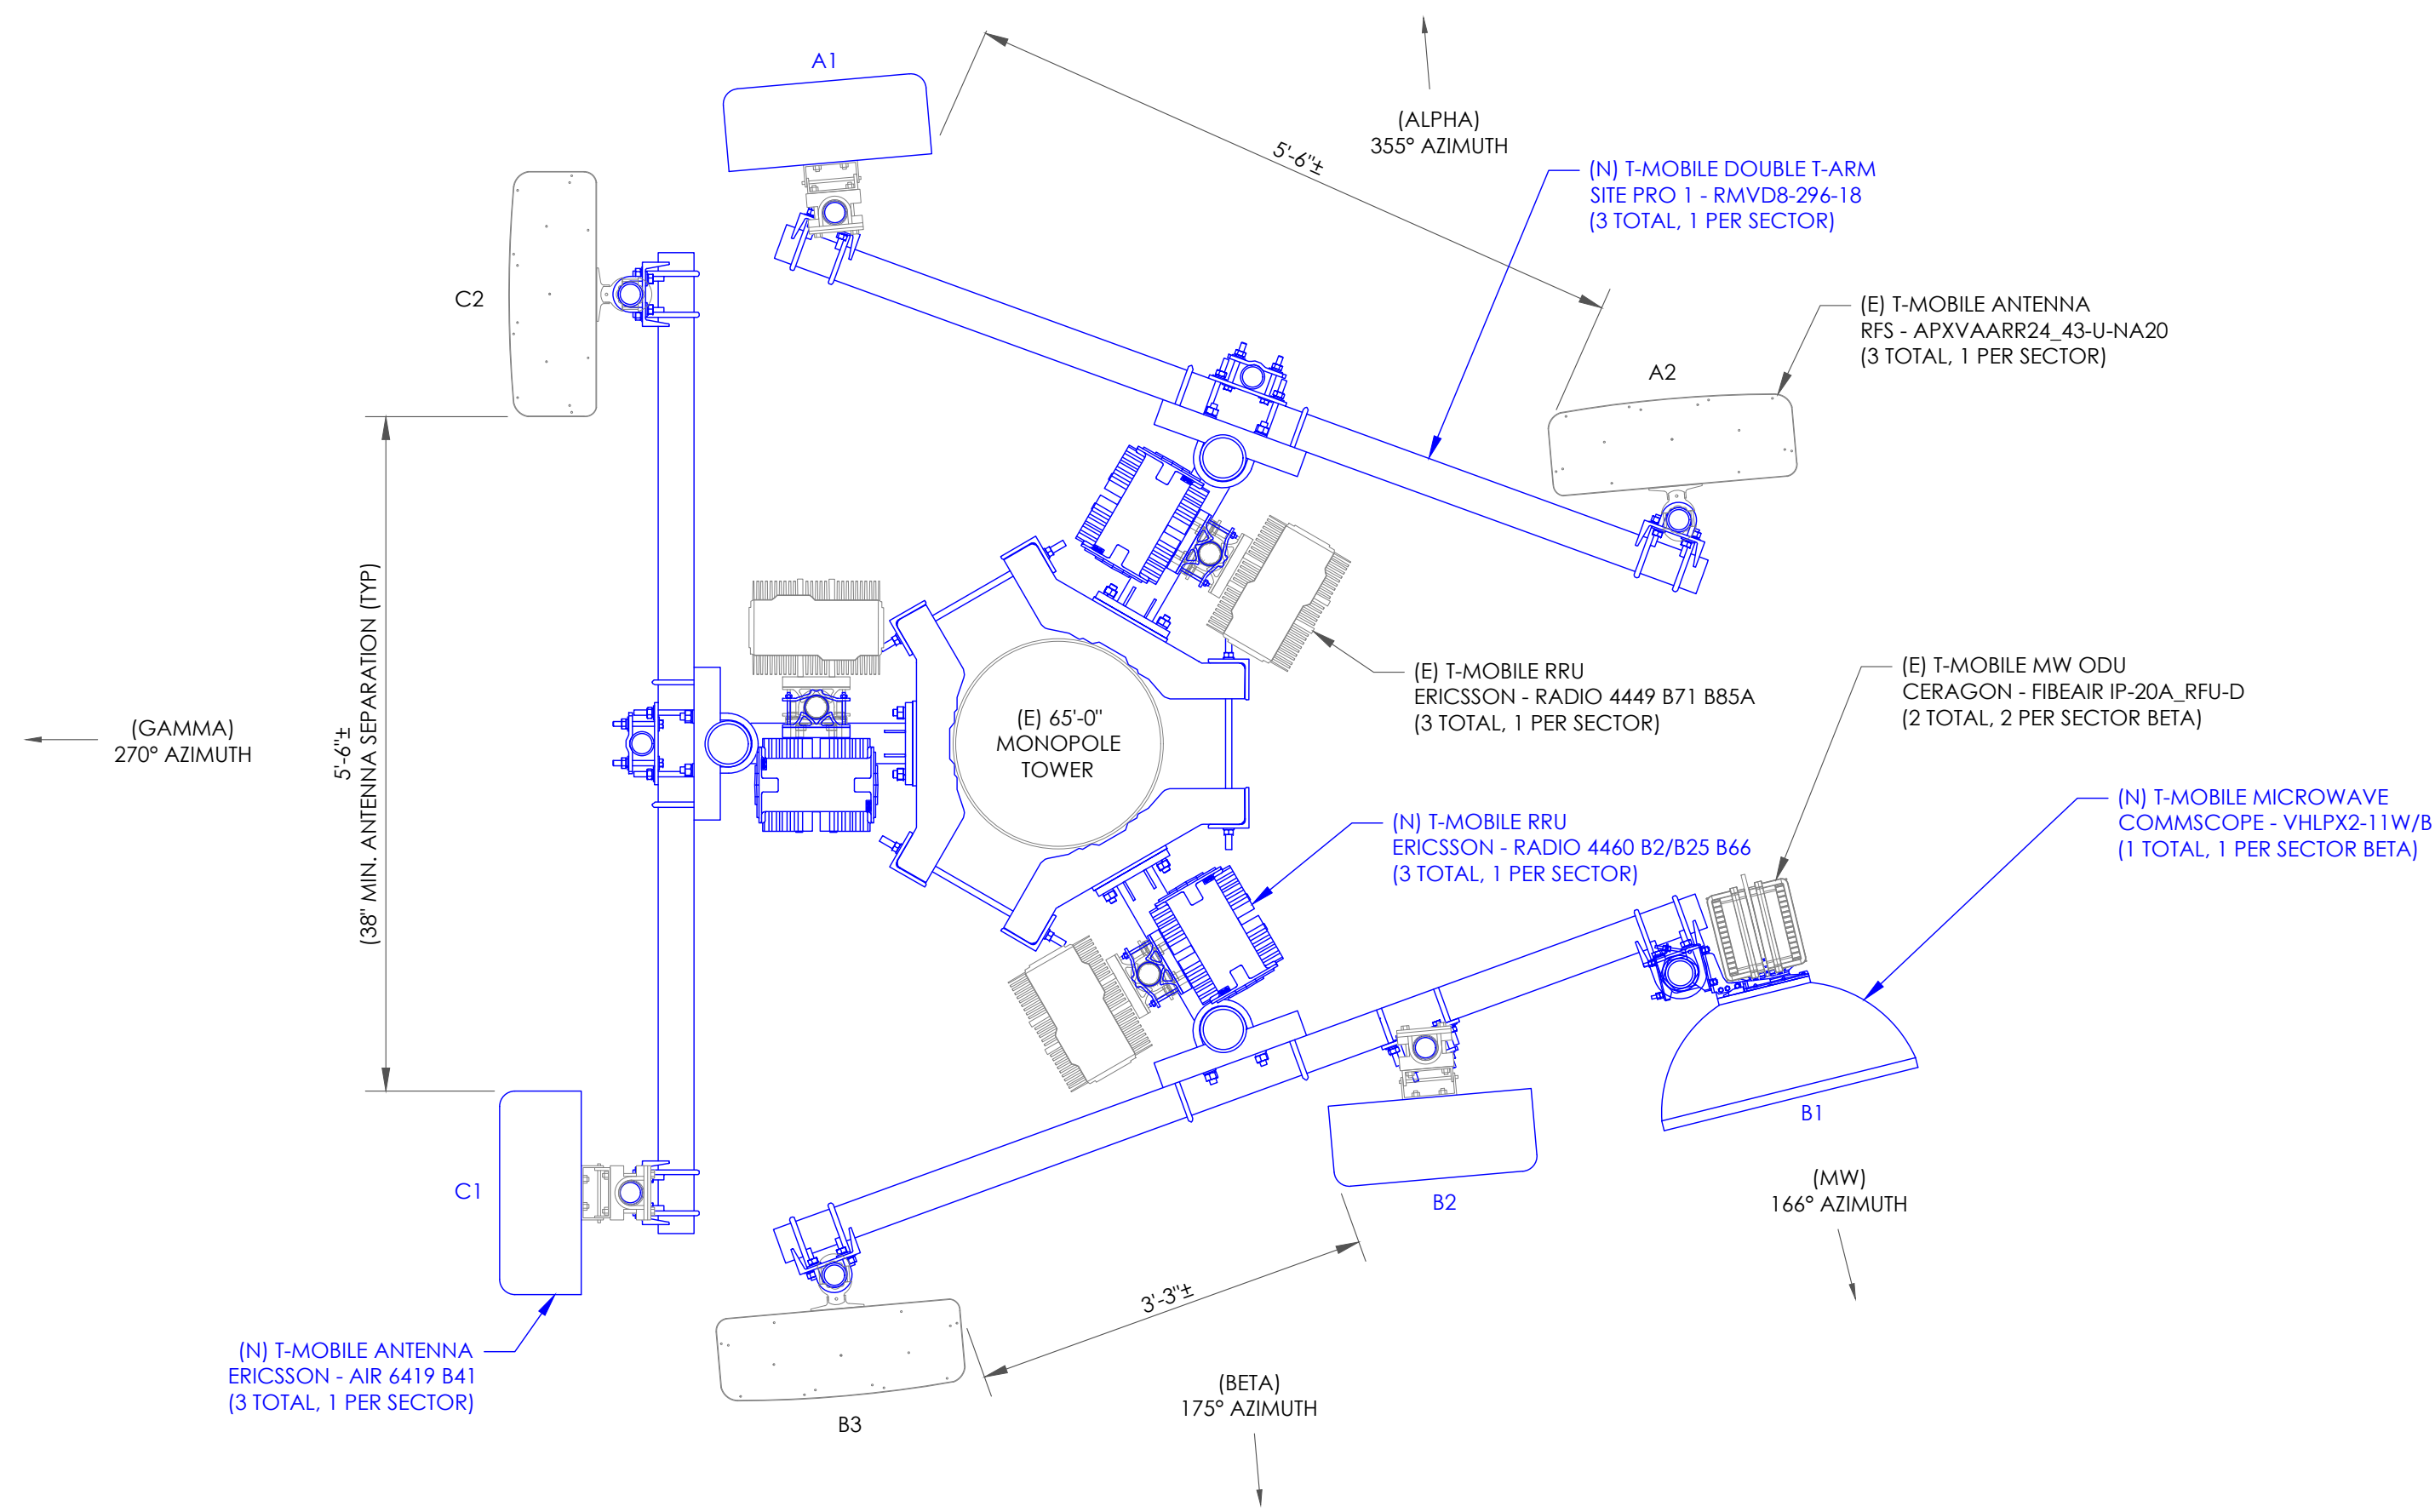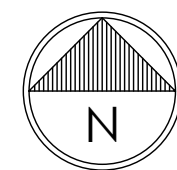

"LOOK UP" - CROWN CASTLE USA INC. SAFETY CLIMB REQUIREMENT:

THE INTEGRITY OF THE SAFETY CLIMB AND ALL COMPONENTS OF THE CLIMBING FACILITY SHALL BE CONSIDERED DURING ALL STAGES OF DESIGN, INSTALLATION, AND INSPECTION. TOWER MODIFICATION, MOUNT REINFORCEMENTS, AND/OR EQUIPMENT INSTALLATIONS SHALL NOT COMPROMISE THE INTEGRITY OR FUNCTIONAL USE OF THE SAFETY CLIMB OR ANY COMPONENTS OF THE CLIMBING FACILITY ON THE STRUCTURE. THIS SHALL INCLUDE, BUT NOT BE LIMITED TO: PINCHING OF THE WIRE ROPE, BENDING OF THE WIRE ROPE FROM ITS SUPPORTS, DIRECT CONTACT OR CLOSE PROXIMITY TO THE WIRE ROPE WHICH MAY CAUSE FRICTIONAL WEAR, IMPACT TO THE ANCHORAGE POINTS IN ANY WAY, OR TO IMPEDE/BLOCK ITS INTENDED USE. ANY COMPROMISED SAFETY CLIMB, INCLUDING EXISTING CONDITIONS MUST BE TAGGED OUT AND REPORTED TO YOUR CROWN CASTLE USA INC. POC OR CALL THE NOC TO GENERATE A SAFETY CLIMB MAINTENANCE AND CONTRACTOR NOTICE TICKET.

NOTES:

1. REFERENCE RFDS FOR FINAL EQUIPMENT SCHEDULE.
2. REFERENCE C-5 FOR NEW EQUIPMENT SPECIFICATIONS.
3. CONTRACTOR TO VERIFY ALL ANTENNA TIP HEIGHTS DO NOT EXCEED BEACON BASE HEIGHT.

STRUCTURAL ANALYSIS & INSTALLATION NOTES:

1. THE DESIGN DEPICTED IN THESE DRAWINGS IS VALID WHEN ACCOMPANIED BY A CORRESPONDING PASSING TOWER ANALYSIS, FOUNDATION ANALYSIS & MOUNT ANALYSIS.
2. CONSTRUCTION MANAGER / GENERAL CONTRACTOR SHALL REVIEW THE MOUNT ANALYSIS FOR ANY CONDITIONS PRIOR TO INSTALLATION.
3. ANY REQUIRED MOUNT MODIFICATION DESIGN OR MOUNT REPLACEMENT SHALL BE APPROVED BY EOR.

T-Mobile

1200 CONCORD AVE., SUITE 500
CONCORD, CA 94520

CROWN CASTLE

1 PARK PLACE, SUITE 300
DUBLIN, CA 94568

PMA

P. MARSHALL & ASSOCIATES
6801 PORTWEST DR. STE 100,
HOUSTON, TX 77024
OFFICE 713-677-0964

T-MOBILE SITE NUMBER:
SF40959A

BU #: 857683

CROWN: AT&T NEW
POTTER VALLEY

12531 EEL RIVER ROAD
POTTER VALLEY, CA 95469

EXISTING 65'-0" MONOPOLE

ISSUED FOR:

REV	DATE	DRWN	DESCRIPTION	DES/QA
A	12/20/23	AW	PRELIMINARY	HS
0	01/31/24	SM	FINAL CD	HS



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SHEET NUMBER: C-3
REVISION: 0



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CONCORD, CA 94520



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DUBLIN, CA 94568



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6801 PORTWEST DR. STE 100,
HOUSTON, TX 77024
OFFICE 713-677-0964

T-MOBILE SITE NUMBER:
SF40959A

BU #: 857683

**CROWN: AT&T NEW
POTTER VALLEY**

**12531 EEL RIVER ROAD
POTTER VALLEY, CA 95469**

EXISTING 65'-0" MONOPOLE

ISSUED FOR:

REV	DATE	DRWN	DESCRIPTION	DES./QA
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0	01/31/24	SM	FINAL CD	HS



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**PROJECT NUMBER:
23CCTCAM-127**

SHEET NUMBER: C-4 **REVISION: 0**

**EXISTING EQUIPMENT SCHEDULE
(VERIFY WITH CURRENT RFDS)**

ALPHA																		
POSITION	ANTENNA				RADIO				DIPLER		TMA		SURGE PROTECTION		CABLES			
	TECH.	STATUS/MANUFACTURER MODEL	AZIMUTH	RAD CENTER	QTY.	STATUS/MODEL	LOCATION	QTY.	STATUS	LOCATION	QTY.	STATUS/MODEL	QTY.	STATUS/MODEL	QTY.	STATUS/TYPE	SIZE	LENGTH
A1	L1900/ L2100/ G1900	(E) RFS - APXV18-206516S-C-A20	340°	54'-0"	-	-	-	-	-	-	2	(E) COMMSCOPE STYLE 4 - ETM19V2S12UB (E15S09P84)	-	-	2	COAX CABLES	7/8"	105'
A2	L700/ N600	(E) RFS - APXVAARR24_43-U-NA20	340°	54'-0"	1	(E) RADIO 4449 B71 B85A	A2	-	-	-	-	-	-	-	1	6X12 HCS	1-3/8"	30M
BETA																		
B1	L1900/ L2100/ G1900	(E) RFS - APXVAARR24_43-U-NA20	150°	54'-0"	1	(E) RADIO 4449 B71 B85A	B1	-	-	-	-	-	-	-	-	SHARED 6X12 HCS	-	-
B2	L2100/ G1900	(E) RFS - APXV18-206516S-C-A20	150°	54'-0"	-	-	-	-	-	-	2	(E) COMMSCOPE STYLE 4 - ETM19V2S12UB (E15S09P84)	-	-	2	COAX CABLES	7/8"	105'
B3	-	(E) COMMSCOPE - VHLPX4-11W	166°	54'-0"	2	(E) FIBEAIR IP-20A_RFU-D	B3	-	-	-	-	-	-	-	1 1	POWER CABLE FIBER CABLE	21/64" 7/32"	105' 105'
GAMMA																		
C1	L1900/ L2100/ G1900	(E) RFS - APXV18-206516S-C-A20	245°	54'-0"	-	-	-	-	-	-	2	(E) COMMSCOPE STYLE 4 - ETM19V2S12UB (E15S09P84)	-	-	2	COAX CABLES	7/8"	105'
C2	L700/ N600	(E) RFS - APXVAARR24_43-U-NA20	245°	54'-0"	1	(E) RADIO 4449 B71 B85A	C2	-	-	-	-	-	-	-	-	SHARED 6X12 HCS	-	-



1200 CONCORD AVE., SUITE 500
CONCORD, CA 94520



1 PARK PLACE, SUITE 300
DUBLIN, CA 94568



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HOUSTON, TX 77024
OFFICE 713-677-0964

T-MOBILE SITE NUMBER:
SF40959A

BU #: 857683

**CROWN: AT&T NEW
POTTER VALLEY**

**12531 EEL RIVER ROAD
POTTER VALLEY, CA 95469**

EXISTING 65'-0" MONOPOLE

ISSUED FOR:

REV	DATE	DRWN	DESCRIPTION	DES./QA
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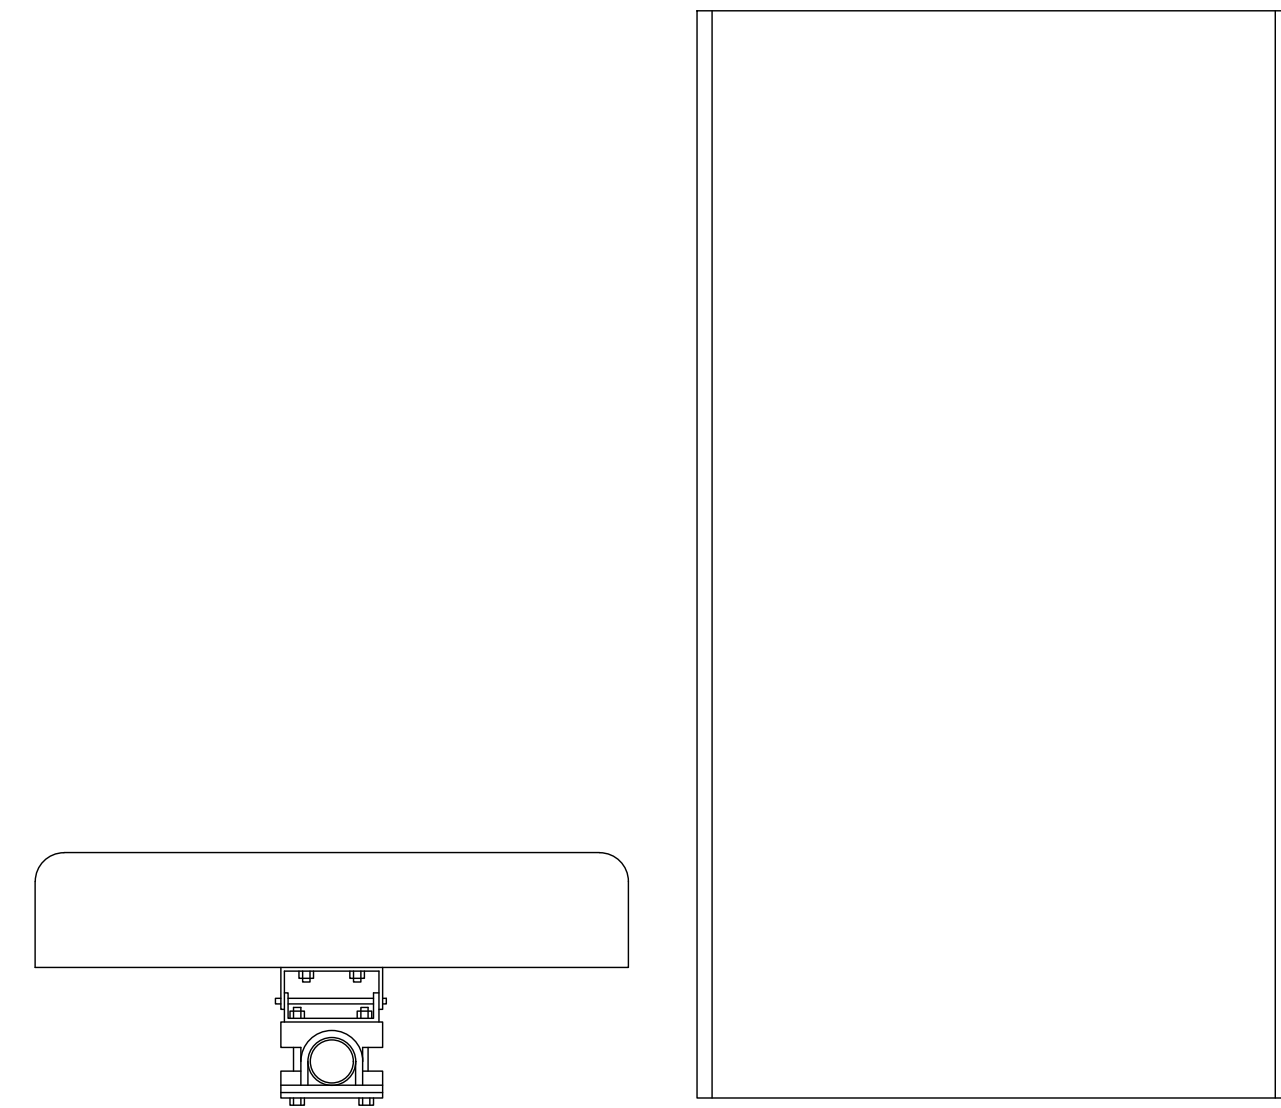
**PROJECT NUMBER:
23CCTCAM-127**

SHEET NUMBER: C-4.1 **REVISION: 0**

**FINAL EQUIPMENT SCHEDULE
(VERIFY WITH CURRENT RFDS)**


ALPHA																		
POSITION	ANTENNA				RADIO				DIPLEXER		TMA		SURGE PROTECTION		CABLES			
	TECH.	STATUS/MANUFACTURER MODEL	AZIMUTH	RAD CENTER	QTY.	STATUS/MODEL	LOCATION	QTY.	STATUS	LOCATION	QTY.	STATUS/MODEL	QTY.	STATUS/MODEL	QTY.	STATUS/TYPE	SIZE	LENGTH
A1	N2500	(N) ERICSSON - AIR 6419 B41	355°	54'-0"	-	-	-	-	-	-	-	-	-	-	1	(N) 6X24 HCS	1-5/8"	30M
A2	L700/ N600/ L2100/ L1900/ G1900/ N1900	(E) RFS - APXVAARR24_43-U-NA20	355°	54'-0"	1 1	(E) RADIO 4449 B71 B85A (N) RADIO 4460 B2 B25 B66	A2	-	-	-	-	-	-	-	1 1	(E) 6X12 HCS (N) 6X24 HCS	1-3/8" 1-5/8"	30M 30M
BETA																		
B1	-	(N) COMMSCOPE - VHLPX2-11W/B	166°	54'-0"	2	(E) FIBEAIR IP-20A_RFU-D	B1	-	-	-	-	-	-	-	1 1	(E) POWER CABLE (E) FIBER CABLE	21/64" 7/32"	105' 105'
B2	N2500	(N) ERICSSON - AIR 6419 B41	175°	54'-0"	-	-	-	-	-	-	-	-	-	-	-	(N) SHARED 6X24 HCS	-	-
B3	L700/ N600/ L2100/ L1900/ G1900/ N1900	(E) RFS - APXVAARR24_43-U-NA20	175°	54'-0"	1 1	(E) RADIO 4449 B71 B85A (N) RADIO 4460 B2 B25 B66	B3	-	-	-	-	-	-	-	-	(E) SHARED 6X12 HCS (N) SHARED 6X24 HCS	-	-
GAMMA																		
C1	N2500	(N) ERICSSON - AIR 6419 B41	270°	54'-0"	-	-	-	-	-	-	-	-	-	-	-	(N) SHARED 6X24 HCS	-	-
C2	L700/ N600/ L2100/ L1900/ G1900/ N1900	(E) RFS - APXVAARR24_43-U-NA20	270°	54'-0"	1 1	(E) RADIO 4449 B71 B85A (N) RADIO 4460 B2 B25 B66	C2	-	-	-	-	-	-	-	-	(E) SHARED 6X12 HCS (N) SHARED 6X24 HCS	-	-

NOTES:
(E) - EXISTING
(N) - NEW



ERICSSON - AIR 6419 B41
 WEIGHT (WITHOUT MOUNTING HARDWARE): 81.84 LBS
 SIZE (HxWxD): 34.49x19.92x7.99IN.

1 ERICSSON - AIR 6419 B41
 SCALE: NOT TO SCALE

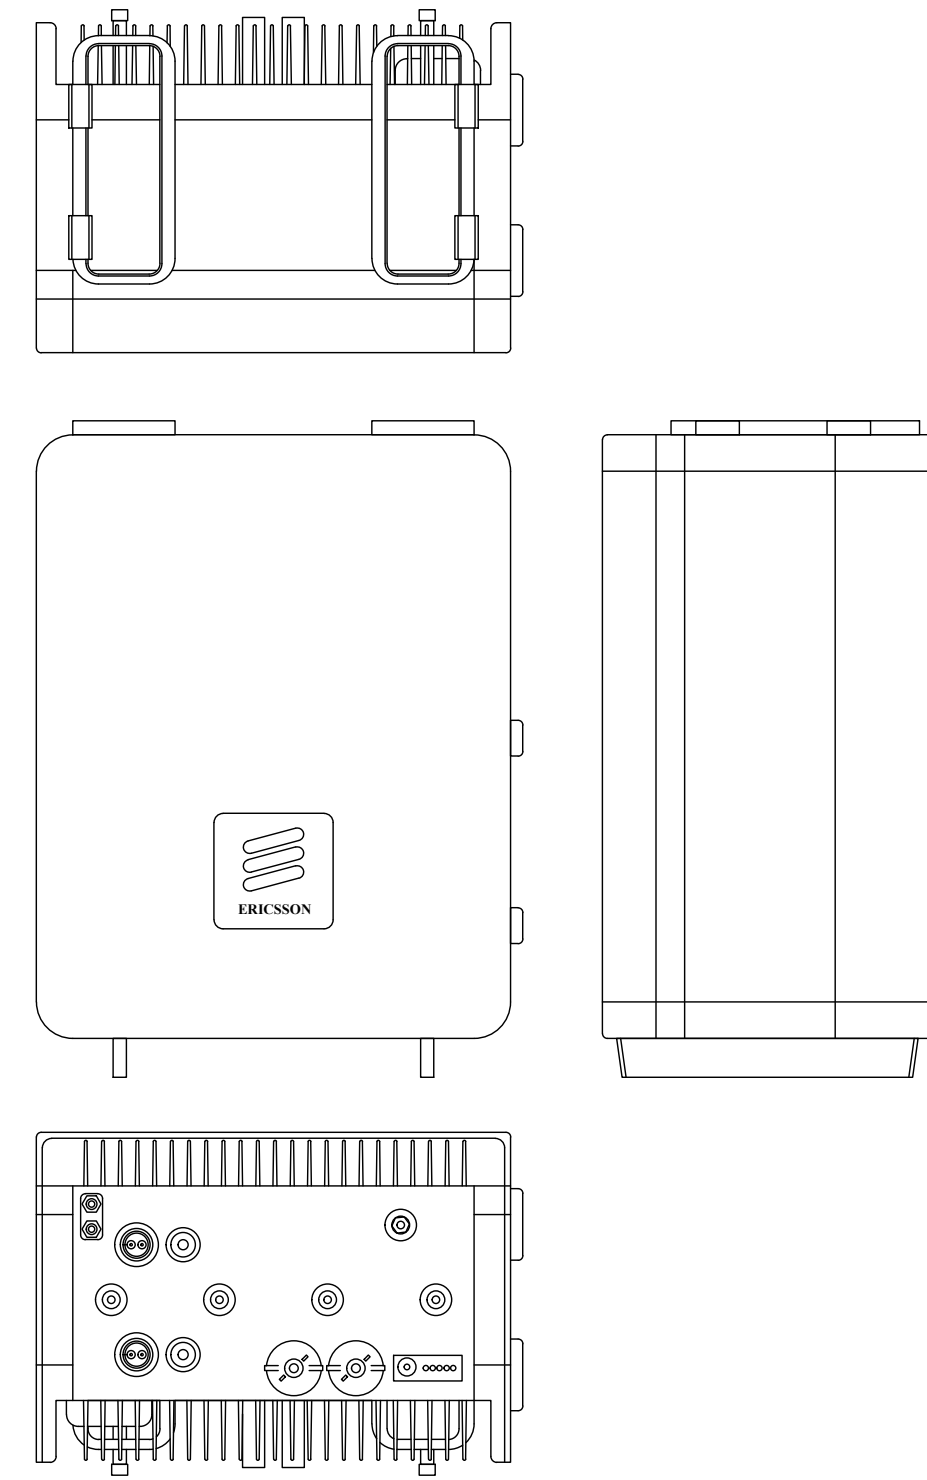


ERICSSON - RADIO 4460 B25+B66
 WEIGHT: 109.0 LBS
 SIZE (HxWxD): 17.0x15.1x11.9 IN.

2 ERICSSON - RADIO 4460 B25+B66
 SCALE: NOT TO SCALE

INSTALLER NOTES:

1. COMPLY WITH MANUFACTURERS INSTRUCTIONS TO ENSURE THAT ALL RRU'S RECEIVE ELECTRICAL POWER WITHIN 24 HOURS OF BEING REMOVED FROM THE MANUFACTURER'S PACKAGING.
2. DO NOT OPEN RRU PACKAGES IN THE RAIN.
3. ALL PIPES, BRACKETS, AND MISCELLANEOUS HARDWARE TO BE GALVANIZED UNLESS NOTED OTHERWISE.

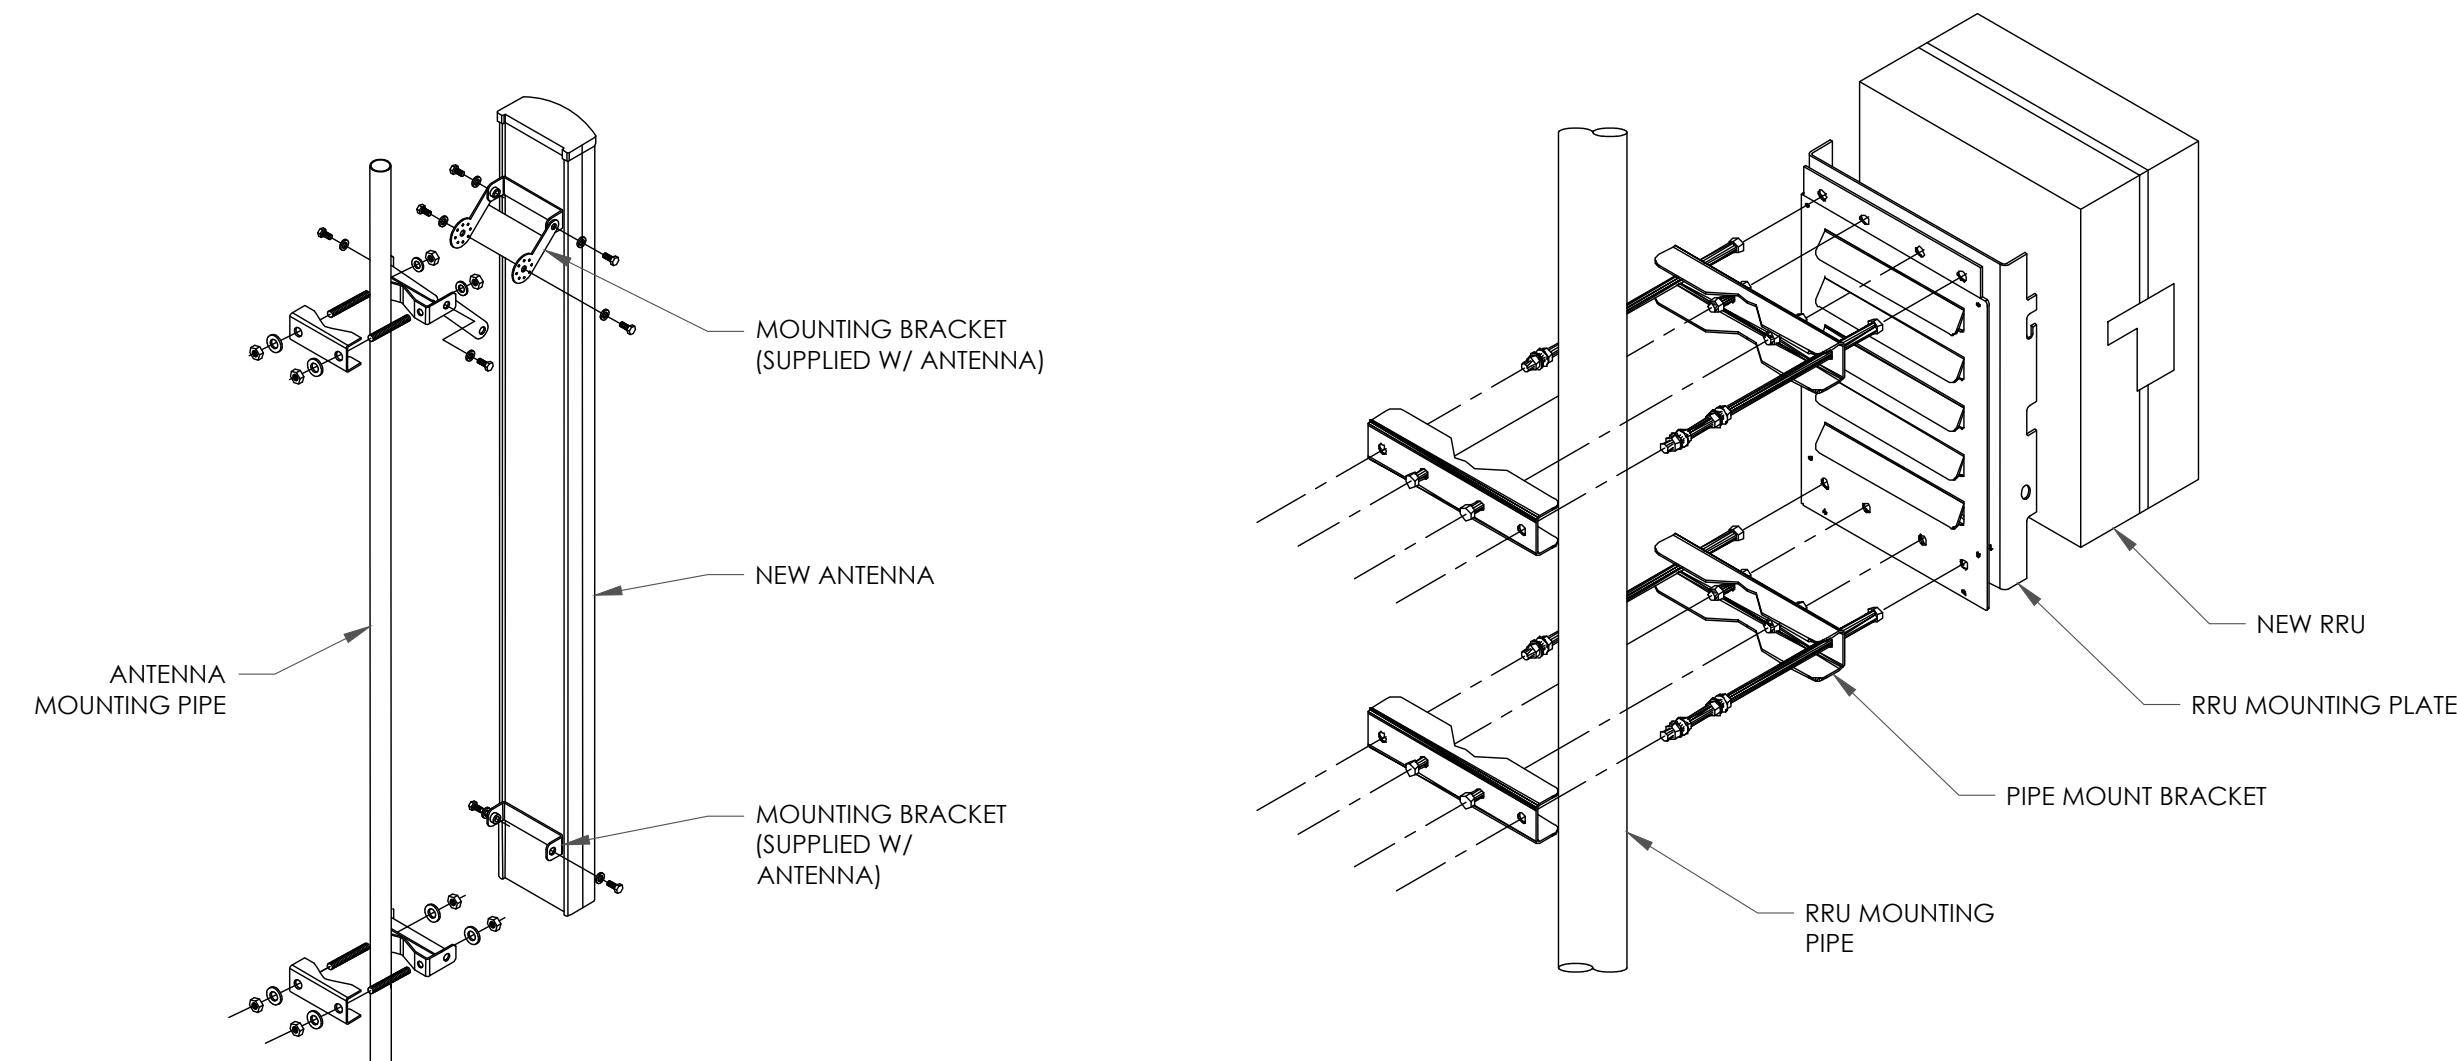

3 ANTENNA & RRU MOUNTING DETAIL
 SCALE: NOT TO SCALE

T-Mobile

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CROWN CASTLE

1 PARK PLACE, SUITE 300
 DUBLIN, CA 94568

PM&A

P. MARSHALL & ASSOCIATES
 6801 PORTWEST DR. STE 100,
 HOUSTON, TX 77024
 OFFICE 713-677-0964

T-MOBILE SITE NUMBER:
 SF40959A

BU #: 857683

**CROWN: AT&T NEW
 POTTER VALLEY**

**12531 EEL RIVER ROAD
 POTTER VALLEY, CA 95469**

EXISTING 65'-0" MONOPOLE

ISSUED FOR:

REV	DATE	DRWN	DESCRIPTION	DES./QA
A	12/20/23	AW	PRELIMINARY	HS
0	01/31/24	SM	FINAL CD	HS



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**PROJECT NUMBER:
 23CCTCAM-127**

SHEET NUMBER: REVISION:

C-5

0

VHLPX2-11W/B



0.6m | 2 ft ValuLine® High Performance Antenna, dual polarized, 10.000 – 11.700 GHz

Product Classification

Product Type Microwave antenna
Product Brand ValuLine®

General Specifications

Antenna Type VHLPX - ValuLine® High Performance Low Profile Antenna, dual-polarized
Polarization Dual
Side Struts, Included 0
Side Struts, Optional 0

Dimensions

Diameter, nominal 0.6 m | 2 ft

Electrical Specifications

Operating Frequency Band 10.000 – 11.700 GHz
Gain, Low Band 33.7 dBi
Gain, Mid Band 34.5 dBi
Gain, Top Band 35.2 dBi
Boresite Cross Polarization Discrimination (XPD) 30 dB
Front-to-Back Ratio 61 dB
Beamwidth, Horizontal 3.3 °
Beamwidth, Vertical 3.3 °
Return Loss 17.7 dB
VSWR 1.3
Radiation Pattern Envelope Reference (RPE) 7212B | 7213B
Electrical Compliance ACMA FX03_10b | ACMA FX03_11b | Brazil Anatel Class 3 | Canada SRSP 310.7 Part B | ETSI 302 217 Class 3 | US FCC Part 101A | US FCC Part 101B


Page 1 of 4

VHLPX2-11W/B

Mechanical Specifications

Compatible Mounting Pipe Diameter 48 mm–120 mm | 1.9 in–4.7 in
Fine Azimuth Adjustment Range ±15°
Fine Elevation Adjustment Range ±15°
Wind Speed, operational 201 km/h | 124.896 mph
Wind Speed, survival 252 km/h | 156.585 mph

Antenna Dimensions and Mounting Information

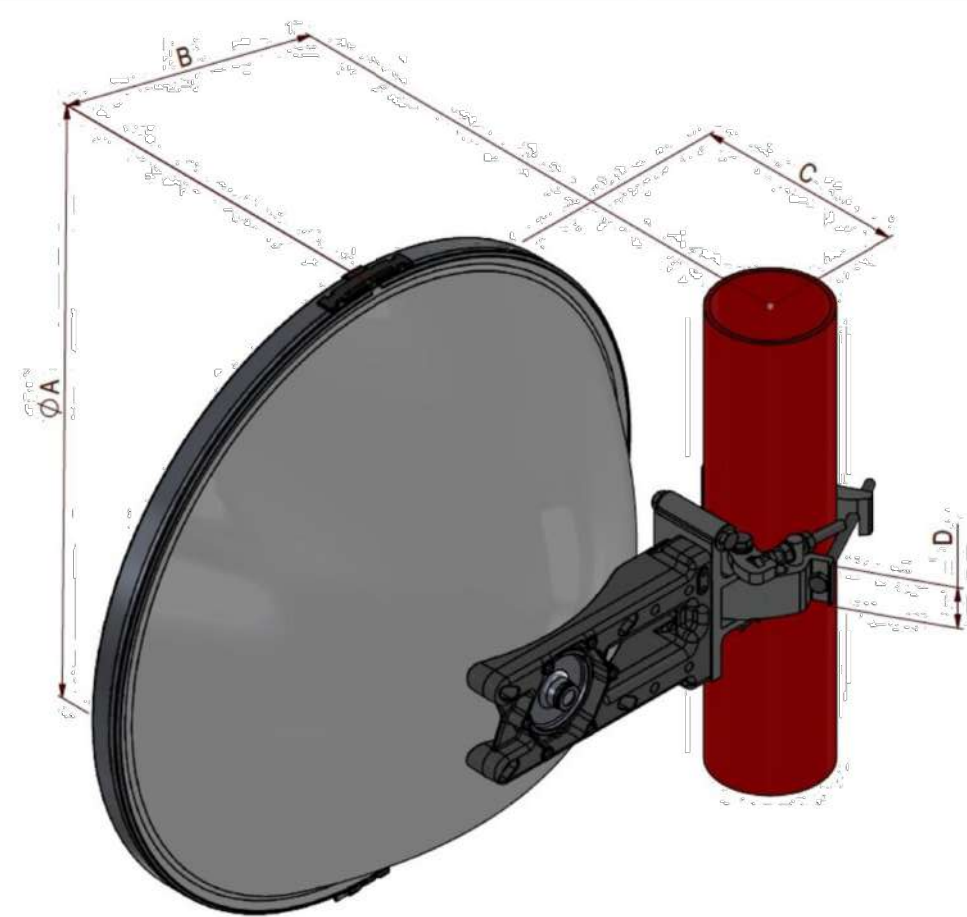

Antenna Size, ft (m)	Dimensions in Inches (mm)			
	A	B	C	D
2 (0.6)	25.9 (660)	12.2 (310)	8.9 (226)	1.8 (45)

Wind Forces at Wind Velocity Survival Rating


Axial Force (FA) 1400 N | 314.733 lbf

Page 2 of 4

VHLPX2-11W/B

Angle α for MT Max -50 °
Side Force (FS) -350 N | -78.683 lbf
Twisting Moment (MT) 500 N-m | 4,425.373 in lb
Zcg without Ice 55 mm | 2.165 in
Zcg with 1 in (25 mm) Radial Ice 91 mm | 3.583 in
Weight with 1 in (25 mm) Radial Ice 20 kg | 44.092 lb

Wind Forces at Wind Velocity Survival Rating Image

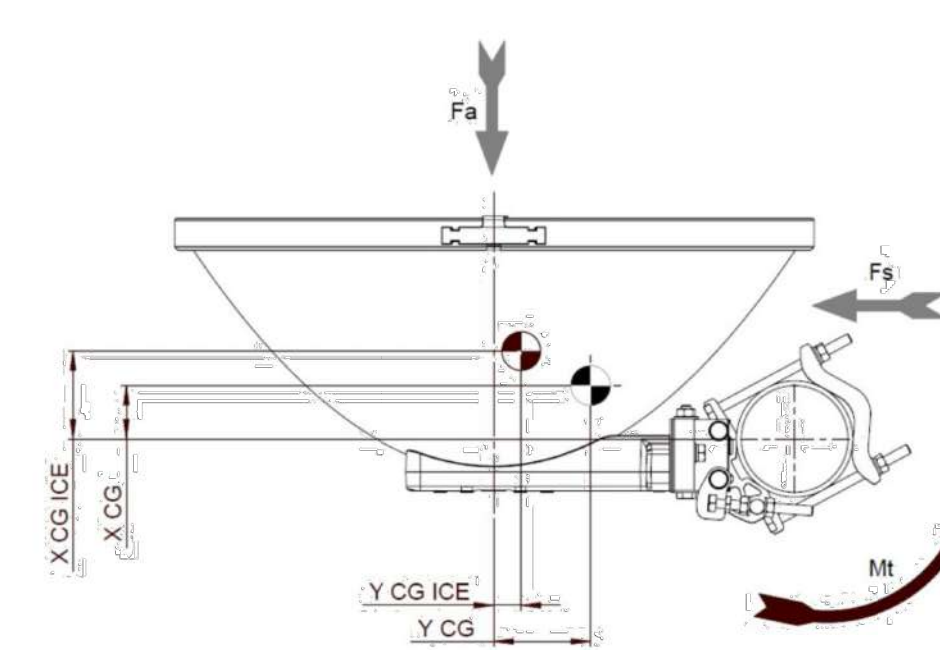

Packaging and Weights

Weight, net 5.75 kg | 12.677 lb

Regulatory Compliance/Certifications

Agency ISO 9001:2015
Classification Designed, manufactured and/or distributed under this quality management system



* Footnotes

Operating Frequency Band Bands correspond with CCIR recommendations or common allocations

Page 3 of 4

T-Mobile

1200 CONCORD AVE., SUITE 500
CONCORD, CA 94520

CROWN CASTLE

1 PARK PLACE, SUITE 300
DUBLIN, CA 94568

PM&A

P. MARSHALL & ASSOCIATES
6801 PORTWEST DR. STE 100,
HOUSTON, TX 77024
OFFICE 713-677-0964

T-MOBILE SITE NUMBER:
SF40959A

BU #: 857683

CROWN: AT&T NEW
POTTER VALLEY

12531 EEL RIVER ROAD
POTTER VALLEY, CA 95469

EXISTING 65'-0" MONOPOLE

ISSUED FOR:

REV	DATE	DRWN	DESCRIPTION	DES./QA
A	12/20/23	AW	PRELIMINARY	HS
0	01/31/24	SM	FINAL CD	HS



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PROJECT NUMBER:
23CCTCAM-127

SHEET NUMBER: C-6 REVISION: 0

EQUIPMENT NOTES:
 HEIGHTxWIDTHxDEPTH: 63.0" x 26.0" x 34.0"
 WEIGHT (EMPTY): 320 LBS
 WEIGHT (FULLY LOADED W/ BATTERIES): 1500 LBS


RACK ASSIGNMENT		
RACK	RUSLOT	DESCRIPTION
FULL RACK	1	
	2	RECTIFIER SHELF
	3	
	4	
	5	RECTIFIER
	6	
	7	FIBER BOX
	8	DCDU
	9	CSR/IXR-e
	10	
	11	1ST BASEBAND
	12	2ND BASEBAND
	13	3RD BASEBAND
	14	4TH BASEBAND
	15	5TH BASEBAND
	16	6TH BASEBAND
	17	7TH BASEBAND
	18	8TH BASEBAND
	19	
	20	LEGACY BASEBAND
	21	
	22	PSU 4813
	23	
	24	
	25	

2" KNOCKOUTS WITH LBS FOR ALARM CABLE AND TEMP SENSOR ROUTING. UPPER REAR CENTER WORK BEST FOR THIS INSTALL FOR EASE OF INSTALL AND REPLACEMENT IN THE EVENT OF FAILURE. CONDUIT MUST BE PROPERLY SECURED TO PREVENT DAMAGE TO CABINETS AND OR CABLING


2" KNOCKOUTS WITH RIGID CONDUIT AND LB FOR 3/0 BATTERY CABLE INSTALL, AND AUX POWER CABLE. OUTSIDE KNOCKOUTS WORK BEST FOR EASE OF INSTALL

2" KNOCKOUTS FOR AAV AND FIBER ROUTING BETWEEN MACRO CABINETS ON SITE. LB WITH RIGID CONDUIT IS PREFERRED.

2" KNOCKOUTS AT LOWER REAR OF THE CABINET INTENDED FOR HYBRID/MLE CABLES

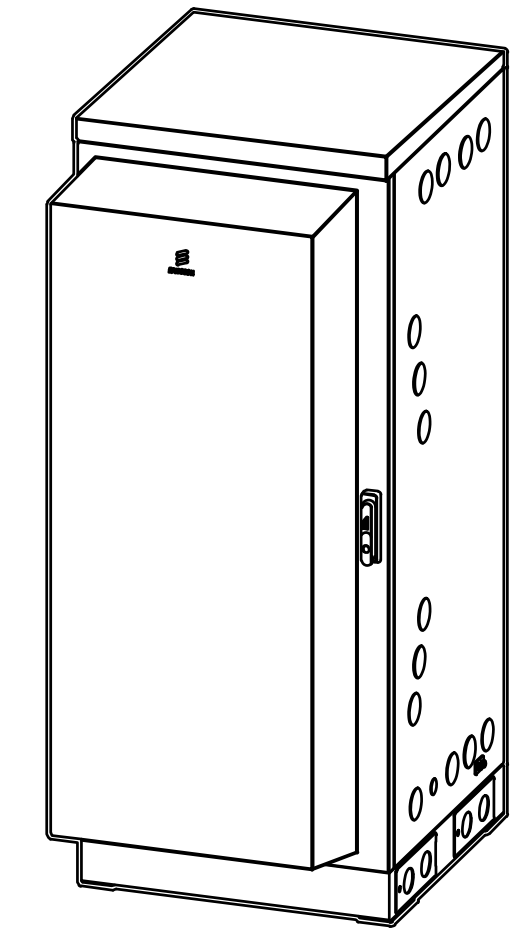


ISO VIEW

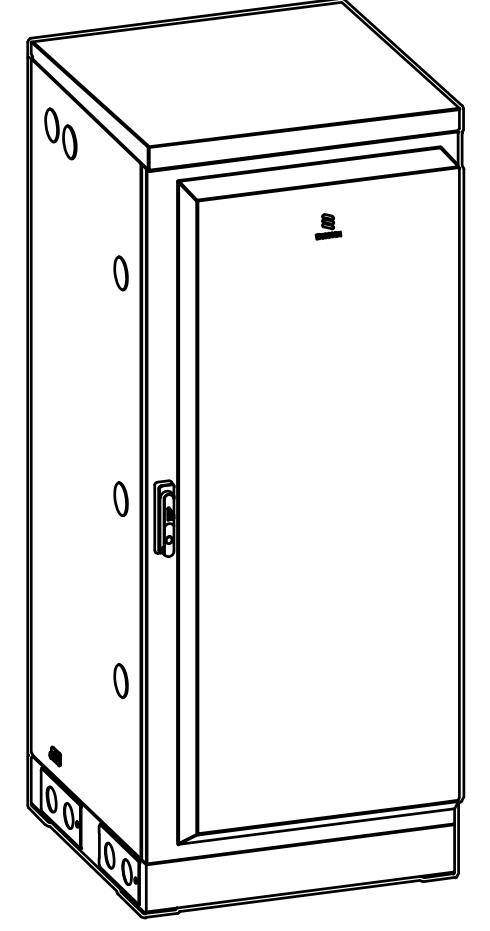


ISO VIEW


EQUIPMENT NOTES:
 HEIGHTxWIDTHxDEPTH: 63.0" x 26.0" x 28.0"
 (1600.0mm x 660.0mm x 711.0mm)
 WEIGHT (EMPTY): 295 LBS (134 kg)
 WEIGHT (FULLY LOADED W/ BATTERIES): 2000 LBS (908 kg)

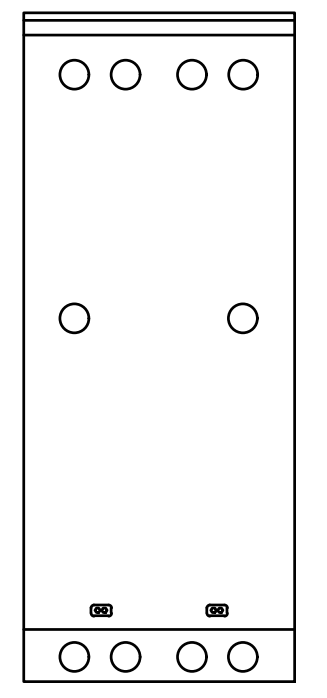


REAR VIEW

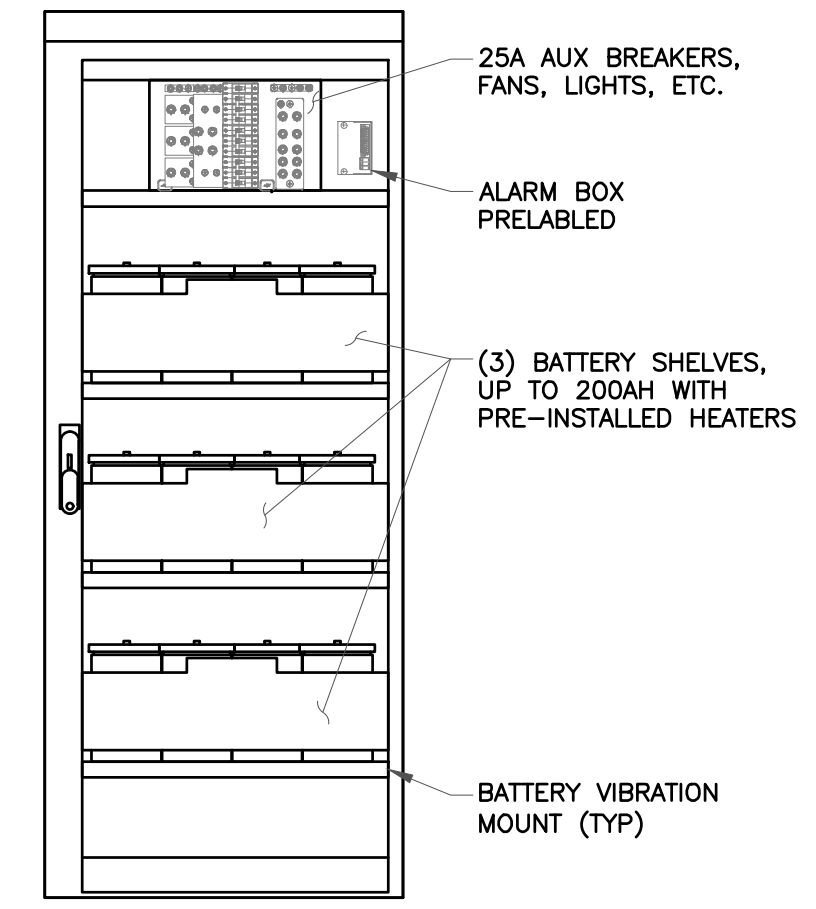


FRONT VIEW OPEN

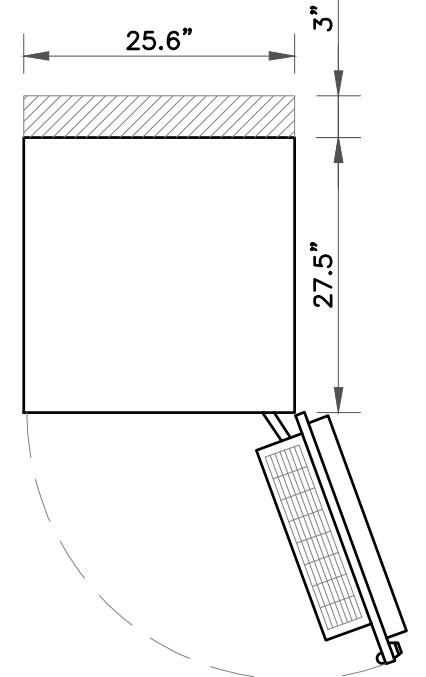


PLAN VIEW

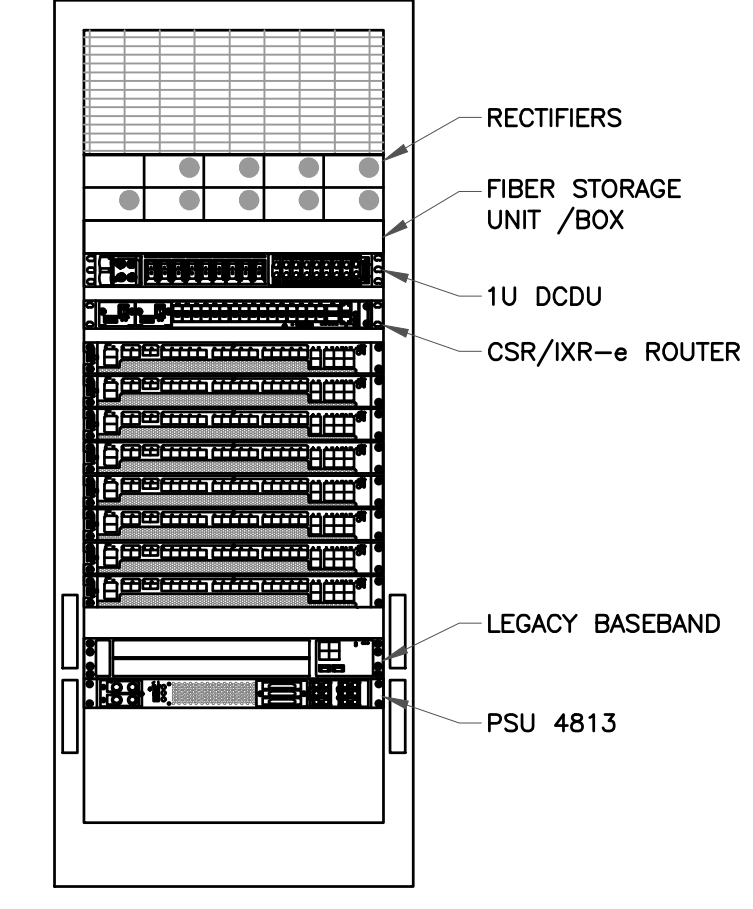


FRONT VIEW OPEN

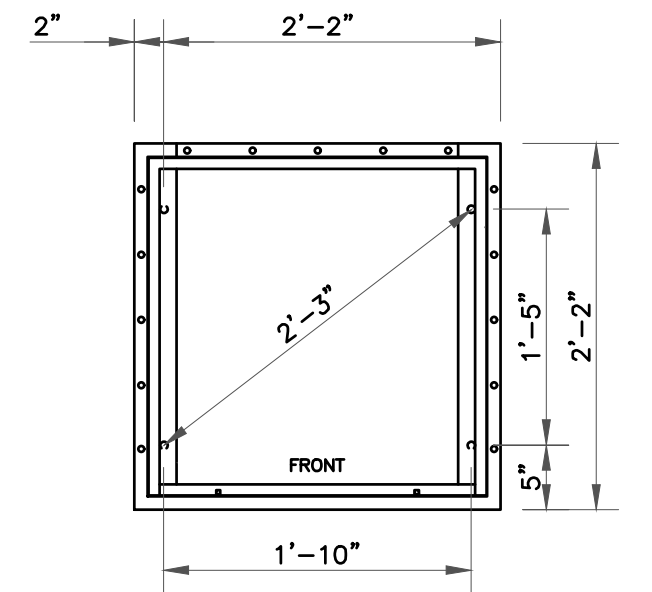


FRONT

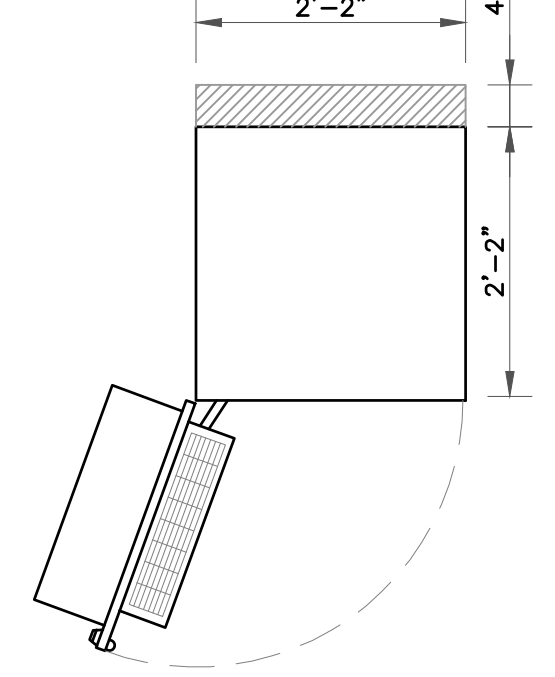


PLAN VIEW

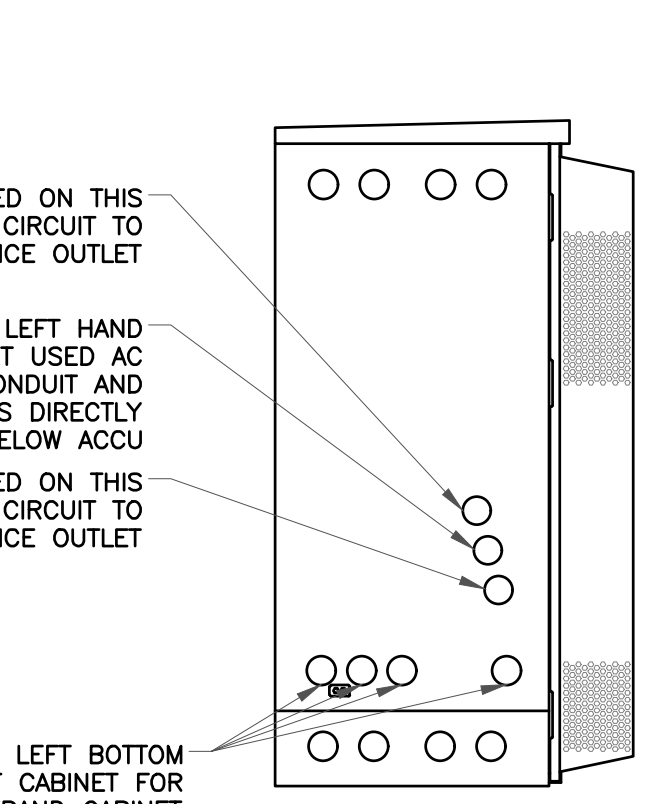

LEFT VIEW

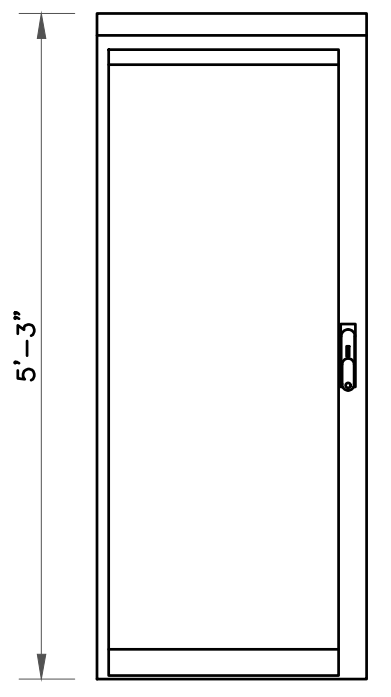

FRONT VIEW

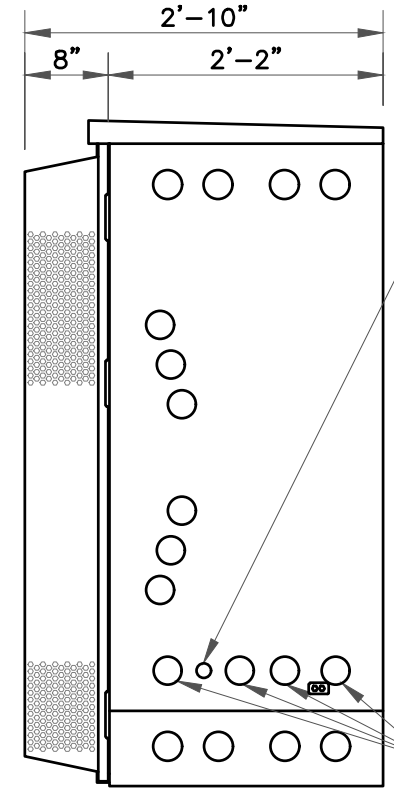

RIGHT VIEW

2" KNOCKOUT, UNUSED ON THIS SITE FOR DEDICATED CIRCUIT TO SERVICE OUTLET

2" KNOCKOUT ON LEFT HAND SIDE OF CABINET USED AC POWER, WITH RIGID CONDUIT AND LR. PENETRATION IS DIRECTLY BELOW ACCU

2" KNOCKOUT, UNUSED ON THIS SITE FOR DEDICATED CIRCUIT TO SERVICE OUTLET

2" KNOCKOUT ON LEFT BOTTOM SIDE OF CABINET FOR INTER-BASEBAND CABINET CONNECTINO. A RIGID OR FLEXIBLE CONDUIT WITH AN LR WILL BE USED WHEN RUNNING THIS CONDUIT TO THE LEGACY 6131, 6102, ODE OR MUAC CABINET.

DEDICATED 1" FOR GNSS/GPS KNOCKOUT ON RIGHT HAND SIDE OF THE CABINET, RECOMMEND USING LL, RATHER THAN LB OR 90 DUE TO CLOSE PROXIMITY TO B160 BATTERY CABINET. 4" RIGID OR FLEX CONDUIT MAY BE USED.

UNUSABLE 2" KNOCKOUTS DUE TO CLOSE PROXIMITY TO B160 CABINET

25A AUX BREAKERS, FANS, LIGHTS, ETC.

ALARM BOX PRELABELED

(3) BATTERY SHELVES, UP TO 200AH WITH PRE-INSTALLED HEATERS

BATTERY VIBRATION MOUNT (TYP)

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 CONCORD, CA 94520

CROWN CASTLE

1 PARK PLACE, SUITE 300
 DUBLIN, CA 94568

PM&A

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T-MOBILE SITE NUMBER:
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0	01/31/24	SM	FINAL CD	HS



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SHEET NUMBER:
 C-7

REVISION:
 0

1 ERICSSON RBS 6160 CABINET
 SCALE: NOT TO SCALE

2 B160 BATTERY CABINET
 SCALE: NOT TO SCALE

T-MOBILE SITE NUMBER:
SF40959A

BU #: 857683
**CROWN: AT&T NEW
POTTER VALLEY**

**12531 EEL RIVER ROAD
POTTER VALLEY, CA 95469**

EXISTING 65'-0" MONOPOLE

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REV	DATE	DRWN	DESCRIPTION	DES./QA
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**PROJECT NUMBER:
23CCTCAM-127**

SHEET NUMBER: **C-8** REVISION: **0**



CHAPTER 12, SECTION 1206					
ELECTRICAL ENERGY STORAGE SYSTEM					
1206.2 SCOPE:					
STATIONARY STORAGE BATTERY SYSTEMS HAVING CAPACITIES EXCEEDING THE VALUES SHOWN IN TABLE 1206.2 SHALL COMPLY W/ SECTION 1206.2.1 THROUGH 1206.2.12.6, AS APPLICABLE.					
BATTERY STORAGE SYSTEM THRESHOLD QTY'S					
BATTERY TECHNOLOGY			CAPACITY ALLOWED		
LEAD ACID, ALL TYPES			70 kWh (252 MEGAJOULES)		
AH = VOLTAGE (AH)/1000					
VOLTS	AH	kWh	NO. OF BATTERIES	TOTAL kWh	
12	210	1000	2.52	12	30.24
CONCLUSIONS:					
30.24	<	70 kWh	SECTION 1206.2 DOES NOT APPLY		
TOTAL BATTERY WEIGHT (12 BATTERIES):					1,699.2 LBS
TOTAL GALLONS - ELECTROLYTE & ACID (12 BATTERIES):					40.8

NSB 210FT RED BATTERY LEAD & ACID WEIGHTS (12-VOLT MODULE):			
ELECTROLYTE	WEIGHT	/KG	12.1
		/LBS	26.5
	VOLUME	/LITERS	9.0
/GALLONS		2.4	
ACID	WEIGHT	/KG	6.8
		/LBS	14.9
	VOLUME	/LITERS	3.7
/GALLONS		1.0	
LEAD	WEIGHT	/KG	19.8
		/LBS	43.6
LEAD OXIDE	VOLUME	/KG	25.7
		/LBS	56.6
TOTAL WEIGHT	WEIGHT	/KG	64.22
		/LBS	141.6

NORTHSTAR NSB BATTERY SPECIFICATIONS											
BATTERY MODEL NUMBER	VOLTAGE	CAPACITY (AH)		NOMINAL DIMENSIONS						NOMINAL WEIGHT	
		8 HR CAPACITY TO 1.75 VPC @ 20/25°C (68/77°F)	10 HR CAPACITY TO 1.80 VPC @ 20/25°C (68/77°F)	INCHES			MILLIMETERS			LBS	Kg
				A	B	C	A	B	C		
NSB 210FT RED	12	200 / 204 AH	204 / 207 AH	22.0	4.96	12.9	558.8	125.98	327.66	141.6	64.22


ELECTRICAL DATA		
BATTERY MODEL NUMBER	SHORT CIRCUIT CURRENT	INTERNAL RESISTANCE (mOhms)
NSB 210FT RED	5400 A	2.8 mΩ @25°C (77°F)

FLOAT VOLTAGE
CONSTANT VOLTAGE CHARGING IS RECOMMENDED
RECOMMENDED FLOAT VOLTAGE @ 20/25°C (68/77°F), 2.28 /2.27 VPC

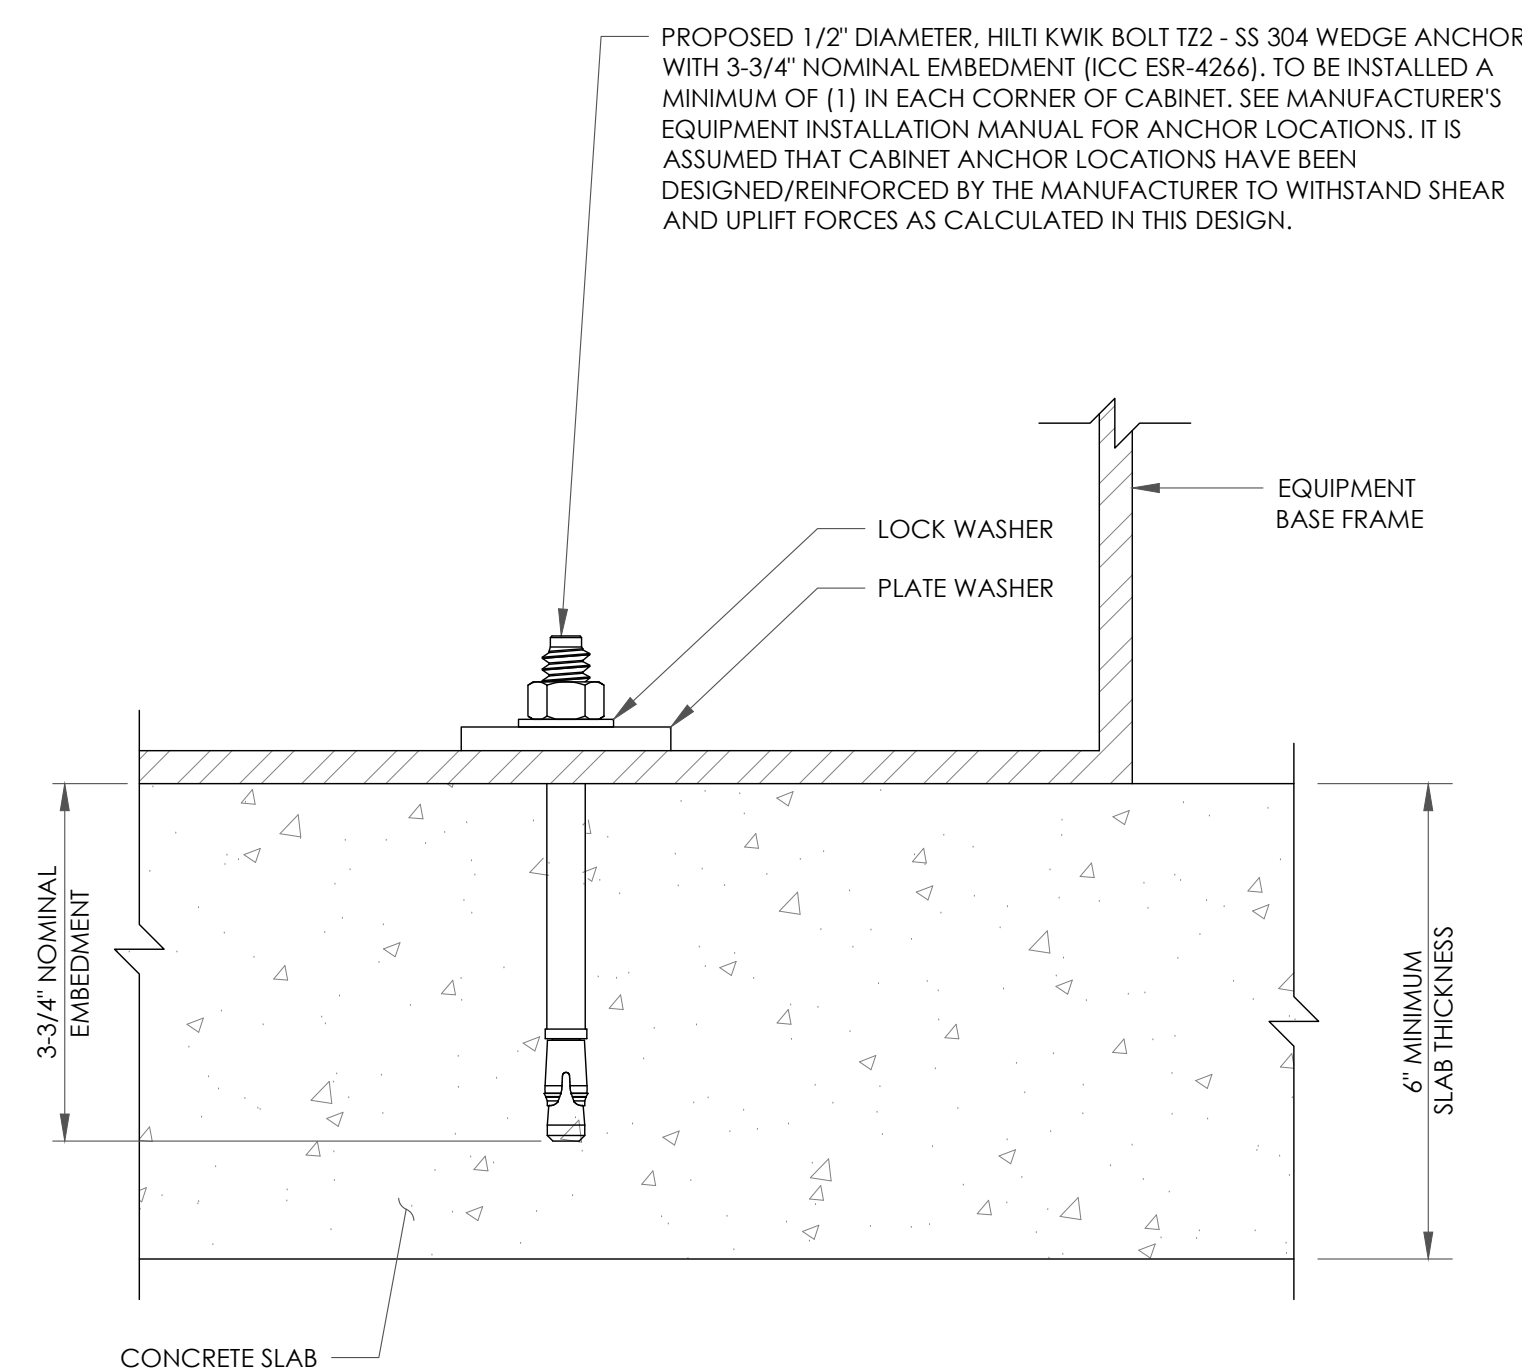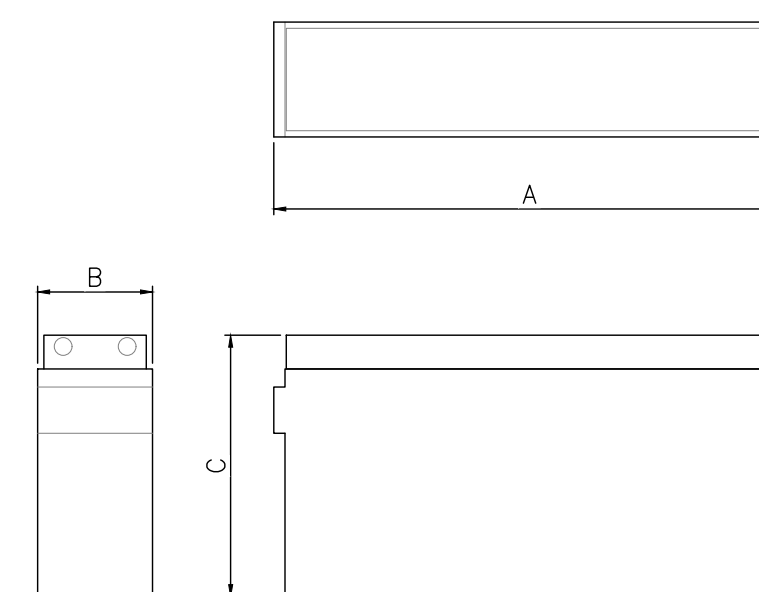


1 CABINET ANCHORAGE DETAIL
SCALE: NOT TO SCALE

2 NORTHSTAR NSB 210FT RED BATTERY SPECS
SCALE: NOT TO SCALE

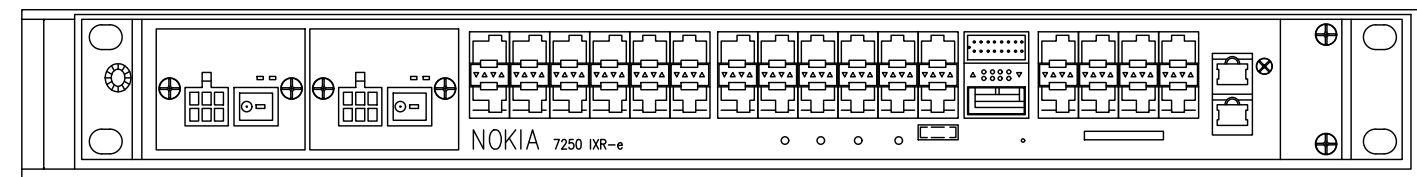

NOKIA CSR IXRE V2 ROUTER
WEIGHT: 11.2 LBS.
SIZE (HxWxD): 1.75x17.25x10.0 IN.

1 NOKIA CSR IXRE V2 ROUTER
SCALE: NOT TO SCALE

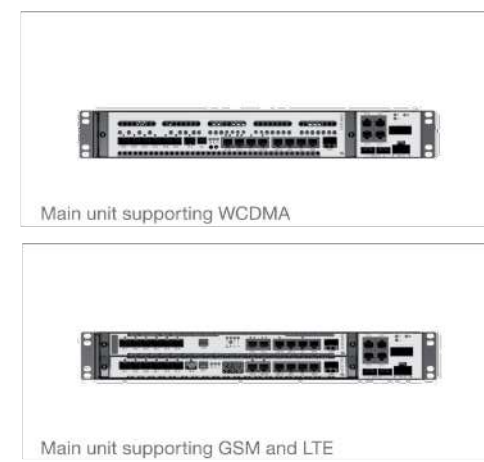

TECHNICAL SPECIFICATIONS
RBS 6601

CONFIGURATIONS
Sectors: 1 to 6 sectors
Carriers/TRXs: 1 to 4 per sector

OUTPUT POWER CLASSES
1x 20, 40, 60 W per RRU01
2x 10, 20, 30 W per RRU11

CAPACITY PER MU
GSM 24 TRXs
WCDMA 12 cell carriers
LTE 3 x 20 MHz (MIMO) dualband

MECHANICAL DIMENSION
MU: 19 inch, 1.5 RU up to 10.5 kg
RRUS 01: 23 liters, 20 kg
RRUS 11: 25 liters, 20 kg

SITE POWER
MU: -48 V DC
RRUS 01/11: -48 V DC / 100-250 V AC

TRANSMISSION
E1/T1/G1
Channelized STM-1
100/1000 Base-T Ethernet

TEMPERATURE RANGE
MU: +5 °C to +50 °C
RRU: -40 °C to +55 °C

The MU can also be installed in an outdoor site support cabinet, SSC-02 or an existing 19-inch rack. The RRU can be installed, indoor or outdoors on poles, walls, or in a tower. The RBS 6601 suits medium to large multi-standard capacity requirements. It supports multi-standard for both single- and dual-band configurations and supports the most common frequency bands.

Since the hardware is separated into small, lightweight units that can be carried to site, a main-remote solution is perfect for sites where any disturbance caused by installation work must be kept to a minimum or for locations where space or access is limited. Main-remote solutions are also ideal for specifically tailored coverage, because the highly flexible RRU can be spread over a very large area. The RBS 6601 suits a wide range of applications, e.g.: rooftop sites, metro and tunnel coverage, in-building solutions and highway coverage.


The minimal feeder loss reduces the need for tower mounted amplifiers, e.g.: TMA, WTMA, or ASC, which reduces capital expenditure.

- Key Features**
- Multi-standard: GSM, WCDMA and LTE support
 - Up to twelve RRU can be connected to one MU
 - Can be installed with zero footprint
 - Multiple power output options, up to 60 W/RRU
 - Available for different frequency bands
 - Supports dual-band configurations
 - 1 Tx and 2 Tx RRU models

Telefonnordbolaget LM Ericsson
SE-162 23 Stockholm, Sweden
Telephone +46 8 719 0000
Fax +46 8 18 40 85
www.ericsson.com

287 01-FGC 101 0071 Rev B
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2 RBS 6601
SCALE: NOT TO SCALE

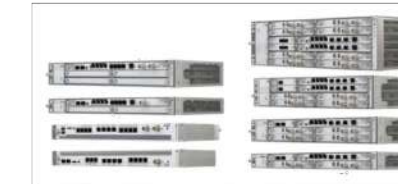

traditional frequencies (6-42 GHz), V-band 60 GHz, E-band 70/80 GHz, single and dual carrier, Coax and Ethernet interface.

Efficient network migration
MINI-LINK 6600 support any network migration from one generation of Radio technology to next on the Road to 5G. There is a topology flexibility in MINI-LINK 6600 to build hop based, tree, stars or ring based topologies to best support the network need.

For cost efficient migration MINI-LINK 6600 is hop compatible with MINI-LINK TN. Upgrading to MINI-LINK 6600, the radio units, antennas, and cabling can be reused.


Technical specification
MINI-LINK 6600

RADIO LINK 940 GHz*	Using MINI-LINK 6353 up to 40950MHz -1.4 Gbps 1+0 in 112 MHz (ETSI) -2 Gbps using 2x RLB in 112 MHz (ETSI)
RADIO LINK 6670/98 GHz*	1 Gbps over 200 MHz using MINI-LINK 6351 10 Gbps over 2000 MHz using MINI-LINK 6352
RADIO LINK	ATPC, Radio Link Bonding, XPC, Adaptive Coding Modulation, Multi-layer Modulation Compression, Multi-band Booster, AES encryption over the hop, 4x4 MIMO
PROTECTION & CONFIGURATION	Up to 2+2 Hot standby and Space Diversity Up to 4+4 Radio Link Bonding (RLB) Up to 4+0 RLB using different CS combinations EWS, RESIP, SNCP Network protection MSP 1+1 Equipment protection
DIMENSIONS (H x W x D)	6651: 44x44x228 mm, 1.7x17.6x9.8 inch 6654: 44x44x240 mm, 1.7x17.6x9.4 inch 6655: 66x44x228 mm, 2.6x17.6x9.8 inch 6691: 44x44x240 mm, 1.7x17.6x9.4 inch 6695: 66x44x228 mm, 2.6x17.6x9.8 inch 6696: 66x44x239 mm, 3.6x17.6x9.4 inch 6692: 133x44x240 mm, 5.2x17.6x9.4 inch
POWER SUPPLY	-48 V DC, Power redundancy
ENERGY EFFICIENCY	Traffic: Active Power Save
POWER CONSUMPTION (EXCLUDING RADIO)	6651/0: 30W 1+0 configuration 6651: 48W 1+0 configuration 6654: 48W 1+0 configuration 6655: 87W 1+0 configuration 6691: 52W 1+0 configuration 6695: 52W 1+0 configuration 6696: 79W 1+0 configuration 6692: 84W 1+0 configuration
OPERATIONAL TEMPERATURE	-25°C to +65°C / -13°F to +149°F -25°C to +60°C / -13°F to +131°F (6651/0)
TRAFFIC INTERFACES	E1, CES, SATAP, 10/100/1000 BASE-T IEEE802.3, Optical 1000BASE-SX/LX/EX/DC, GE, DWDM 10G BASE-LR/ER/ZR, 10GE DWDM
SYNCHRONIZATION	SynE, E-1588v2 (Telecom profile G.8275.1), NTP transparent, E1 and 2MHz, Frequency (G.8265.1)
SWITCHING/ROUTING	IEEE 802.1Q-2011 Customer & Provider Bridge, Bridge Virtual Interface, LAG/LACP, SRP, H-Gate, SRM, MAC Swaps, loopback, VRF, OSPF, iBGP, IS-IS, RSVP-TE FRR, RSP/TE Path Protection, IPMP, S-L3 VPN, LDP, BFD, BGP FRR, MP-BGP, IPv4 ACL
QAM	Link OAM, Service OAM FPM, Y-1731, TWAMP reflector Light
DCN	DCN over VLAN, Routed DCN (OSPF) DCN over VLAN for L1 connection
NETWORK MANAGEMENT	Supported by EMS, IP transport NMS, SensorCN, Node GUI and CLI SNMP v3, SSH, RADIUS, TACACS+
STANDARDS & RECOMMENDATIONS	3GPP, ETSI, ITU, IEEE, IETF


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SE-407 56 Göteborg, Sweden
Telephone +46 10 719 00 00
www.ericsson.com

28701-FGC 101 2880 Rev U
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3 ERICSSON RP 6651
SCALE: NOT TO SCALE

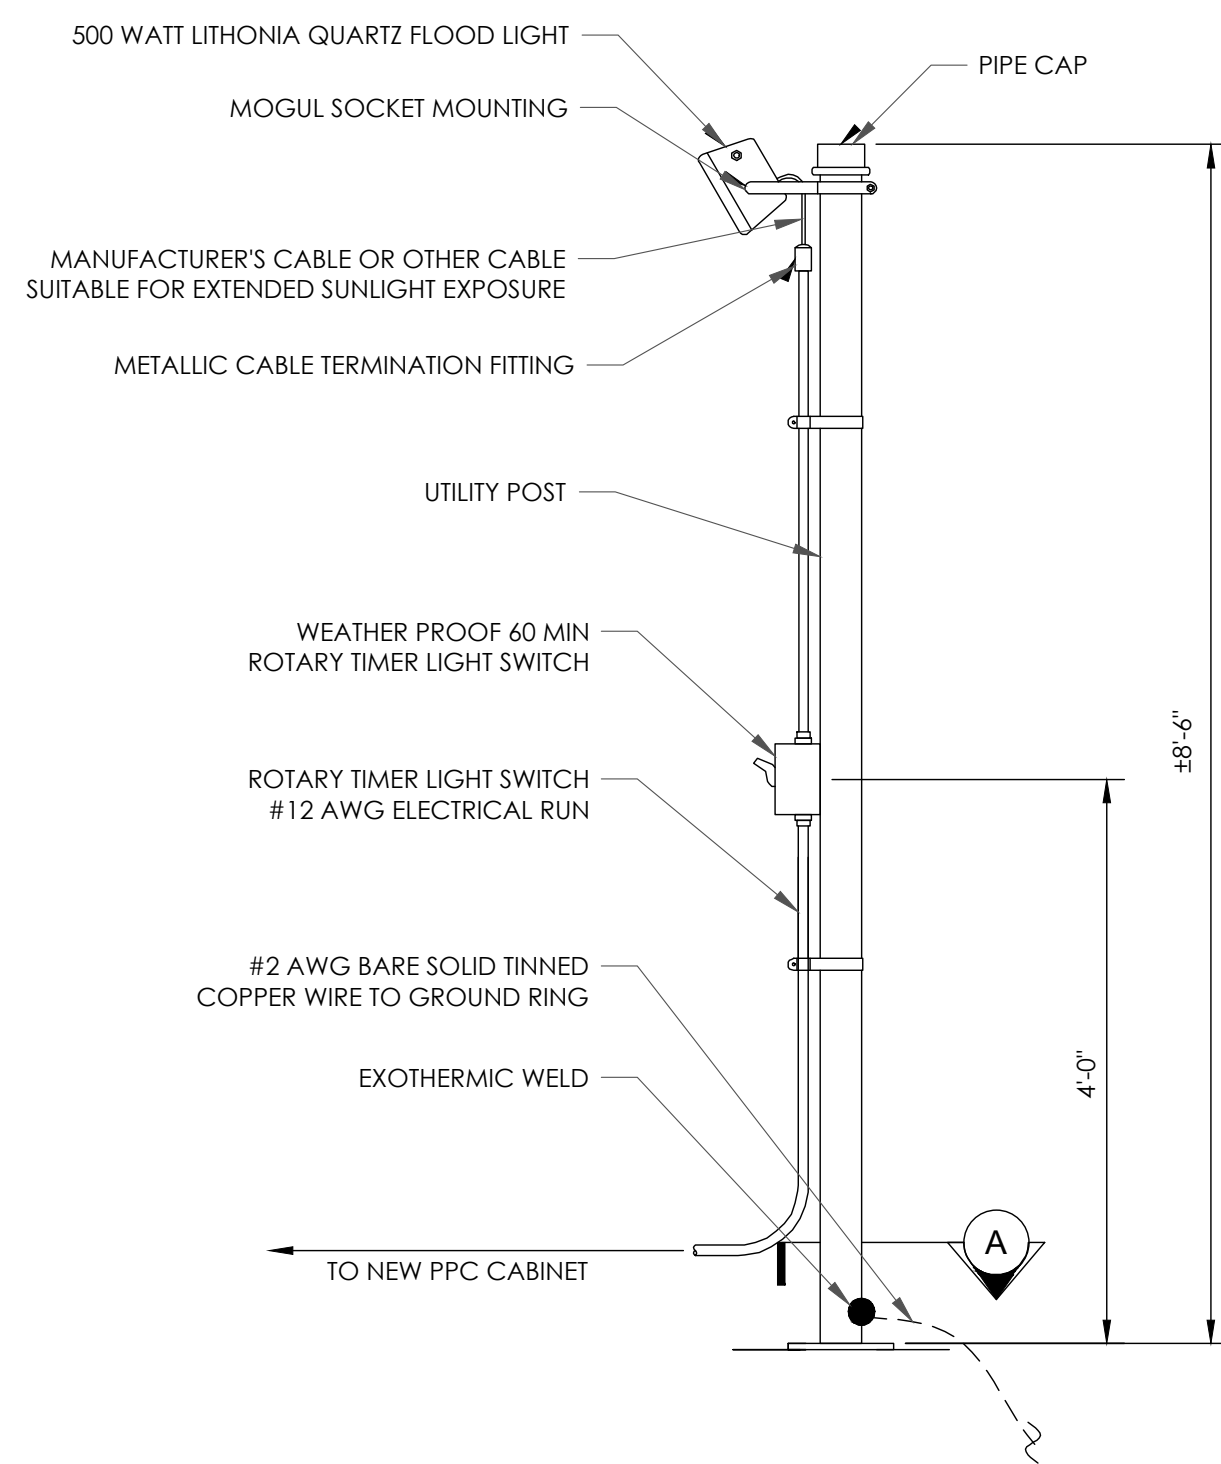

4 TECH LIGHT W/ TIMER SWITCH
SCALE: NOT TO SCALE

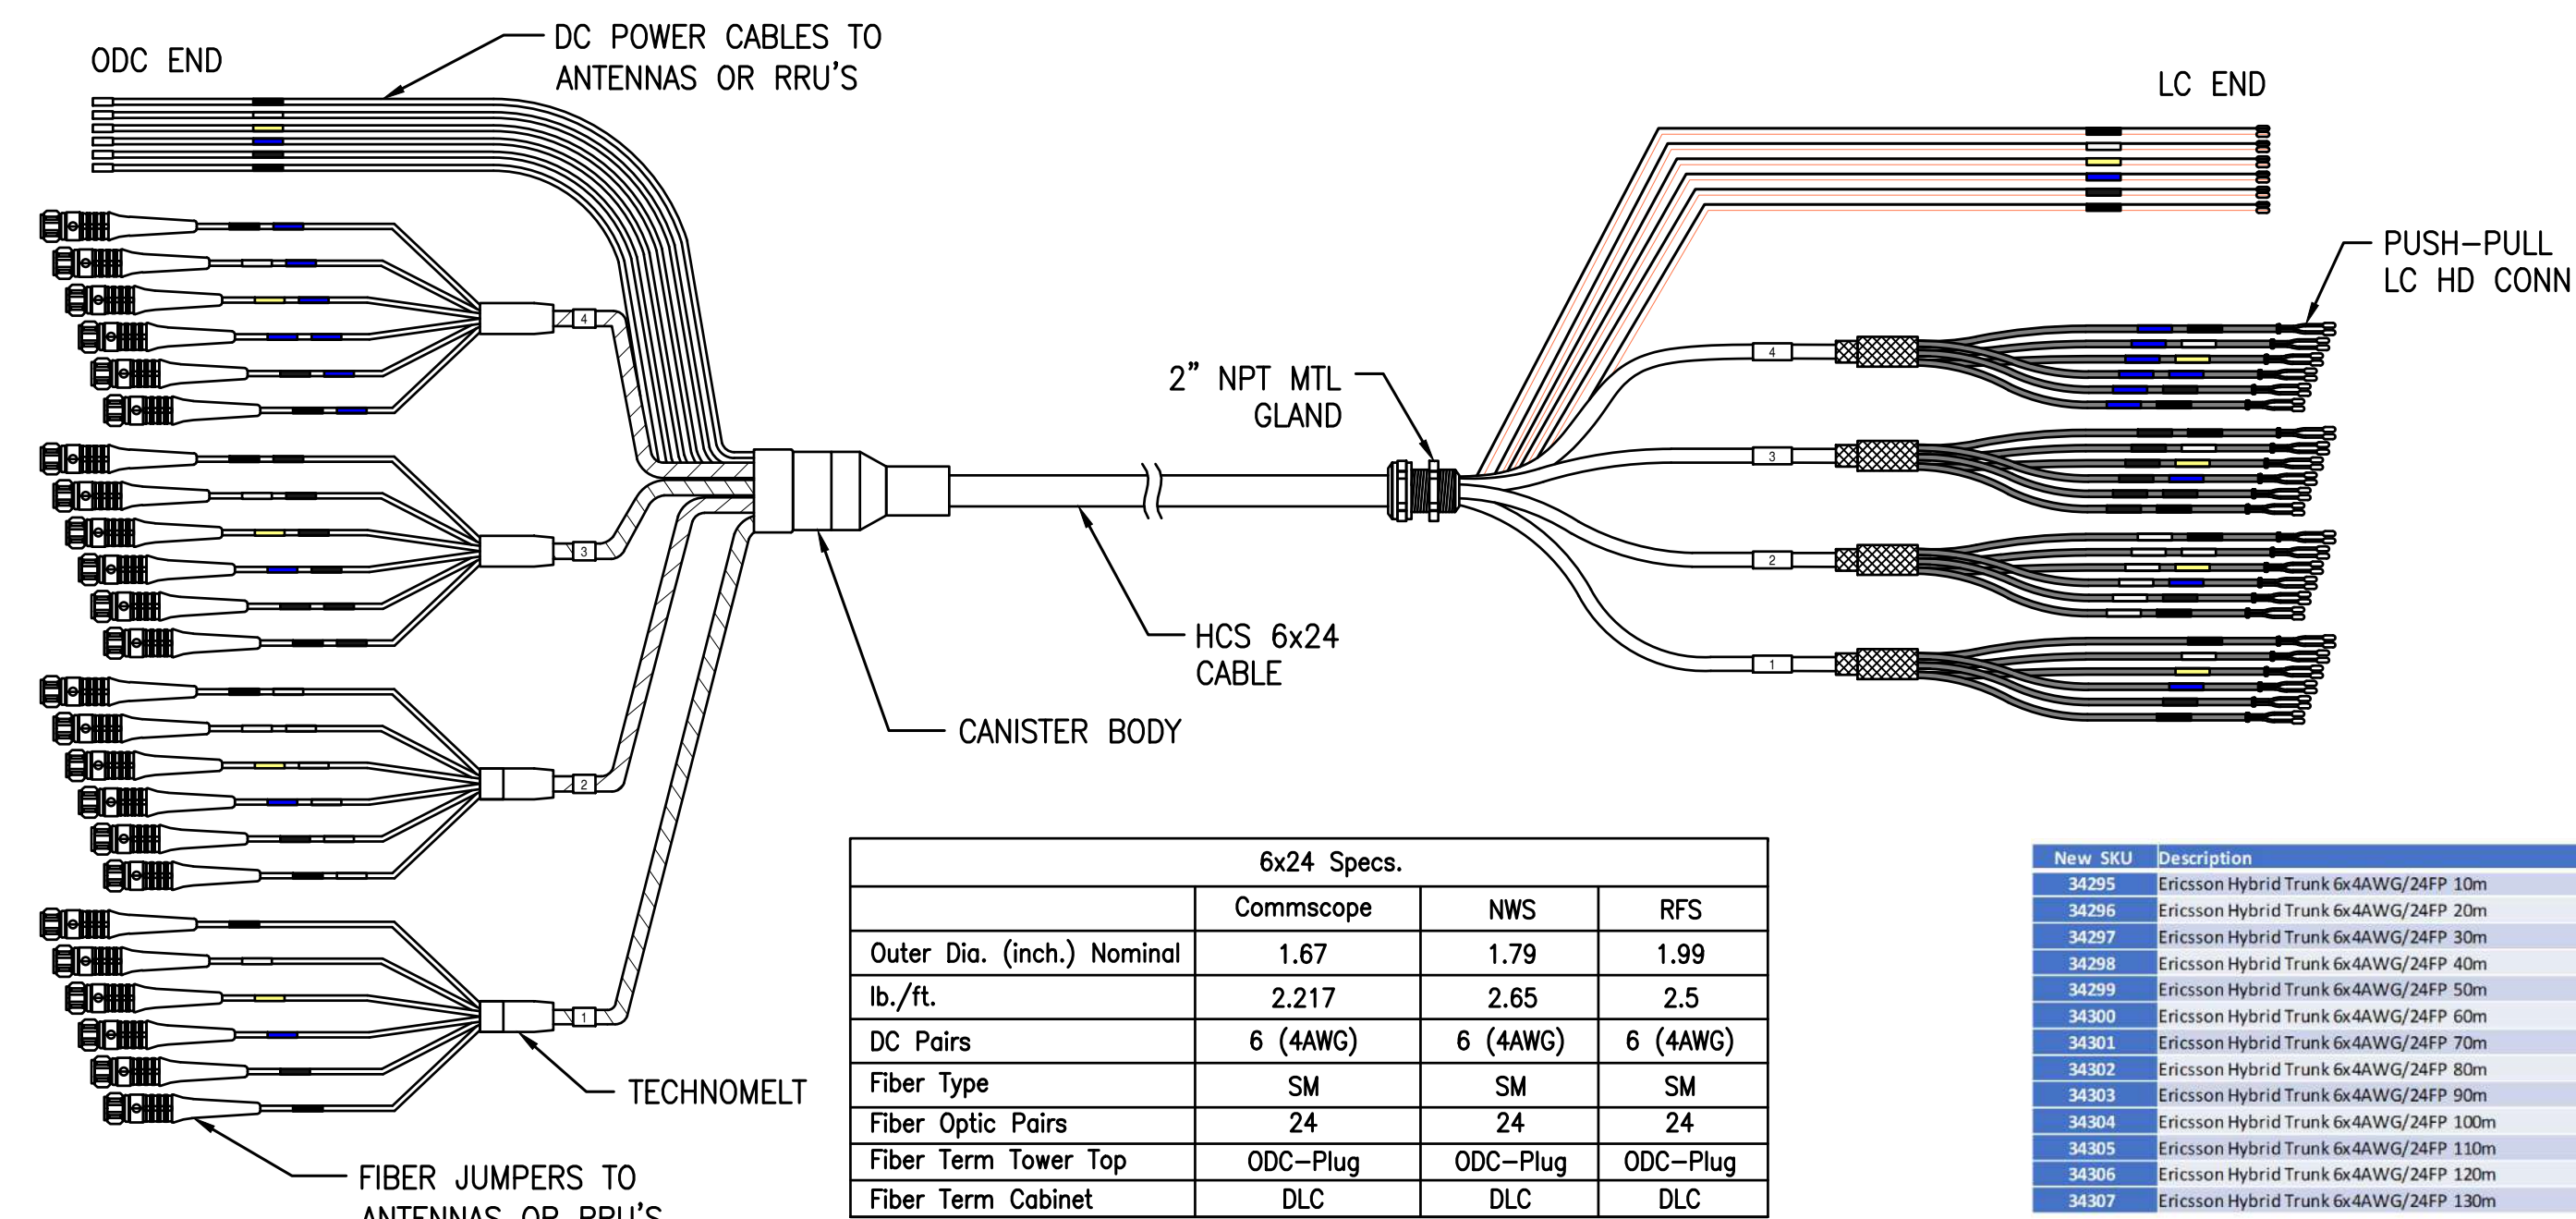

5 HCS CABLE SPECS
SCALE: NOT TO SCALE



1200 CONCORD AVE., SUITE 500
CONCORD, CA 94520



1 PARK PLACE, SUITE 300
DUBLIN, CA 94568



P. MARSHALL & ASSOCIATES
6801 PORTWEST DR. STE 100,
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EXISTING 65'-0" MONOPOLE

ISSUED FOR:

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0	01/31/24	SM	FINAL CD	HS



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PROJECT NUMBER:
23CCTCAM-127

SHEET NUMBER: C-9
REVISION: 0

ISSUED FOR:

REV	DATE	DRWN	DESCRIPTION	DES./QA
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0	01/31/24	SM	FINAL CD	HS



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SHEET NUMBER: **C-10** REVISION: **0**



WALL-MOUNT ENCLOSURES WALL-MOUNT TYPE 12 ENCLOSURES

CONTINUOUS HINGE WITH CLAMPS, TYPE 12



INDUSTRY STANDARDS

UL 508A Listed; Type 12, 13; File No. E61997
cUL Listed per CSA C22.2 No. 94; Type 12, 13; File No. E61997
NEMA/IEEEMAC Type 12 and 13
CSA, File No. 42186; Type 12
IEC 60529, IP65

APPLICATION

For applications requiring a bright white interior to increase control visibility, this enclosure includes a padlocking hasp and staple for security and screw-down clamps for secure closure.

SPECIFICATIONS

- 16 or 14 gauge steel
- Seams continuously welded and ground smooth
- External welded-on mounting brackets for easy installation
- Formed external return flanges around all sides of enclosure opening
- Screw-down door clamps
- Removable heavy-gauge continuous hinge pin
- Hasp and staple for padlocking
- Data pocket is high-impact thermoplastic
- Collar studs for mounting optional panels
- Bonding provision on door
- Removable door with continuous hinge
- Seamless foam-in-place gasket

FINISH

Body: White inside with ANSI 61 gray finish outside.
Door: ANSI 61 gray inside and outside.

ACCESSORIES

Panels for 3R, 4, 4X, 12, and 13 Enclosures
Drip Shield Kit for Type 12 Enclosures
Electric Heater
Fast-Operating Clamp Assembly
Compact Cooling Fans
Steel and Stainless Steel Window Kits
HF Side-Mount Filter Fans

MODIFICATION AND CUSTOMIZATION

Hoffman excels at modifying and customizing products to your specifications. Contact your local Hoffman sales office or distributor for complete information.

BULLETIN: A12

Standard Product


Catalog Number	AxBxC in./mm	Body Gauge	Panel	Conductive Panel	Panel Size D x E in./mm	F in./mm	Number of Clamps	Data Pocket
A122404LP	12.00 x 24.00 x 6.00	16	A12P24	A12P24G	9.00 x 21.00	3.00	2	Small
A161204LP	16.00 x 12.00 x 6.00	16	A16P12	A16P12G	12.00 x 9.00	1.25	2	Small
A161404LP	16.00 x 16.00 x 6.00	16	A16P16	A16P16G	13.00 x 13.00	3.00	2	Small
A161804LP	16.00 x 18.00 x 6.00	16	A16P18	A16P18G	15.00 x 15.00	3.00	2	Small
A201204LP	20.00 x 12.00 x 6.00	16	A20P12	A20P12G	17.00 x 9.00	1.25	2	Small
A201404LP	20.00 x 16.00 x 6.00	16	A20P16	A20P16G	17.00 x 13.00	3.00	2	Small
A202004LP	20.00 x 20.00 x 6.00	16	A20P20	A20P20G	17.00 x 17.00	3.00	2	Small
A241204LP	24.00 x 12.00 x 6.00	16	A24P12	A24P12G	21.00 x 9.00	1.25	2	Small
A241404LP	24.00 x 14.00 x 6.00	16	A24P14	A24P14G	21.00 x 11.00	1.25	2	Small
A242004LP	24.00 x 20.00 x 6.00	16	A24P20	A24P20G	21.00 x 17.00	3.00	2	Small
A242404LP	24.00 x 24.00 x 6.00	16	A24P24	A24P24G	21.00 x 21.00	3.00	2	Small
A301404LP	30.00 x 14.00 x 6.00	14	A30P14	A30P14G	27.00 x 11.00	3.00	2	Small
A302004LP	30.00 x 20.00 x 6.00	14	A30P20	A30P20G	27.00 x 17.00	3.00	2	Small
A302404LP	30.00 x 24.00 x 6.00	14	A30P24	A30P24G	27.00 x 21.00	3.00	2	Large
A362404LP	36.00 x 24.00 x 6.00	14	A36P24	A36P24G	33.00 x 21.00	3.00	2	Large
A363004LP	36.00 x 30.00 x 6.00	14	A36P30	A36P30G	33.00 x 27.00	3.00	2	Large
A422404LP	42.00 x 24.00 x 6.00	14	A42P24	A42P24G	39.00 x 21.00	3.00	2	Large
A423004LP	42.00 x 30.00 x 6.00	14	A42P30	A42P30G	39.00 x 27.00	3.00	2	Small
A423604LP	42.00 x 36.00 x 6.00	14	A42P36	A42P36G	39.00 x 33.00	3.00	2	Large
A482404LP	48.00 x 24.00 x 6.00	14	A48P24	A48P24G	45.00 x 21.00	3.00	3	Large
A483004LP	48.00 x 30.00 x 6.00	14	A48P30	A48P30G	45.00 x 27.00	3.00	3	Large
A483604LP	48.00 x 36.00 x 6.00	14	A48P36	A48P36G	45.00 x 33.00	3.00	3	Large
A161210LP	16.00 x 12.00 x 10.00	14	A16P12	A16P12G	13.00 x 9.00	1.25	2	Small
A201410LP	20.00 x 16.00 x 10.00	14	A20P14	A20P14G	17.00 x 13.00	3.00	2	Small
A202010LP	20.00 x 20.00 x 10.00	14	A20P20	A20P20G	17.00 x 17.00	3.00	2	Small
A242410LP	24.00 x 24.00 x 10.00	14	A24P24	A24P24G	21.00 x 21.00	3.00	2	Small
A302410LP	30.00 x 24.00 x 10.00	14	A30P24	A30P24G	27.00 x 21.00	3.00	2	Large
A362410LP	36.00 x 24.00 x 10.00	14	A36P24	A36P24G	33.00 x 21.00	3.00	2	Large
A363010LP	36.00 x 30.00 x 10.00	14	A36P30	A36P30G	33.00 x 27.00	3.00	2	Large
A422010LP	42.00 x 20.00 x 10.00	14	A42P20	A42P20G	39.00 x 17.00	3.00	2	Small
A422410LP	42.00 x 24.00 x 10.00	14	A42P24	A42P24G	39.00 x 21.00	3.00	2	Large

WALL-MOUNT ENCLOSURES WALL-MOUNT TYPE 12 ENCLOSURES



Catalog Number	AxBxC in./mm	Body Gauge	Panel	Conductive Panel	Panel Size D x E in./mm	F in./mm	Number of Clamps	Data Pocket
A122404LP	12.00 x 24.00 x 6.00	16	A12P24	A12P24G	9.00 x 21.00	3.00	2	Small
A161208LP	16.00 x 12.00 x 8.00	16	A16P12	A16P12G	13.00 x 9.00	1.25	2	Small
A161408LP	16.00 x 16.00 x 8.00	16	A16P16	A16P16G	13.00 x 13.00	3.00	2	Small
A162008LP	16.00 x 20.00 x 8.00	16	A20P16	A20P16G	17.00 x 13.00	3.00	2	Small
A201208LP	20.00 x 12.00 x 8.00	16	A20P12	A20P12G	17.00 x 9.00	1.25	2	Small
A201408LP	20.00 x 14.00 x 8.00	16	A20P14	A20P14G	17.00 x 11.00	1.25	2	Small
A202008LP	20.00 x 20.00 x 8.00	16	A20P20	A20P20G	17.00 x 17.00	3.00	2	Small
A202408LP	20.00 x 24.00 x 8.00	16	A24P20	A24P20G	21.00 x 17.00	3.00	2	Small
A241208LP	24.00 x 12.00 x 8.00	16	A12P24	A12P24G	9.00 x 21.00	1.25	2	Small
A241408LP	24.00 x 14.00 x 8.00	16	A24P16	A24P16G	21.00 x 13.00	3.00	2	Small
A242008LP	24.00 x 20.00 x 8.00	16	A24P20	A24P20G	21.00 x 17.00	3.00	2	Small
A242408LP	24.00 x 24.00 x 8.00	16	A24P24	A24P24G	21.00 x 21.00	3.00	2	Small
A302008LP	30.00 x 20.00 x 8.00	14	A30P20	A30P20G	27.00 x 17.00	3.00	2	Small
A302408LP	30.00 x 24.00 x 8.00	14	A30P24	A30P24G	27.00 x 21.00	3.00	2	Large
A362408LP	36.00 x 24.00 x 8.00	14	A36P24	A36P24G	33.00 x 21.00	3.00	2	Large
A363008LP	36.00 x 30.00 x 8.00	14	A36P30	A36P30G	33.00 x 27.00	3.00	2	Large
A422008LP	42.00 x 20.00 x 8.00	14	A42P20	A42P20G	39.00 x 17.00	3.00	2	Small
A422408LP	42.00 x 24.00 x 8.00	14	A42P24	A42P24G	39.00 x 21.00	3.00	2	Large
A423008LP	42.00 x 30.00 x 8.00	14	A42P30	A42P30G	39.00 x 27.00	3.00	2	Large
A423608LP	42.00 x 36.00 x 8.00	14	A42P36	A42P36G	39.00 x 33.00	3.00	2	Large

WALL-MOUNT ENCLOSURES WALL-MOUNT TYPE 12 ENCLOSURES

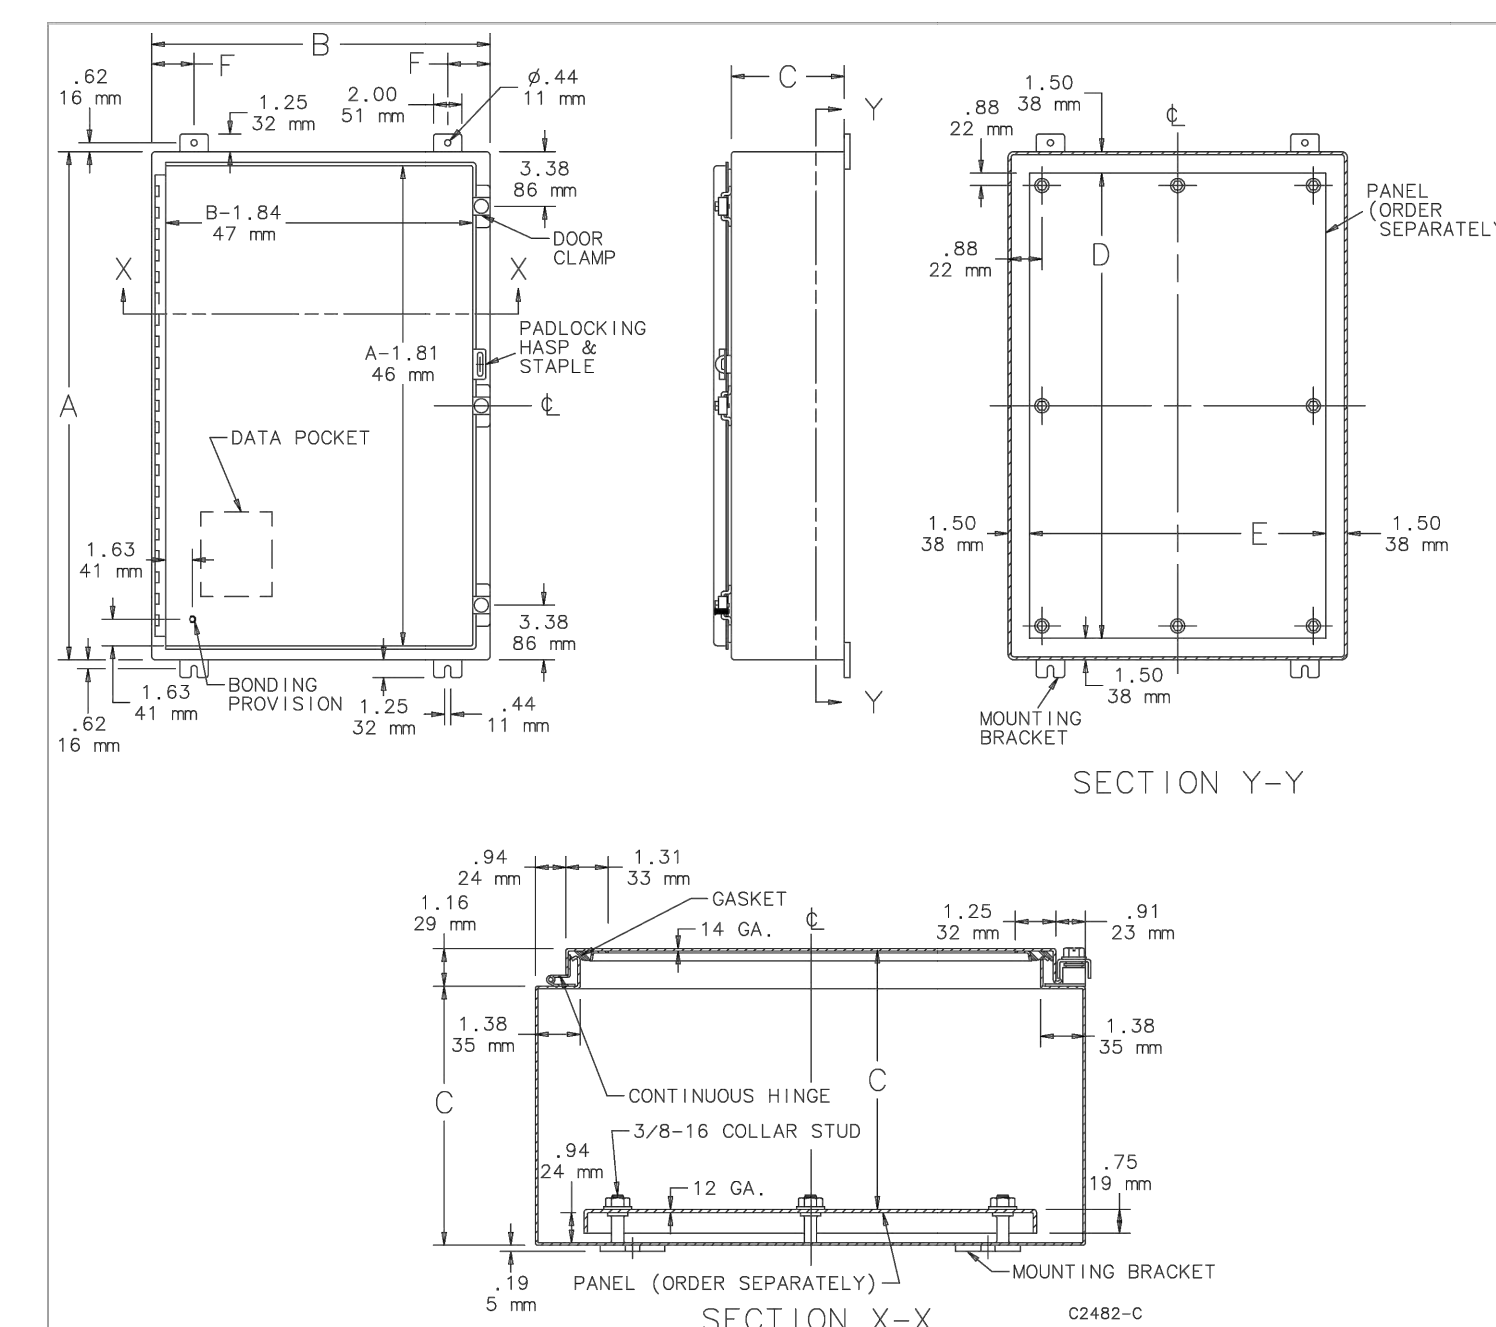

T-MOBILE SITE NUMBER:
SF40959A

BU #: 857683
CROWN: AT&T NEW
POTTER VALLEY

12531 EEL RIVER ROAD
POTTER VALLEY, CA 95469

EXISTING 65'-0" MONOPOLE

ISSUED FOR:


REV	DATE	DRWN	DESCRIPTION	DES./QA
A	12/20/23	AW	PRELIMINARY	HS
0	01/31/24	SM	FINAL CD	HS



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PROJECT NUMBER:
23CCTCAM-127

SHEET NUMBER: C11
REVISION: 0

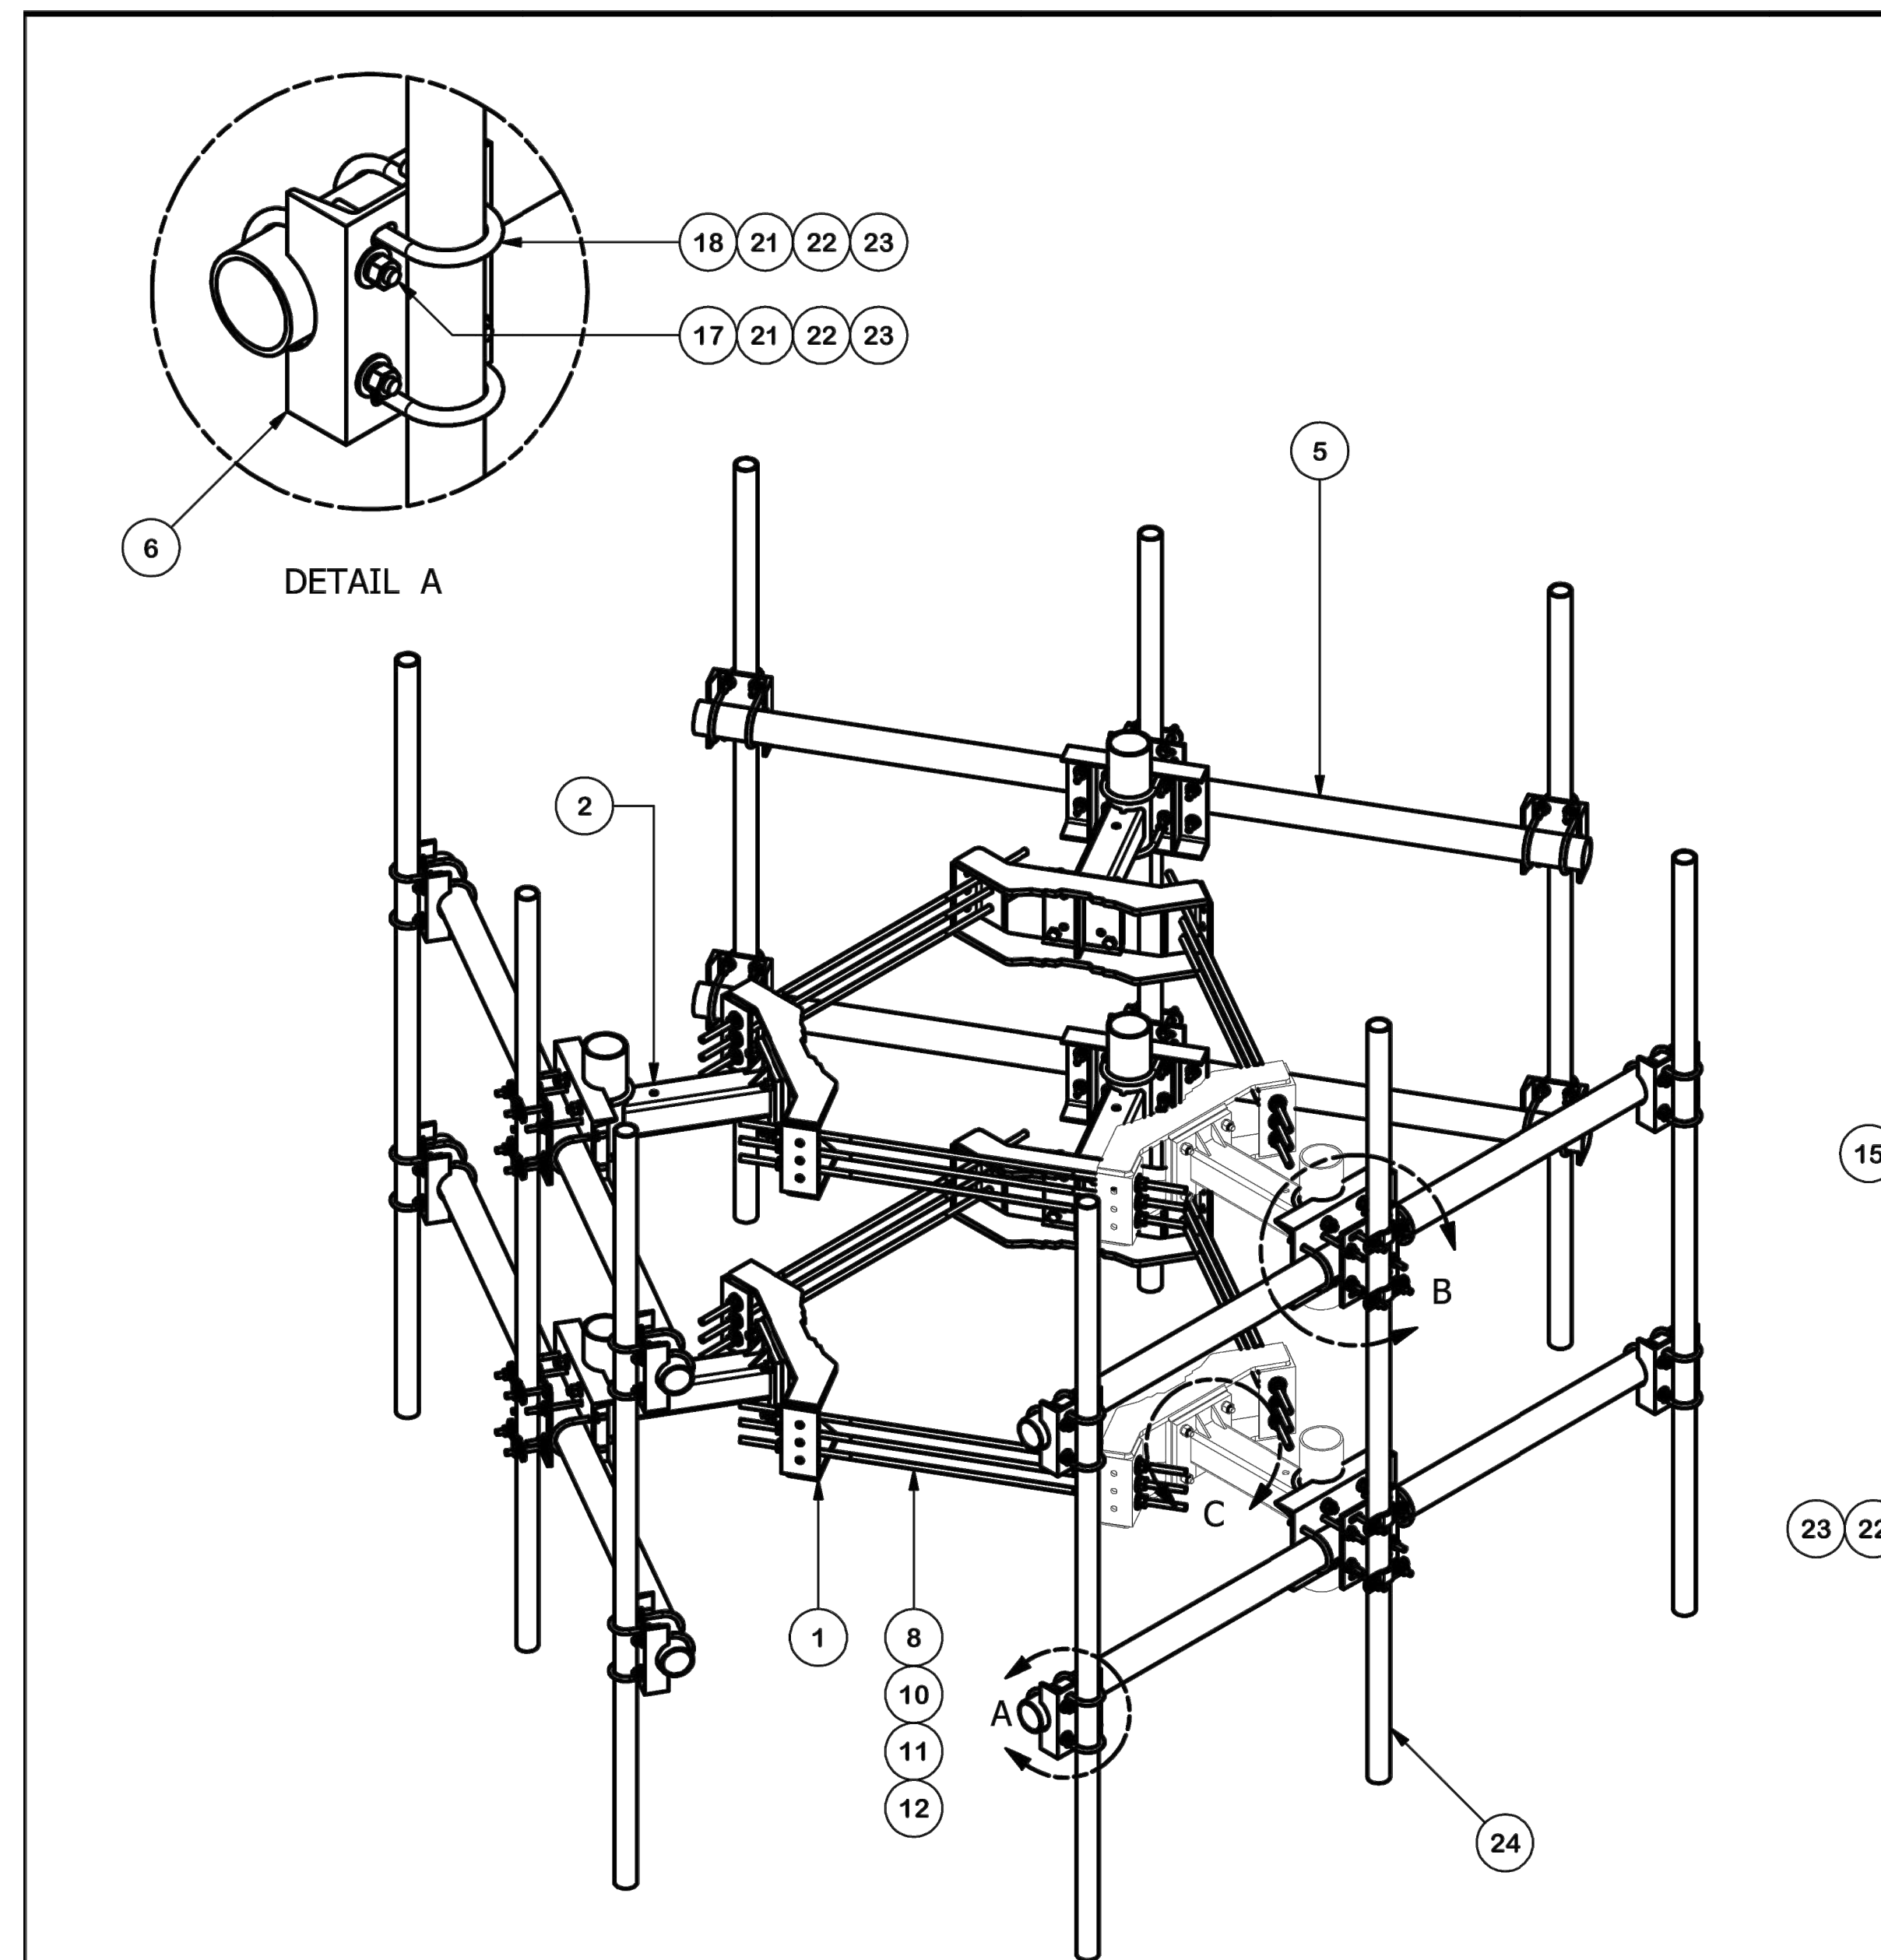

PARTS LIST						
ITEM	QTY	PART NO.	PART DESCRIPTION	LENGTH	UNIT WT.	NET WT.
1	6	X-LWRM	RING MOUNT WELDMENT		68.81	412.85
2	6	X-SV197-18	SUPPORT ARM WELDMENT - 18"		45.69	274.15
3	6	X-SP216	LARGE SUPPORT CROSS PLATE		22.08	132.46
4	6	SCX3	CROSSOVER PLATE	9.250 in	7.19	43.13
5	6	P396	3-1/2" X 96" (3" SCH 40) GALVANIZED PIPE	96.000 in	60.75	364.49
6	12	X-SP219	SMALL SUPPORT CROSS PLATE	8.250 in	8.61	103.33
7	12	X-100064	CLAMP (4" V-CLAMP) GALVANIZED		0.92	11.06
8	18	G58R-48	5/8" X 48" GALV THREADED ROD		4.39	79.03
8	18	G58R-24	5/8" x 24" THREADED ROD (HDG.)		2.09	37.63
9	12	X-UB5458	5/8" X 4-5/8" X 7" X 3" U-BOLT (HDG.)		1.54	18.42
10	36	G58FW	5/8" HDG USS FLATWASHER	.122	0.07	2.54
11	84	G58LW	5/8" HDG LOCKWASHER		0.03	2.19
12	36	G58NUT	5/8" HDG HEAVY 2H HEX NUT		0.13	4.68
13	24	A58234	5/8" x 2-3/4" HDG A325 HEX BOLT	2.75	0.36	8.54
14	24	A58FW	5/8" HDG A325 FLATWASHER		0.03	0.82
15	48	A58NUT	5/8" HDG A325 HEX NUT		0.13	6.23
16	12	X-UB1358	1/2" X 3-5/8" X 5-1/2" X 3" U-BOLT (HDG.)		0.77	9.27
17	24	X-UB1306	1/2" X 3-5/8" X 6" X 3" U-BOLT (HDG.)		0.83	19.88
18	24	X-UB1212	1/2" X 2-1/2" X 4-1/2" X 2" U-BOLT (HDG.)		0.63	15.00
19	24	G12R-8	1/2" x 8" THREADED ROD (HDG.)		0.45	10.71
20	24	G12045	1/2" x 4.5" HDG HEX BOLT GR5 FULL THREAD	4.5	0.30	7.15
21	216	G12FW	1/2" HDG USS FLATWASHER	0.095	0.03	7.36
22	192	G12LW	1/2" HDG LOCKWASHER	.125	0.01	2.67
23	192	G12NUT	1/2" HDG HEAVY 2H HEX NUT		0.07	13.75
24	9	A	B	C	D	E

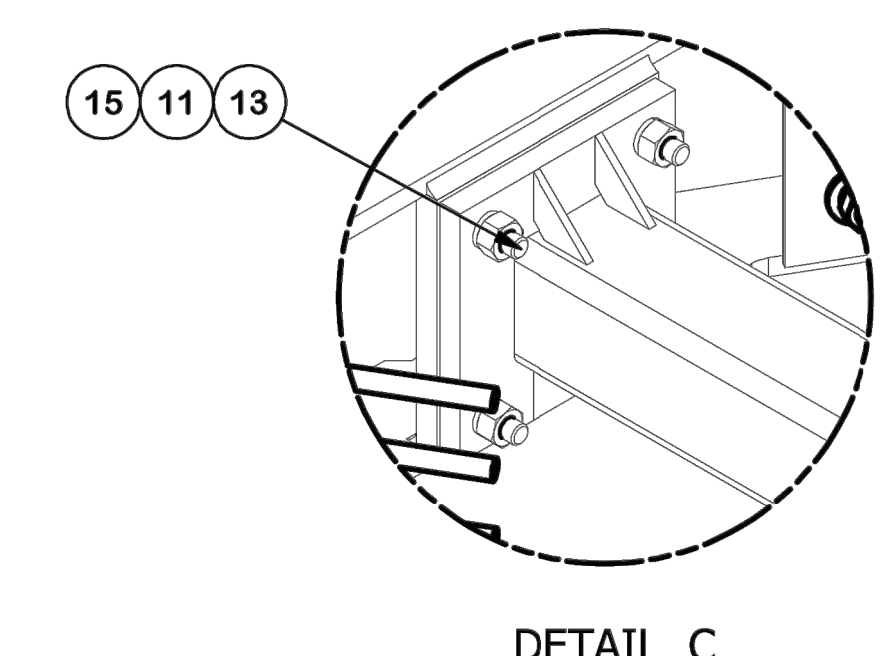
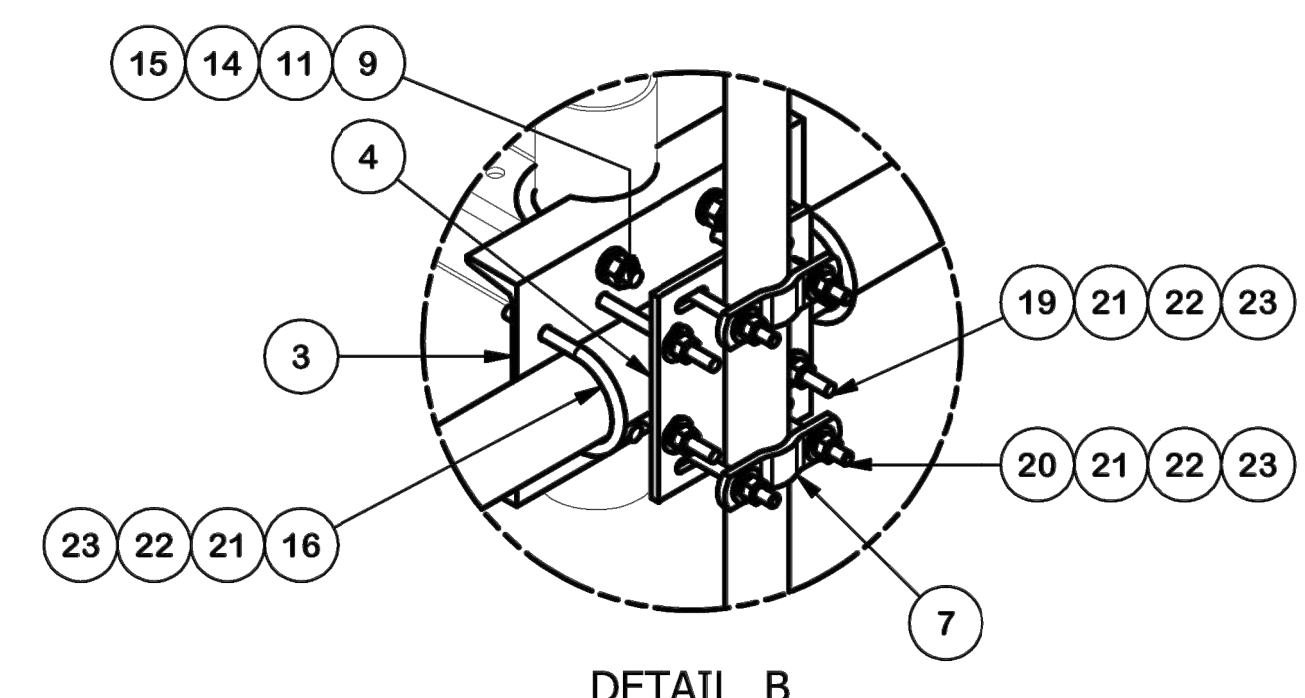


TABLE					
"ASSEMBLY NO."	PART NO. "A"	PART DESCRIPTION "B"	LENGTH "C"	UNIT WT. "D"	TOTAL WT.
RMVD8-296-18	P296	2-3/8" O.D. SCH. 40 PIPE	96"	29.22	1,880.76
RMVD8-2120-18	P2120	2-2/8" O.D. SCH. 40 PIPE	120"	36.53	1,936.65

TOLERANCE NOTES
TOLERANCES ON DIMENSIONS, UNLESS OTHERWISE NOTED ARE:
SAWED, SHEARED AND GAS CUT EDGES ($\pm 0.030"$)
DRILLED AND GAS CUT HOLES ($\pm 0.030"$) - NO CONING OF HOLES
LASER CUT EDGES AND HOLES ($\pm 0.010"$) - NO CONING OF HOLES
BENDS ARE $\pm 1/2$ DEGREE
ALL OTHER MACHINING ($\pm 0.030"$)
ALL OTHER ASSEMBLY ($\pm 0.060"$)

PROPRIETARY NOTE:
THE DATA AND TECHNIQUES CONTAINED IN THIS DRAWING ARE PROPRIETARY INFORMATION OF VALMONT INDUSTRIES AND CONSIDERED A TRADE SECRET. ANY USE OR DISCLOSURE WITHOUT THE CONSENT OF VALMONT INDUSTRIES IS STRICTLY PROHIBITED.

DESCRIPTION		
8' DOUBLE MONOPOLE TRIPLE T-ARM W/ 2-3/8" ANTENNA PIPES & 18" STANDOFF		
CPD NO.	DRAWN BY	ENG. APPROVAL
	CMFL 11/23/2021	11/13/2020
CLASS	SUB	DRAWING USAGE
87	02	CUSTOMER
		CHECKED BY
		BMC 11/13/2020

SITE PRO 1
A valmont COMPANY

Locations:
New York, NY
Atlanta, GA
Los Angeles, CA
Plymouth, IN
Salem, OR
Dallas, TX

Engineering Support Team:
1-888-753-7446

PART NO.	RMVD8-2XX-18
DWG. NO.	RMVD8-2XX-18

1 OF 2 PAGE

T-Mobile

1200 CONCORD AVE., SUITE 500
CONCORD, CA 94520

CROWN CASTLE

1 PARK PLACE, SUITE 300
DUBLIN, CA 94568

PM&A

P. MARSHALL & ASSOCIATES
6801 PORTWEST DR. STE 100,
HOUSTON, TX 77024
OFFICE 713-677-0964

T-MOBILE SITE NUMBER:
SF40959A



BU #: 857683
**CROWN: AT&T NEW
POTTER VALLEY**

**12531 EEL RIVER ROAD
POTTER VALLEY, CA 95469**

EXISTING 65'-0" MONOPOLE

ISSUED FOR:

REV	DATE	DRWN	DESCRIPTION	DES./QA
A	12/20/23	AW	PRELIMINARY	HS
0	01/31/24	SM	FINAL CD	HS

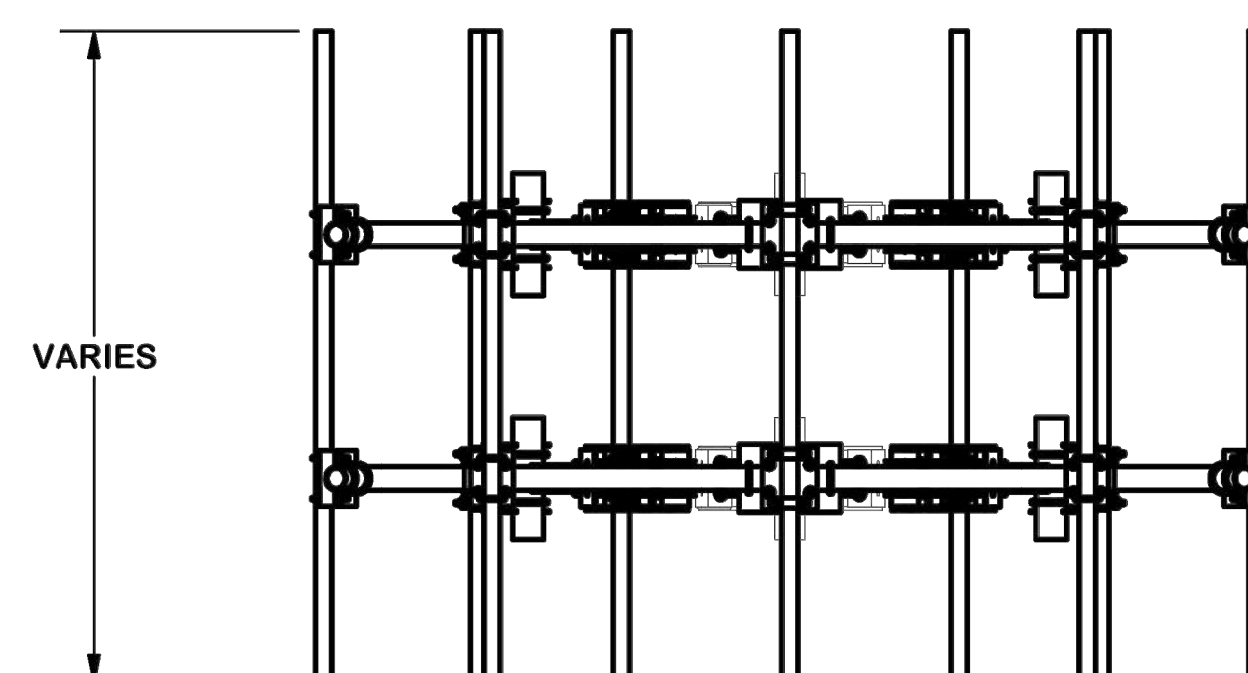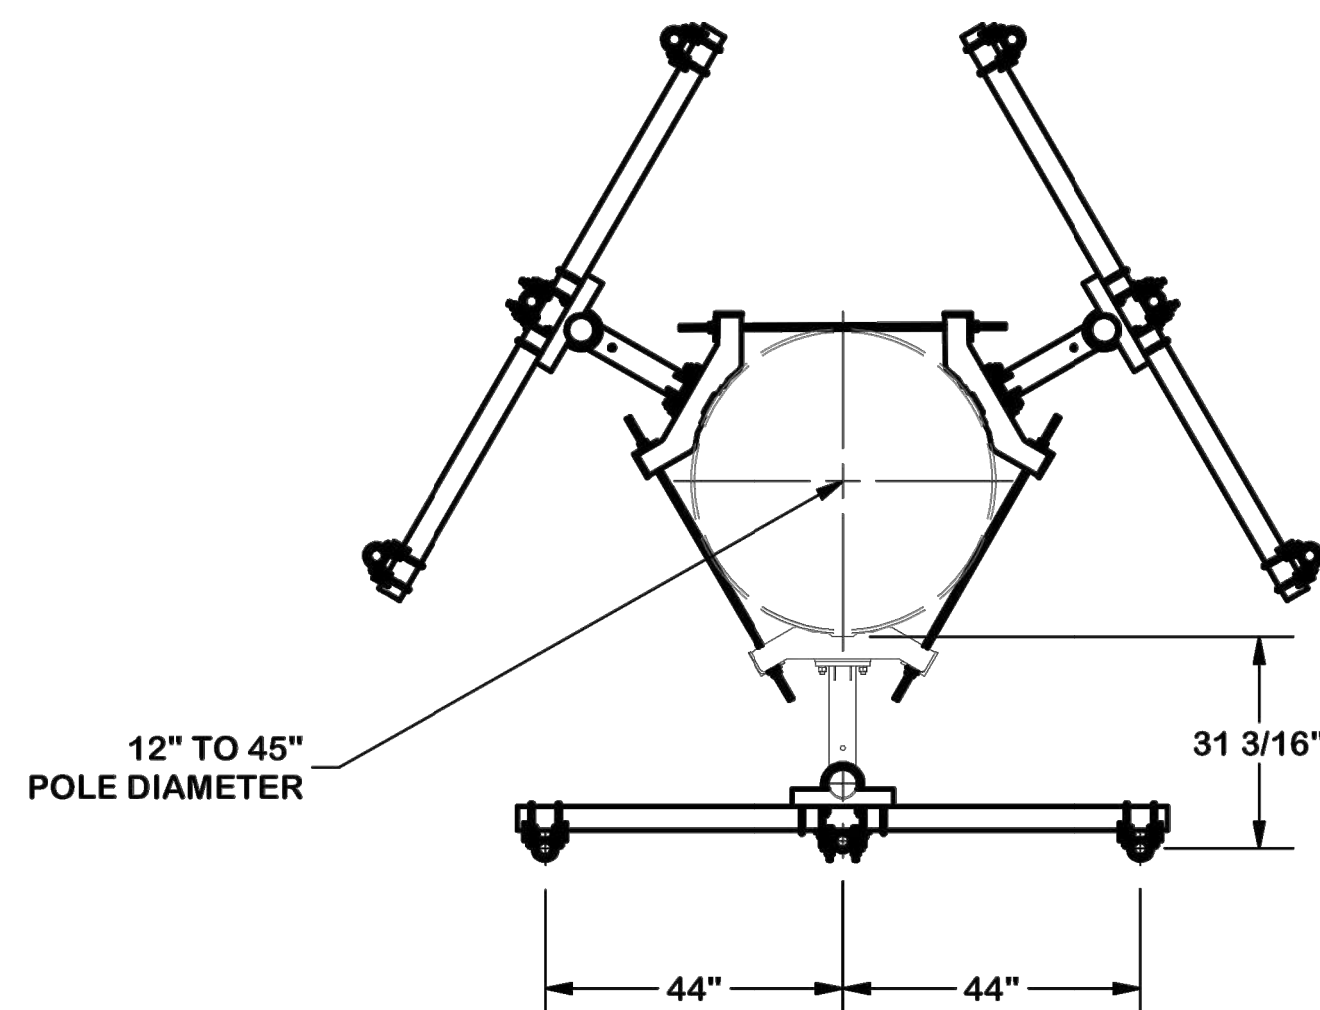

TOLERANCE NOTES

TOLERANCES ON DIMENSIONS, UNLESS OTHERWISE NOTED ARE:
SAWED, SHEARED AND GAS CUT EDGES (± 0.030 "")
DRILLED AND GAS CUT HOLES (± 0.030 "") - NO CONING OF HOLES
LASER CUT EDGES AND HOLES (± 0.010 "") - NO CONING OF HOLES
BENDS ARE $\pm 1/2$ DEGREE
ALL OTHER MACHINING (± 0.030 "")
ALL OTHER ASSEMBLY (± 0.060 "")

PROPRIETARY NOTE:
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DESCRIPTION
**8' DOUBLE MONOPOLE TRIPLE T-ARM
W/ 2-3/8" ANTENNA PIPES & 18" STANDOFF**



Locations:
New York, NY
Atlanta, GA
Los Angeles, CA
Plymouth, IN
Salem, OR
Dallas, TX

Engineering
Support Team:
1-888-753-7446

A valmont COMPANY

CPD NO.	DRAWN BY CMFL 11/23/2021	ENG. APPROVAL 11/13/2020
CLASS 87	SUB 02	DRAWING USAGE CUSTOMER
	CHECKED BY BMC 11/13/2020	

PART NO. RMVD8-2XX-18	PAGE 2 OF 2
DWG. NO. RMVD8-2XX-18	



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PROJECT NUMBER:
23CCTCAM-127

SHEET NUMBER: **C-11.1** REVISION: **0**


T-MOBILE SITE #:		LOCATION:		VOLTAGE: 240/120 1Ø				MOUNTING / ENCLOSURE: EXISTING / NEMA 3R					
SF40959A (PROPOSED)		H-FRAME MOUNTED PPC CABINET		MAIN C/B: 200 AMPS				AVAIL. FAULT CURRENT: EXISTING					
12/14/2023				BUS RATING: 200 AMPS				SHORT CIRCUIT RATING: 65,000					
AMPS/POLES	WIRE & CONDUIT	TYPE	DESCRIPTION	KVA	CKT	A	B	CKT	KVA	DESCRIPTION	TYPE	WIRE & CONDUIT	AMPS/POLES
30/2	EXISTING	EQ	TVSS	0.10	1	8.74		2	8.64	RBS 6160 CABINET	EQ	(2) #1, (1) #6 GND, 2" C	125/2
				0.10	3		8.74	4	8.64		EQ		
15/1	EXISTING	R	GFI	0.18	5	0.36		6	0.18	SITE GFI	R	EXISTING	15/1
20/1	EXISTING	H	BLOCK HEATER	1.00	7		1.50	8	0.50	SITE LIGHT	L	EXISTING	15/1
20/1	EXISTING	EQ	BATTERY CHARGER	1.00	9	1.50		10	0.50	TECH LIGHT	L	(2) #12, (1) #12 GND, 1/2" C	20/1
			SPACE		11		0.18	12	0.18	RBS 6160 GFCI	R	(2) #12, (1) #12 GND, 1/2" C	20/1
			SPACE		13			14		SPACE			
			SPACE		15			16		SPACE			
			SPACE		17			18		SPACE			
			SPACE		19			20		SPACE			
			SPACE		21			22		SPACE			
			SPACE		23			24		SPACE			
PHASE TOTAL				10.6			10.4						
TOTAL CONNECTED LOAD				21.0 KVA		88 A							
TOTAL DEMAND LOAD				21.3 KVA		89 A							
NOTES: REMOVE (1) 100/2 RBS 6102 BREAKER.													

LOAD TYPE	DESCRIPTION	CONN. LOAD KVA	AMPS	DEMAND FACTOR	DESIGN LOAD KVA	AMPS
L	LIGHTING	1.0	4.2	1.25	1.3	5.2
R	RECEPTACLE	0.5	2.3	NEC	0.5	2.3
M	MOTOR	0.0	0.0	NEC	0.0	0.0
H	HEATING	1.0	4.2	1.00	1.0	4.2
AC	HVAC	0.0	0.0	1.00	0.0	0.0
EQ	EQUIPMENT	18.5	77.0	1.00	18.5	77.0
E	EXISTING	0.0	0.0	1.25	0.0	0.0

* ALL EQUIPMENT LOADS CONSIDERED CONTINUOUS LOADS

ELECTRICAL NOTES:

- ALL NEW CONDUCTORS TO BE INSTALLED SHALL BE COPPER. ALL CONDUCTORS SHALL BE THHW, THWN, THWN-2, XHHW, OR XHHW-2 UNLESS NOTED OTHERWISE.
- CONTRACTOR IS TO FIELD VERIFY ALL EXISTING ITEMS SHOWN ON THE ELECTRICAL ONE-LINE DIAGRAM AND NOTIFY THE ENGINEER OF ANY DISCREPANCIES.
- ALL GROUNDING AND BONDING PER THE CEC.
- POWER DESIGN FOR ANY AC ELECTRICAL POWER CHANGE IS TO BE PERFORMED BY OTHERS AND IS SHOWN FOR REFERENCE PURPOSES ONLY. T-MOBILE IS SOLELY RESPONSIBLE FOR THE ELECTRICAL POWER DESIGN.

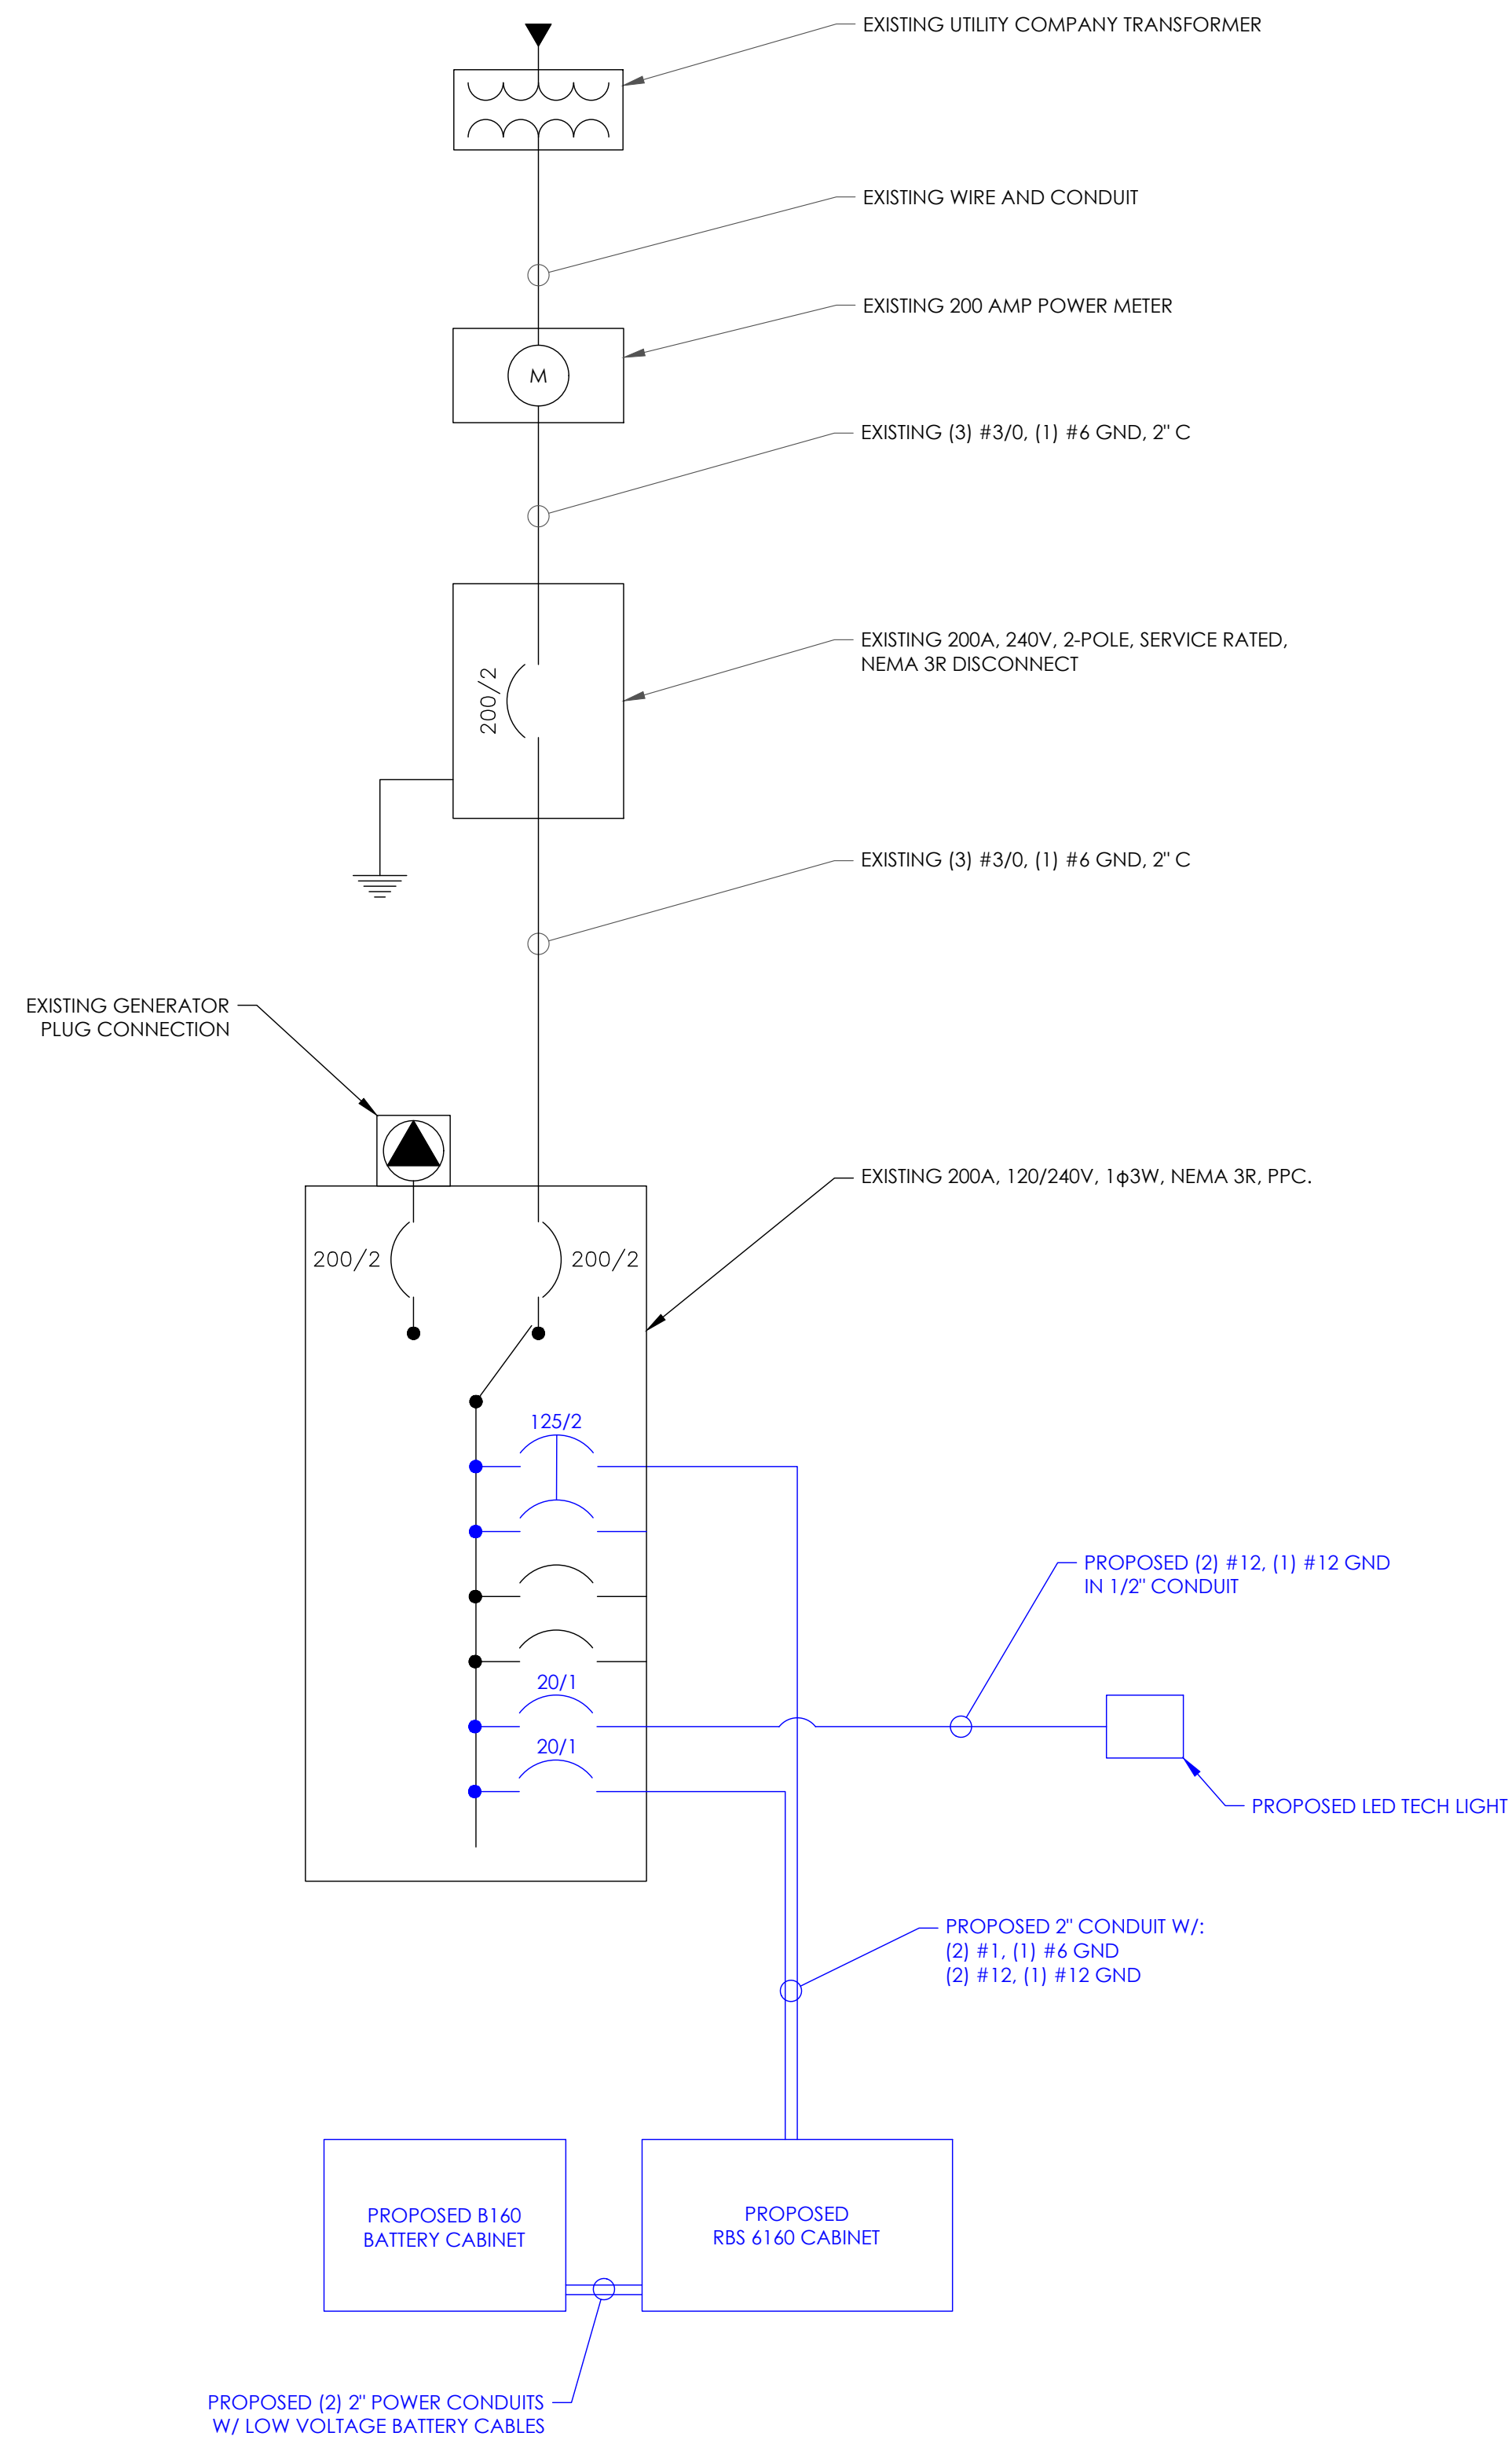

T-Mobile

1200 CONCORD AVE., SUITE 500
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CROWN CASTLE

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DUBLIN, CA 94568

PMA

P. MARSHALL & ASSOCIATES
6801 PORTWEST DR. STE 100,
HOUSTON, TX 77024
OFFICE 713-677-0964

T-MOBILE SITE NUMBER:
SF40959A

BU #: 857683

CROWN: AT&T NEW
POTTER VALLEY

12531 EEL RIVER ROAD
POTTER VALLEY, CA 95469

EXISTING 65'-0" MONOPOLE

ISSUED FOR:

REV	DATE	DRWN	DESCRIPTION	DES./QA
A	12/20/23	AW	PRELIMINARY	HS
0	01/31/24	SM	FINAL CD	HS



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PROJECT NUMBER:
23CCTCAM-127


SHEET NUMBER: REVISION:

E-1

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GROUNDING KEY NOTES:


- ① EXISTING #2 BARE TINNED SOLID COPPER GROUND RING.
- ② EXISTING 5/8" DIA. x 8' LONG STEEL SHAFT COPPER CLAD GROUND ROD (TYP.).
- ③ EXISTING GROUND ROD WITH COVERED PVC TEST WELL (TYP.).
- ④ GROUND PROPOSED RBS 6160 CABINET, MAIN GROUND BAR WITH 2-HOLE LUG CONNECTION.
- ⑤ GROUND PROPOSED RBS 6160 OUTER CABINET TO GROUND RING.
- ⑥ GROUND PROPOSED B160 BATTERY CABINET, MAIN GROUND BAR W/ 2-HOLE LUG CONNECTION.
- ⑦ GROUND PROPOSED B160 BATTERY OUTER CABINET TO GROUND RING.
- ⑧ GROUND PROPOSED LED TECH LIGHT TO GROUND RING.
- ⑨ GROUND PROPOSED HCS WINDER/SLACK CAN, HOFFMAN TO GROUND RING.

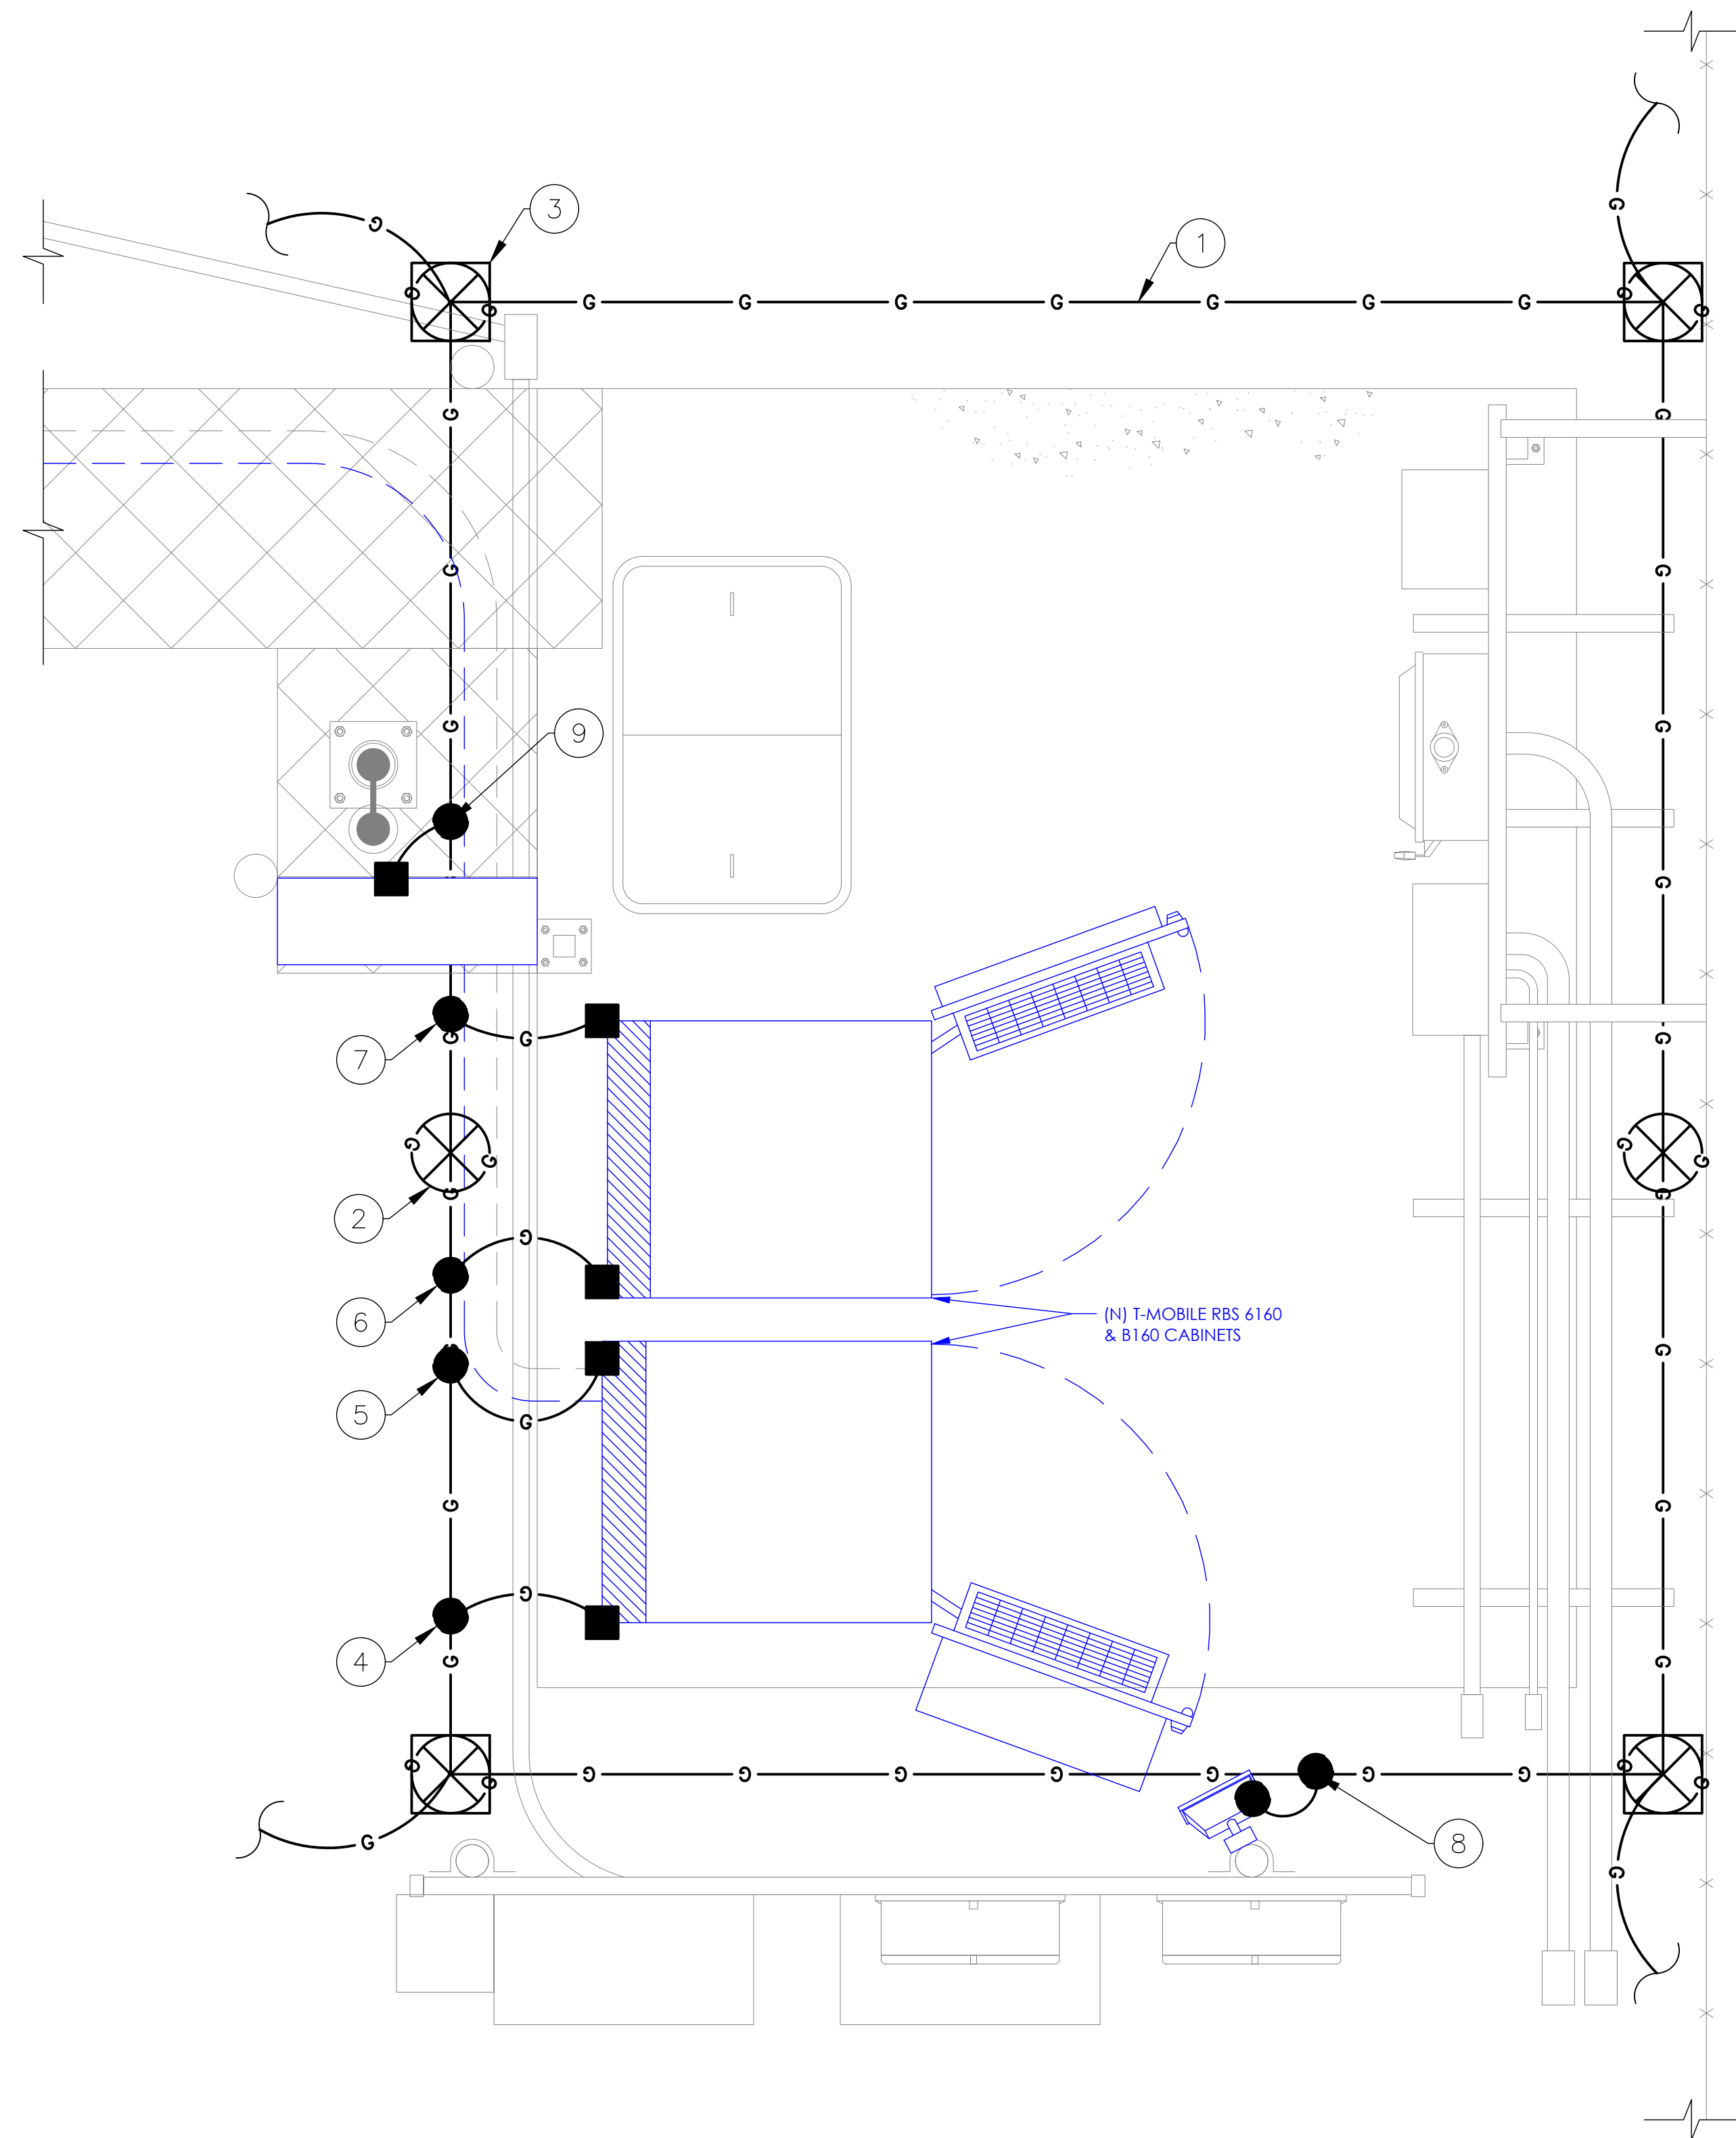

GROUNDING LEGEND

- INSPECTION WELL VERIFY LOCATION W/ CONSTR. MGR.
- 5/8"x10'-0" COPPER CLAD GROUND ROD, 10' O.C. (TYP)
- #6 AWG STRANDED & INSULATED
- #2 AWG SOLID COPPER TINNED
- GROUND BUS BAR
- EXOTHERMIC WELD (CADWELD) (UNLESS OTHERWISE NOTED)
- MECHANICAL CONNECTION

① EQUIPMENT GROUNDING PLAN
 SCALE: 1"=1'-0" (FULL SIZE)
 1/2"=1'-0" (11x17)

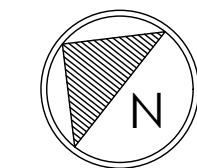

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 CONCORD, CA 94520

CROWN CASTLE

1 PARK PLACE, SUITE 300
 DUBLIN, CA 94568

PM&A

P. MARSHALL & ASSOCIATES
 6801 PORTWEST DR. STE 100,
 HOUSTON, TX 77024
 OFFICE 713-677-0964

T-MOBILE SITE NUMBER:
 SF40959A

BU #: 857683

**CROWN: AT&T NEW
 POTTER VALLEY**

12531 EEL RIVER ROAD
 POTTER VALLEY, CA 95469

EXISTING 65'-0" MONOPOLE

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SHEET NUMBER: **G-1** REVISION: **0**

T-Mobile

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CONCORD, CA 94520

CROWN CASTLE

1 PARK PLACE, SUITE 300
DUBLIN, CA 94568

PMA

P. MARSHALL & ASSOCIATES
6801 PORTWEST DR. STE 100,
HOUSTON, TX 77024
OFFICE 713-677-0964

T-MOBILE SITE NUMBER:
SF40959A

BU #: 857683

CROWN: AT&T NEW
POTTER VALLEY

12531 EEL RIVER ROAD
POTTER VALLEY, CA 95469

EXISTING 65'-0" MONOPOLE

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REV	DATE	DRWN	DESCRIPTION	DES./QA
A	12/20/23	AW	PRELIMINARY	HS
0	01/31/24	SM	FINAL CD	HS




IT IS A VIOLATION OF LAW FOR ANY PERSON,
UNLESS THEY ARE ACTING UNDER THE DIRECTION
OF A LICENSED PROFESSIONAL ENGINEER,
TO ALTER THIS DOCUMENT.

PROJECT NUMBER:
23CCTCAM-127

SHEET NUMBER: REVISION:


G-2

0

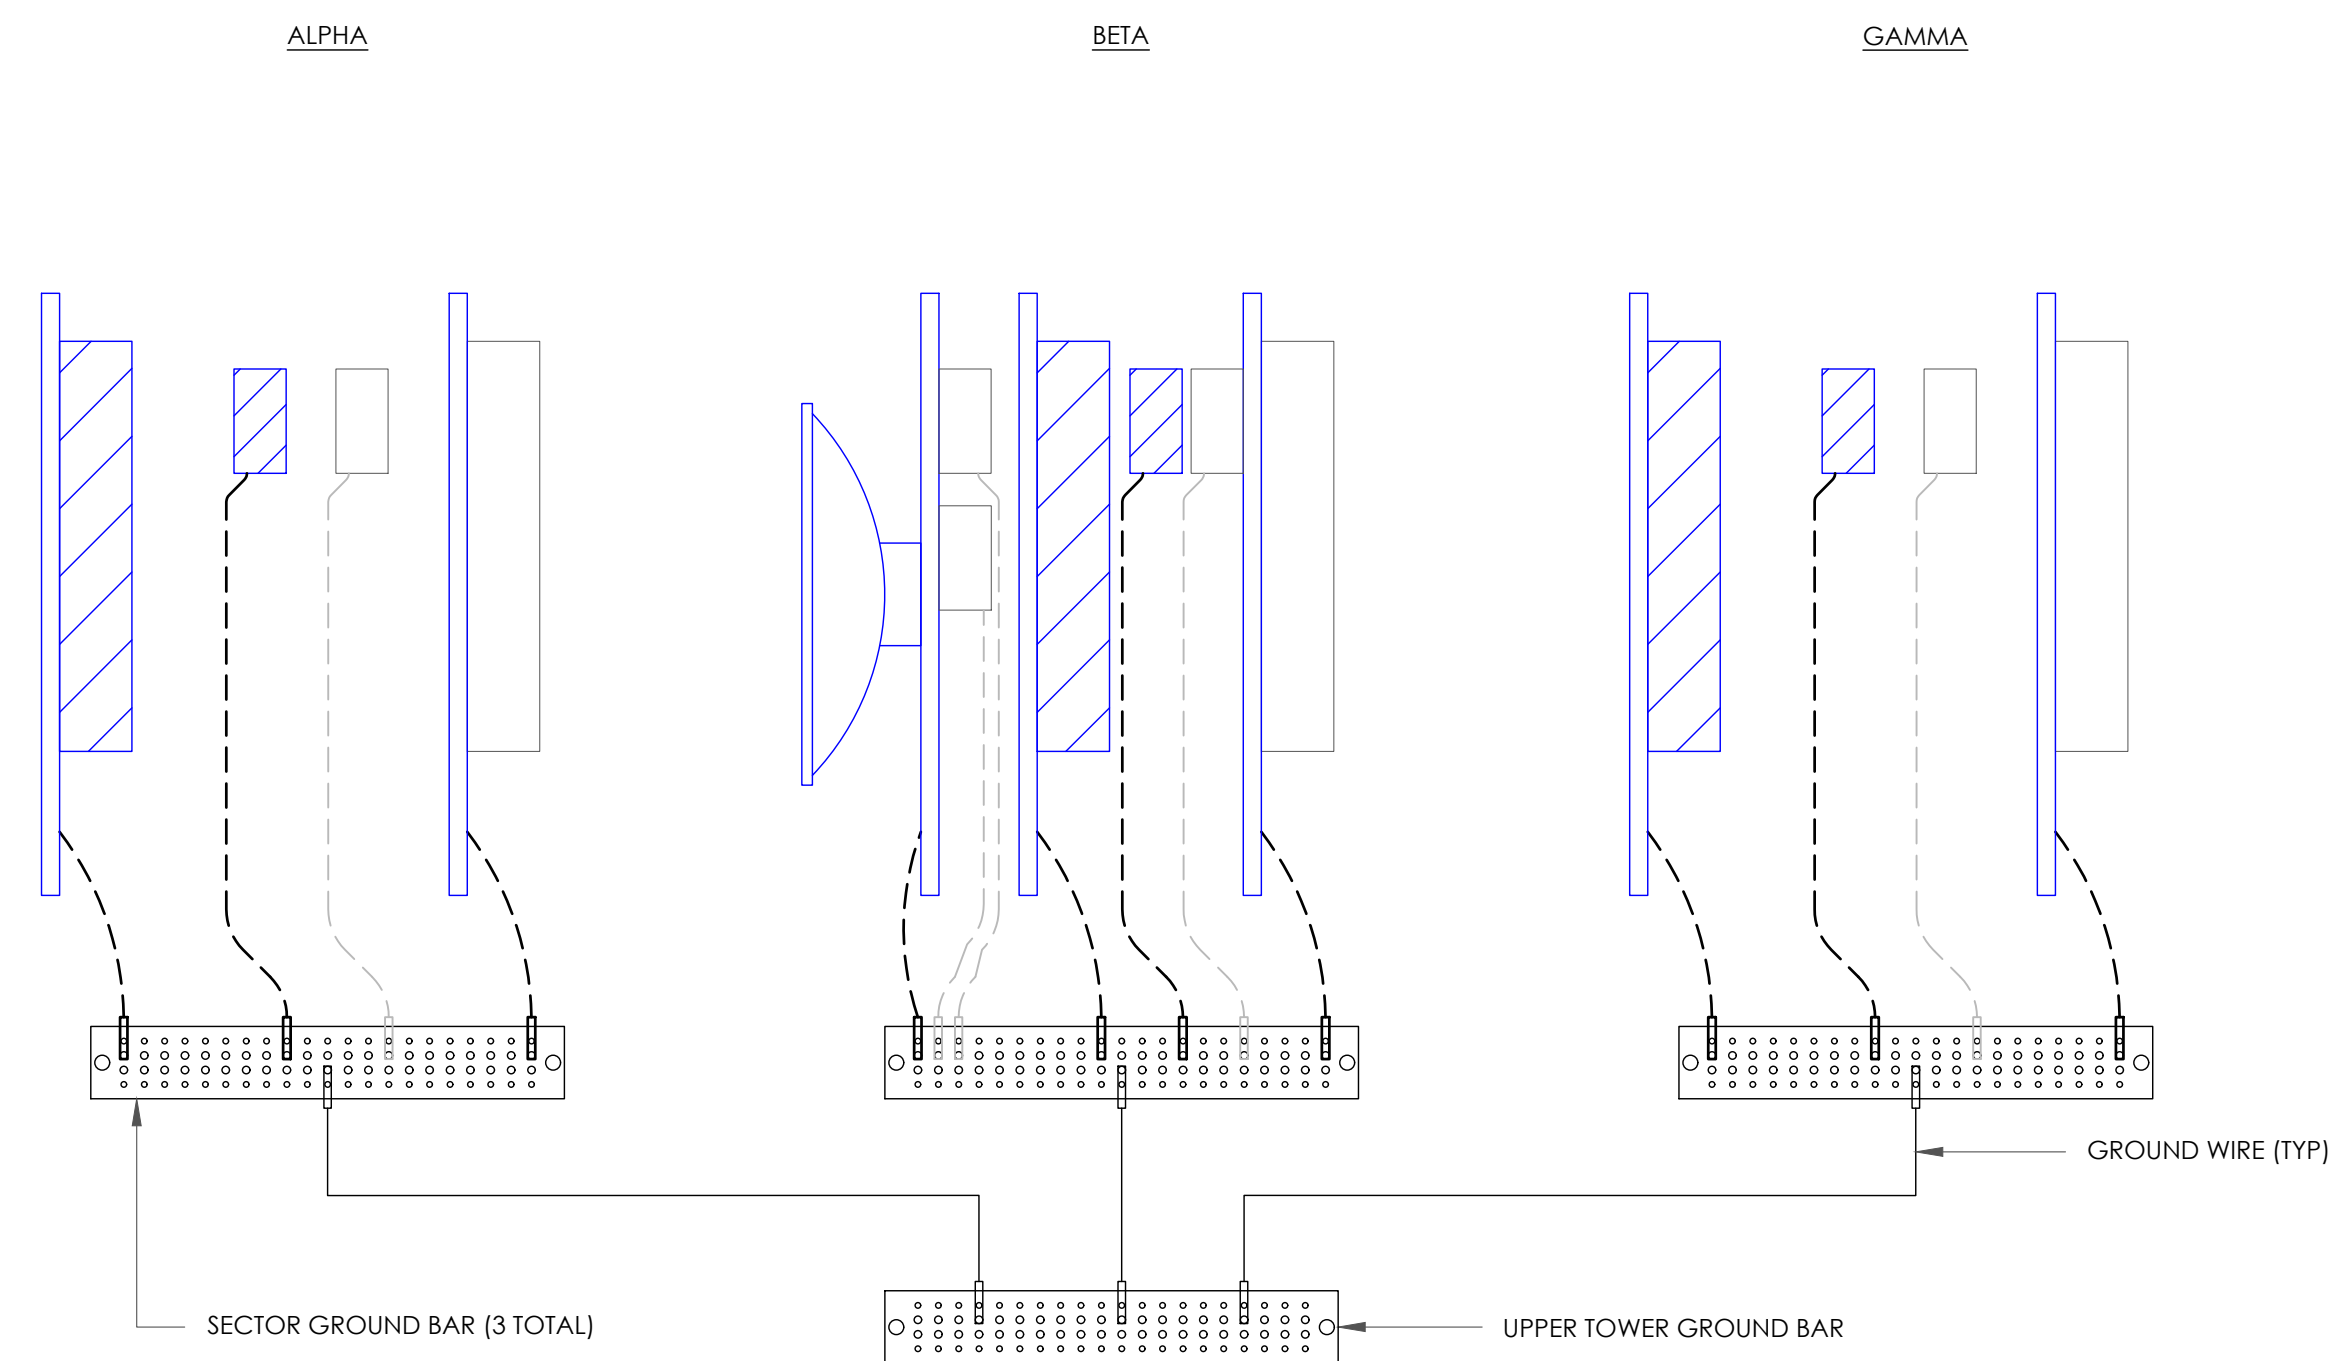

GROUNDING NOTE:
ALL NEW GROUNDS TO BE #6 STRANDED
COPPER WITH GREEN INSULATION UNLESS
NOTED OTHERWISE.


1 ANTENNA GROUNDING SCHEMATIC
SCALE: NOT TO SCALE

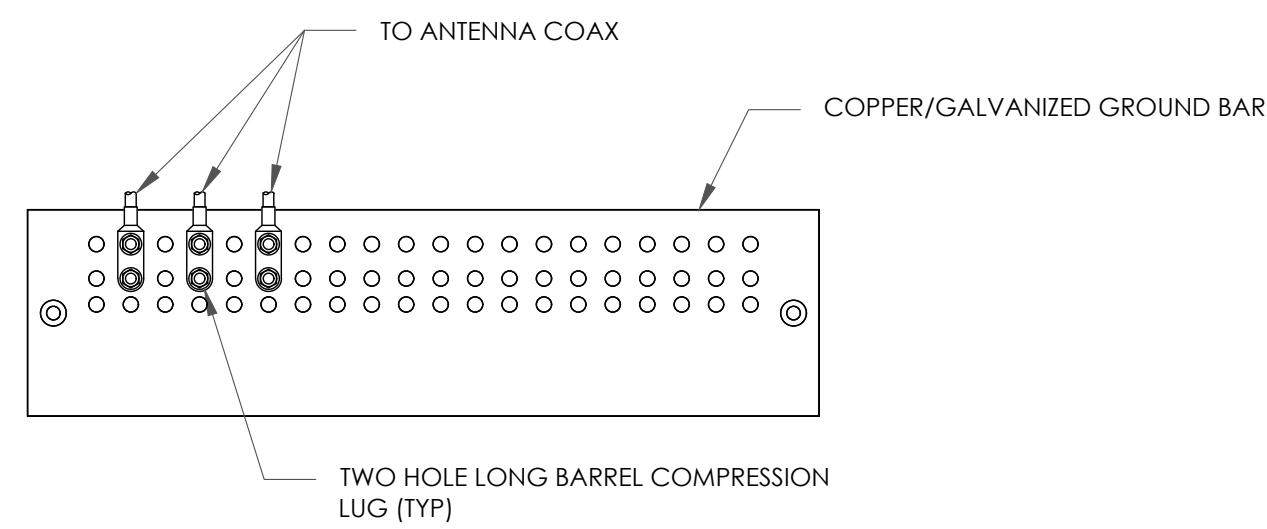

NOTES:

1. DOUBLING UP "OR STACKING" OF CONNECTIONS IS NOT PERMITTED.
2. EXTERIOR ANTIOXIDANT JOINT COMPOUND TO BE USED ON ALL EXTERIOR CONNECTIONS.
3. GROUND BAR SHALL NOT BE ISOLATED FROM TOWER. MOUNT DIRECTLY TO ANTENNA MOUNT STEEL.

1 ANTENNA SECTOR GROUND BAR DETAIL
SCALE: NOT TO SCALE

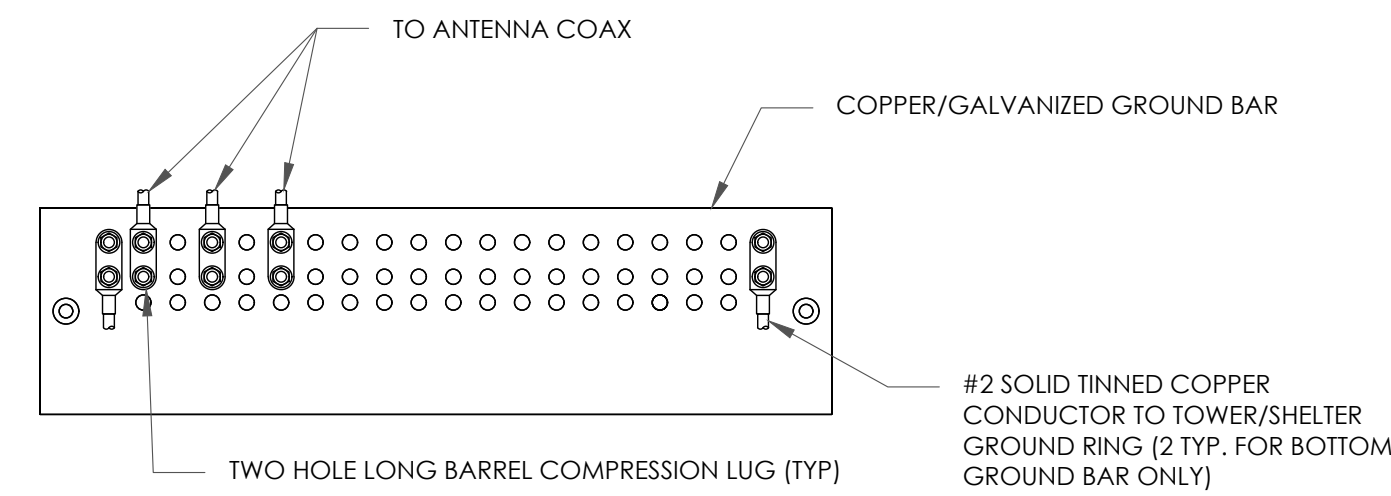


NOTES:

1. EXTERIOR ANTIOXIDANT JOINT COMPOUND TO BE USED ON ALL EXTERIOR CONNECTIONS.
2. GROUND BAR SHALL NOT BE ISOLATED FROM TOWER. MOUNT DIRECTLY TO TOWER STEEL (TOWER ONLY).
3. GROUND BAR SHALL BE ISOLATED FROM BUILDING OR SHELTER.

2 TOWER/SHELTER GROUND BAR DETAIL
SCALE: NOT TO SCALE


3 NOT USED
SCALE: NOT TO SCALE

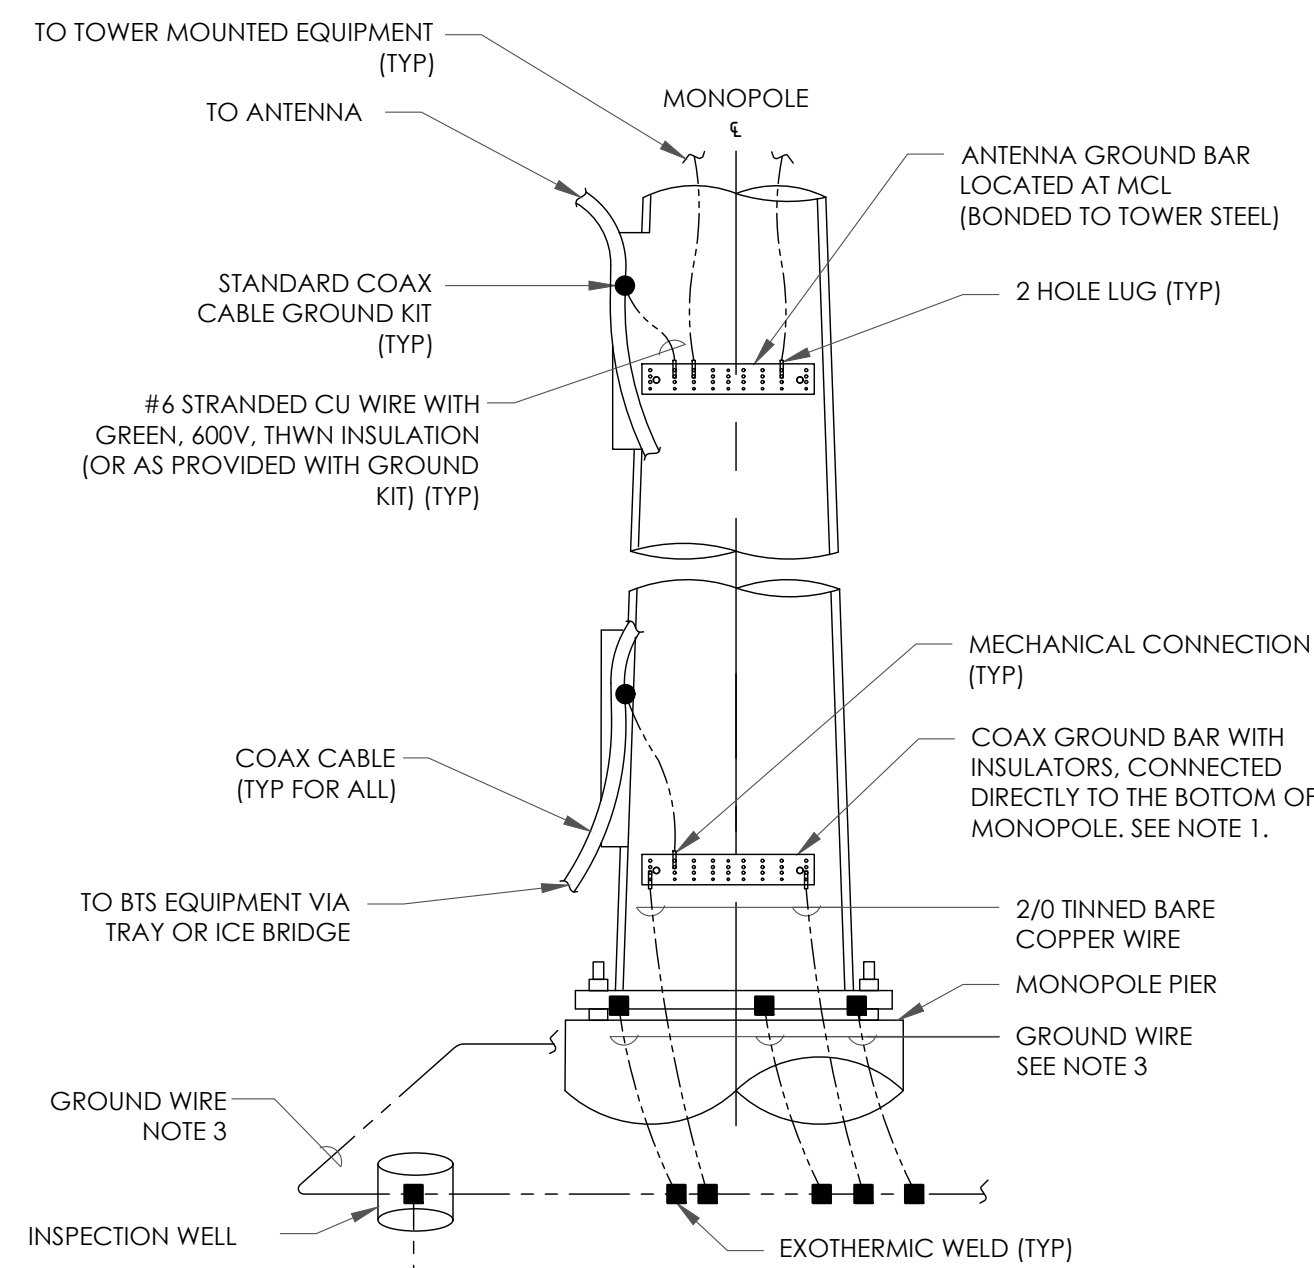


NOTES:

1. NUMBER OF GROUNDING BARS MAY VARY DEPENDING ON THE TYPE OF TOWER, ANTENNA LOCATIONS AND CONNECTION ORIENTATION. COAXIAL CABLES EXCEEDING 200 FEET ON THE TOWER SHALL HAVE GROUND KITS AT THE MIDPOINT. PROVIDE AS REQUIRED.
2. ONLY MECHANICAL CONNECTIONS ARE ALLOWED TO BE MADE TO CROWN CASTLE USA INC. TOWERS. ALL MECHANICAL CONNECTIONS SHALL BE TREATED WITH AN ANTI-OXIDANT COATING.
3. ALL TOWER GROUNDING SYSTEMS SHALL COMPLY WITH THE REQUIREMENTS OF THE RECOGNIZED EDITION OF ANS/TIA 222 AND NFPA 780.


4 TYPICAL ANTENNA CABLE GROUNDING
SCALE: NOT TO SCALE

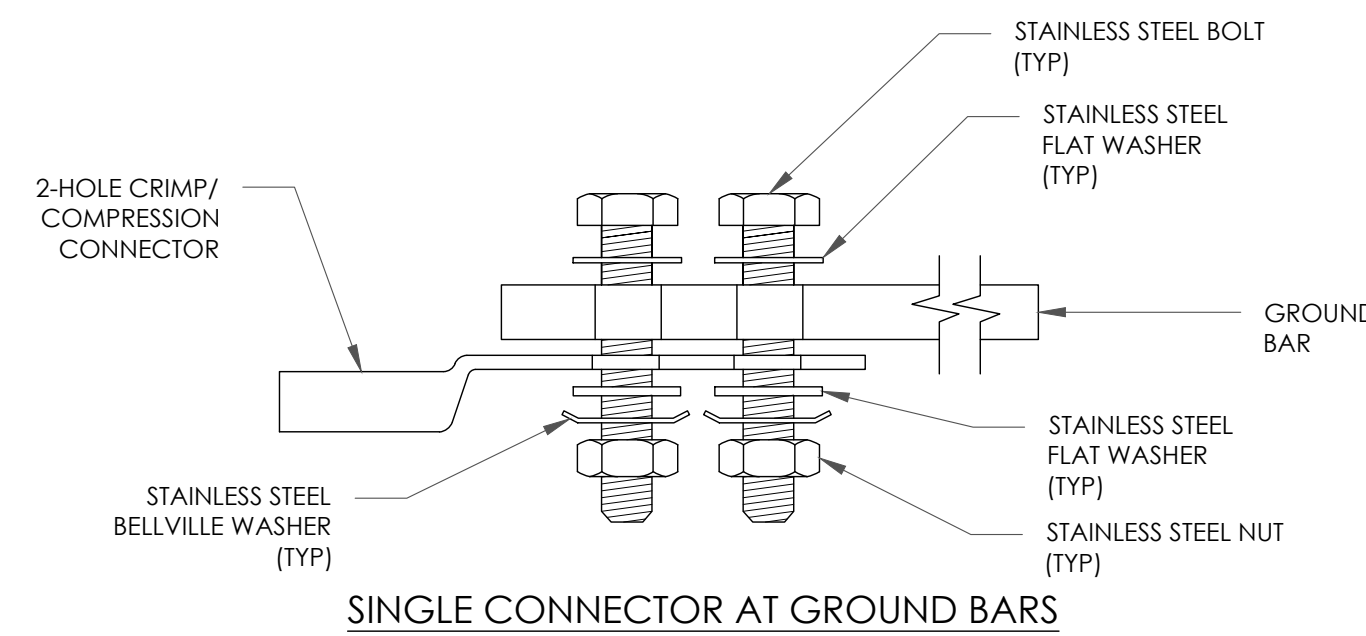

SINGLE CONNECTOR AT GROUND BARS

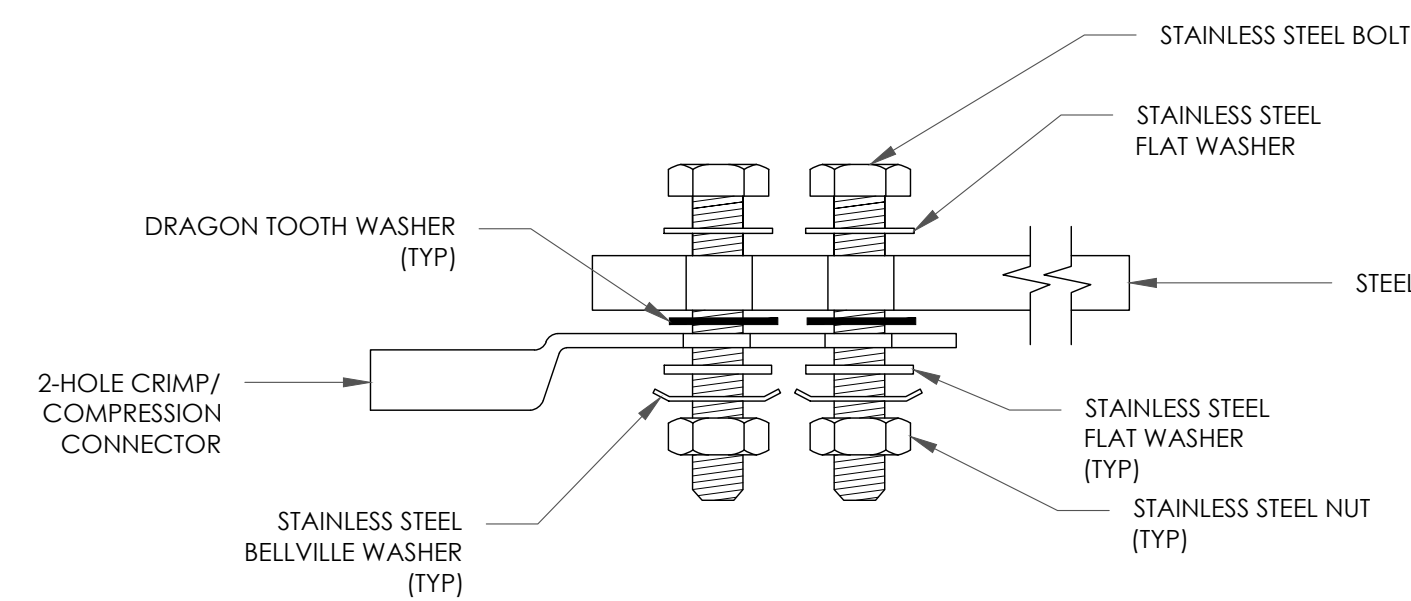

SINGLE CONNECTOR AT STEEL OBJECTS

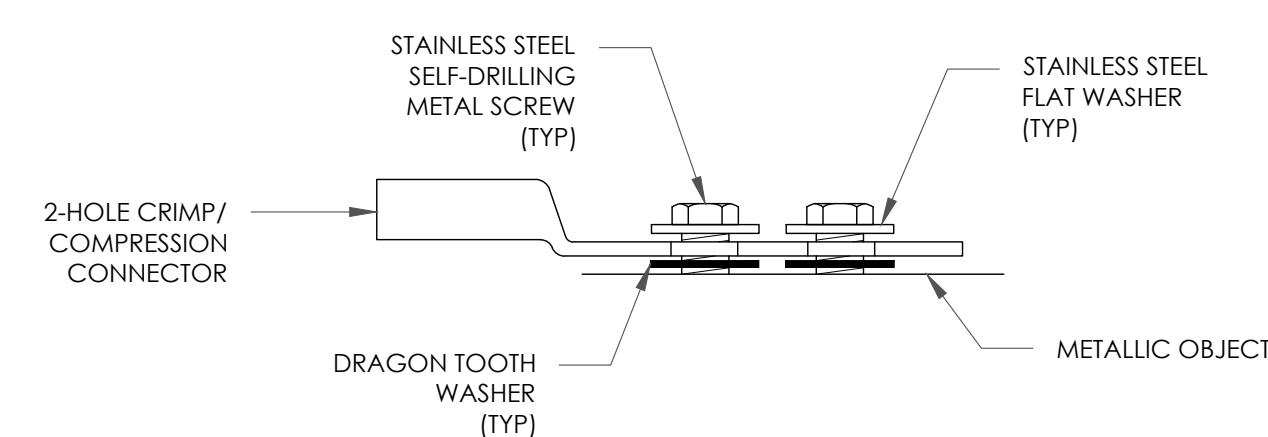

SINGLE CONNECTOR AT METALLIC/STEEL OBJECTS

5 HARDWARE DETAIL FOR EXTERIOR CONNECTIONS
SCALE: NOT TO SCALE

6 NOT USED
SCALE: NOT TO SCALE

T-Mobile

1200 CONCORD AVE., SUITE 500
CONCORD, CA 94520

CROWN CASTLE

1 PARK PLACE, SUITE 300
DUBLIN, CA 94568

PMA

P. MARSHALL & ASSOCIATES
6801 PORTWEST DR. STE 100,
HOUSTON, TX 77024
OFFICE 713-677-0964

T-MOBILE SITE NUMBER:
SF40959A

BU #: 857683

CROWN: AT&T NEW
POTTER VALLEY

12531 EEL RIVER ROAD
POTTER VALLEY, CA 95469

EXISTING 65'-0" MONOPOLE

ISSUED FOR:

REV	DATE	DRWN	DESCRIPTION	DES./QA
A	12/20/23	AW	PRELIMINARY	HS
0	01/31/24	SM	FINAL CD	HS




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PROJECT NUMBER:
23CCTCAM-127

SHEET NUMBER: G-3
REVISION: 0

1 NOT USED
SCALE: NOT TO SCALE

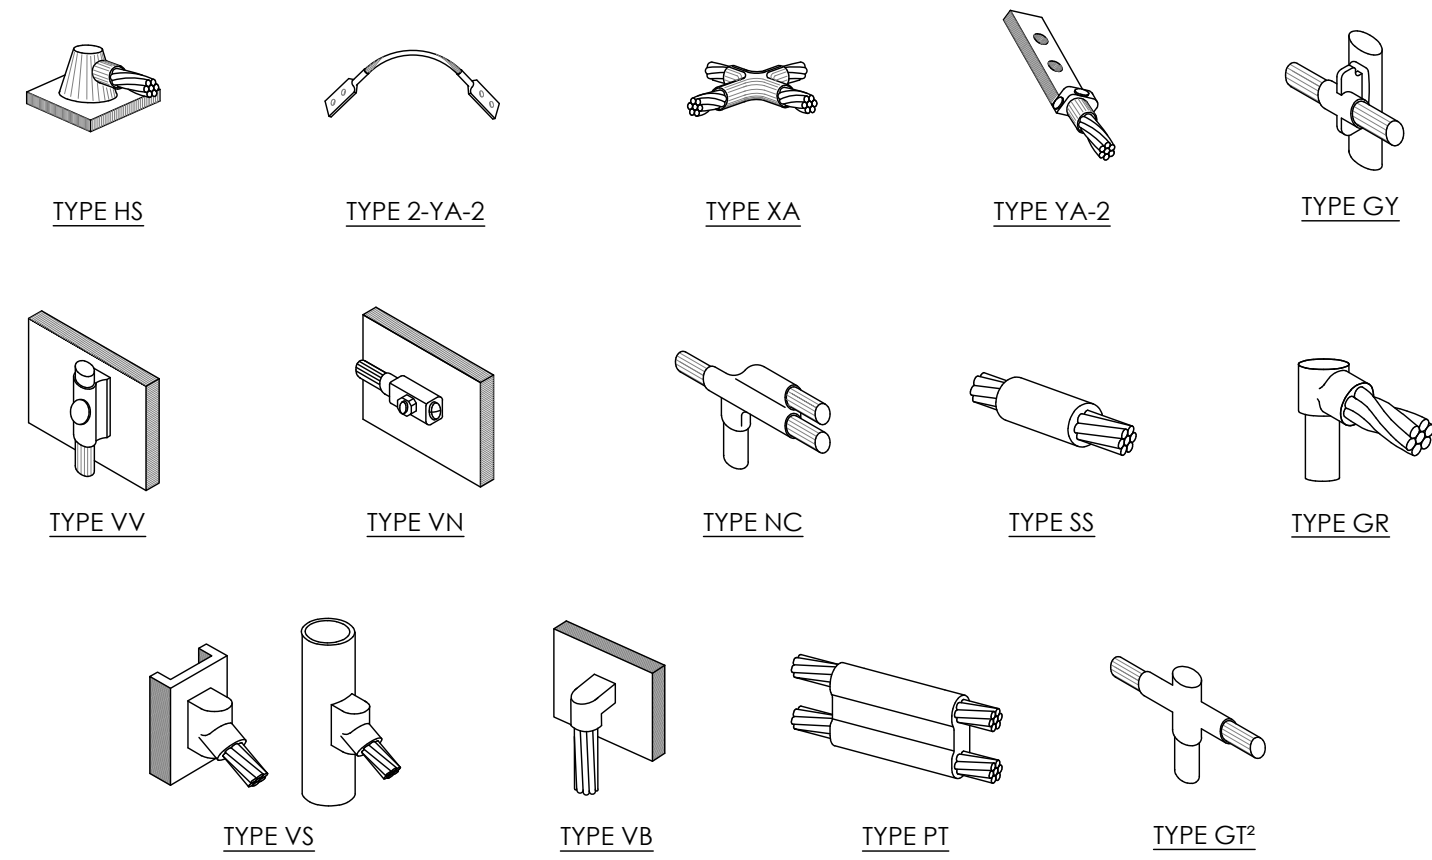


NOTES:
1. ERICO EXOTHERMIC "MOLD TYPES" SHOWN HERE ARE EXAMPLES. CONSULT WITH CONSTRUCTION MANAGER FOR SPECIFIC MOLDS TO BE USED FOR THIS PROJECT.
2. MOLD TYPE ONLY TO BE USED BELOW GRADE WHEN CONNECTING GROUND RING TO GROUND ROD.

4 CADWELD GROUNDING CONNECTIONS
SCALE: NOT TO SCALE


6 TRANSITIONING GROUND DETAIL
SCALE: NOT TO SCALE

2 NOT USED
SCALE: NOT TO SCALE

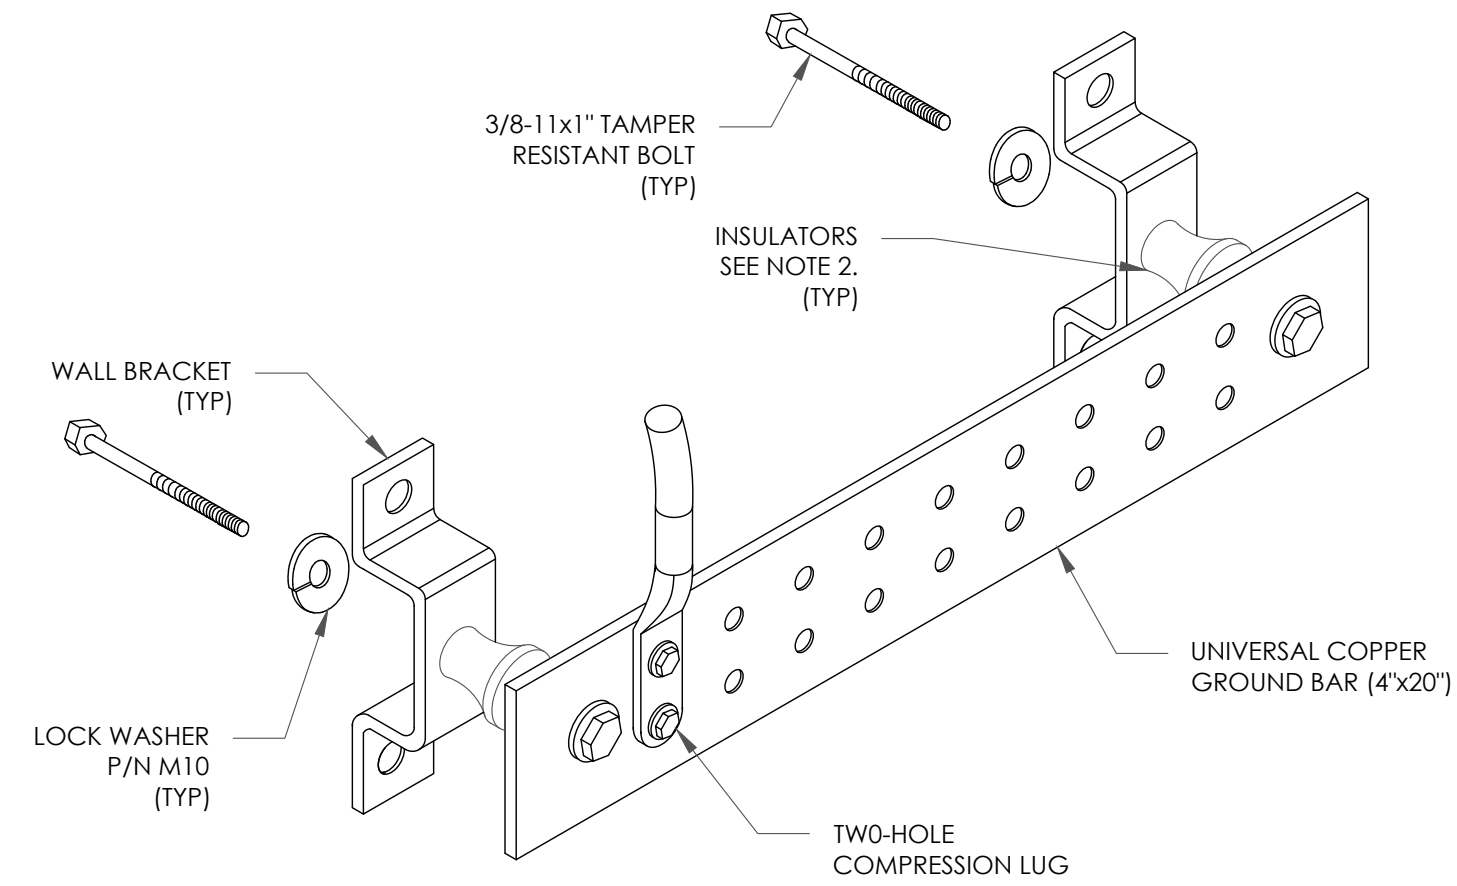


NOTES:
1. DOWN LEAD (HOME RUN) CONDUCTORS ARE NOT TO BE INSTALLED ON CROWN CASTLE USA INC. TOWER, PER THE GROUNDING DOWN CONDUCTOR POLICY QAS-STD-10091. NO MODIFICATION OR DRILLING TO TOWER STEEL IS ALLOWED IN ANY FORM OR FASHION, CAD-WELDING ON THE TOWER AND/OR IN THE AIR ARE NOT PERMITTED.
2. OMIT INSULATOR WHEN MOUNTING TO TOWER STEEL OR PLATFORM STEEL. USE INSULATORS WHEN ATTACHING TO BUILDING OR SHELTERS.

5 GROUND BAR DETAIL
SCALE: NOT TO SCALE

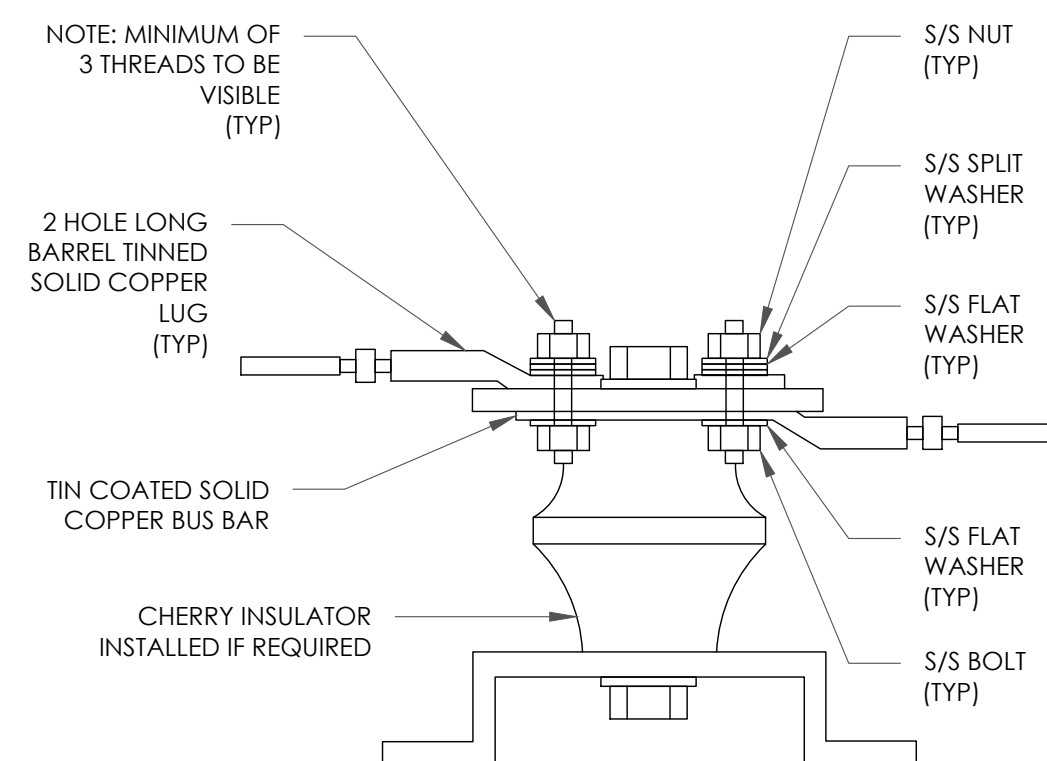

7 LUG DETAIL
SCALE: NOT TO SCALE

WIRE SIZE	BURNDY LUG	BOLT SIZE
#6 GREEN INSULATED	YA6C-2TC38	3/8" - 16 NC SS 2 BOLT
#2 SOLID TINNED	YA3C-2TC38	3/8" - 16 NC SS 2 BOLT
#2 STRANDED	YA2C-2TC38	3/8" - 16 NC SS 2 BOLT
#2/0 STRANDED	YA26-2TC38	3/8" - 16 NC SS 2 BOLT
#4/0 STRANDED	YA28-2N	1/2" - 16 NC SS 2 BOLT

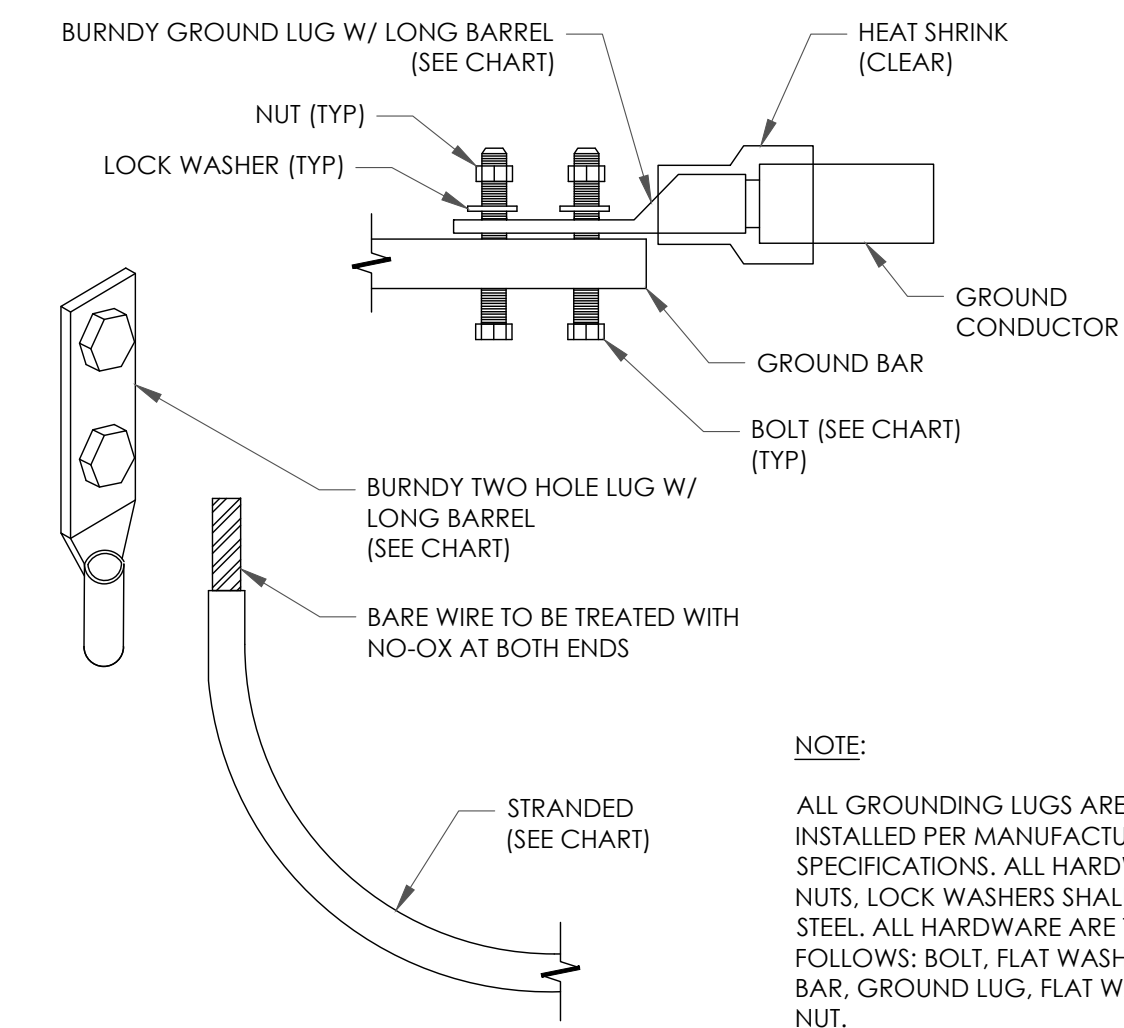

NOTE:
ALL GROUNDING LUGS ARE TO BE INSTALLED PER MANUFACTURER'S SPECIFICATIONS. ALL HARDWARE BOLTS, NUTS, LOCK WASHERS SHALL BE STAINLESS STEEL. ALL HARDWARE ARE TO BE AS FOLLOWS: BOLT, FLAT WASHER, GROUND BAR, GROUND LUG, FLAT WASHER AND NUT.

3 MECHANICAL LUG CONNECTION
SCALE: NOT TO SCALE

8 NOT USED
SCALE: NOT TO SCALE

T-Mobile

1200 CONCORD AVE., SUITE 500
CONCORD, CA 94520

CROWN CASTLE

1 PARK PLACE, SUITE 300
DUBLIN, CA 94568

PM&A

P. MARSHALL & ASSOCIATES
6801 PORTWEST DR. STE 100,
HOUSTON, TX 77024
OFFICE 713-677-0964

T-MOBILE SITE NUMBER:
SF40959A

BU #: 857683
CROWN: AT&T NEW
POTTER VALLEY

12531 EEL RIVER ROAD
POTTER VALLEY, CA 95469

EXISTING 65'-0" MONOPOLE

ISSUED FOR:

REV	DATE	DRWN	DESCRIPTION	DES./QA
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PROJECT NUMBER:
23CCTCAM-127

SHEET NUMBER: G-4
REVISION: 0



8020 Katy Fwy
Houston, TX 77024

Phone: (678) 366-1259
www.crowncastle.com

Project Data Sheet	
Business Unit (BU)	857683
Application/Order Number	657872
Crown Castle Site Name	CA371 - POTTER VALLEY
Customer Site Number	SF40959A
Site Address	12531 EEL RIVER ROAD
Site City, State, Zip	POTTER VALLEY, CA 95469
Parcel Tax ID	175-010-10-00
Applicant / Agent	T-Mobile West LLC by Crown Castle USA Inc.
Agent Address	8020 Katy Fwy
Agent phone number	(678) 366-1259
Carrier	T-Mobile
Scope of work	Add or replace antennas, ancillary equipment and ground equipment as per plans for an existing carrier on an existing wireless communication facility.
Property Owner	GLOBAL SIGNAL ACQUISITIONS IV LLC
Property Owner Address	PO BOX 277455, ATLANTA, GA 30384-7455
Structure Type	MONOPOLE
Structure Height	65 FT
Antenna Equipment Height	54
Size of Compound Sq. Ft.	2,304 sq ft
Latitude	39° 19' 52.9"
Longitude	-123° 5' 53.2"
Zoning Jurisdiction	COUNTY OF MENDOCINO, CA
Zoning Jurisdiction Address	860 NORTH BUSH STREET, UKIAH, CA 95482
Permitting Jurisdiction	COUNTY OF MENDOCINO, CA
Permitting Jurisdiction Address	860 NORTH BUSH STREET, UKIAH, CA 95482



8020 Katy Fwy
Houston, TX 77024

Phone: (678) 366-1259
www.crowncastle.com

February 12, 2024

COUNTY OF MENDOCINO, CA
Mendocino County Building Services
860 NORTH BUSH STREET
UKIAH, CA 95482

Via Mail

*****NOTICE OF ELIGIBLE FACILITIES REQUEST*****

RE: Request for Minor Modification to Existing Wireless Facility – Section 6409
Notice of Request for Approval of Emergency Standby Generator – CA AB 2421
Site Address: 12531 EEL RIVER ROAD, POTTER VALLEY, CA 95469
Crown Site Number: 857683 / Crown Site Name: CA371 - POTTER VALLEY
Customer Site Number: SF40959A / Application Number: 657872

Attention Reviewing Parties:

On behalf of T-Mobile West LLC (“T-Mobile” or “Applicant”), Crown Castle USA Inc. (“Crown Castle”) is pleased to submit this request to modify the existing wireless facility noted above through the collocation, replacement and/or removal of the Applicant’s equipment as an eligible facilities request for a minor modification under Section 6409¹ and the rules of the Federal Communications Commission (“FCC”).²

Section 6409 mandates that state and local governments must approve any eligible facilities request for the modification of an existing wireless tower or base station that does not substantially change the physical dimensions of such tower or base station. Under Section 6409, to toll the review period, if the reviewing authority determines that the application is incomplete, it must provide written notice to the applicant within 30 days, which clearly and specifically delineates all missing documents or information reasonably related to whether the request meets the federal requirements.³ Additionally, if a state or local government, fails to issue any approvals required for this request within 60 days, these approvals are deemed granted. The FCC has clarified that the 30-day and 60-day deadlines begins when an applicant: (1) takes the first step required under state or local law; and (2) submits information sufficient to inform the jurisdiction that this modification qualifies under the federal law⁴.

To further secure public safety and welfare during times of fire emergencies, California AB 2421 provides for local administrative non-discretionary review of emergency standby generators as a permitted use, which a local agency shall review on an administrative, nondiscretionary basis. This law further allows applicants to concurrently seek landowner

¹ Middle Class Tax Relief and Job Creation Act of 2012, Pub. L. No. 112-96, § 6409 (2012) (codified at 47 U.S.C. § 1455).
² *Acceleration of Broadband Deployment by Improving Wireless Facility Siting Policies*, 29 FCC Rcd. 12865 (2014) (codified at 47 CFR § 1.6100); and *Implementation of State & Local Governments’ Obligation to Approve Certain Wireless Facility Modification Requests Under Section 6409(a) of the Spectrum Act of 2012*, WT Docket No. 19-250 (June 10, 2020).
³ See 47 CFR § 1.6100 (c)(3). ⁴ See 2020 Upgrade Order at paragraph 16.



8020 Katy Fwy
Houston, TX 77024

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www.crowncastle.com

consent, and states that such emergency standby generator application is deemed approved if not ruled upon within (60) days after a complete application is received by the local jurisdiction, excluding tolling. As indicated in the attached checklist, this application qualifies for review under this important law as well.

Please note that with the submission of this letter and enclosed items, the thirty and sixty-day review periods have started. Based on this filing, the deadline for written notice of incomplete application is March 13, 2024, and the deadline for issuance of approval is April 12, 2024.



8020 Katy Fwy
Houston, TX 77024

Phone: (678) 366-1259
www.crowncastle.com

The proposed scope of work for this project includes:

The installation of a backup power supply as per plans for an existing wireless carrier at an existing wireless communication facility.

At the end of this letter is a checklist of the applicable substantial change criteria under Section 6409. Additionally, please find enclosed the following information in support of this request:

- (1) ;
- (2) Construction Drawings;
- (3) Structural Analysis; and
- (4) Section 6409 Substantial Change Checklist and CA AB 2421 Checklist.

As these documents indicate, this modification is an “eligible facilities request” as defined in the FCC’s rules to which the 60-day deadline for approval applies. Further, the modification is a permitted under California AB 2421 that for which approval is administrative and nondiscretionary. Accordingly, Applicant requests all authorization necessary for this proposed modification.

Our goal is to work with you to obtain approvals earlier than the deadline. We will respond promptly to any request for related information you may have in connection with this request. Please let us know how we can work with you to expedite the approval process. We look forward to working with you on this important project, which will improve wireless telecommunication services in your community using collocation on existing infrastructure. If you have any questions, please do not hesitate to contact me.

Regards,

Victoria Chhun

Victoria Chhun
Permitting Specialist
Crown Castle, Agent for Applicant
(678) 366-1259
Victoria.Chhun@crowncastle.com



8020 Katy Fwy
Houston, TX 77024

Phone: (678) 366-1259
www.crowncastle.com

**Section 6409 Substantial Change Checklist
Towers Outside of the Public Right of Way**

The Federal Communications Commission has determined that a modification substantially changes the physical dimension of a wireless tower or base station under 47 U.S.C. § 1455(a) if it meets one of six enumerated criteria under 47 C.F.R. § 1.6100.

Criteria for Towers Outside the Public Rights of Way


YES/NO NO	Does the modification increase the height of the tower by more than the greater of: (a) 10% (b) or, the height of an additional antenna array plus separation of up to 20 feet from the top of the nearest existing antenna?
YES/NO NO	Does the modification add an appurtenance to the body of the tower that would protrude from the edge of the tower more than 20 feet or more than the width of the tower structure at the level of the appurtenance, whichever is greater?
YES/NO NO	Does the modification involve the installation of more than the standard number of new equipment cabinets for the technology involved or add more than four new equipment cabinets?
YES/NO NO	Does the modification entail any excavation or deployment outside the current site by more than 30 feet in any direction, not including any access or utility easements?
YES/NO NO	Does the modification defeat the concealment elements of the eligible support structure?
YES/NO NO	Does the modification violate conditions associated with the siting approval with the prior approval the tower or base station other than as specified in 47 C.F.R. § 1.6100(c)(7)(i) – (iv)?

If all questions in the above section are answered “NO,” then the modification does not constitute a substantial change to the existing tower under 47 C.F.R. § 1.6100.

California AB 2421 Streamlined Permitting of Generators


YES/NO NO	Is the proposed generator rated above 50 horsepower?
YES/NO NO	Does the proposed generator have a double-wall storage tank that exceeds 300 gallons?
YES/NO NO	Is the proposed generator located more than 100 feet from the physical structure of the macro cell tower or base station?
YES/NO NO	Are the physical dimensions of the emergency standby generator and storage tank cumulatively larger than 250 cubic feet in volume?

If all questions in the above section are answered “NO”, then the generator project is entitled to streamlined permitting under CA AB 2421.

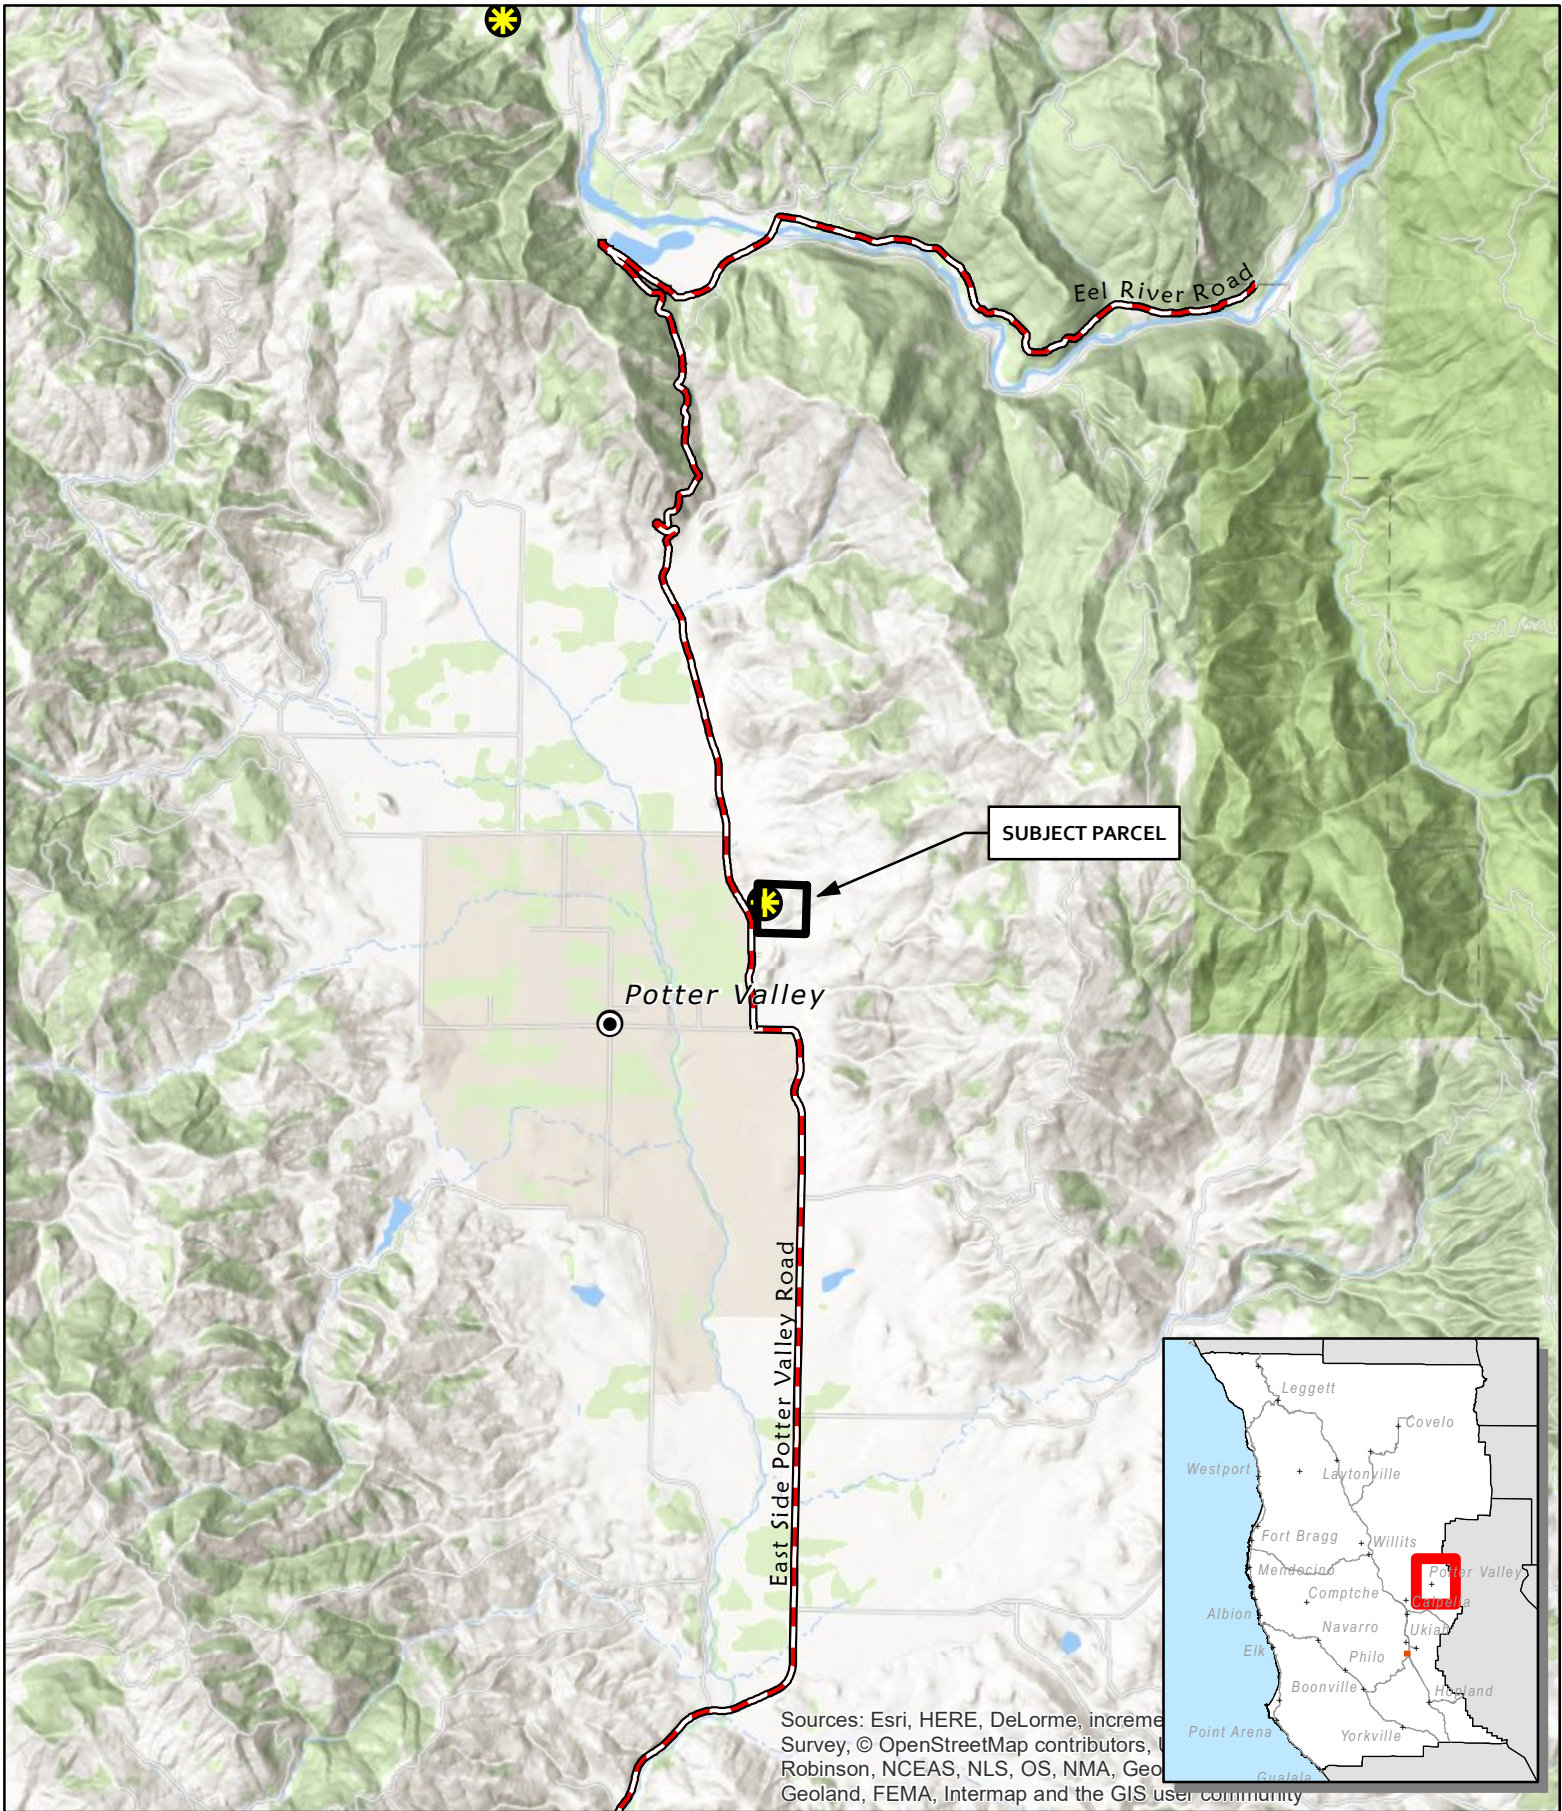

CASE: AP 2024-0013
OWNER: Global Signal Acquisitions
APN: 175-010-10
APLCT: Victoria Chhun
AGENT: Victoria Chhun
ADDRESS: 12531 Eel River Rd, Potter Valley

-  Major Towns & Places
-  Major Roads
-  Approved Wireless Sites

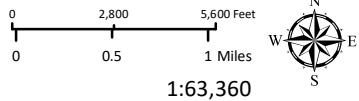

1:63,360

LOCATION


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Source: Esri, Maxar, Earthstar Geographics, and the GIS User Community, IGN, and the GIS User Community

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APN: 175-010-10
APLCT: Victoria Chhun
AGENT: Victoria Chhun
ADDRESS: 12531 Eel River Rd, Potter Valley

-  Major Towns & Places
-  Private Roads
-  Major Roads
-  Driveways/Unnamed Roads
-  Public Roads
-  Approved Wireless Sites




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AERIAL IMAGERY
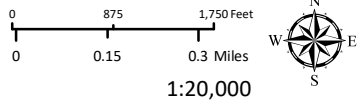
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
Source: Esri, Maxar, Earthstar Geographics, and the GIS User Community, Source: Esri, Maxar, Earthstar Geographics, IGN, and the GIS User Community




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
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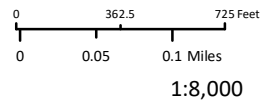
 Approved Wireless Sites
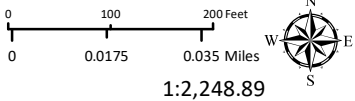
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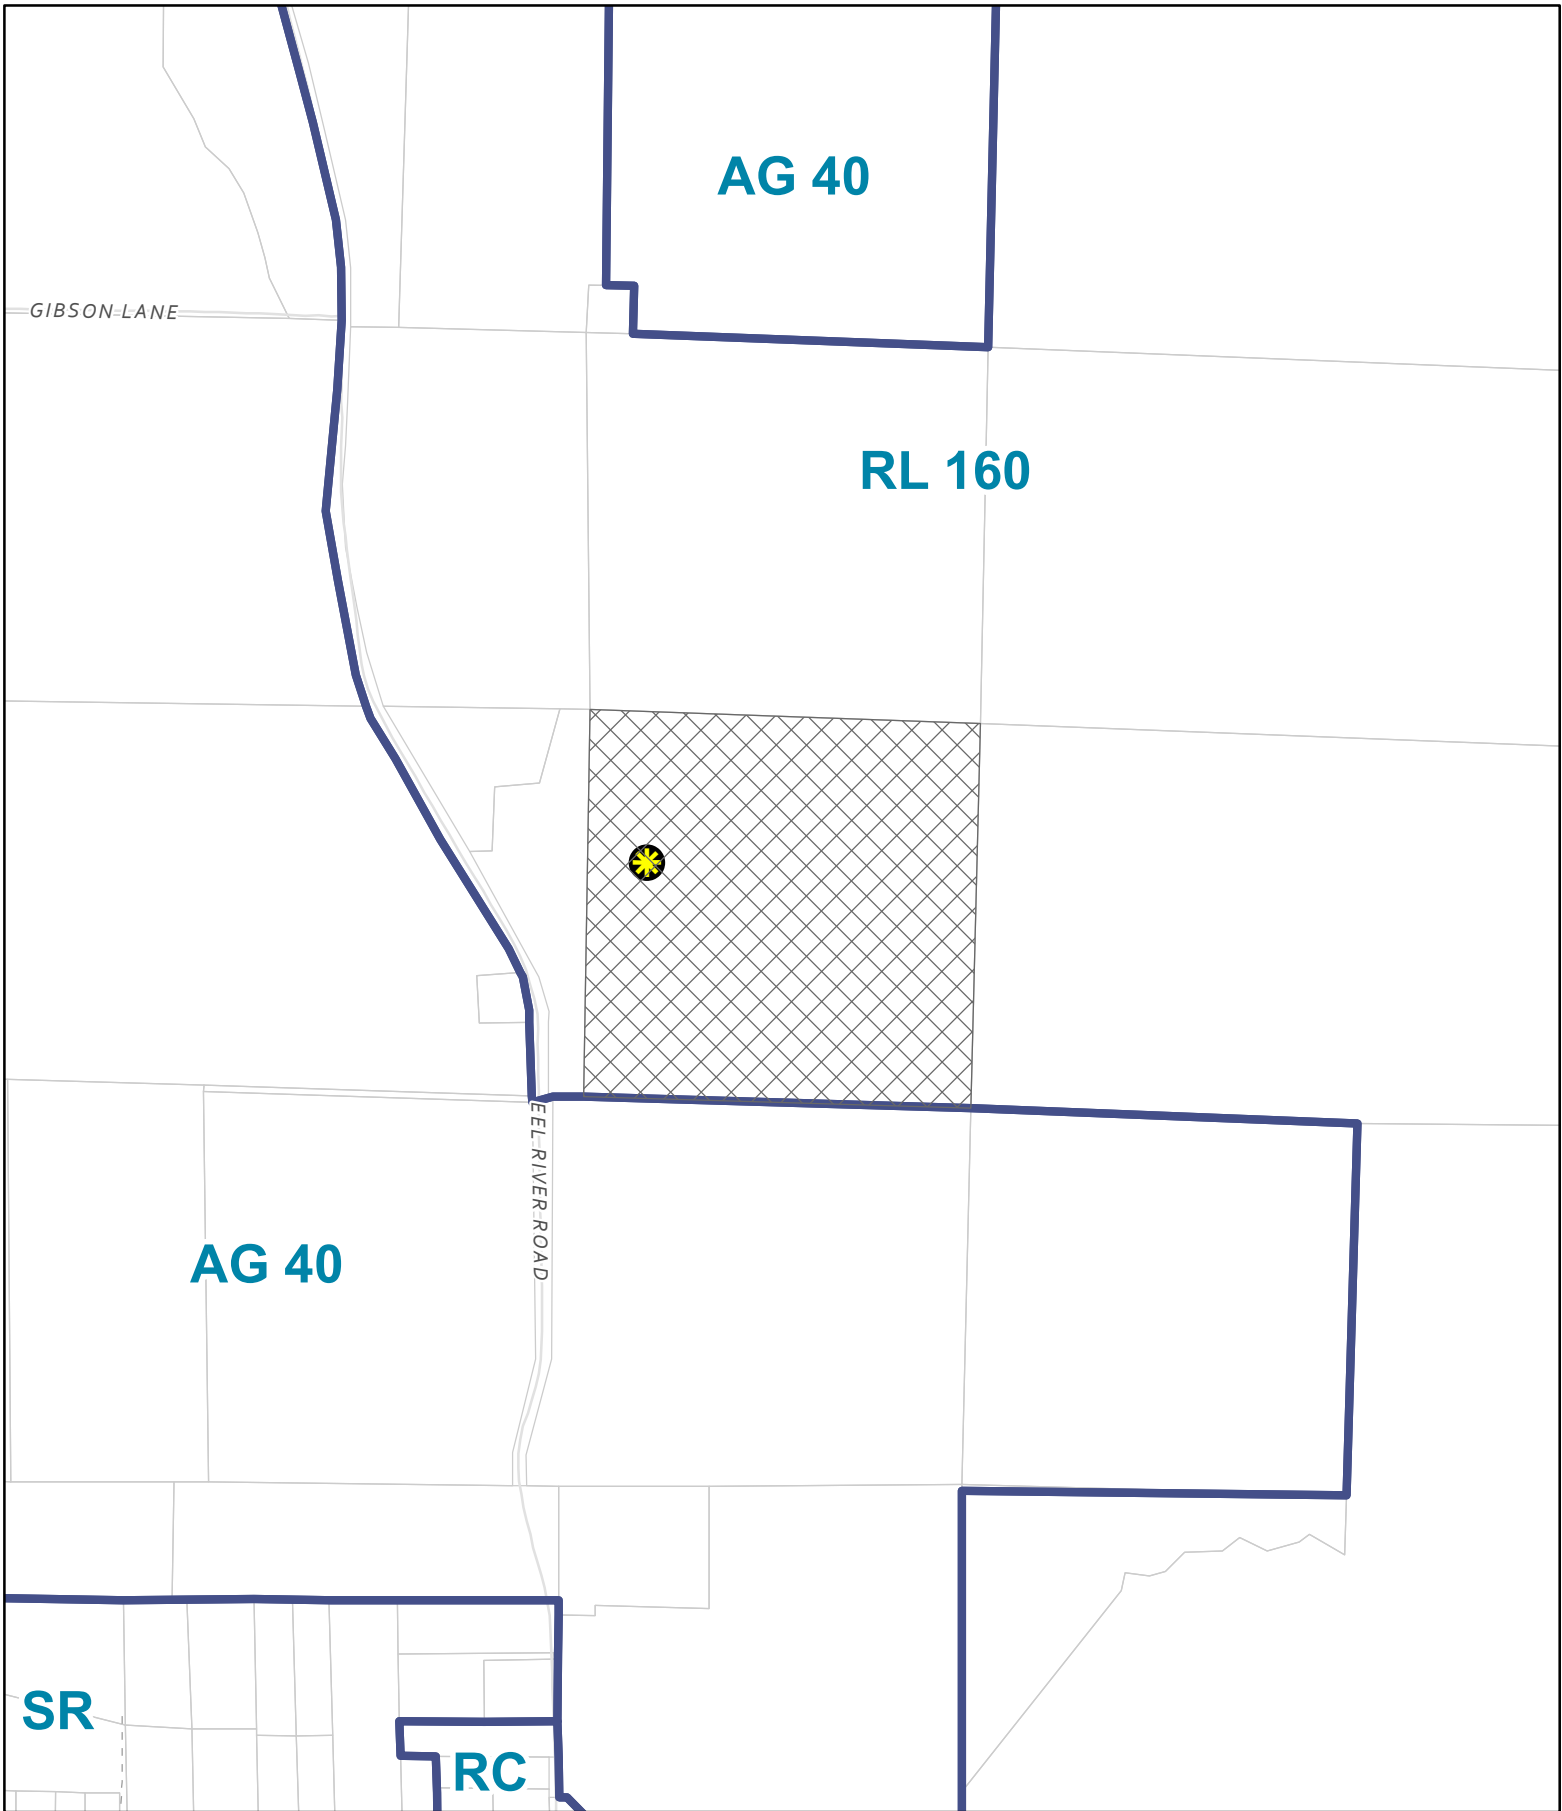
-  Zoning Districts
-  Assessors Parcels
-  Public Roads
-  Approved Wireless Sites
-  Private Roads





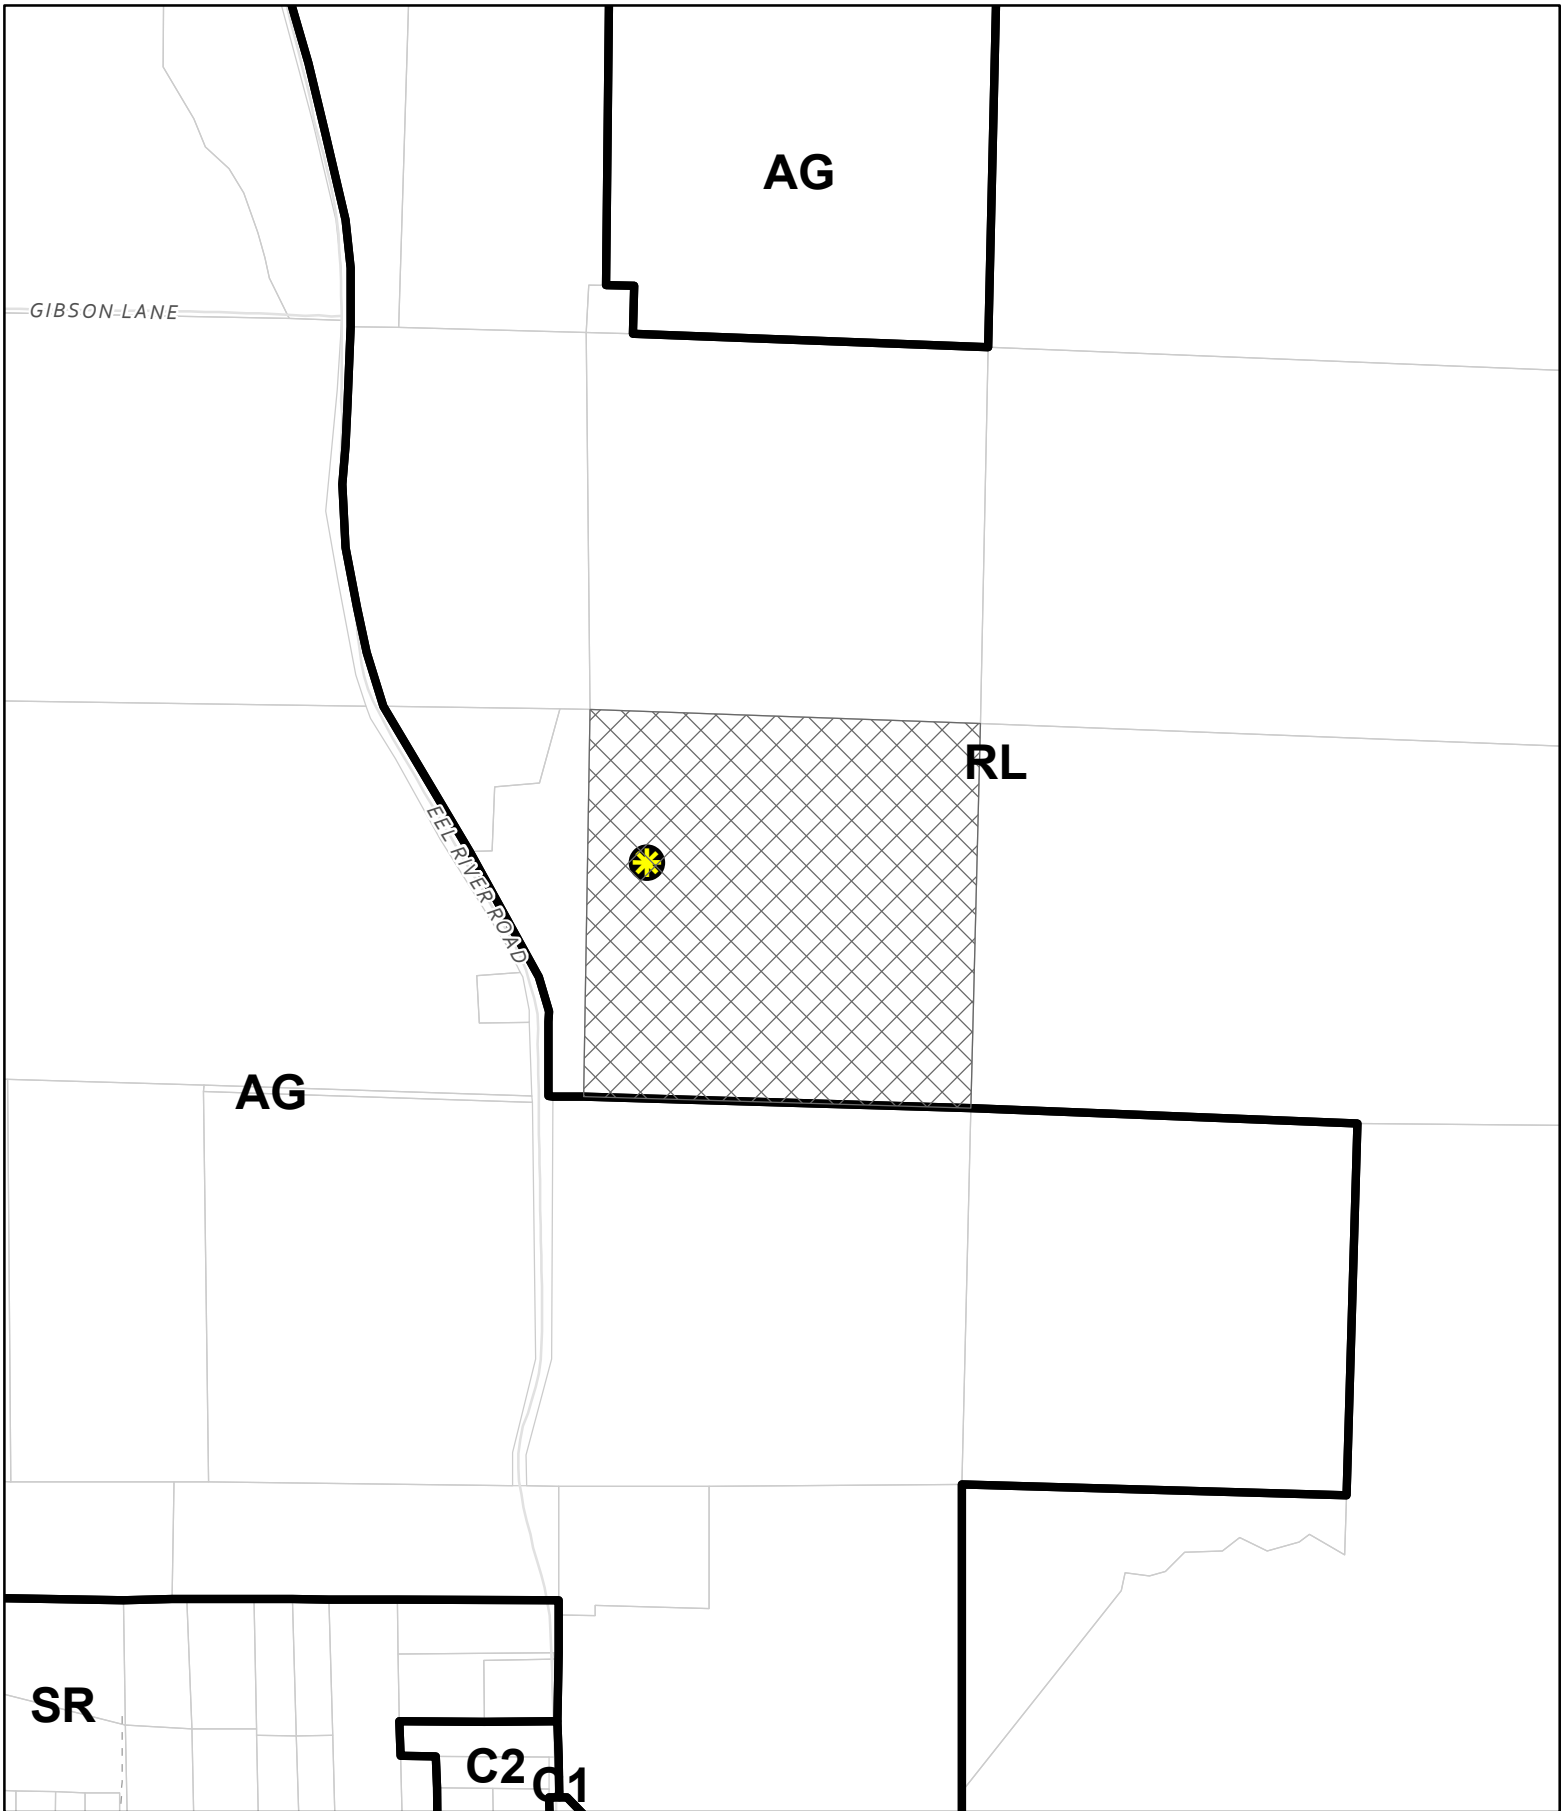

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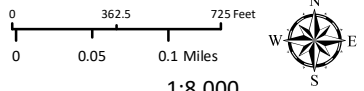
ZONING

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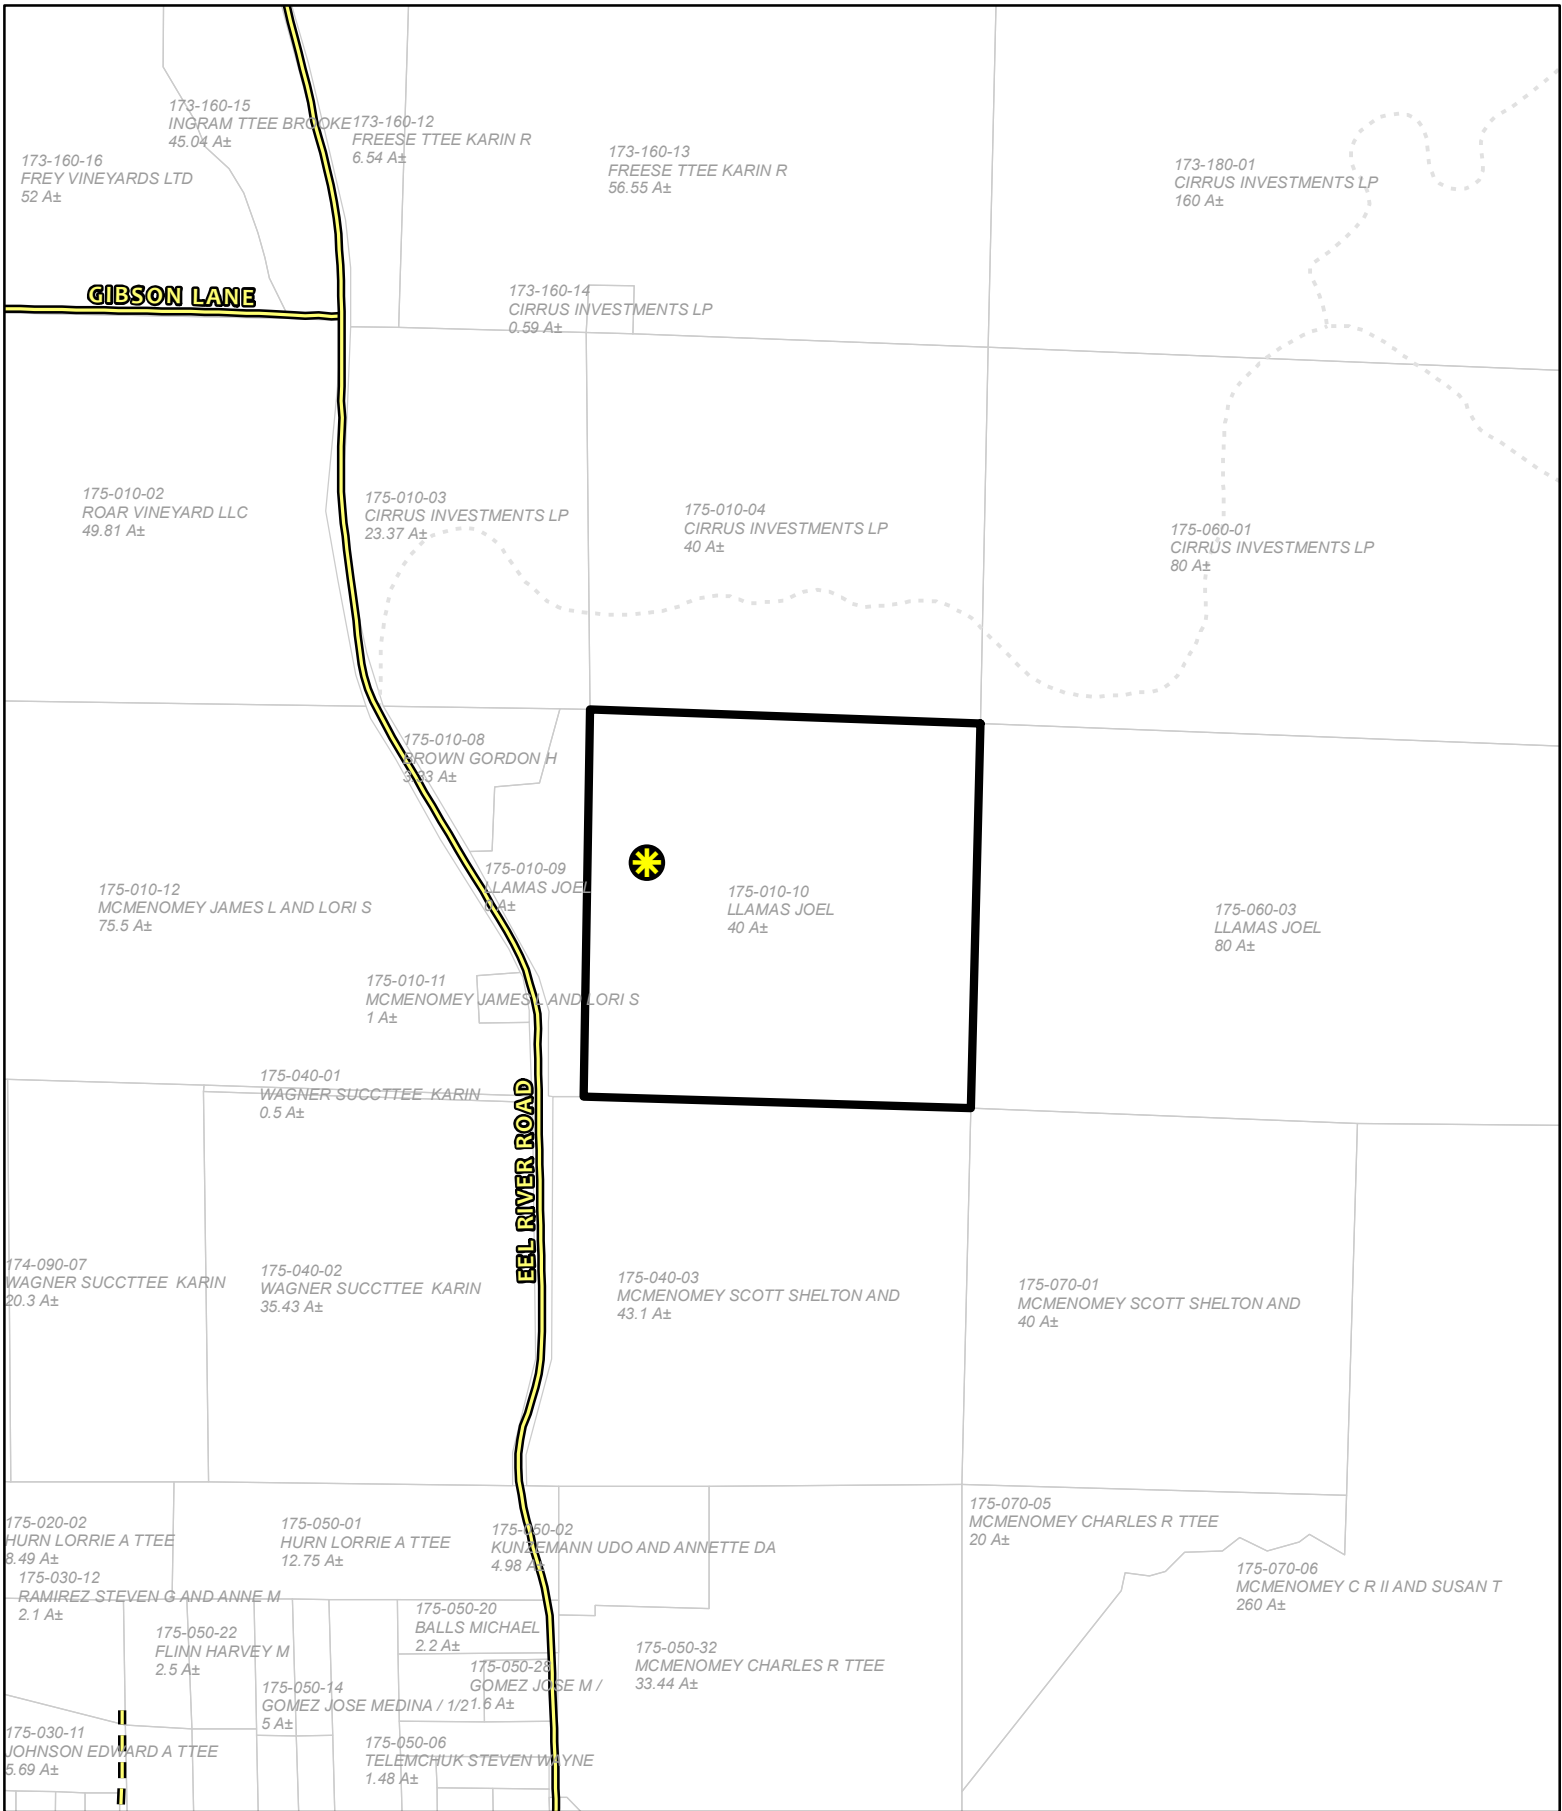
CASE: AP 2024-0013
OWNER: Global Signal Acquisitions
APN: 175-010-10
APLCT: Victoria Chhun
AGENT: Victoria Chhun
ADDRESS: 12531 Eel River Rd, Potter Valley

-  Public Roads
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-  Approved Wireless Sites




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GENERAL PLAN

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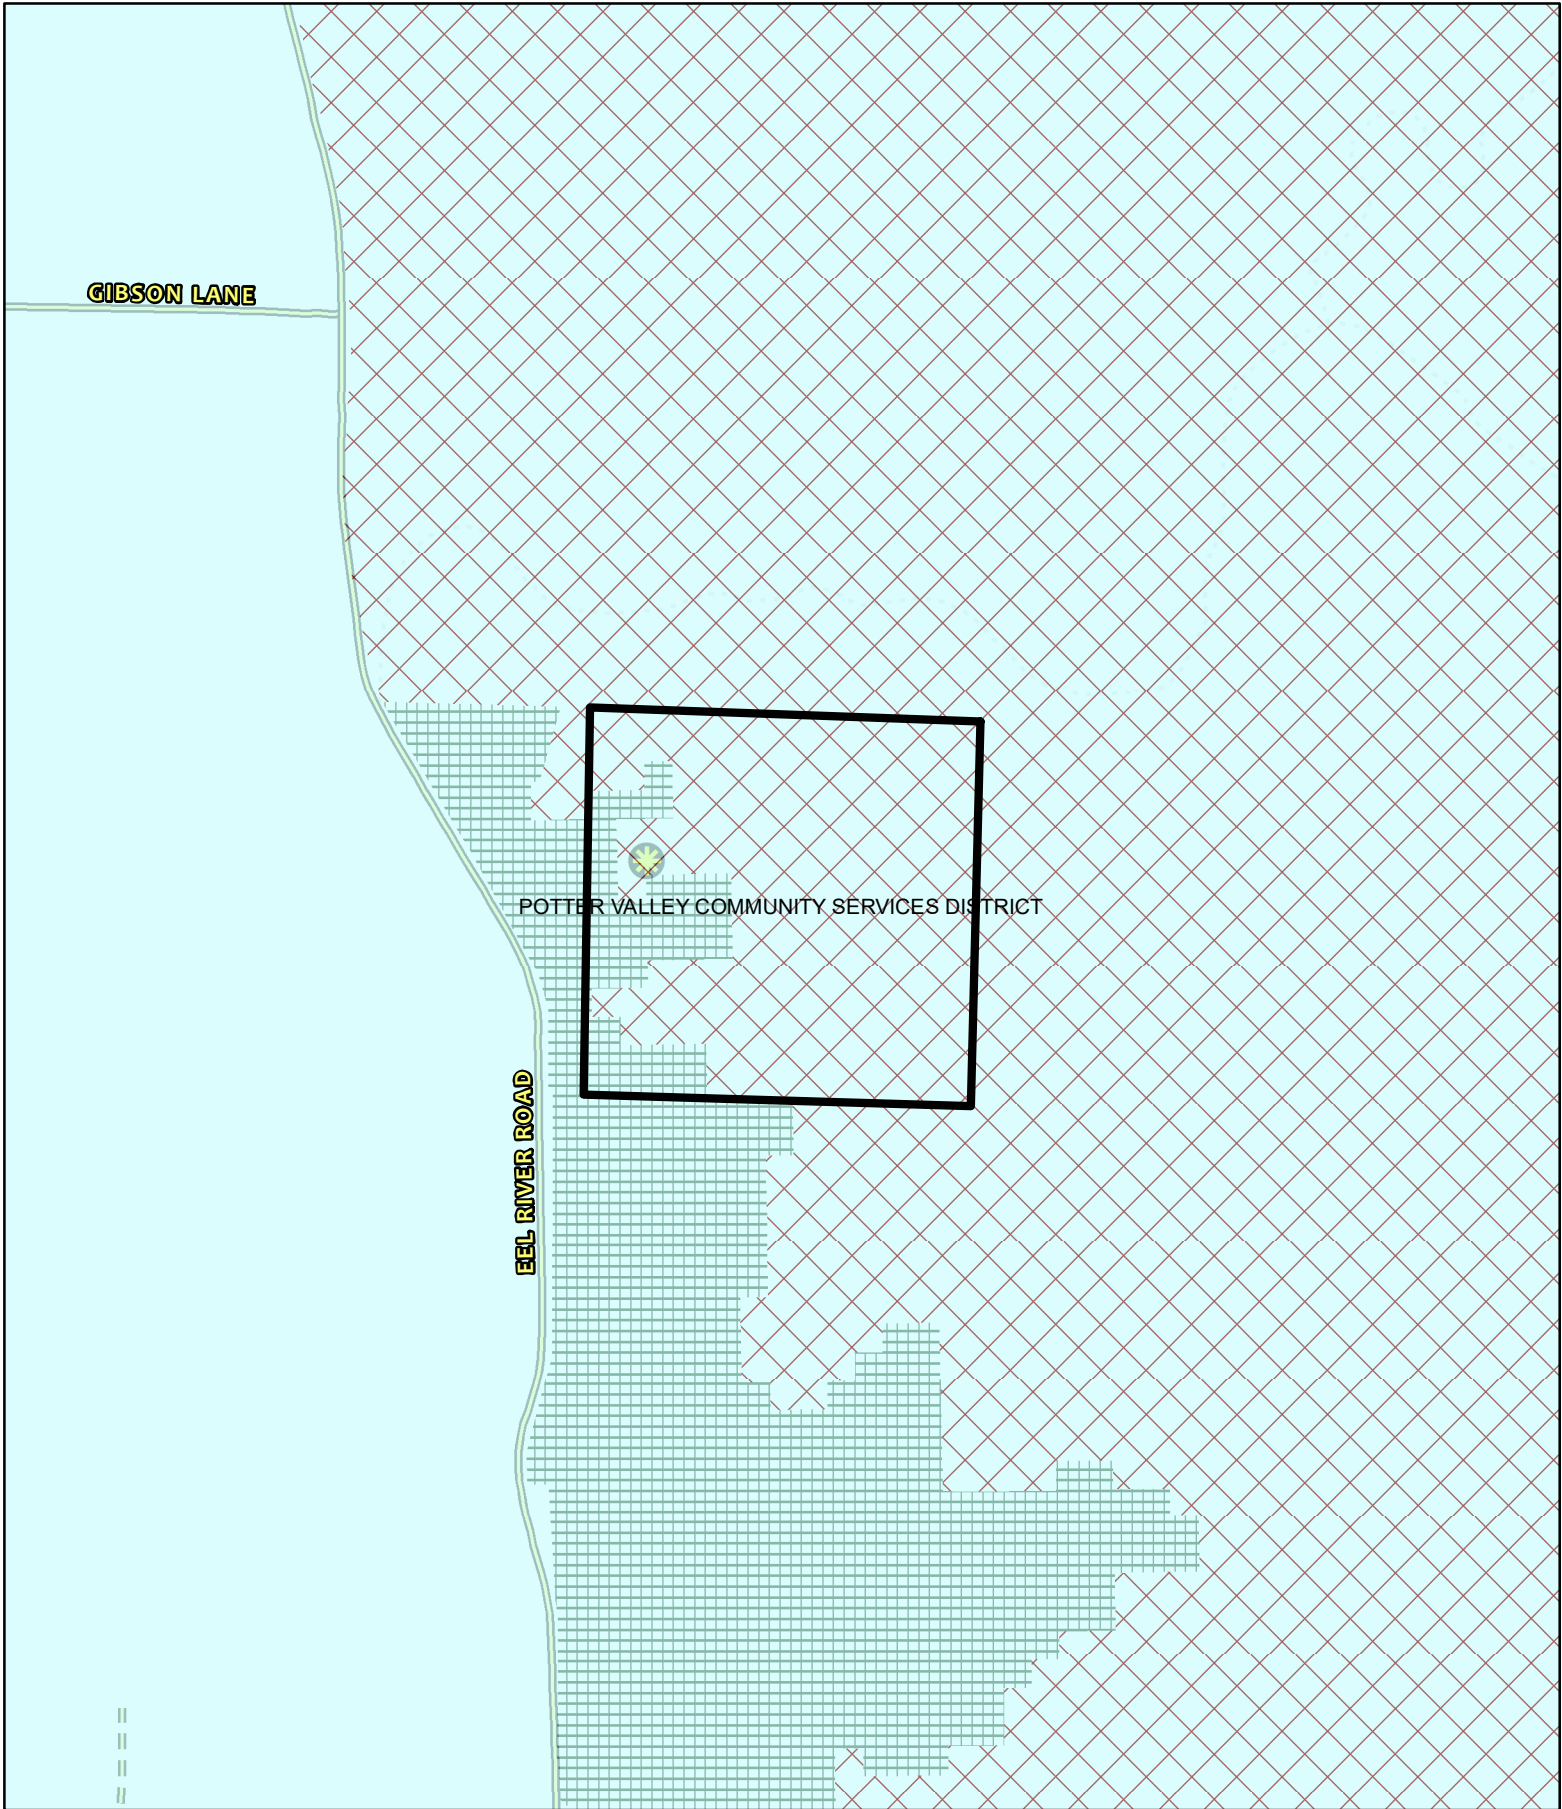
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





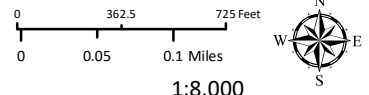


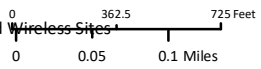

ADJACENT PARCELS

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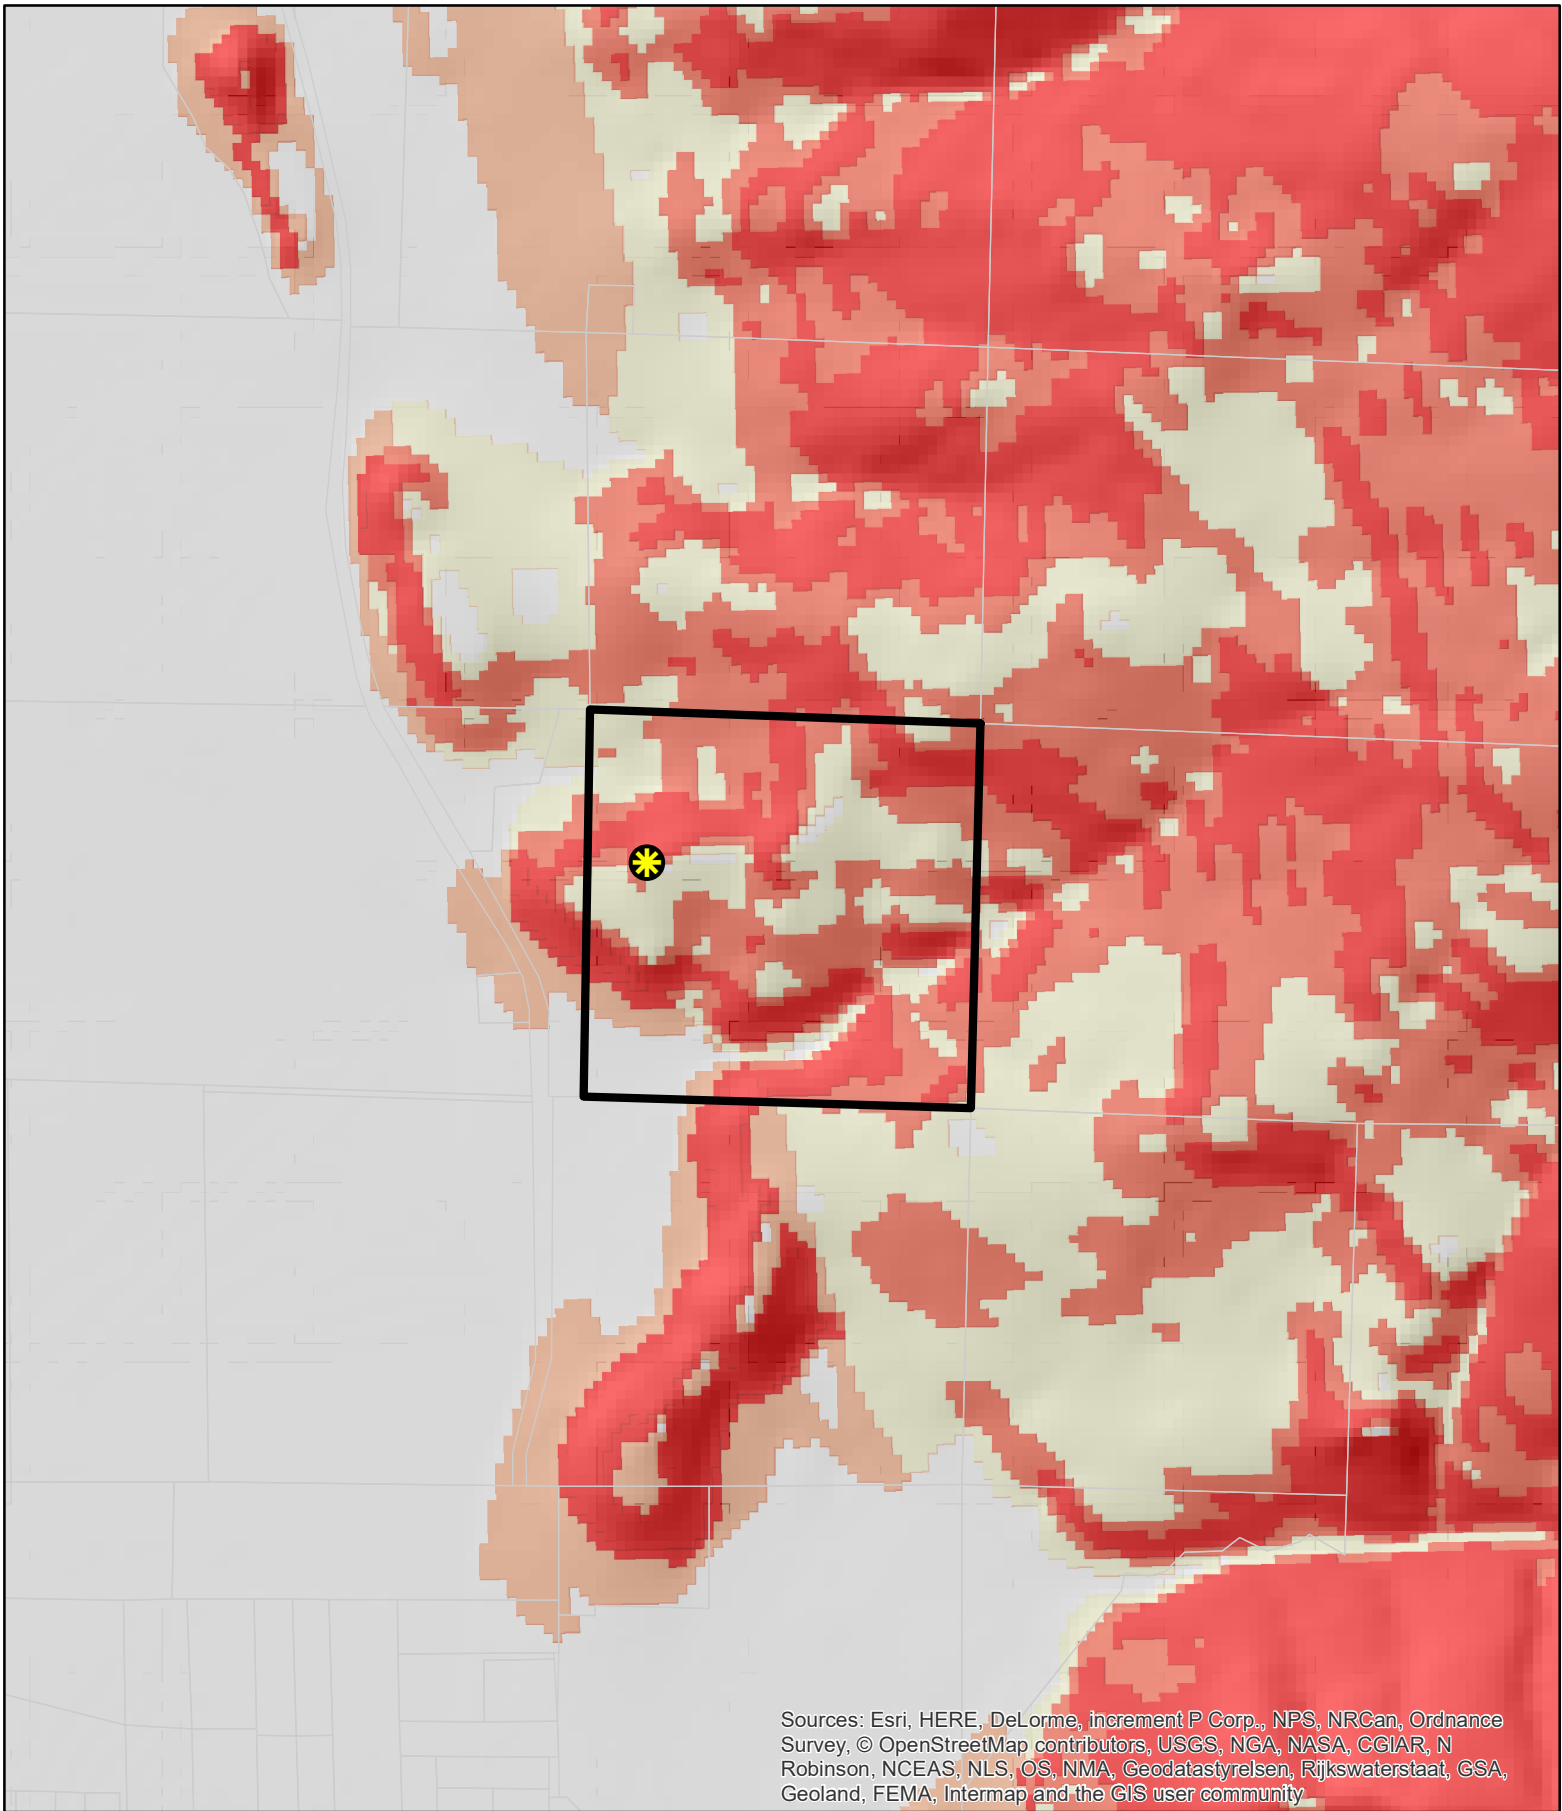
CASE: AP 2024-0013
OWNER: Global Signal Acquisitions
APN: 175-010-10
APLCT: Victoria Chhun
AGENT: Victoria Chhun
ADDRESS: 12531 Eel River Rd, Potter Valley

-  High Fire Hazard
-  Moderate Fire Hazard
-  County Fire Districts
-  Public Roads
-  Private Roads
-  Driveways/Unnamed Roads


FIRE HAZARD ZONES & RESPONSIBILITY AREAS
 STATE RESPONSIBILITY AREA

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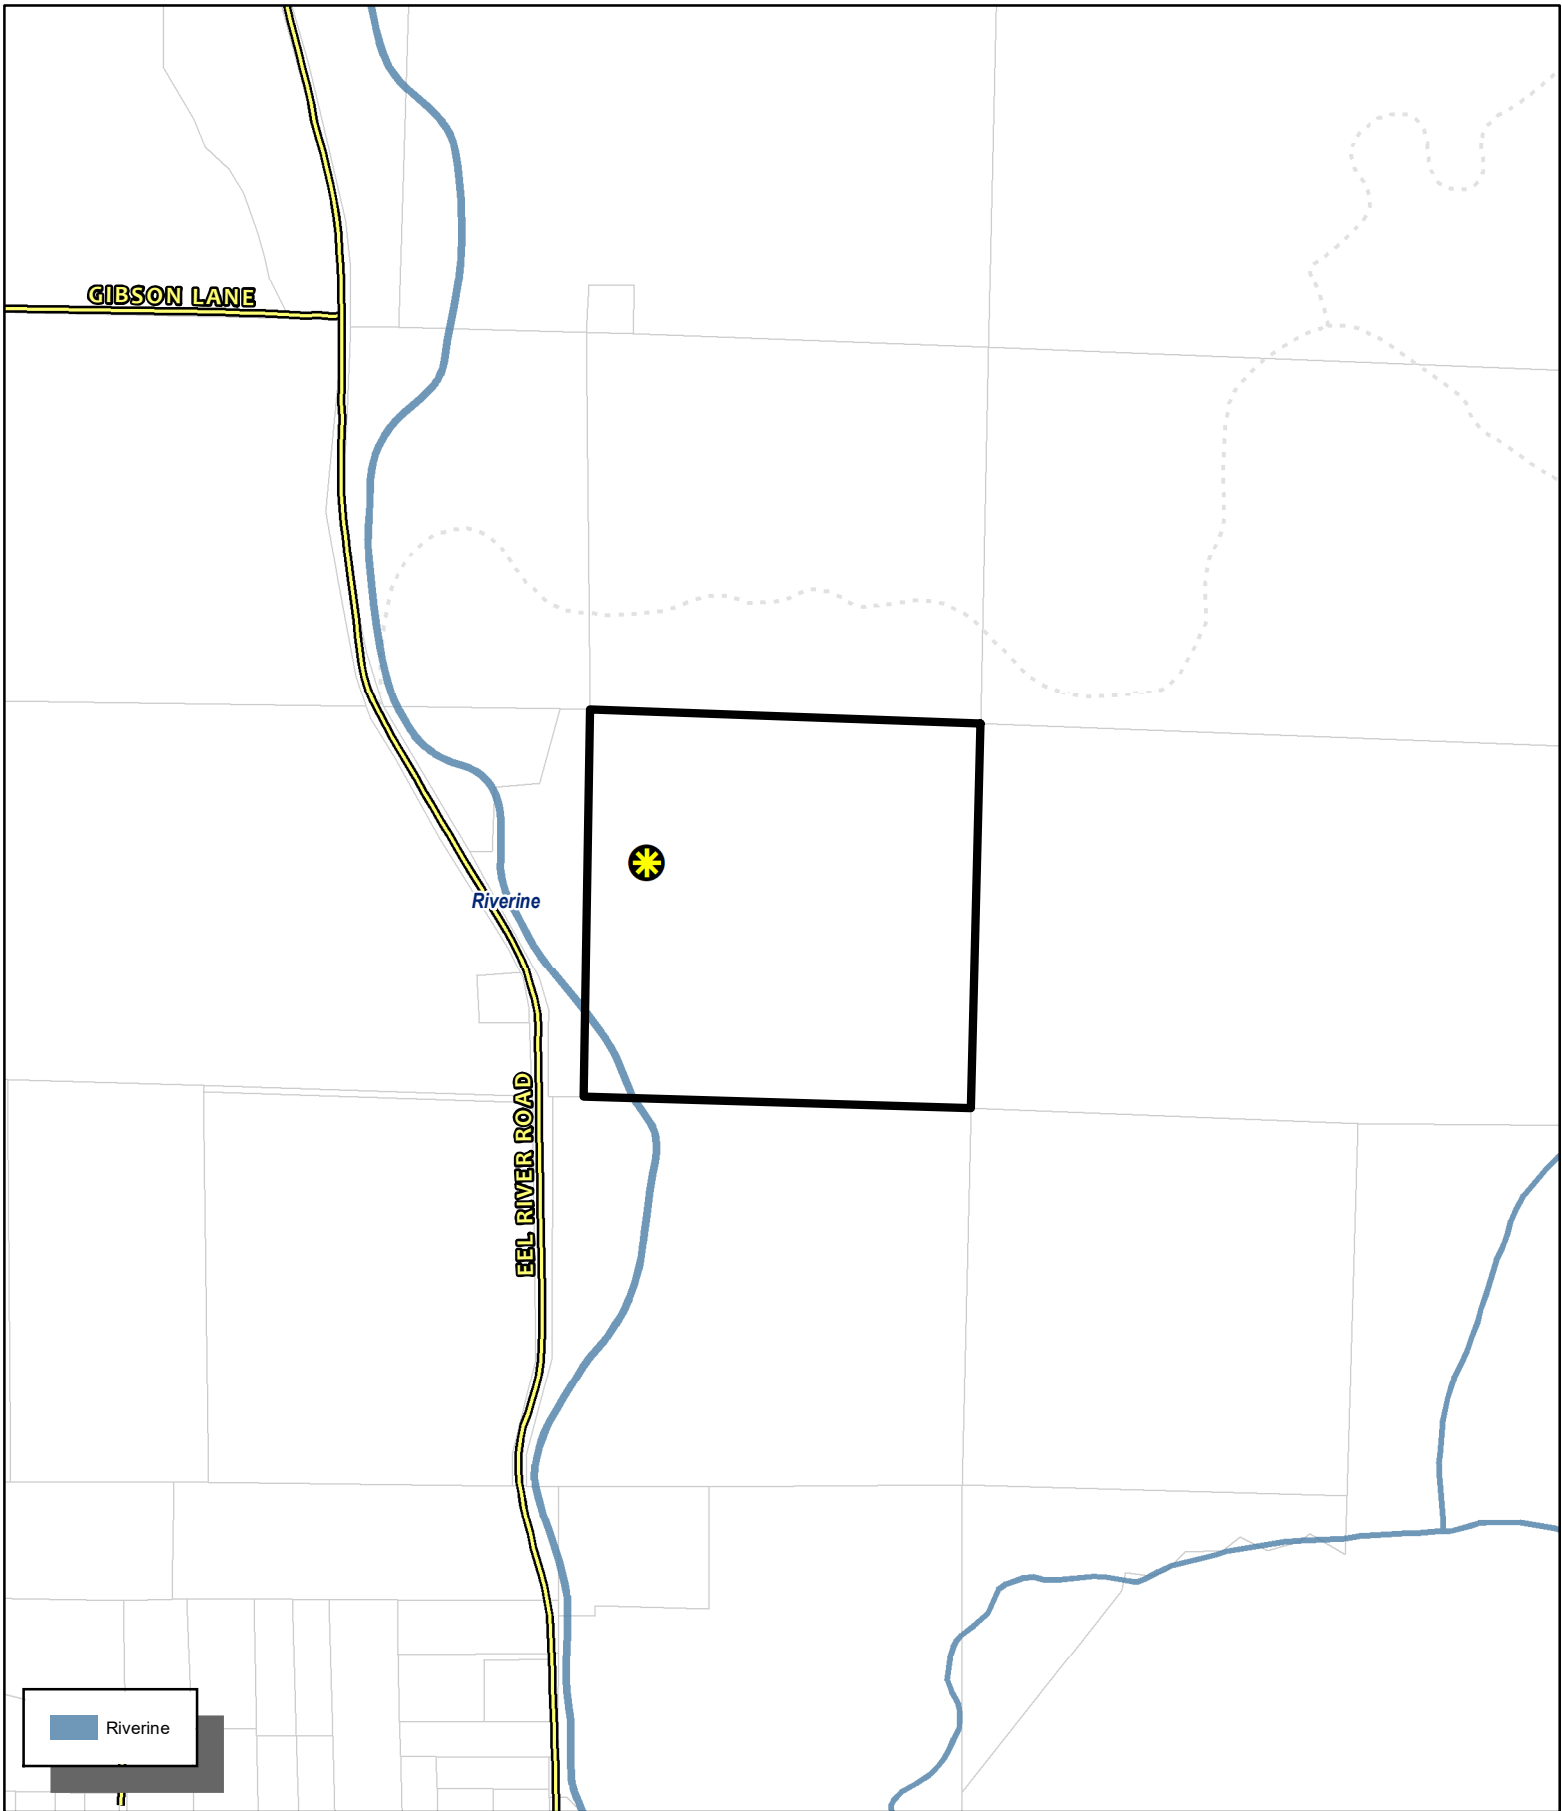
Sources: Esri, HERE, DeLorme, increment P Corp., NPS, NRCan, Ordnance Survey, © OpenStreetMap contributors, USGS, NGA, NASA, CGIAR, N Robinson, NCEAS, NLS, OS, NMA, Geodatastyrelsen, Rijkswaterstaat, GSA, Geoland, FEMA, Intermap and the GIS user community

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



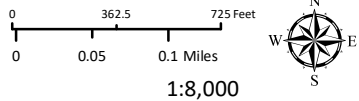


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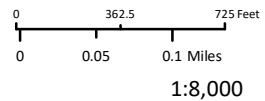
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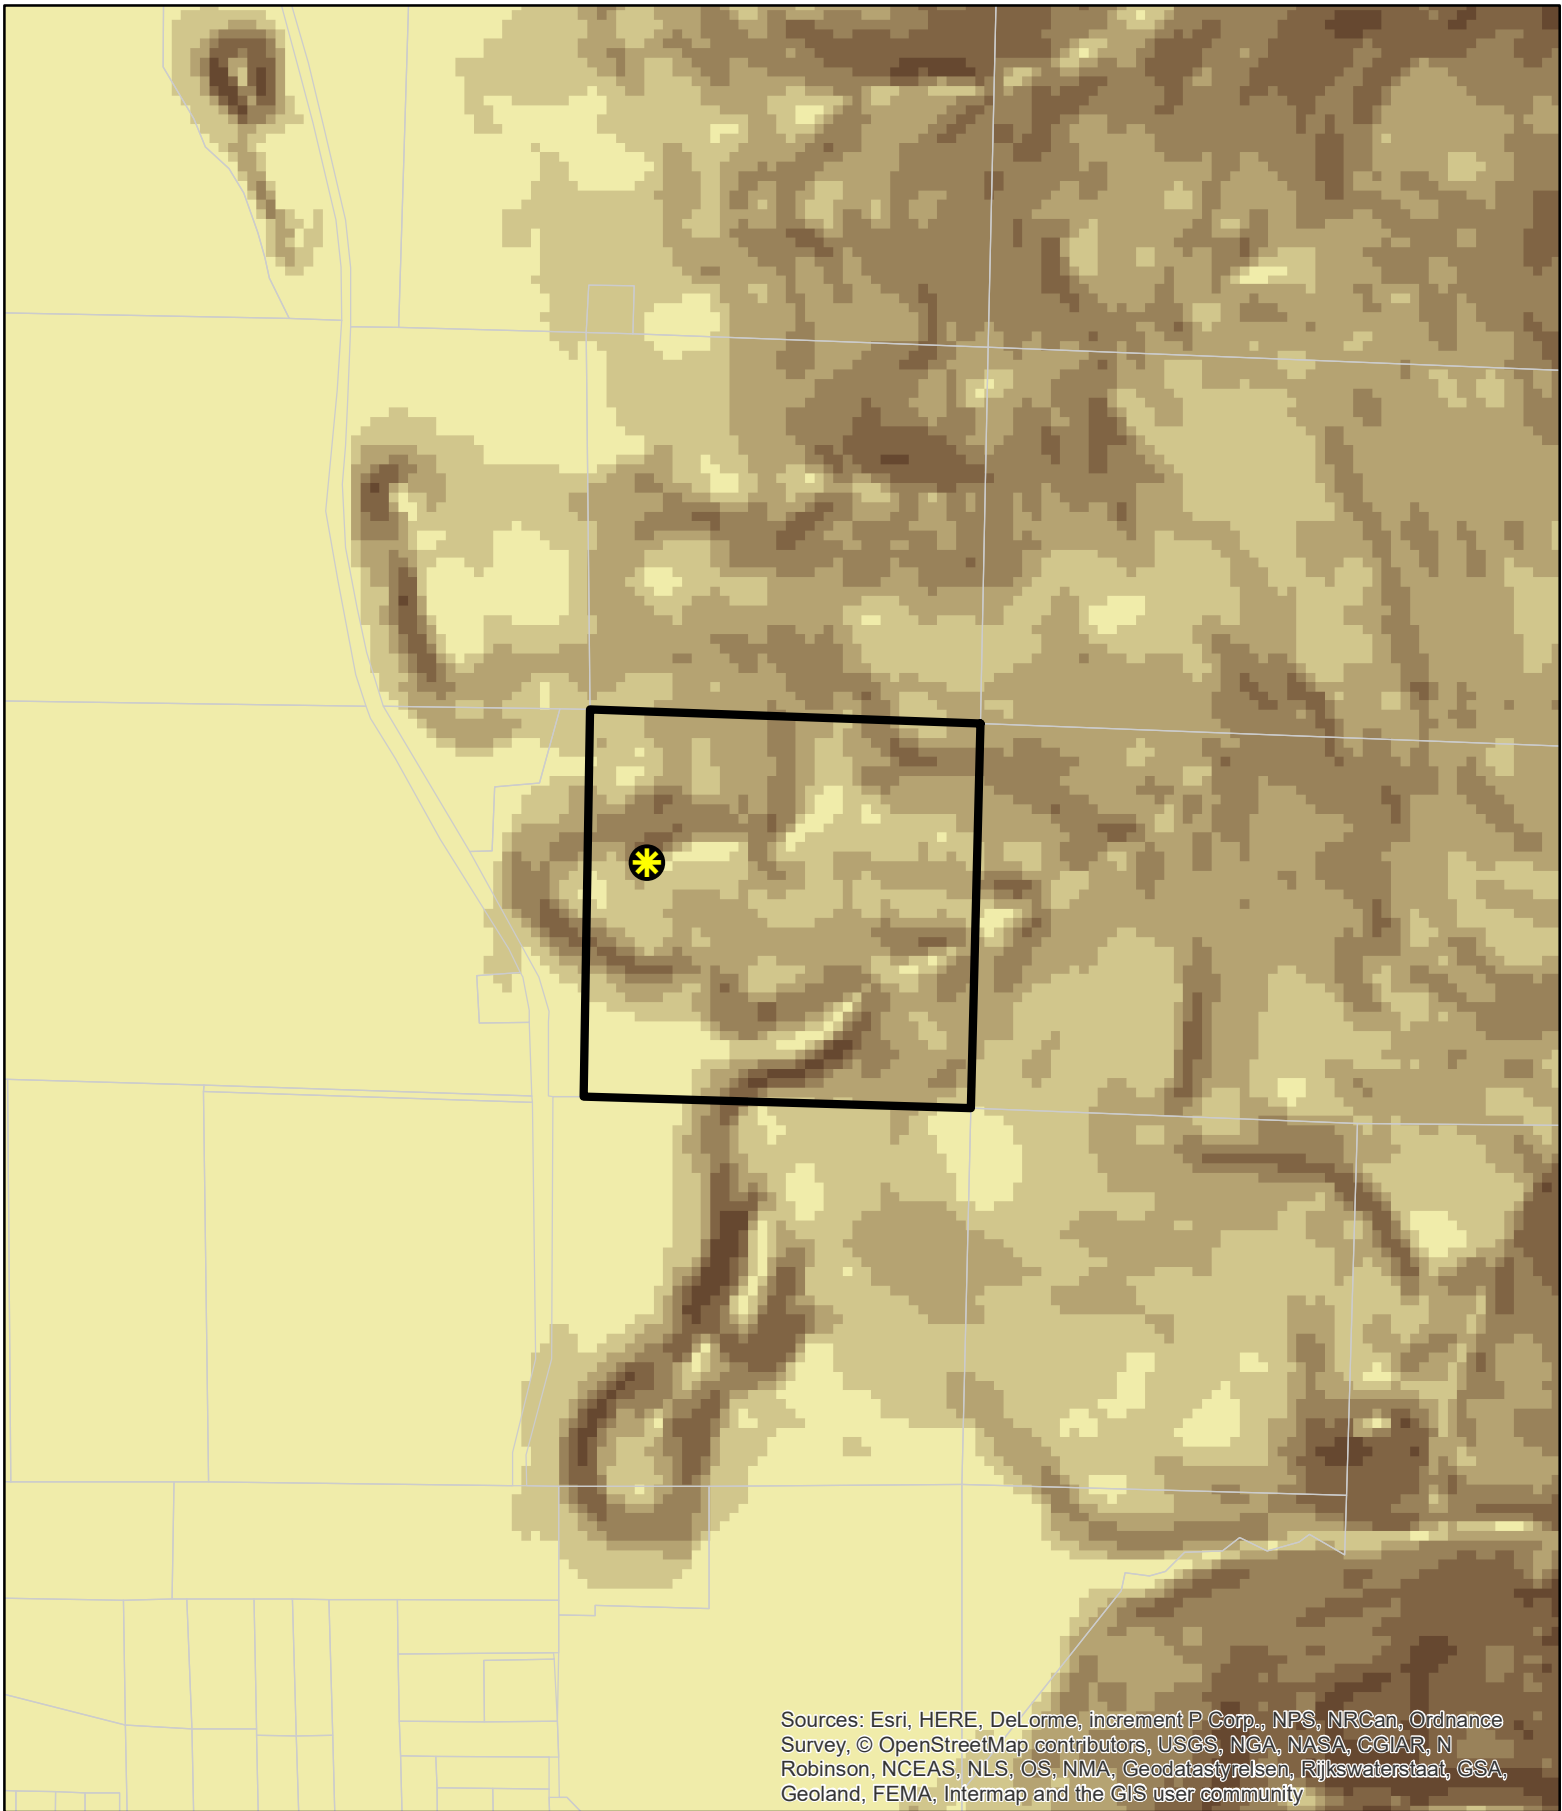
-  Public Roads
-  Private Roads
-  Driveways/Unnamed Roads

-  Assessors Parcels
-  Approved Wireless Sites





WETLANDS

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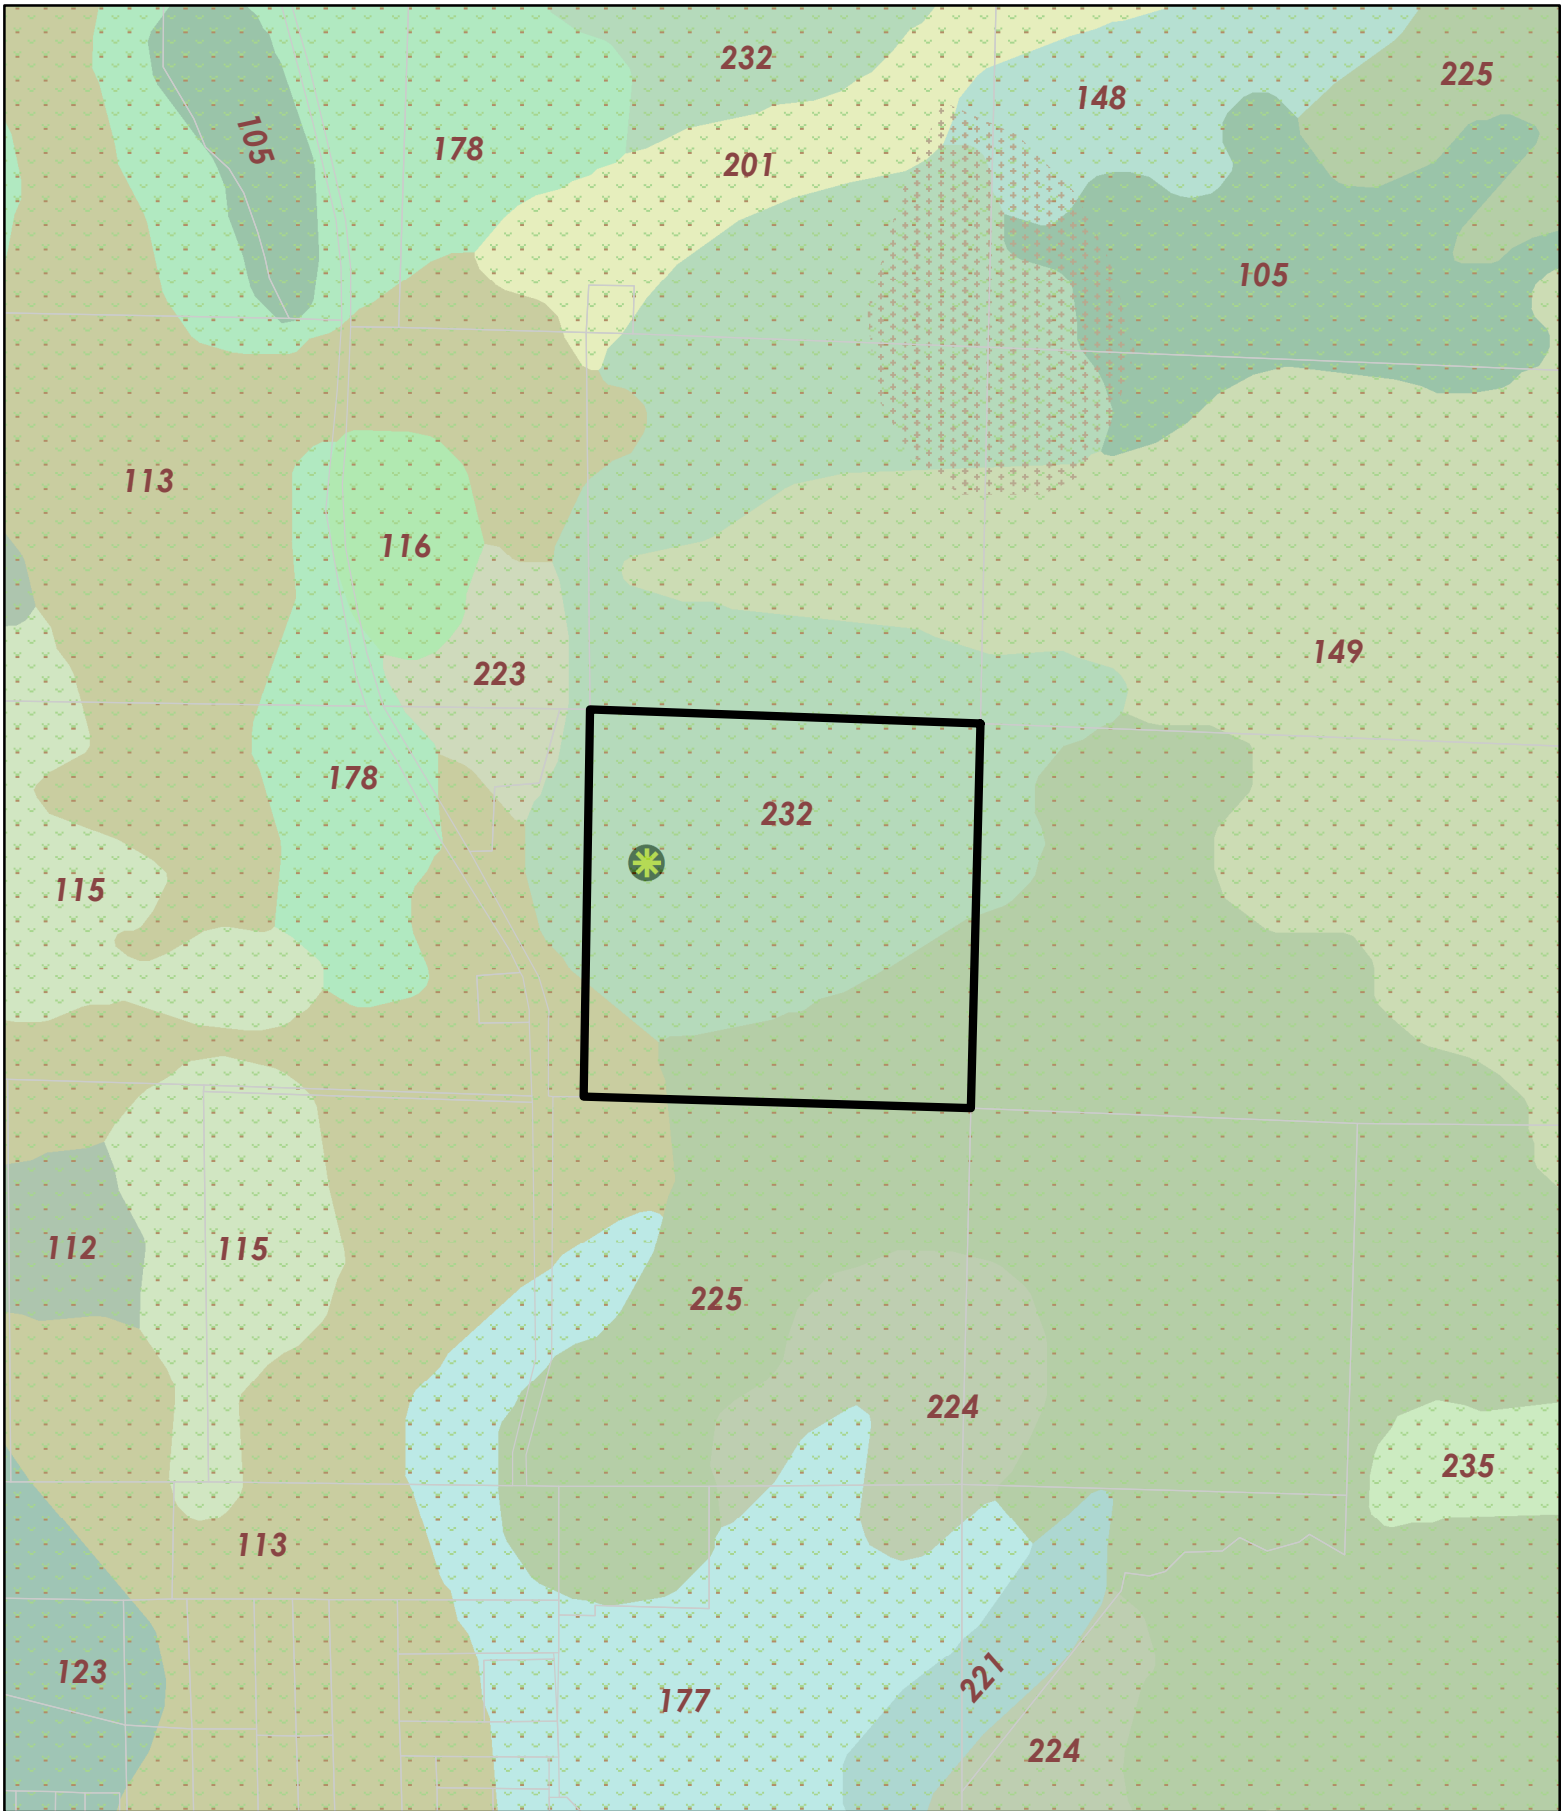
Sources: Esri, HERE, DeLorme, increment P Corp., NPS, NRCAn, Ordnance Survey, © OpenStreetMap contributors, USGS, NGA, NASA, CGIAR, N Robinson, NCEAS, NLS, OS, NMA, Geodatasysteisen, Rijkswaterstaat, GSA, Geoland, FEMA, Intermap and the GIS user community

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



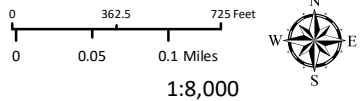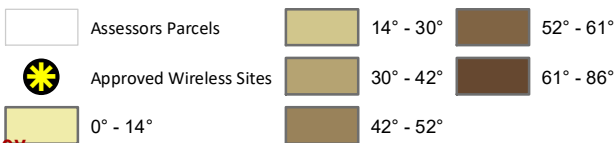


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ESTIMATED SLOPE

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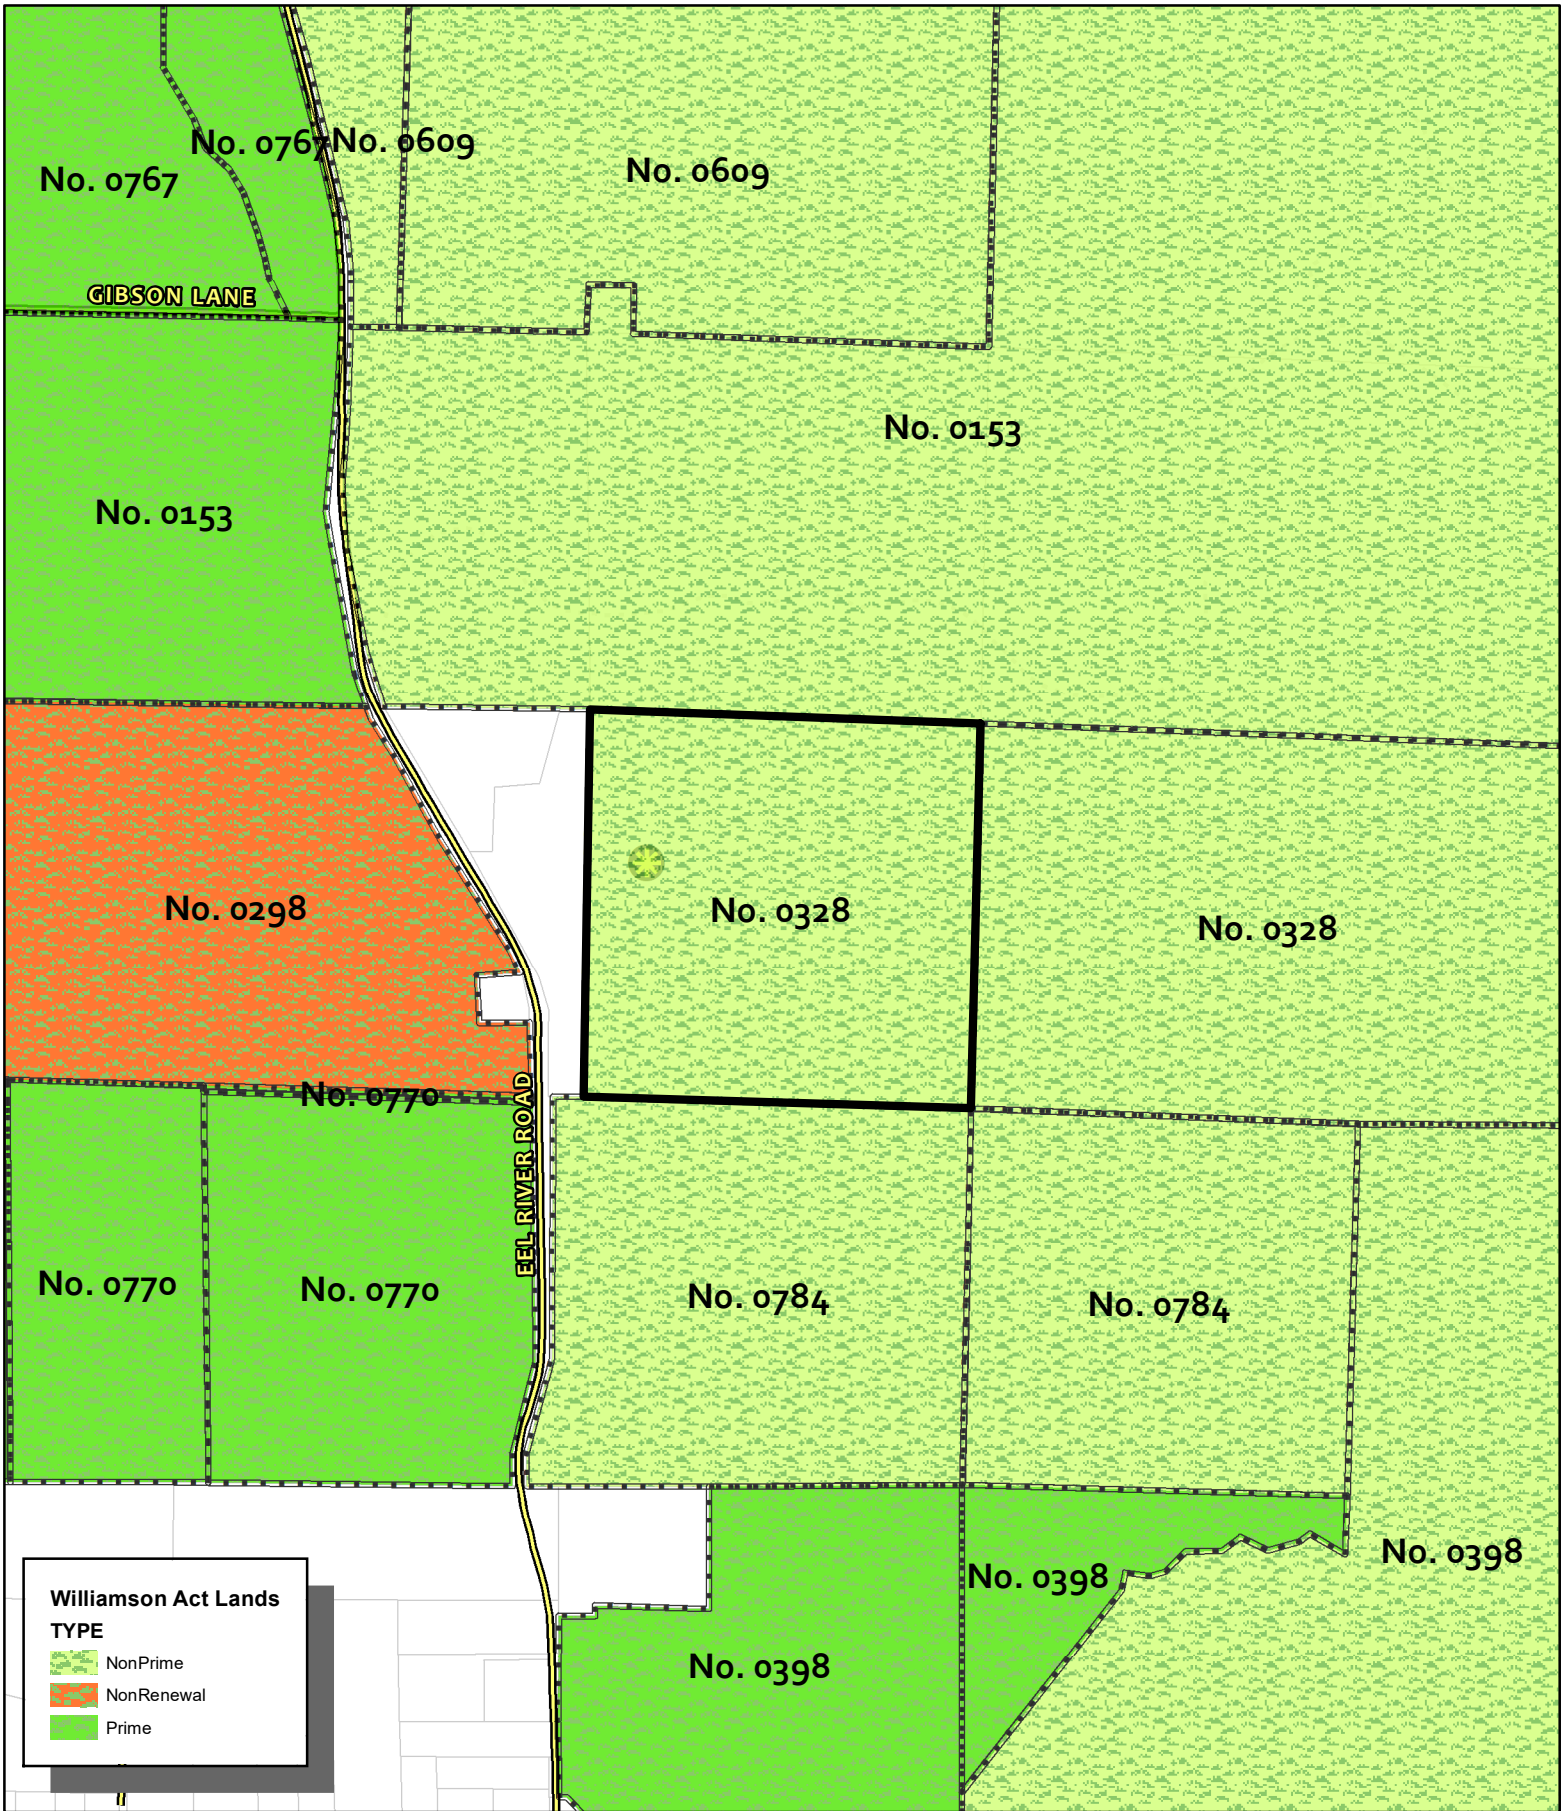
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-  Assessors Parcels
-  Approved Wireless Sites
-  Ultramafic Rock
-  Naturally Occurring Asbestos



EASTERN SOIL CLASSIFICATIONS

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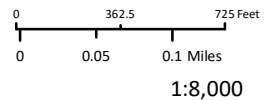
Williamson Act Lands
TYPE

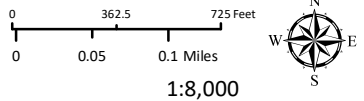- NonPrime
- NonRenewal
- Prime

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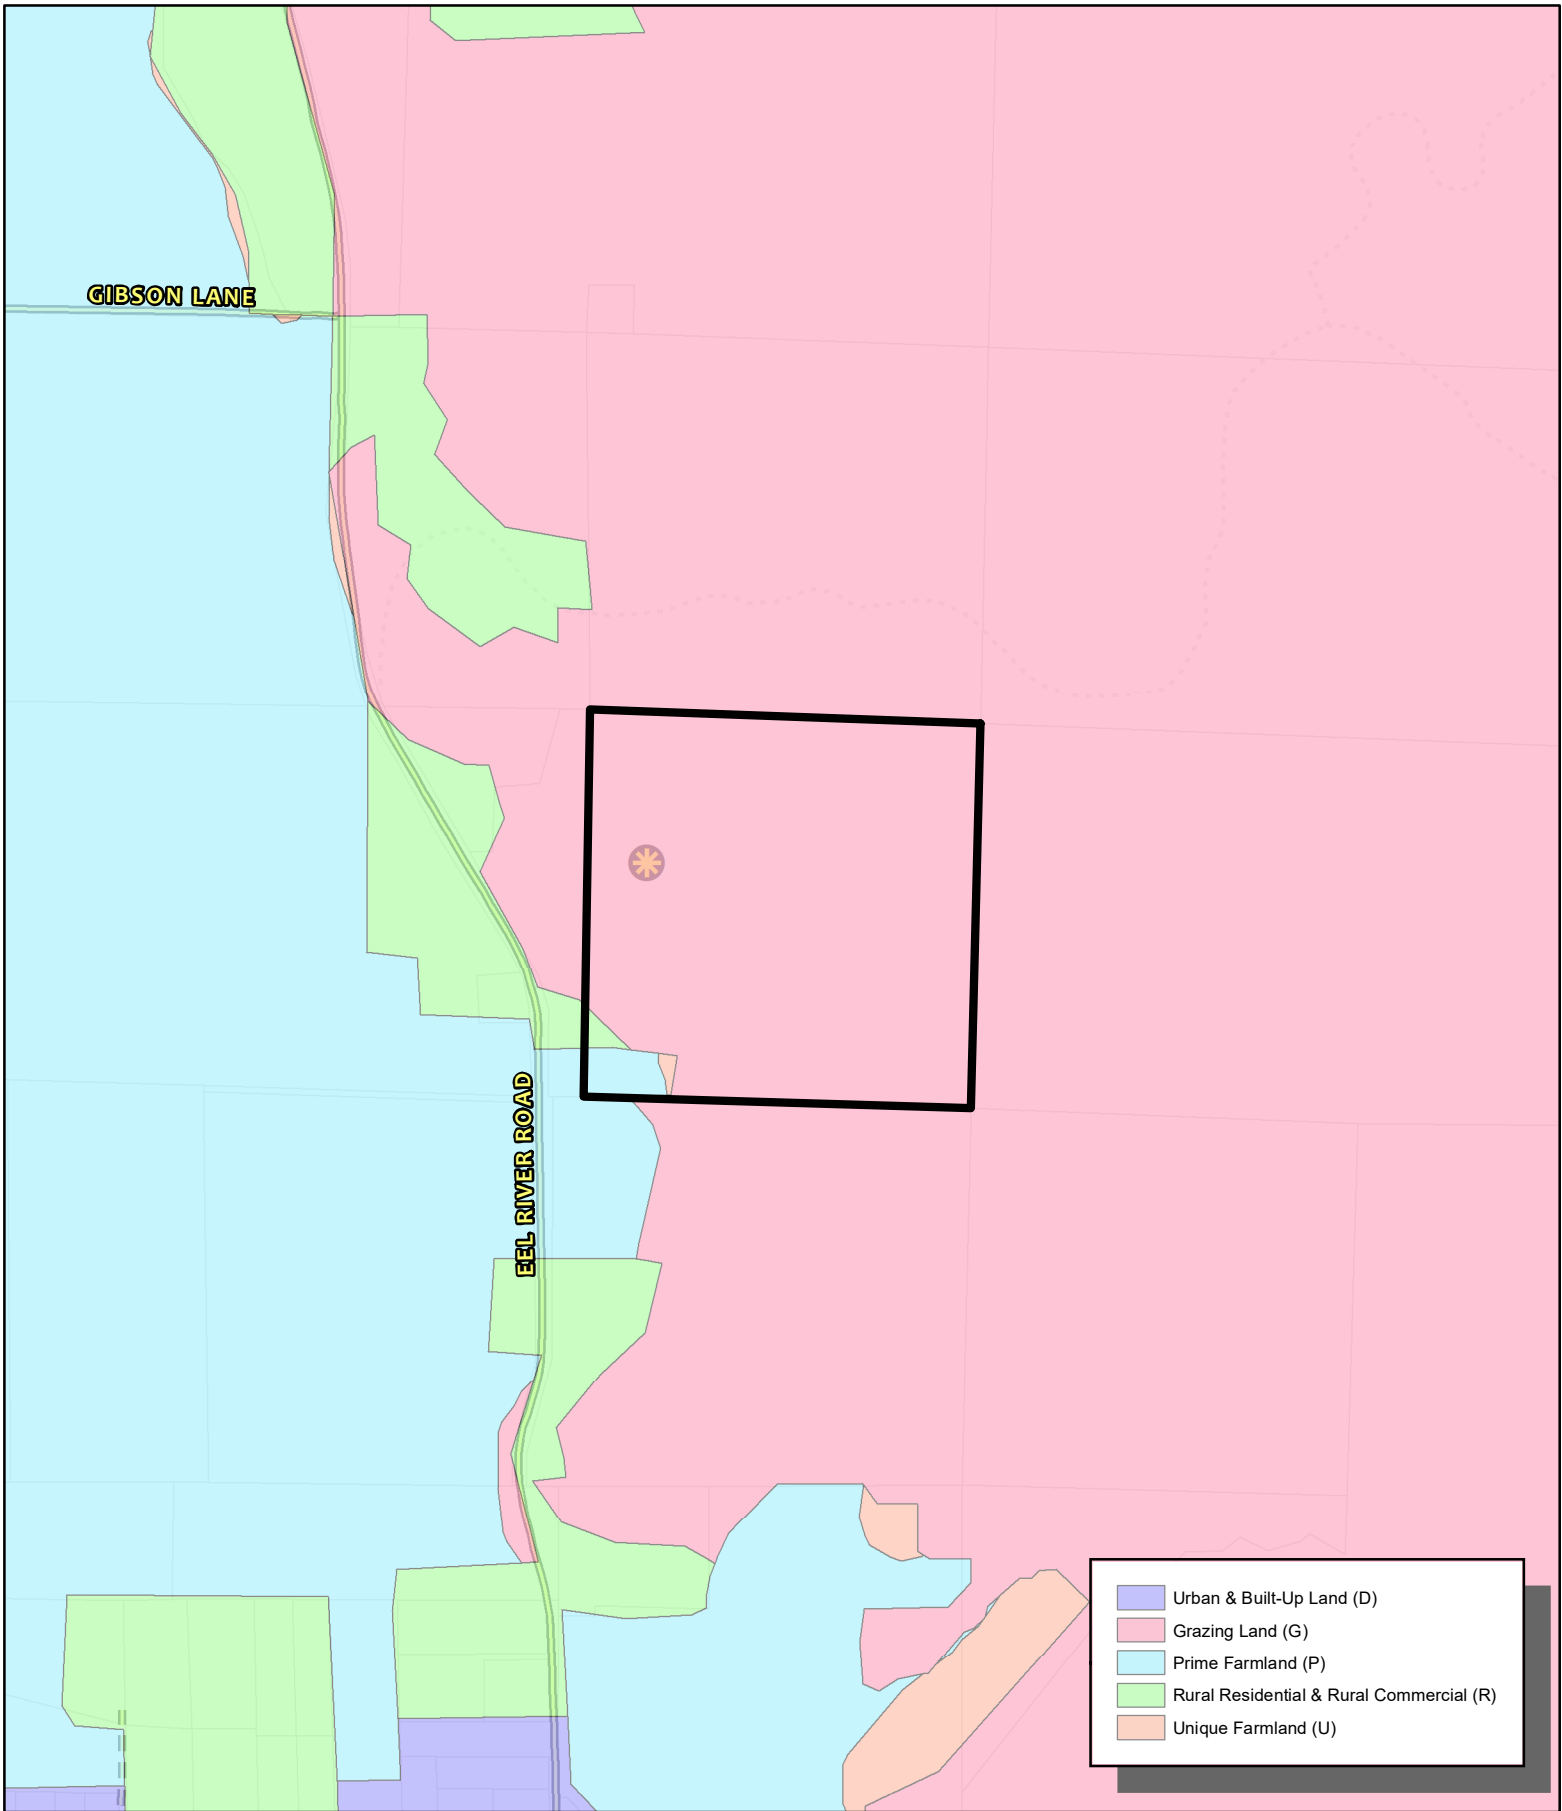
- Public Roads
- Private Roads
- Driveways/Unnamed Roads

- Assessors Parcels
- Approved Wireless Sites








WILLIAMSON ACT


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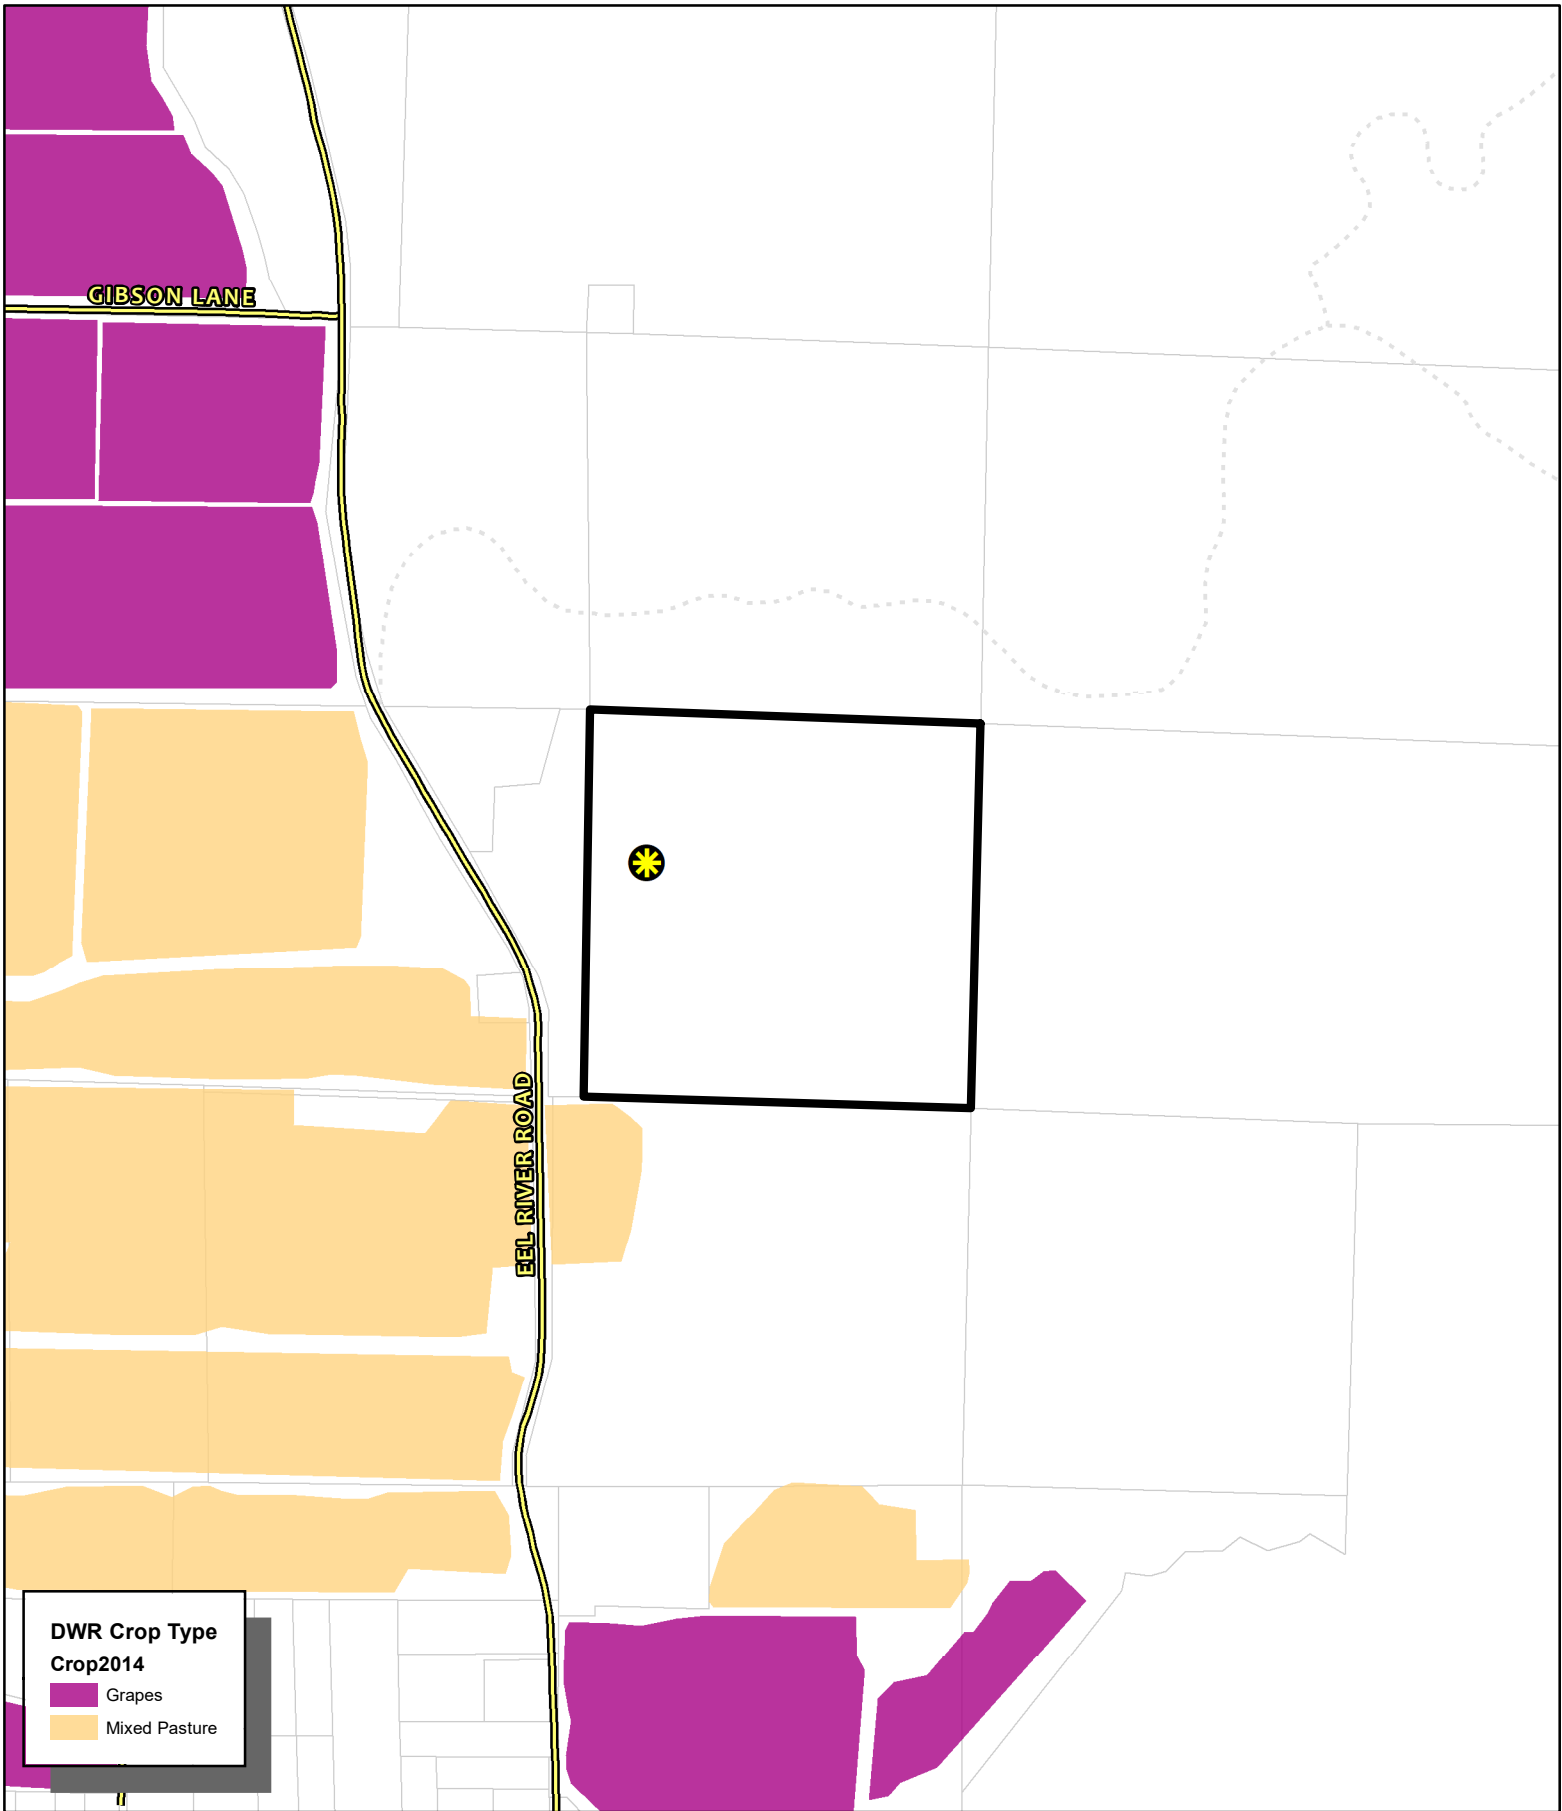
-  Public Roads
-  Private Roads
-  Driveways/Unnamed Roads

-  Assessors Parcels
-  Approved Wireless Sites



FARMLAND CLASSIFICATIONS


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DWR Crop Type
Crop2014
 Grapes
 Mixed Pasture
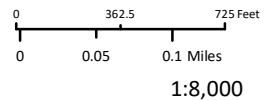
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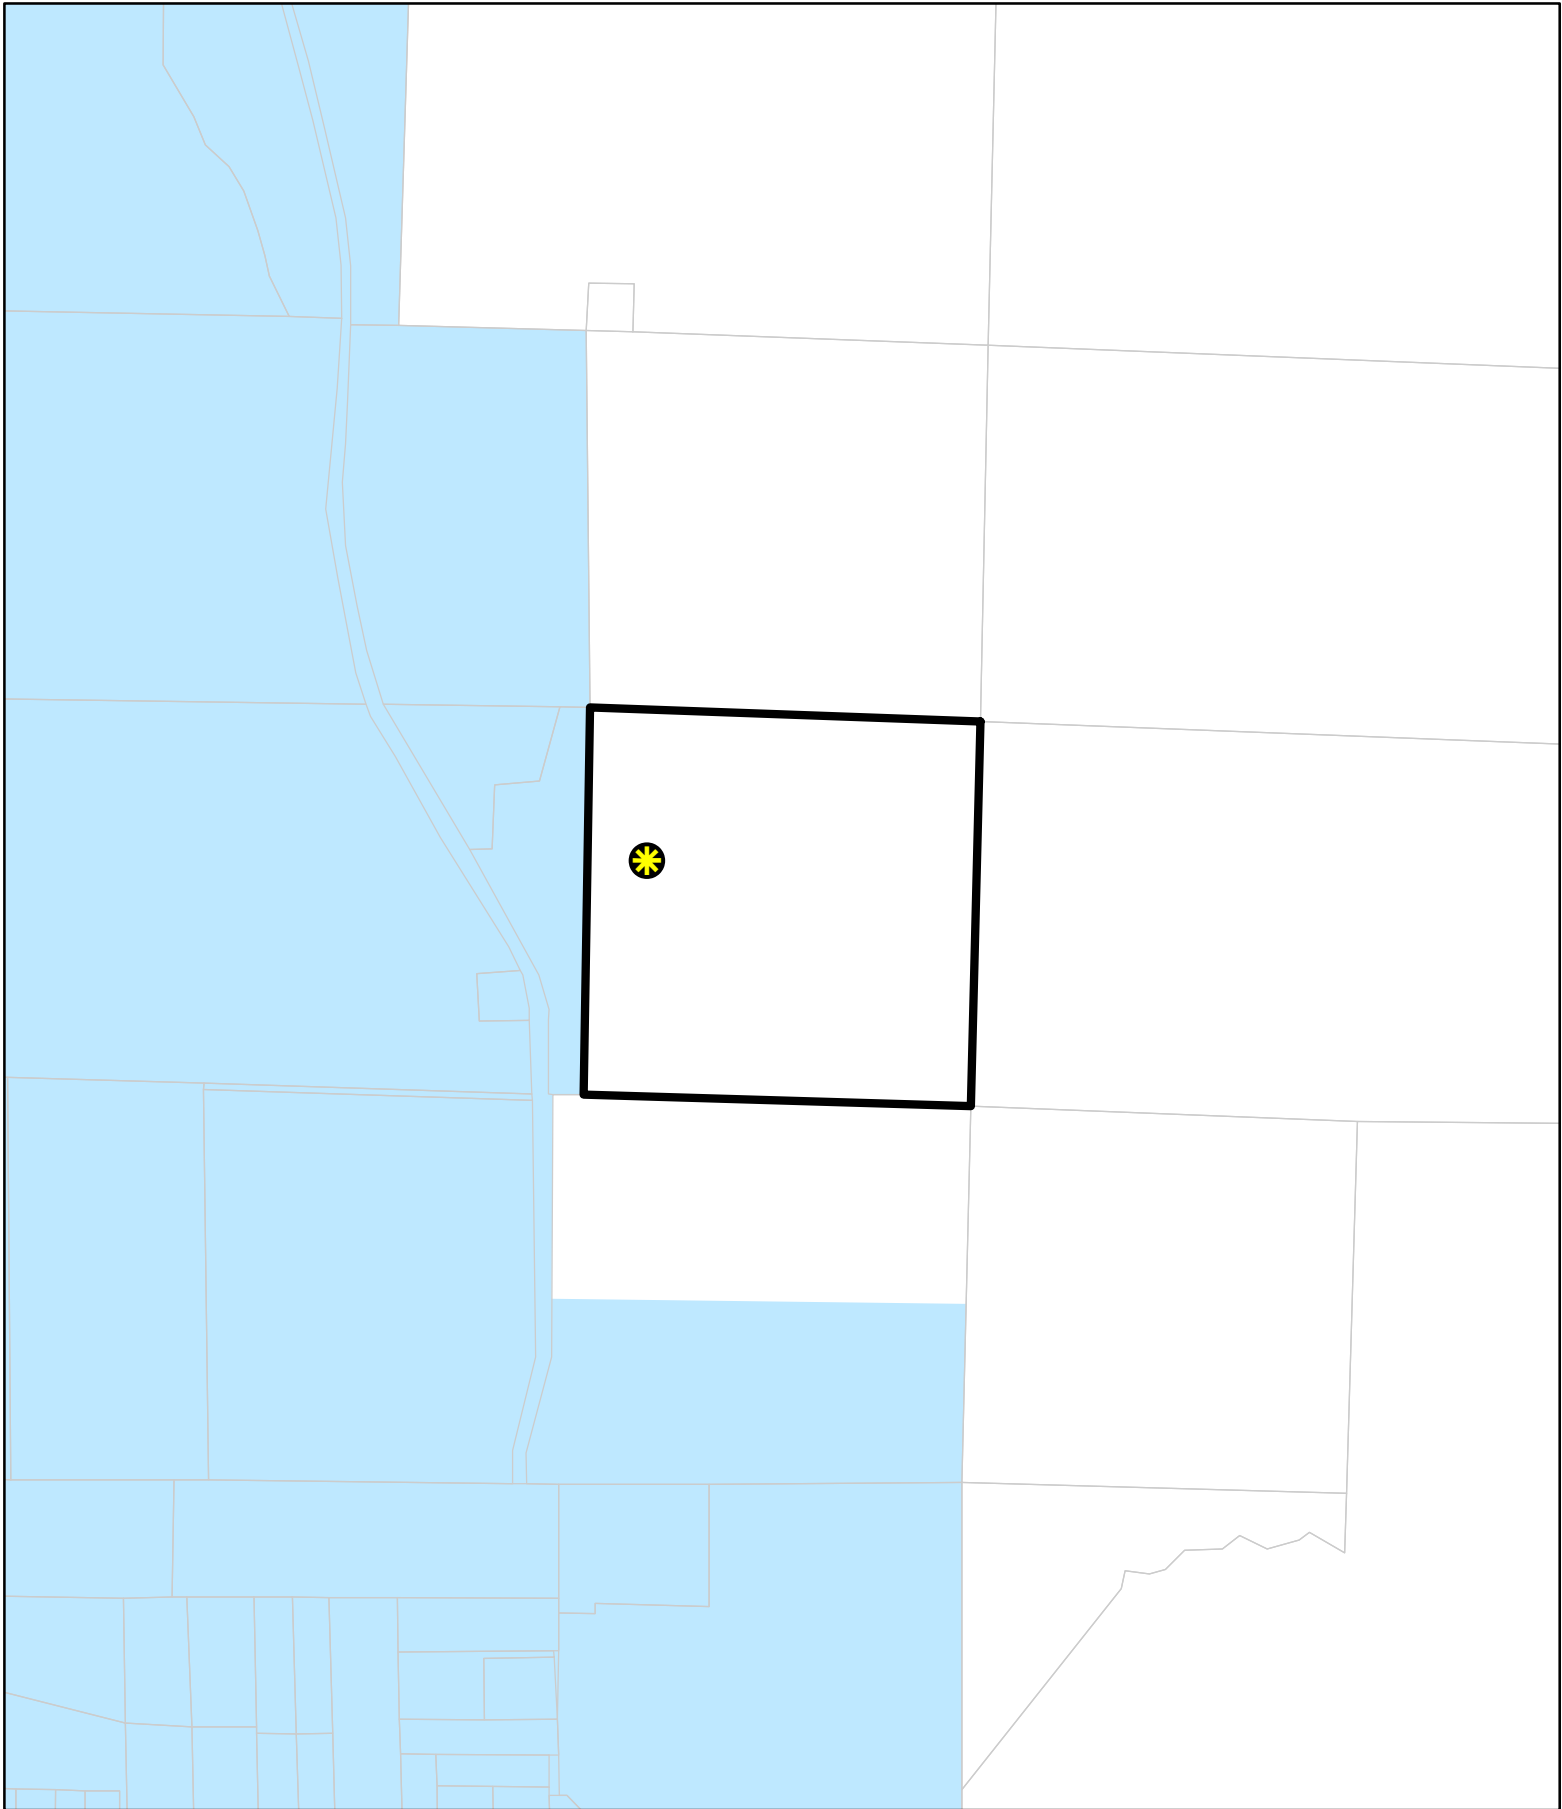
- Public Roads
- Private Roads
- Driveways/Unnamed Roads
- Assessors Parcels
- Approved Wireless Sites




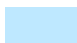

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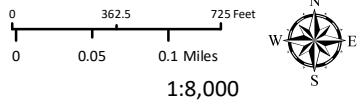
CROP TYPES

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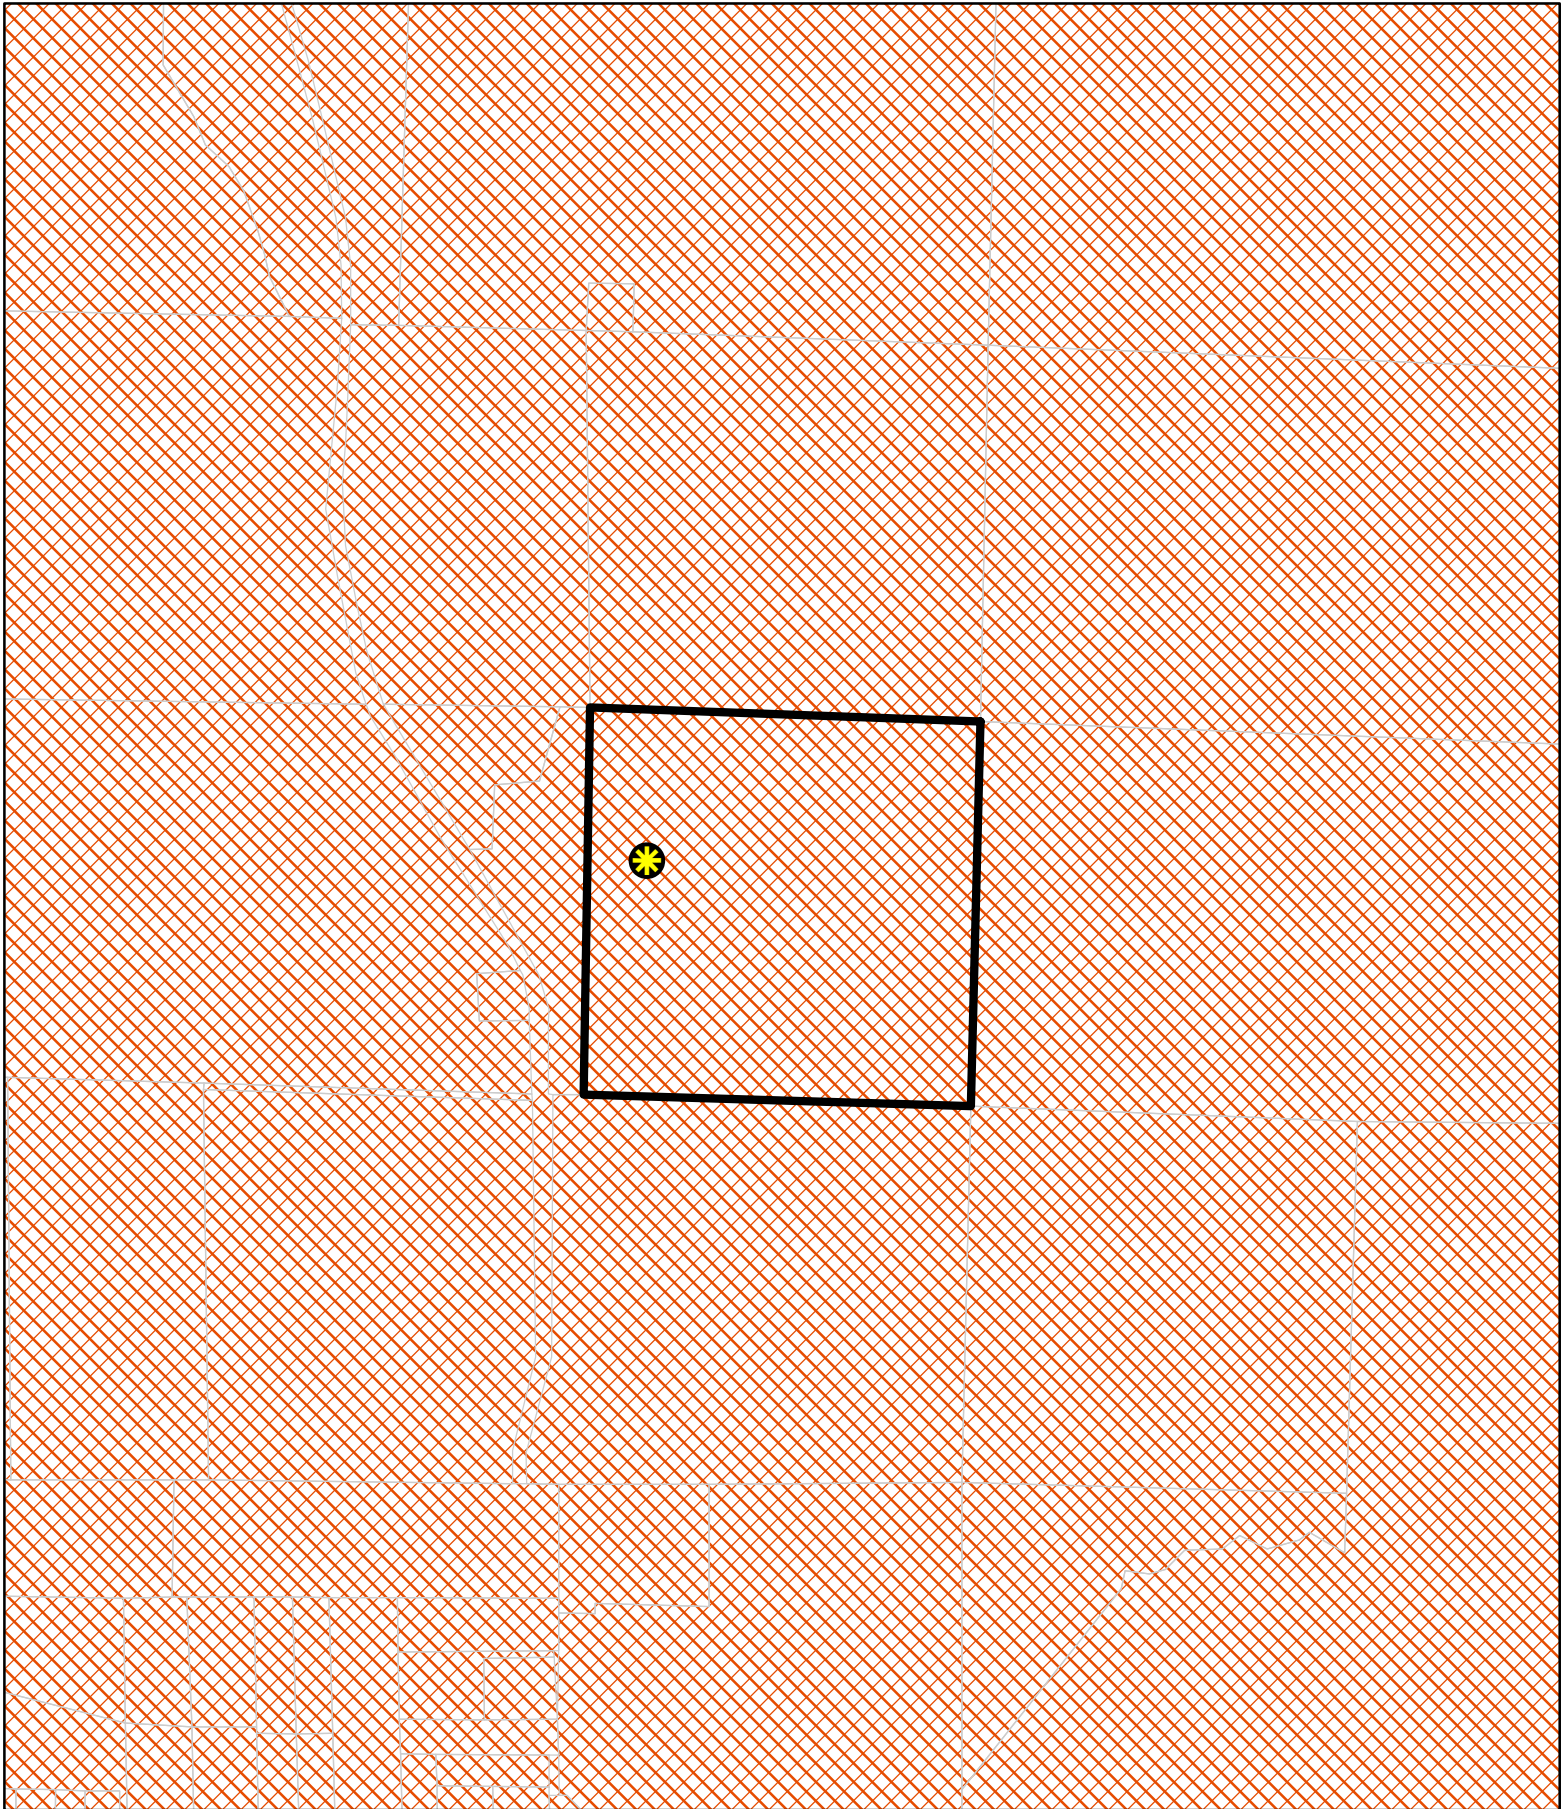
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-  Assessors Parcels
-  County Water Districts
-  Approved Wireless Sites

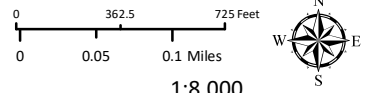




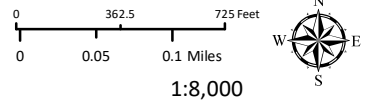
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WATER DISTRICT

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-  Assessors Parcels
-  Approved Wireless Sites
-  PV Tribe Ancestral Areas



POTTER VALLEY TRIBE ANCESTRAL AREA

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