### COUNTY OF MENDOCINO DEPARTMENT OF PLANNING AND BUILDING SERVICES

860 NORTH BUSH STREET · UKIAH · CALIFORNIA · 95482 120 WEST FIR STREET · FT. BRAGG · CALIFORNIA · 95437 JULIA KROG, DIRECTOR TELEPHONE: 707-234-6650 FAX: 707-463-5709 FB PHONE: 707-964-5379 FB FAX: 707-961-2427 pbs@mendocinocounty.org/pbs www.mendocinocounty.org/pbs

December 05, 2023

Department of Transportation Building Inspection - Ukiah Assessor Air Quality Management Airport Land Use Commission
Department of Forestry/ CalFire
-Land Use
Department of Fish and Wildlife

Cloverdale Rancheria Redwood Valley Rancheria Sherwood Valley Band of Pomo Indians Ukiah Valley Fire District

**CASE#:** AP\_2023-0008 **DATE FILED:** 3/2/2023

**OWNER: RUDDICK RANCH INCORPORATED** 

**APPLICANT: CALIFORNIA RURAL SERVICE AREA #1** 

**AGENT: FAULK AND FOSTER/GARA FLUITT** 

**REQUEST:** Administrative Permit to modify an existing telecommunication site. The modifications include the addition of six (6) Remote Radio Heads, six (6) integrated antennas, and other small ancillary equipment.

**ENVIRONMENTAL DETERMINATION:** Categorically Exempt

**LOCATION:** 1.1± miles southwest of Talmage, on the west side of Ruddick Cunningham Road (CR 205), 0.9± miles south of its intersection with State Highway 222 (SR 222), located at 1800 Ruddick Cunningham Rd.,

Talmage (APN:183-030-02).

SUPERVISORIAL DISTRICT: 1

STAFF PLANNER: LIAM CROWLEY

RESPONSE DUE DATE: December 19, 2023

#### PROJECT INFORMATION CAN BE FOUND AT:

www.mendocinocounty.org

Select "Government" from the drop-down; then locate Planning and Building Services/Public Agency Referrals.

Mendocino County Planning & Building Services is soliciting your input, which will be used in staff analysis and forwarded to the appropriate public hearing. You are invited to comment on any aspect of the proposed project(s). Please convey any requirements or conditions your agency requires for project compliance to the project coordinator at the above address, or submit your comments by email to <a href="mailto:pbs@mendocinocounty.org">pbs@mendocinocounty.org</a>. Please note the case number and name of the project coordinator with all correspondence to this department.

We have reviewed the above application and recommend the following (please check one):
☐ No comment at this time.
Recommend conditional approval (attached).
☐ Applicant to submit additional information (attach items needed, or contact the applicant directly, copying Planning and Building Services in any correspondence you may have with the applicant)
Recommend denial (Attach reasons for recommending denial).
Recommend preparation of an Environmental Impact Report (attach reasons why an EIR should be required).
Other comments (attach as necessary).
REVIEWED BY:

Department

Date

**CASE:** AP 2023-0008

OWNER: RUDDICK RANCH INCORPORATED

APPLICANT: CALIFORNIA RURAL SERVICE AREA #1 (US CELLULAR)

**AGENT:** FAULK AND FOSTER

**REQUEST:** Administrative Permit to modify an existing telecommunication site. The modifications include the addition of six (6)

remote radio heads, six (6) integrated antennas, and other small ancillary equipment.

LOCATION: 1.1± miles southwest of Talmage, on the west side of Ruddick Cunningham Road (CR 205), 0.9± miles south of its

intersection with State Highway 222 (SR 222), located at 1800 Ruddick Cunningham Rd., Talmage (APN:183-030-02).

**APN/S:** 183-030-02

PARCEL SIZE: 50± Acres

**GENERAL PLAN:** Agricultural (AG)

**ZONING:** Agricultural (A-G)

**EXISTING USES:** Agricultural, telecommunication facility

**DISTRICT:** 1<sup>st</sup> (McGourty)

**RELATED CASES:** See below.

	ADJACENT GENERAL PLAN	<b>ADJACENT ZONING</b>	ADJACENT LOT SIZES	<b>ADJACENT USES</b>
NORTH:	Agricultural (AG:40)	Agricultural (A-G)	18± Acres	Agricultural
EAST:	Agricultural (AG:40)	Agricultural (A-G)	111± Acres	Agricultural
SOUTH:	Agricultural (AG:40)	Agricultural (A-G)	44± Acres	Agricultural
WEST:	Agricultural (AG:40)	Agricultural (A-G)	50± Acres	Agricultural

#### **REFERRAL AGENCIES**

#### LOCAL

 $\ oxtimes$  Air Quality Management District

☑ Airport Land Use Commission

☑ Building Division (Ukiah)☑ Department of Transportation (DOT)

☑ Ukiah Valley Fire Authority

<u>STATE</u>

☑ CALFIRE (Land Use)

#### TRIBAL

☑ Cloverdale Rancheria

☑ Redwood Valley Rancheria

#### ADDITIONAL INFORMATION – Related cases include the following:

- **U\_2008-0016:** Use permit to authorize construction and operation of a telecommunication facility consisting of a 60-foot-tall monopole, 6 panel antennas, a 35-kilowatt diesel generator, a 1,000-gallon LPG tank, and an 11-foot by 16-foot equipment shelter. Approved 05/20/2010.
- AP\_2017-0013: Administrative Permit for modifications to the existing facility, including the installation of six (6) antennas, one (1) hybrid cable, one (1) power cable, three (3) t-arm mounts, six (6) FRLB remote radio heads, two (2) surge protectors, twelve (12) combiners, and two (2) stackable FXCB remote radio heads. The modifications also included removal of three (3) antennas, six (6) coaxial cables, and three (3) t-arm mounts. Approved 07/18/2017.
- AP\_2019-0053: Administrative permit for modifications to the existing facility, including the installation of three (3) RRHs, three (3) fiber jumpers, three (3) power jumpers, and twelve (12) ½ inch jumpers. Approved 08/19/2019.
- AP\_2019-0092: Administrative Permit for modifications to the existing facility, including the installation of six (6) LTE antennas and associated equipment. The modifications also included removal of decommissioned panel equipment. Approved 12/30/2019.
- UR\_2023-0003: Renewal of Use Permit U\_2008-0016 for an additional ten (10) year period. Approved 06/15/2023.

A Structural Analysis Report was prepared for the project to determine the structural integrity of the tower. This report is available on file at Mendocino County Planning & Building Services. For more information, please contact staff planner Liam Crowley at <a href="mailto:crowleyl@mendocinocounty.gov">crowleyl@mendocinocounty.gov</a>.

STAFF PLANNER: Liam Crowley DATE: 12/1/2023

#### **ENVIRONMENTAL DATA**

1. MAC:

None

2. FIRE HAZARD SEVERITY ZONE:

CALFIRE FRAP maps/GIS

Non-Wildland/Non-Urban

3. FIRE RESPONSIBILITY AREA:

CALFIRE FRAP maps/GIS

Local Responsibility Area (LRA)

4. FARMLAND CLASSIFICATION:

GIS

Prime Farmland

5. FLOOD ZONE CLASSIFICATION:

FFMA Flood Insurance Rate Mans (FIRM)

Floodway

6. COASTAL GROUNDWATER RESOURCE AREA:

Coastal Groundwater Study/GIS

N/A

7. SOIL CLASSIFICATION:

Mendocino County Soils Study Eastern/Western Par

Eastern Soil Map Unit No. 113

8. PYGMY VEGETATION OR PYGMY CAPABLE SOIL:

LCP maps, Pygmy Soils Maps; GIS

N/A

9. WILLIAMSON ACT CONTRACT:

GIS/Mendocino County Assessor's Office

No

**10. TIMBER PRODUCTION ZONE:** 

GIS **No** 

11. WETLANDS CLASSIFICATION:

None

12. EARTHQUAKE FAULT ZONE:

No

13. AIRPORT LAND USE PLANNING AREA:

irport Land Use Plan; GIS

Ukiah Municipal Airport Zone 6

14. SUPERFUND/BROWNFIELD/HAZMAT SITE:

GIS; General Plan 3-1:

No

15. NATURAL DIVERSITY DATABASE:

A Dept. of Fish & Wildlife Rarefind Database/GIS

No

16. STATE FOREST/PARK/RECREATION AREA ADJACENT:

GIS; General Plan 3-10

No

**17. LANDSLIDE HAZARD:** 

Hazards and Landslides Map; GIS; Policy RM-61; General Plan 4-44

No

18. WATER EFFICIENT LANDSCAPE REQUIRED:

Policy RM-7; General Plan 4

No

19. WILD AND SCENIC RIVER:

www.rivers.gov.(Fel Only): GIS

No

20. SPECIFIC PLAN/SPECIAL PLAN AREA:

Various Adopted Specific Plan Areas: G

Ukiah Valley Area Plan (UVAP)

21. STATE CLEARINGHOUSE REQUIRED:

No.

22. OAK WOODLAND AREA:

No.

23. HARBOR DISTRICT:


Sec. 20.51

No



Farm Ven. 071421

# PLANNING & BUILDING SERVICES

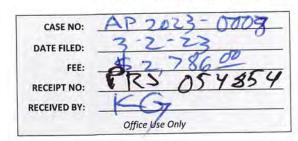

#### **APPLICATION FORM**

APPLICANT:  California Rural Se  Name: Faulk and Foster	rvice Area #1, Inc		one: 318-	807-2631
Mailing Address: 8410 Wes	t Bryn Mawr Avei	nue, Suite 700		
City: Chicago	State/Zip:_IL 6		ail: gara.fl	nitt@faulkandfoster.com
PROPERTY OWNER:				
Name: RUDDICK RANC	H INCORPORAT	ED Ph	one: not ap	plicable - all permission given in lease
Mailing Address: PO Box 5	39			
	State/Zip:CA	95481En	nail: not ap	plicable - all permission given in lease
AGENT:				
Name: Faulk and Foster	by Gara Fluitt	Ph	none: 318-80	07-2631
Mailing Address: 1811 Au	burn Avenue			
	State/Zip:_LA	/71201Er	nail: gara.f	luitt@faulkandfoster.com
ASSESSOR'S PARCEL NU  TYPE OF APPLICATION:  Administrative Permit  Agricultural Preserve: Ne  Agricultural Preserve: Ca  Agricultural Preserve: Re  Airport Land Use  Development Review  Exception  Flood Hazard Developm	ew Contract incellation escind & ReEnter ent Permit	☐ General Plan Amend ☐ Land Division — Mind ☐ Land Division — Pard ☐ Land Division — Pard ☐ Land Division — Re-S ☐ Modification of Cond ☐ Reversion to Acreas	or or el subdivision ditions se	☐ Use Permit — Cottage ☐ Use Permit — Minor ☐ Use Permit — Major ☐ Use Permit — Modification ☐ Variance ☐ Other  MAR 0 2 2023
I certify that the information s	ubmitted with this appl	ication is true and accurat	e.	Planning & Building Services
Gara Fluitt Poster, ou.	a.fluitt@faulkandfoster.		tached leas	
Signature of Applicant/Agent	Date	Sign	nature of Owner	Date

#### SITE AND PROJECT DESCRIPTION QUESTIONNAIRE

The purpose of this questionnaire is to relate information concerning your application to the Department of Planning and Building Services and other agencies who will be reviewing your project proposal. Please remember that the clearer picture that you give us of your project and the site, the easier it will be to promptly process your application. Please answer all questions. Those questions which do not pertain to your project please indicate "Not applicable" or "N/A".

#### THE PROJECT

Modification of antennas an	d equipment pursu	ant to the scope of	work and a nar	rative description	n
					-
	NO. O	F UNITS		SQUARE FOOTAGE	
2. Structures/Lot Coverage				,	TOTAL
2. Structures/Lot Coverage	NO. O EXISTING	F UNITS PROPOSED	EXISTING	SQUARE FOOTAGE PROPOSED	TOTAL
				,	TOTAL
☐ Single Family				,	TOTAL
☐ Single Family ☐ Mobile Home				,	TOTAL
☐ Single Family ☐ Mobile Home ☐ Duplex				,	TOTAL
☐ Single Family ☐ Mobile Home ☐ Duplex ☐ Multifamily				,	TOTAL
☐ Single Family ☐ Mobile Home ☐ Duplex ☐ Multifamily ☐ Other:				,	TOTAL
☐ Single Family ☐ Mobile Home ☐ Duplex ☐ Multifamily ☐ Other: ☐ Other:	EXISTING			,	TOTAL
☐ Single Family ☐ Mobile Home ☐ Duplex ☐ Multifamily ☐ Other: ☐ Other:	EXISTING			,	TOTAL
☐ Single Family ☐ Mobile Home ☐ Duplex ☐ Multifamily ☐ Other:	EXISTING			PROPOSED	TOTAL
☐ Single Family ☐ Mobile Home ☐ Duplex ☐ Multifamily ☐ Other: ☐ Other: ☐ GRAND TOTAL (Equal to gross are	EXISTING  a of Parcel):	PROPOSED	EXISTING	PROPOSED	TOTAL
☐ Single Family ☐ Mobile Home ☐ Duplex ☐ Multifamily ☐ Other: ☐ Other: GRAND TOTAL (Equal to gross are	EXISTING  a of Parcel):	PROPOSED	EXISTING	PROPOSED	TOTAL
☐ Mobile Home ☐ Duplex ☐ Multifamily ☐ Other: ☐ Other: GRAND TOTAL (Equal to gross are	EXISTING  a of Parcel):	PROPOSED	EXISTING	PROPOSED	TOTAL
☐ Single Family ☐ Mobile Home ☐ Duplex ☐ Multifamily ☐ Other: ☐ Other: ☐ GRAND TOTAL (Equal to gross are	EXISTING  a of Parcel):  ustrial or institutional, hift:	PROPOSED	EXISTING g:	PROPOSED	TOTAL

Will the project	t be pha	sed?			
☐ YES	$\overline{X}$ NO	If yes, explain your plans fo	r phasing:		
Will vegetation	be rem	oved on areas other than th	e building sites and roads?		
☐ YES	<b>∑</b> NO	If no, explain:			
·					
Will the projec	t involv	e the use or disposal of note	entially hazardous materials	such as toxic substances, flammables, or e	xplosive
□ YES	√D NO	If yes, explain:			
	A- ···	. , , ,			
<del> </del>					
How much off		parking will be provided?	Number	Size	
		covered spaces: uncovered spaces:			
		standard spaces:			
		accessible spaces:			
		g no. of spaces:			
		ed additional spaces:			
	Total:				
. Is any road co	nstructi	on or grading planned? If ye	es, grading and drainage pla	ns may be required.	
☐ YES	∏ NO	Also, please describe the	terrain to be traversed. (e.g.	. steep, moderate slope, flat, etc.)	
•					
		_			
). For grading o	r road c	onstruction, complete the fo	ollowing:		
Amount of c	:ut:		cubic yards		
		pe:			
		ppe:			
		ope:			
Lagatian of	harrow	r dienocal cite:			

		ct involve sand removal, mining or gravel extraction? If yes, detailed extraction, reclamation a	nu monitoring plans
may	y be required YES	X no	
	⊔ 1 <b>E</b> 3	± NO	
11.	Will the prop	sed development convert land currently or previously used for agriculture to another use?	
	☐ YES	XI NO	
12.	Will the deve	opment provide public or private recreation opportunities?	
	☐ YES	🗓 NO If yes, explain how:	
13	is the propo	d development visible from State Highway 1 or other scenic route?	
13.	☐ YES	⊠ NO	
14.		d development visible from a park, beach or other recreational area?	
	☐ YES	X) NO	
15.	Does the de	elopment involve diking, filling, dredging or placing structures in open coastal water, wetlands,	estuaries or lakes?
	Diking:	□ YES XD NO	
	Filling: Dredging:	□ YES 12 NO	
	Structures:	☐ Open Coastal Waters ☐ Wetlands ☐ Estuaries ☐ Lakes	
	If so what is	ne amount of material to be dredged/filled?: cubic yards	
		edged material disposal site?:	
	Has a U.S. A	y Corps of Engineers permit been applied for? 🔲 YES 🔲 NO	
16	. Will there b	any exterior lighting?	
	☐ YES	☐ NO If yes, describe below and identify the location of all exterior lighting on the plot and but	uilding plans.
	no chang		
-			
17	7. Utilities wil	pe supplied to the site as follows: no change	
	Electricity:	Utility Company (service exists to parcel)	
		☐ Utility Company (requires extension of service to site): feet miles ☐ On Site Generation — Specify:	
	Gas:	Utility Company/Tank	
		☐ On Site Generation – Specify:	
		None	
	Telephone:	☐ YES ☐ NO	

18. What will be the method of sewage disposal? none  Community Sewage System (specify supplier):  Septic Tank  Other (specify):
19. What will be the domestic water source: none  Community Water System (specify supplier):  Well Spring Other (specify):
20. Are there any associated projects and/or adjacent properties under your ownership?  ☐ YES
21. List and describe any other related permits and other public approval required for this project, including those required by othe County departments, city, regional, State and Federal agencies:
nothing new
22. Describe the location of the site in terms of readily identifiable landmarks: (e.g., mailboxes, mile posts, street intersections, etc. see construction drawings
23. Are there existing structures on the property? If yes, describe below and identify the use of each structure on the plot plan or tentative map if the proposal is for a subdivision.
no change
24. Will any existing structure be demolished or removed? If yes, describe the type of development to be demolished or remove including the relocation site, if applicable.
no change

25. What is the i	maximum	height of all	structures?							
Evicting: 5	9	_ feet								
Proposed:	59	_feet								
26. What is the	gross flooi	areas of all	structures, i	ncluding cov	ered parkir	g and accessor	ry buildings?	none		
		_ square feet								
		_square feet								
27. What is the	total lot a	rea within p	roperty lines	i?						
Total Lot Are				quare feet						
28. Briefly descr soil stability, pla be helpful:	ants and a	nimals, and	any cultural,	historical or	scenic asp	ects. Attach an	y photograp	hs of the	e site that y	ou feel would
29. Briefly desci Indicate the typ be helpful.	ribe the su	irrounding p use (use cha	roperties, in rt below) an	cluding infor d its general	mation on intensity.	plants, animals Attach any pho	s and any cu otographs of	tural, his	storic or so	enic aspects. u feel would
									<del> </del>	
30. Indicate the	surround	ling land use	s:							
50. maicate an			Agriculture	Commercial	Industrial	<b>Public Facility</b>	Timberland	Other		
North:										
East:										
South:										
West:										
west.	J	<u> </u>	_	<del>_</del>	_					



February 3, 2023

RE: Faulk & Foster Authorization

To Whom it may concern,

U.S. Cellular® authorizes Faulk and Foster to represent U.S. Cellular® in the performance pf project management, zoning, and permitting activities for various projects in the states of California, Oregon, Washington, Texas, Oklahoma, Missouri, Kansas, Nebraska, Iowa, Illinois, Wisconsin, Tennessee, South Carolina, North Carolina, West Virginia, Virginia, Pennsylvania, New Hampshire, Maine.

Best regards,

Brandi Vandenberg

Brandi Vandenberg
U.S. Cellular®
Sr Manager Access Deployment
10343 Military Road
Omaha, NE 68134
(402) 515-8275
brandi.vandenberg@uscellular.com


# STATE LOCATION

#### C-BAND & DoD DRAWINGS

#### **TALMAGE CAPACITY**

568451

#### 1800 RUDDICK-CUNNINGHAM RD **UKIAH, CA 95482** (MENDOCINO COUNTY)

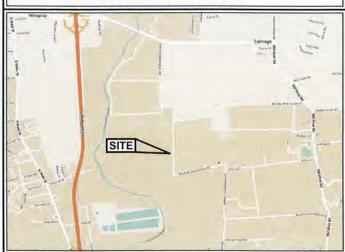

#### PROJECT INFORMATION

LATITUDE: LONGITUDE: N 39° 07' 15.8" \* W 123° 10' 54.6" \*

GROUND ELEVATION: 580'± (AMSL) \*\*

\* INFORMATION PROVIDED USCC

\*\* INFORMATION FROM GOOGLE EARTH

TOWER TYPE: LOADING TYPE: 59'-0" MONOPOLE DX210F-CDMA -**NOKIA C-BAND & DoD** 

**ACCESS ISSUES: GATE COMBO:** 

**KEY ENTRY (7CI KEY)** 



#### Know what's **below**. Call before you dig

#### **INDEX OF SHEETS**

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#### STRUCTURAL NOTE

STRUCTURAL STATUS:

• TOWER SA - PASSING (JANUARY 24, 2023)

• MOUNT REPLACEMENT SA - PASSING (FEBRUARY 2, 2023)

#### SCOPE OF WORK

#### TOWER SCOPE:

EXISTING EQUIPMENT TO REMAIN:

(6) DENGYO OCT8-2LX2HX-BW65 LTE PANEL ANTENNAS.

(3) NOKIA AHLOA B12/B71 RRHs

NOKIA AHFIB B2/B66 RRHs NOKIA FXCB B5 RRHs

RAYCAPS RUSDC-6267-PF-48

MAR 0 2 202

(3) NOKIA AQQK C-BAND RRHS W/ INTEGRATED A**RTENNA**NG & Building Service (3) NOKIA AEQU DOD RRHS W/INTEGRATED ANTENNA
(1) RAYCAP RUSDC-6267-PF-48
(1) 1½" HYBRID CABLE

) FIBER JUMPERS FROM RAYCAP TO C-BAND RRHs ) FIBER JUMPERS FROM RAYCAP TO DOD RRHs

POWER JUMPERS FROM RAYCAP TO C-BAND RRHS POWER JUMPERS FROM RAYCAP TO DoD RRHS

1 M. JUMPERS FROM B12/B66 RRHs TO ANTENNAS
1 M. JUMPERS FROM B2/B66 RRHs TO ANTENNAS
1 M. JUMPERS FROM B5 RRHs TO ANTENNAS
1 M. JUMPERS FROM B12/B66 RRHS TO ANTENNAS
1 M. JUMPERS FROM B12/B66 RRHS TO ANTENNAS
1 M. JUMPERS FROM B2/B66 RRHS TO ANTENNAS
1 M. JUMPERS FROM B2/B66 RRHS TO ANTENNAS

CANNOT ACCOMMODATE ADDITIONAL GROUND LEADS. PROPOSED GROUND BAR REQUIRED.

BOTTOM TOWER GROUND BAR:
CAN ACCOMMODATE ADDITIONAL GROUND LEAD.

SHELTER EXTERIOR SCOPE:

CAN ACCOMMODATE ADDITION OF (1) HYBRID CABLE, (1) GPS ANTENNA AND (1) GPS CABLE.

CAN ACCOMMODATE ADDITION OF (1) HYBRID CABLE AND (1) GPS CABLE.

SHELTER EXTERIOR GROUND BAR: CAN ACCOMMODATE ADDITIONAL GROUND LEADS. SHELTER INTERIOR SCOPE:

PROPOSED EQUIPMENT:

(1) PROPOSED RAYCAP FIBER SLACK TRAY

(1) PROPOSED RAYCAP PDU BOX (BY OTHERS)

EXISTING FOUIPMENT:

(2) RAYCAPS RUSDC-6267-PF-48 TO REMAIN

(1) RAYCAP RUSDC-8999-P-48 TO BE REMOVED

SHELTER INTERNAL GROUND BAR: CAN ACCOMMODATE ADDITIONAL GROUND LEAD. SPECIAL REQUIREMENTS:

ANTENNA AZIMUTHS:

PROPOSED C-BAND AND DOD RRHs TO BE INSTALLED AT THE DESIGN AZIMUTH. AZIMUTH CHANGES MUST BE PRE SCHEDULED WITH USCC.

EXISTING ANTENNA MOUNTS TO BE REPLACED. SEE MOUNT REPLACEMENT ANALYSIS BY TEP DATED FEBRUARY 2, 2023.

ANTENNA CONFIGURATION:

PROPOSED C-BAND AND DoD RRHs TO BE INSTALLED AT 53'-6" AND PLACED ON MOUNT POSITIONS A3, B3 AND G3.

CDMA CONSOLIDATION:

GC TO PLUMB ALL SECTORS CDMA COAX INTO EXISTING LTE ANTENNAS. SEE SHEET C-11 FOR DETAILS.

**DECOMMISSIONED EQUIPMENT REMOVAL:** 

(3) AMPHENOL BXA-80040-8CF-EDIN-0 CDMA PANEL ANTENNAS

(2) RAYCAP RUSDC-8999-P-48

(1) 1¼" POWER CABLE

# PLANS PREPARED FOR:

CHICAGO, IL 60631 (773) 399-8900

PROJECT INFORMATION:

#### 568451 TALMAGE CAPACITY

1800 RUDDICK-CUNNINGHAM RD UKIAH, CA 95482 (MENDOCINO COUNTY)

PLANS PREPARED BY:



#### TOWER ENGINEERING PROFESSIONALS

500 E. 84TH AVE, SUITE C10 THORNTON, CO 80229 OFFICE: (303) 566-9914 www.tepgroup.net

SEAL:



February 24, 2023

REV	DATE	ISSUED FOR:
1	02-02-23	PRELIMINARY
2	02-23-23	PRELIMINARY
3	02-24-23	CONSTRUCTION

DRAWN BY: RSR CHECKED BY: GSK

SHEET TITLE:

TITLE SHEET

SHEET NUMBER:

REVISION:

TEP#: 25207.743329



#### PROJECT TEAM

RANDALL MATTSON

PROJECT CONTACT:
U.S. CELLULAR CORPORATION NAME 8410 W BRYN MAWR SUITE 700 **ADDRESS** CHICAGO, IL 60631 CITY, STATE, ZIP

SITE ACQUISITION:

NAME FAULK & FOSTER **ADDRESS** 1811 AUBURN AVENUE MONROE, LA 71201 CITY, STATE, ZIP CONTACT DAN HOOVER (318) 807-4666

**TOWER OWNER:** 

PHONE

US CELLULAR CORPORATION **ADDRESS** 8410 W. BRYN MAWR, SUITE 700 CHICAGO, IL 60631

CITY, STATE, ZIP CONTACT

RANDALL MATTSON

TOWER ENGINEERING PROFESSIONALS, INC. 4710 E. ELWOOD ST. #9

**ADDRESS** CITY, STATE, ZIP CONTACT

PHOENIX, AZ 85040 DAN REIDENBACH, P.E. (480) 750-9062 PHONE

**CIVIL ENGINEER:** 



#### **BIRD'S EYE AERIAL OVERVIEW**



SITE OVERVIEW



**COMPOUND SIGNAGE** 

#### NOTES:

- SITE PLAN CREATED FROM SURVEY DATED MAY 27, 2013 BY WILLIAM P. COLISCH.
- 2. SURVEY LISTED ABOVE WAS PROVIDED BY USCC AND IS NOT CARRIED UNDER SIGNATURE AND SEAL OF TOWER ENGINEERING PROFESSIONALS' SURVEYING SERVICES AND/OR ITS LAND SURVEYING PROFESSIONALS.

EXISTING DIRT ACCESS ROAD EXISTING USCC COMPOUND. SEE SHEET C-2 FOR

RUDDICK CUNNINGHAM RD

PLANS PREPARED FOR:



CHICAGO, IL 60631 (773) 399-8900

PROJECT INFORMATION:

#### 568451 **TALMAGE CAPACITY**

1800 RUDDICK-CUNNINGHAM RD UKIAH, CA 95482 (MENDOCINO COUNTY)

PLANS PREPARED BY:



#### **TOWER ENGINEERING PROFESSIONALS**

500 E. 84TH AVE, SUITE C10 THORNTON, CO 80229 OFFICE: (303) 566-9914 www.tepgroup.net

SEAL:



February 24, 2023

REV	DATE	ISSUED FOR:
1	02-02-23	PRELIMINARY
2	02-23-23	PRELIMINARY
3	02-24-23	CONSTRUCTION

DRAWN BY: RSR CHECKED BY:

SHEET TITLE:

SITE PLAN

SHEET NUMBER:

REVISION:

TEP#: 25207.743329

SITE PLAN SCALE: N.T.S



#### COMPOUND VIEW "A"




**COMPOUND VIEW "B"** 



**COMPOUND DETAIL** 

SCALE: 1 = 1'-0"

COMPOUND VIEW "C"

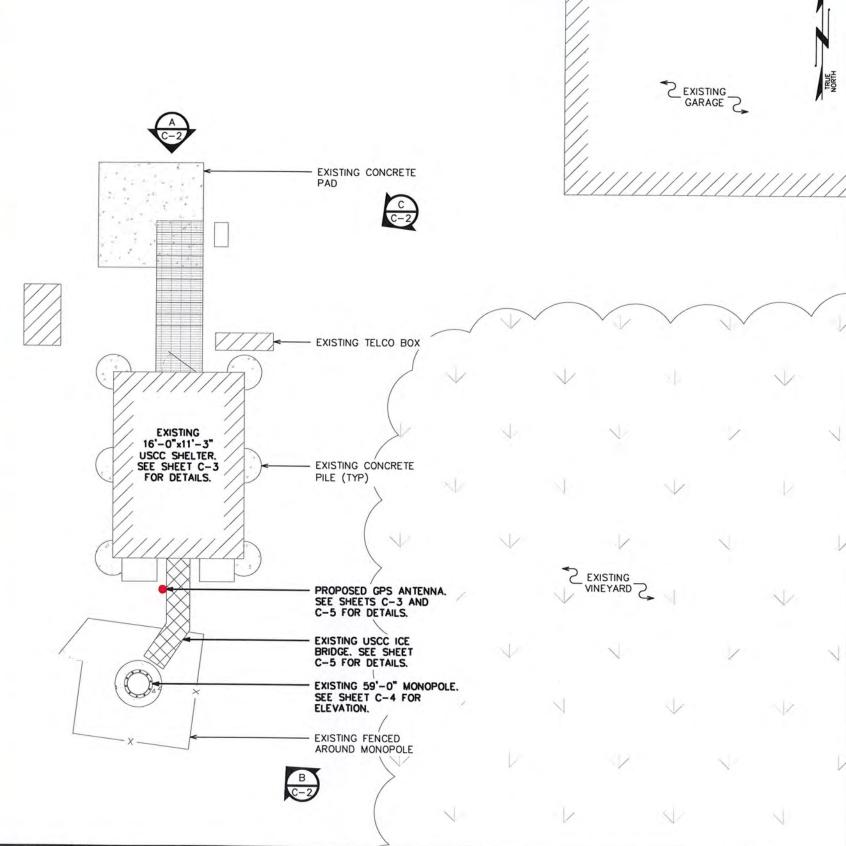

PLANS PREPARED FOR:

USCEllular

410 W BRYN MAWR SUITE 70 CHICAGO, IL 60631 (773) 399-8900

PROJECT INFORMATION:

#### 568451 TALMAGE CAPACITY

1800 RUDDICK-CUNNINGHAM RD UKIAH, CA 95482 (MENDOCINO COUNTY)

PLANS PREPARED BY:

#### TOWER ENGINEERING PROFESSIONALS

500 E. 84TH AVE, SUITE C10 THORNTON, CO 80229 OFFICE: (303) 566-9914 www.tepgroup.net

SEAL:

PROFIES

REIDENDATE

92372

\* Exp.06/30/2023 \*

CIVIL

OF CALIFORNIA

### February 24, 2023

3	02-24-23	CONSTRUCTION
2	02-23-23	PRELIMINARY
1	02-02-23	PRELIMINARY
REV	DATE	ISSUED FOR:

DRAWN BY: RSR CHECKED BY: GSK

SHEET TITLE:

**COMPOUND DETAIL** 

SHEET NUMBER:


SCALE IN FEET

2-2

REVISION:


#### NOTE:

CONTRACTOR TO REMOVE OUTER JACKET OF HYBRID CABLE AT THE COAX PORT TO EXPOSE THE FIBER AND POWER RUNS. FIBER RUNS ARE TO BE ROUTED TO THE AUXILIARY RACK AND THE POWER RUNS ARE TO BE ROUTED TO THE RAYCAP/PDU BOX ON THE POWER BAY.

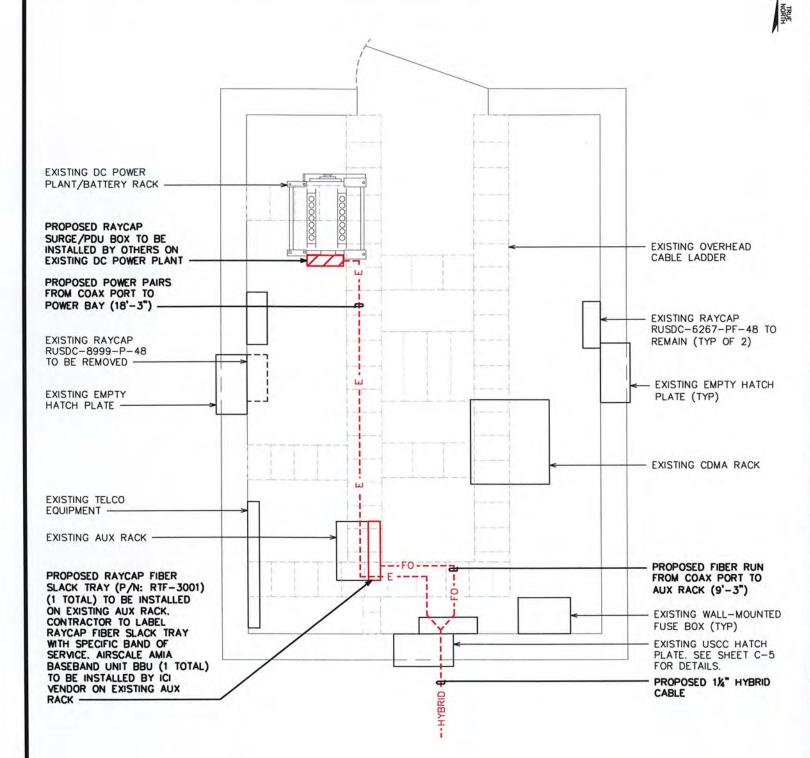

#### NOTES:

- I. LOCATION OF ANTENNA MUST HAVE CLEAR VIEW OF SOUTHERN SKY AND CANNOT HAVE ANY BLOCKAGES EXCEEDING 25% OF THE SURFACE AREA OF A HEMISPHERE AROUND THE GPS ANTENNA.
- 2. ALL GPS ANTENNA LOCATIONS MUST BE ABLE TO RECEIVE CLEAR SIGNALS FROM A MINIMUM OF FOUR (4) SATELLITES. VERIFY WITH HANDHELD GPS BEFORE FINAL LOCATION OF GPS ANTENNA.

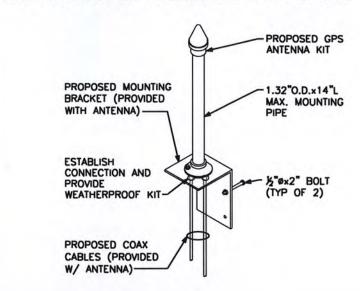

#### **GPS ANTENNA KIT DETAIL**

SCALE: N.T.S.



#### **EXISTING AUX RACK LOCATION**



10 W BRYN MAWR SUITE 700 CHICAGO, IL 60631 (773) 399-8900

PROJECT INFORMATION:

#### 568451 TALMAGE CAPACITY

1800 RUDDICK-CUNNINGHAM RD UKIAH, CA 95482 (MENDOCINO COUNTY)

PLANS PREPARED BY:



#### **TOWER ENGINEERING PROFESSIONALS**

500 E. 84TH AVE, SUITE C10 THORNTON, CO 80229 OFFICE: (303) 566-9914 www.tepgroup.net

SEAL:



February 24, 2023

REV	DATE	ISSUED FOR:
1	02-02-23	PRELIMINARY
2	02-23-23	PRELIMINARY
3	02-24-23	CONSTRUCTION

DRAWN BY: RSR CHECKED BY: GSK

SHEET TITLE:

SHELTER DETAIL

SHEET NUMBER:

C-3

REVISION:

TEP#: 25207.743329

INTERIOR SHELTER LAYOUT

SCALE: %" = 1'-0"

O 2 4
SCALE IN FEET

#### **EUPEN HYBRID CABLE LENGTH**

PROPOSED HYBRID CABLE QUANTITY:	1
EXISTING HYBRID CABLE QUANTITY:	2
LONGEST ROUTE TO COAX PORT IN SHELTER:	18-FT
ICE BRIDGE LENGTH:	10-FT
RAYCAP CENTERLINE + 12-FT BUFFER:	62-FT
TOTAL ESTIMATED LENGTH OF HYBRID CABLE:	90-FT

TOTAL EST, LENGTH OF HYBRID CABLE (ROUNDED UP): 100-FT

#### **JUMPER INFO**

JUMPER	QUANTITIES	
FIBER JUMPERS:	6	
COAX JUMPERS:	36	
RET JUMPERS:	6	

FIBER JUMPER LE	NGTH FROM RAYCA	AP TO RRH
	C-BAND	DoD
ALPHA SECTOR:	10-M	10-M
BETA SECTOR:	10-M	10-M
GAMMA SECTOR:	10-M	10-M

½" COAX JUMPER FRO	DM B12/B71 RRH TO ANTENNA
ALPHA SECTOR:	25-FT
BETA SECTOR:	25-FT
GAMMA SECTOR:	25-FT

½" COAX JUMPER FROM	B2/B66 RRH TO ANTENNA
ALPHA SECTOR:	25-FT
BETA SECTOR:	25-FT
GAMMA SECTOR:	25-FT

½" COAX JUMPER FR	OM B5 RRH TO ANTENNA
ALPHA SECTOR:	25-FT
BETA SECTOR:	25-FT
GAMMA SECTOR:	25-FT

#### **RET JUMPER INFO**

	RRH TO ANTENNA
ALPHA SECTOR:	10-M
BETA SECTOR:	10-M
GAMMA SECTOR:	10-M

#### NOTES:

- EXISTING AND PROPOSED USCC ANTENNAS
   ARE TO BE VERTICALLY CENTERED ON
- 2. T/LIGHTNING ROD TO EXTEND AT LEAST 2' ABOVE THE NEXT HIGHEST APPURTENANCE.

EXISTING LTE PANEL TO REMAIN: EXISTING CDMA PANEL TO REMAIN: PROPOSED CBAND/DoD PANEL TO BE INSTALLED:

> PROPOSED SECTOR MOUNT (TYP OF 3). SEE SHEET C-14 FOR MORE DETAILS.

PROPOSED LIGHTING ROD. SEE

@ 53,-e"

PROPOSED USCC

EXISTING &

P

OF USCC ANTENNAS AND EQUIPMENT @ 53'-6": (6) EXISTING LTE ANTENNAS AND (2) RAYCAPS TO BE RELOCATED TO PROPOSED MOUNTS. (3) EXISTING COMA ANTENNAS TO BE REMOVED. (3) PROPOSED NOKIA AQQK RRHS W/INTEGRATED ANTENNA AND (3) NOKIA AEQU RRHS W/INTEGRATED ANTENNA TO BE INSTALLED ON PROPOSED ANTENNA MOUNTS, SEE SHEET C-8 FOR MORE DETAILS.

€ OF USCC RRH MOUNTS
• 49'-6": (3) EXISTING AHLOA RRHs, (3) AHFIB RRHs, (2) FXCB RRHs TO REMAIN. (1) PROPOSED RAYCAP TO BE INSTALLED ON EXISTING RRH MOUNT. (1) EXISTING RAYCAP TO BE REMOVED. SEE SHEET C-9 FOR MORE DETAILS. GC TO LOWER EXISTING RRH MOUNT 3' IN ORDER TO ACCOMMODATE PROPOSED MOUNT.

EXISTING 59'-0" MONOPOLE

0'-0" (REFERENCE)
T/BASEPLATE

**EXISTING TOWER ELEV** 

**EXISTING GAMMA SECTOR** 

**EXISTING ALPHA SECTOR** 



**EXISTING BETA SECTOR** 



PLANS PREPARED FOR:

CHICAGO, IL 60631 (773) 399-8900

PROJECT INFORMATION:

#### 568451 **TALMAGE CAPACITY**

1800 RUDDICK-CUNNINGHAM RD UKIAH, CA 95482 (MENDOCINO COUNTY)

PLANS PREPARED BY:



#### TOWER ENGINEERING PROFESSIONALS

500 E. 84TH AVE, SUITE C10 THORNTON, CO 80229 OFFICE: (303) 566-9914 www.tepgroup.net

SEAL:



February 24, 2023

3 02-24-23 CONSTRUCTION 2 02-23-23 PRELIMINARY I 02-02-23 PRELIMINARY REV DATE ISSUED FOR:			
2 02-23-23 PRELIMINARY	REV	DATE	ISSUED FOR:
	1	02-02-23	PRELIMINARY
3 02-24-23 CONSTRUCTION	2	02-23-23	PRELIMINARY
	3	02-24-23	CONSTRUCTION

DRAWN BY: RSR CHECKED BY: GSK

SHEET TITLE:

**TOWER ELEVATION** 

SHEET NUMBER:

REVISION:

TEP#: 25207.743329


#### PROPOSED TOWER ELEVATION


SCALE: 1 = 1'-0"

SCALE IN FEET



- 1. ALL VIEWS ARE LOOKING FROM THE TOWER TOWARDS THE SHELTER.
- 2. ANALOG COAX (IF APPLICABLE) TO BE REMOVED IS LABELED WITH GREEN TAPE.

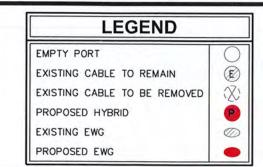

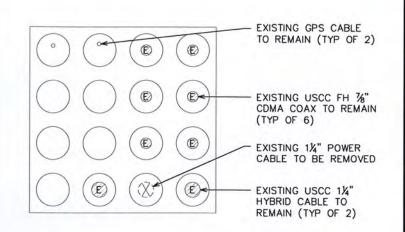


#### **EXISTING HATCH PLATE LAYOUT**

SCALE: N.T.S.


#### NOTE:

CONTRACTOR TO VERIFY COAX LOCATION WITH STRUCTURAL ANALYSIS AND TOWER OWNER PRIOR TO INSTALLATION.

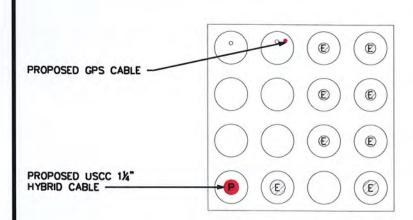


#### PROPOSED HATCH PLATE LAYOUT

SCALE: N.T.S.

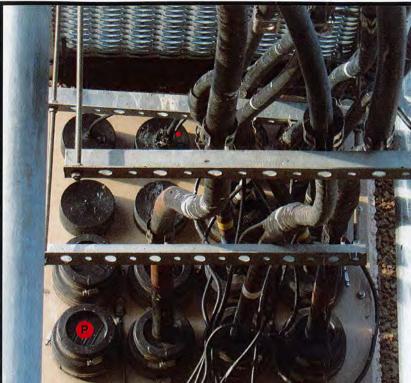

**EXISTING HATCH PLATE** 

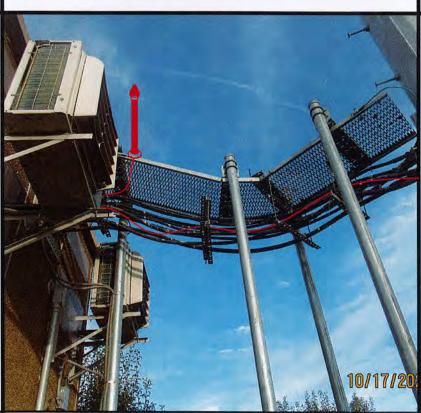

**EXISTING ICE BRIDGE ELEVATION** 

# EXISTING USCC FH 76" CDMA COAX TO REMAIN (TYP OF 6) EXISTING USCC 1½" HYBRID CABLE TO REMAIN (TYP OF 2) EXISTING USCC 1½" POWER CABLE TO BE REMOVED

#### **EXISTING ICE BRIDGE CONFIGURATION**

SCALE: N.T.S.

# PROPOSED USCC 1½" HYBRID CABLE PROPOSED USCC 1½" HYBRID CABLE 1. COAX LOCATIONS ARE SHOWN FOR REFERENCE ONLY AND ARE SUBJECT TO CHANGE BASED ON FIELD CONDITIONS. 2. HYBRID CABLES ARE NOT TO BE DOUBLE-STACKED FOR ANY REASON, EVEN FOR TEMPORARY PURPOSES.

#### PROPOSED ICE BRIDGE CONFIGURATION

SCALE: N.T.S.

# PLANS PREPARED FOR: Suscellular.

O W BRYN MAWR SUITE 700 CHICAGO, IL 60631 (773) 399-8900

PROJECT INFORMATION:

#### 568451 TALMAGE CAPACITY

1800 RUDDICK-CUNNINGHAM RD UKIAH, CA 95482 (MENDOCINO COUNTY)

PLANS PREPARED BY:



#### **TOWER ENGINEERING PROFESSIONALS**

500 E. 84TH AVE, SUITE C10 THORNTON, CO 80229 OFFICE: (303) 566-9914 www.tepgroup.net

SEAL:



February 24, 2023

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DRAWN BY: RSR CHECKED BY: GSK

SHEET TITLE:


HATCH PLATE & ICE BRIDGE DETAILS


SHEET NUMBER:

REVISION:

C-5

3". 0500554

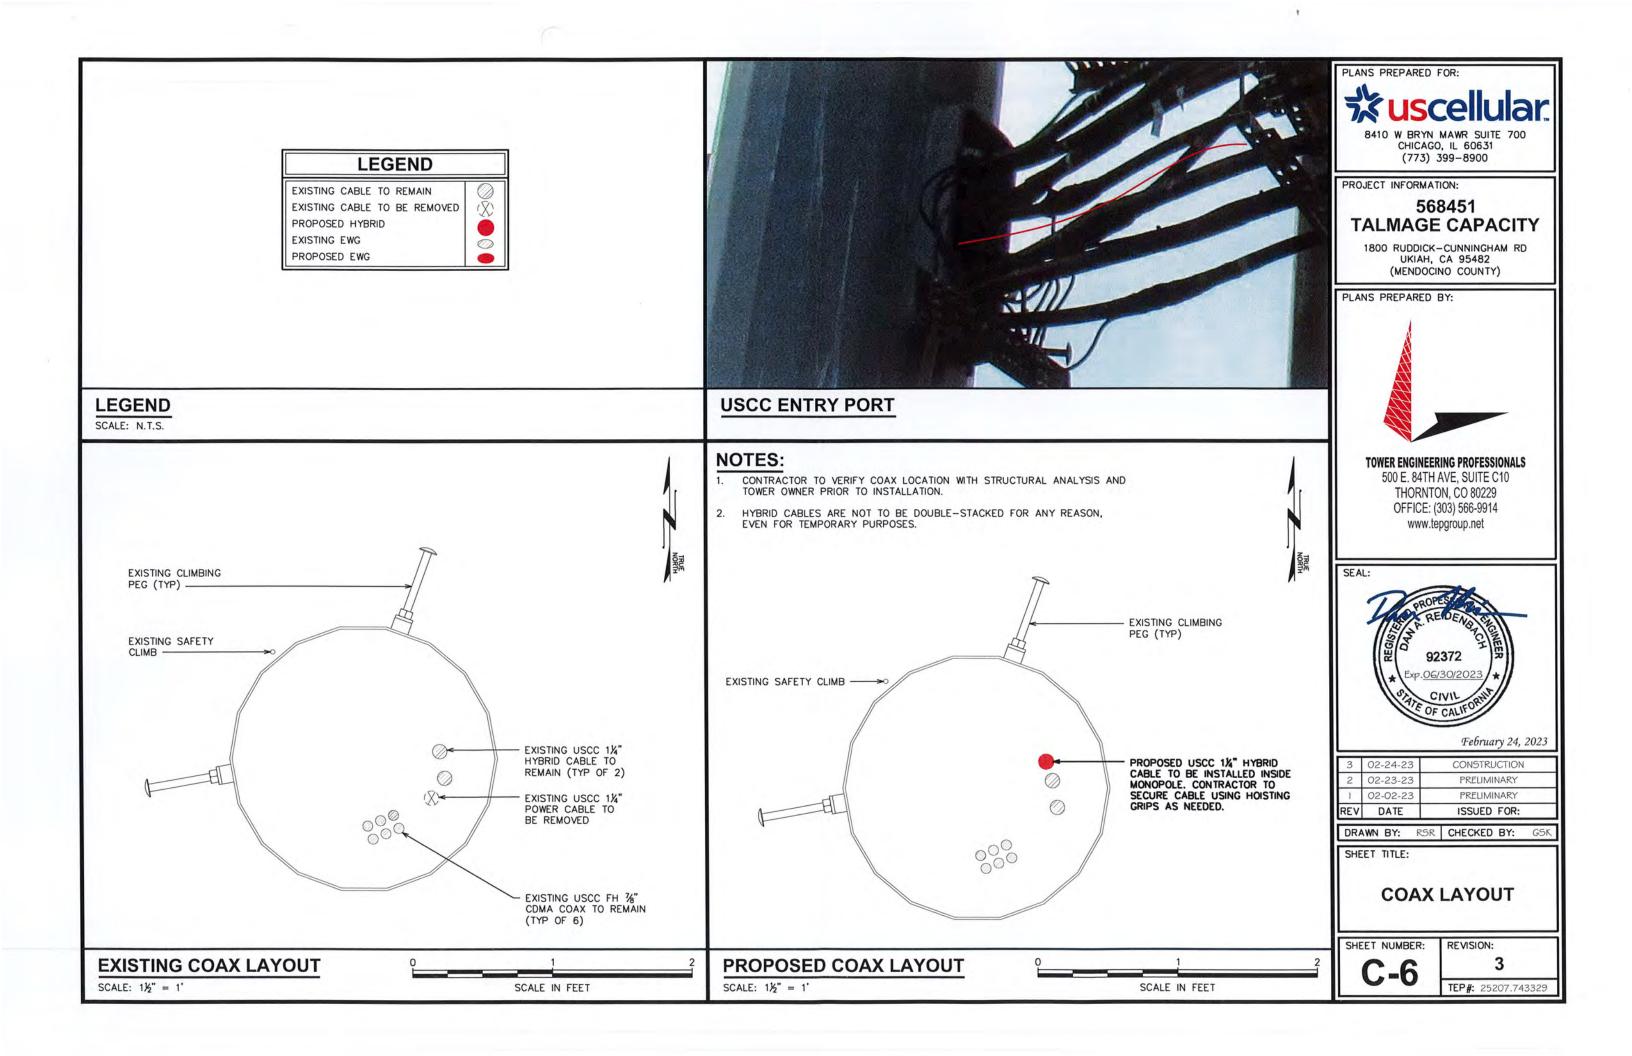

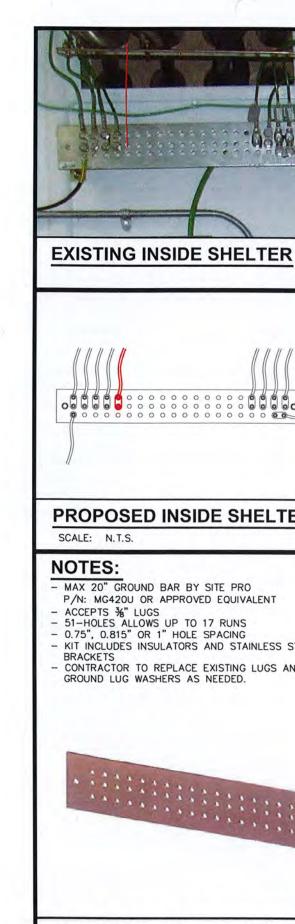





**EXISTING BOTTOM TOWER** 



## PLANS PREPARED FOR: CHICAGO, IL 60631 (773) 399-8900 PROJECT INFORMATION:

#### 568451 TALMAGE CAPACITY

1800 RUDDICK-CUNNINGHAM RD UKIAH, CA 95482 (MENDOCINO COUNTY)

PLANS PREPARED BY:




#### **TOWER ENGINEERING PROFESSIONALS**

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#### NOTE:

EXISTING GROUND BAR HAS INSUFFICIENT CAPACITY FOR PROPOSED GROUND LEADS. PROPOSED PLATE STYLE GROUND BAR REQUIRED. SEE THIS SHEET FOR

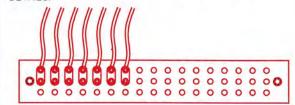

#### PROPOSED INSIDE SHELTER


#### PROPOSED OUTSIDE SHELTER

000000000

PROPOSED BOTTOM TOWER SCALE: N.T.S.

#### PROPOSED TOP TOWER

SCALE: N.T.S.

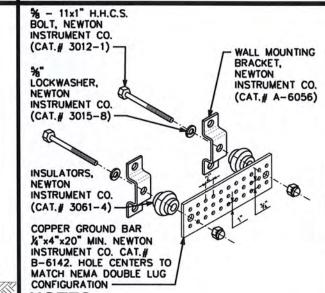

- MAX 20" GROUND BAR BY SITE PRO P/N: MG420U OR APPROVED EQUIVALENT
- KIT INCLUDES INSULATORS AND STAINLESS STEEL
- CONTRACTOR TO REPLACE EXISTING LUGS AND



#### PROPOSED #2 TINNED FROM SUPPORT HYBRID CABLE GROUND GPS -KITS TO TOWER GROUND POST TO ICE BRIDGE (TYP) BAR PROPOSED USCC 124" HYBRID CABLE EXISTING MONOPOLE-EXISTING ICE BRIDGE WEATHERPROOF GROUND DRIP LOOP SHOULD KIT CONNECTION MAINTAIN 14" MIN BEND RADIUS GROUND EQUIPMENT SHELTER COAX LEAD CABLE ENTRY PORT TO BE REPLACED SHELTER GROUND BAR BOTTOM TOWER GROUND BAR (INSTALL ADDITIONAL AS NEEDED) NEEDED -¾" FLEXIBLE PVC (TYP) EXISTING GROUND RING

NOTES: GROUND BAR SHALL BE SIZED TO ACCOMODATE ALL GROUNDING CONNECTIONS REQUIRED PLUS PROVIDE 50% SPARE CAPACITY

2. MINIMUM SPACING OF 12" BETWEEN ALL CADWELDS

#### STANDARD GND. BAR DETAIL

SCALE: N.T.S.



RFV	DATE	ISSUED FOR:
-1	02-02-23	PRELIMINARY
2	02-23-23	PRELIMINARY
3	02-24-23	CONSTRUCTION

DRAWN BY: RSR CHECKED BY:

SHEET TITLE:

#### GROUND BAR DETAILS

REVISION:

SHEET NUMBER:


TEP#: 25207.743325

#### PROPOSED GND. BAR DETAIL

SCALE: N.T.S.

#### SIDE VIEW


SCALE: N.T.S.

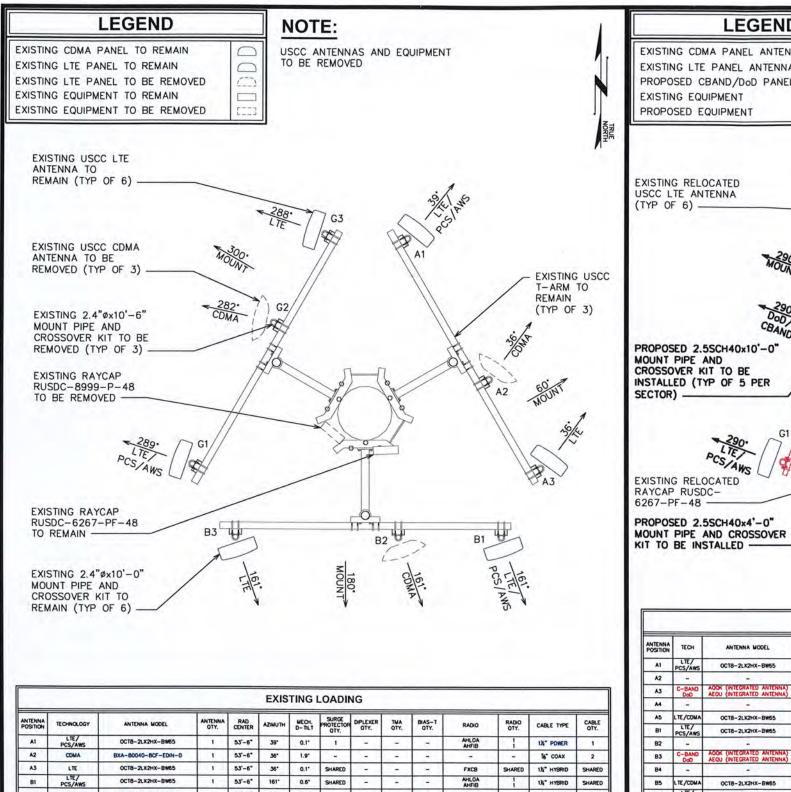

	EXISTING LOADING													
ANTENNA POSITION	TECHNOLOGY	ANTENNA MODEL	ANTENNA OTY.	RAD CENTER	AZIMUTH	MECH. D-TILT	SURGE PROTECTOR OTY,	DIPLEXER OTY.	TMA QTY.	BIAS-T OTY.	RADIO	RADIO OTY.	CABLE TYPE	CABLE OTY.
A1	PCS/AWS	OCT8-2LX2HX-BW65	1	53'-6"	39*	0.1*	1_	-	4		AHLOA	1	1%" POWER	1
A2	CDMA	BXA-80040-8CF-EDIN-0	1	53'-6"	36*	1.9*	L.	. G	-	-	-	11901	% COAX	2
A3	LTE	OCT8-2LX2HX-BW65	1	53'-6"	36*	0.1*	SHARED	-	-	-	FXCB	SHARED	1%" HYBRID	SHARED
B1	LTE/ PCS/AWS	OC18-2LX2HX-BW65	1	53'-6"	161"	0.6*	SHARED	-	-		AHLOA AHFIB	1	1½" HYBRID	SHARED
B2	COMA	BXA-80040-8CF-EDIN-0	1	53'-6"	161"	0.6*	-	-	-	-	211	100	% COAX	2
B3	LTE	OCT8-2LX2HX-BW65	1	53'-6"	161"	1.4"	1	-	-	-	FXCB	2	1¼" HYBRID	1
G1	PCS/AWS	OCT8-2LX2HX-BW65	1	53'-6"	289*	0.1*	-1	-	-	-	AHLOA AHFIB		1¼" HYBRID	1
G2	COMA	BXA-80040-8CF-EDIN-0	1	22,-6.	282*	0.3	-	-	-	-	-	-	% COAX	2
G3	LTE	OCT8-2LX2HX-BW65	1	53'-6"	288*	1.88*	SHARED	-	-	-	FXCB	SHARED	1¼" HYBRID	SHARED

#### **EXISTING ANTENNA ASSIGNMENT**


SCALE: 1 = 1'-0"

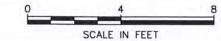

#### LEGEND NOTES:

EXISTING CDMA PANEL ANTENNA EXISTING LTE PANEL ANTENNA PROPOSED CBAND/DoD PANEL ANTENNA EXISTING EQUIPMENT PROPOSED EQUIPMENT

MOUNT ANTENNAS & EQUIPMENT PER MANUFACTURERS SPECIFICATIONS. MOUNT HAS INSUFFICIENT CAPACITY TO SUPPORT PROPOSED EQUIPMENT. SEE TEP MOUNT REPLACEMENT ANALYSIS DATED FEBRUARY 2, 2023.

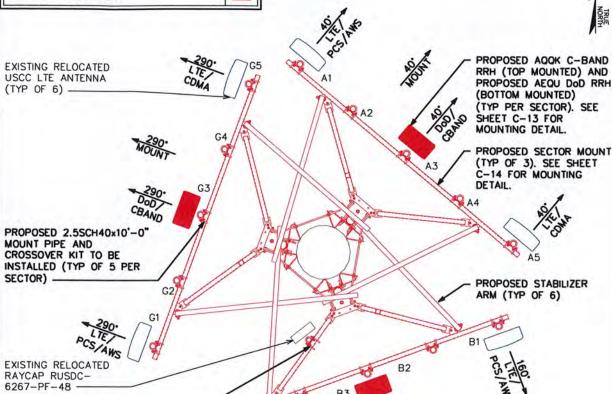


									D LOAI	100									
ANTENNA POSITION	TECH	ANTENNA MODEL	ANTENNA QTY.	RAD CENTER	AZIMUTH	MECH. D-TILT	ELEC. D-TILT (LB)	ELEC. D-TILT (MB)	SURGE PROTECTOR OTY.	CBAND RRH DoD RRH	RADIO QTY.	B12/B71 RADIO	RADIO QTY.	B2/B66 RADIO	RADIO QTY.	B5 RADIO	RADIO OTY,	CABLE TYPE	CABL! QTY.
Al	LTE/ PCS/AWS	OCT8-2LX2HX-BW65	1	53'-6"	40"	-2	-	-5	SHARED	-	-	AHLOA	1.	AHFIB	1	-	-	1%" HYBRID	SHAR
A2	-		2.1	-	-	-	-	-	-	-	-	-	-	GA	7	-	-	-	-
A3	C-BAND DoO	AOOK (INTEGRATED ANTENNA) AEOU (INTEGRATED ANTENNA)	5	53'-2" 50'-9"	40° 40°	=	-	-	1	AOOK AEOU	1		-		-	-	-	1¼" HYBRID	1
A4	-	-	100	-	-	-	-	-	-	-	- T	-	-	- 2 ·	-		-	-	-
A5	LTE/CDMA	OCT8-2LX2HX-BW65	1	53'-6"	40"		1-5	G.	SHARED	-	-	-	-		-	FXCB	SHARE	1%" HYBRID	SHAR 2
BI	PCS/AWS	OCT8-2LX2HX-BW65	1	53'-6"	160*	-	190	-	SHARED	-	-	AHLOA	T.	AHFIB	1	-	16	1%" HYBRID	SHAR
B2	-		-	-	-	-	-	(4)	-	-	-	-	4	-		-	14	(+)	-
B3	C-BAND DoD	ACOK (INTEGRATED ANTENNA) AEQU (INTEGRATED ANTENNA)	1	53'-2" 50'-9"	160"	=	-	-	SHARED	ACOU	1	-	-	1.5	-		-	1%" HYBRID	SHAR
B4	-		-			-		-	-	-	-	-	-		- 1	-	-		
B5	LTE/CDMA	OCT8-2LX2HX-BW65	1	53'-6"	160"	-	-	12	1	-	-	-	12		É.,	FXCB	2	1%" HYBRID	1 2
G1	PCS/AWS	OCT8-2LX2HX-BW65	1	53'-6"	290"	-	-	-	1		-	AHLOA	1.	AHFIB	1	-	-	1%" HYBRID	1
G2	-		-	-	-	-	-	-	-	-	0-1		-	-	-	-	-	-	-
G3	C-BAND DoD	ACOK (INTEGRATED ANTENNA) AEQU (INTEGRATED ANTENNA)	-	53'-2" 50'-9"	290°	- 1	-	91	SHARED	AQQK	1	-	-	-	-		-	1¼" HYBRID	SHAR
G4			-	-	-	-	-	-	-	-	-	141	- 2	1 2	- 0	-	-	-	-
G5	LTE/CDMA	OCT8-2LX2HX-BW65	1	53'-6"	290	-	-	-	SHARED	4	is.	4	2-1		-	FXCB	SHARE	1%" HYBRID %" COAX	SHAR 2
TOTALS:			6						3		6		3		3		2		9

**B5** 

#### PROPOSED ANTENNA ASSIGNMENT

SCALE: 14" = 1'-0"

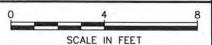

# PLANS PREPARED FOR:

CHICAGO, IL 60631 (773) 399-8900

PROJECT INFORMATION:

#### 568451 TALMAGE CAPACITY

1800 RUDDICK-CUNNINGHAM RD UKIAH, CA 95482 (MENDOCINO COUNTY)

PLANS PREPARED BY:



#### **TOWER ENGINEERING PROFESSIONALS**

500 E. 84TH AVE. SUITE C10 THORNTON, CO 80229 OFFICE: (303) 566-9914 www.tepgroup.net

SEAL:



RFV	DATE	ISSUED FOR-
1	02-02-23	PRELIMINARY
2 02-23-23		PRELIMINARY
3	02-24-23	CONSTRUCTION

DRAWN BY: RSR CHECKED BY:

SHEET TITLE:


ANTENNA MOUNTING DETAIL


SHEET NUMBER:

REVISION:

TEP#: 25207.743329

February 24, 2023

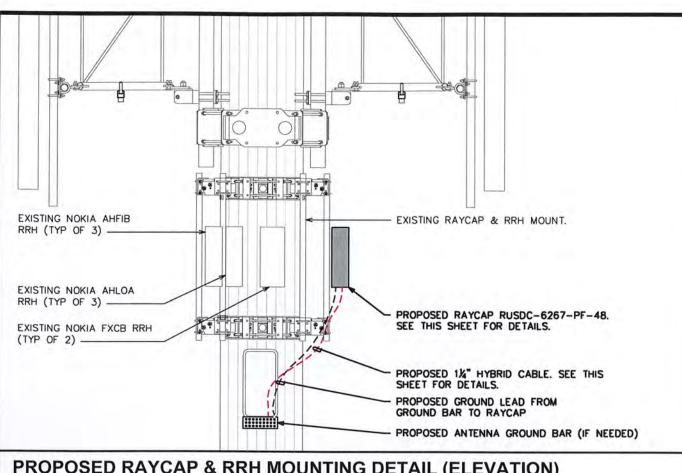

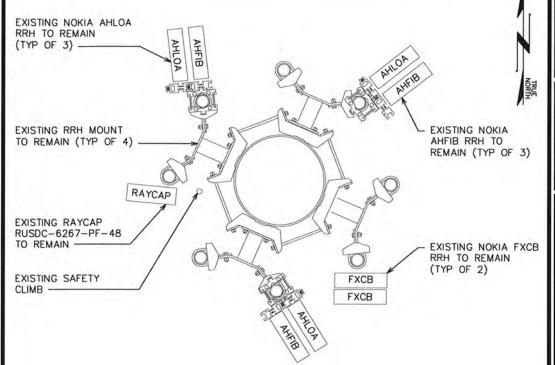

# PLANS PREPARED FOR:

CHICAGO, IL 60631 (773) 399-8900

PROJECT INFORMATION:

#### 568451 **TALMAGE CAPACITY**

1800 RUDDICK-CUNNINGHAM RD UKIAH, CA 95482 (MENDOCINO COUNTY)

PLANS PREPARED BY:



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500 E. 84TH AVE, SUITE C10 THORNTON, CO 80229 OFFICE: (303) 566-9914 www.tepgroup.net

#### SEAL:

PROPOSED RAYCAP

MOUNT PER

FXCB **FXCB** 

MANUFACTURER

RUSDC-6267-PF-48.



February 24, 2023

REV	DATE	ISSUED FOR:	
1	02-02-23	PRELIMINARY	
2	02-23-23	3 PRELIMINARY	
3	02-24-23	CONSTRUCTION	

DRAWN BY: RSR CHECKED BY:

SHEET TITLE:

**RAYCAP & RRH** LAYOUT

SHEET NUMBER:

#### PROPOSED RAYCAP & RRH MOUNTING DETAIL (ELEVATION)

SCALE: N.T.S.


#### NOTES:

- P/N: RUSDC-6267-PF-48

- 20.6"Hx18.9"Wx5.8"D - 19.95 LBS.



BOTTOM VIEW

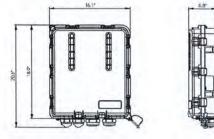

FRONT VIEW

### SIDE VIEW

NOTES:

O.D.) AT EACH END

(2' O.D.)

**EUPEN HYBRID CABLE** 

- 1%" FIBER OPTIC CABLE WITH 48V ENERGY

FEEDER IN CORRUGATED ALUMINUM SHIELDING WITH UV RESISTANT PE JACKET.

MINIMUM BENDING RADIUS: 360mm (14")

APPROX WEIGHT: 2300kg/km (1.55LB/FT)

SHIPPED W/4' PROTECTED JACKET (2.25"

- NON-ARMORED ENDS ARE 3" IN LENGTH

MAXIMUM PULLING STRENGTH: 150daN

MAXIMUM HANGER SPACING: 1,0m

SCALE: N.T.S.

#### **EXISTING RAYCAP & RRH MOUNTING DETAIL (PLAN)**

SCALE: N.T.S.

#### NOTES:

CONTRACTOR TO LEAVE OPENING FOR SAFETY CLIMB AND ENSURE SAFETY CLIMB IS NOT OBSTRUCTED/COMPROMISED. TOWER TOP FIBER/POWER CONNECTIONS FROM RAYCAP TO RRH SHOULD BE SHIELDED IN 1" INTERDUCT (75' PROVIDED IN HYBRID KIT)


0 RAYCAP EXISTING SAFETY CLIMB. SEE NOTE 1

PROPOSED RAYCAP & RRH MOUNTING DETAIL (PLAN) SCALE: N.T.S.

**RAYCAP SPEC SHEET** 

SCALE: N.T.S.

REVISION:

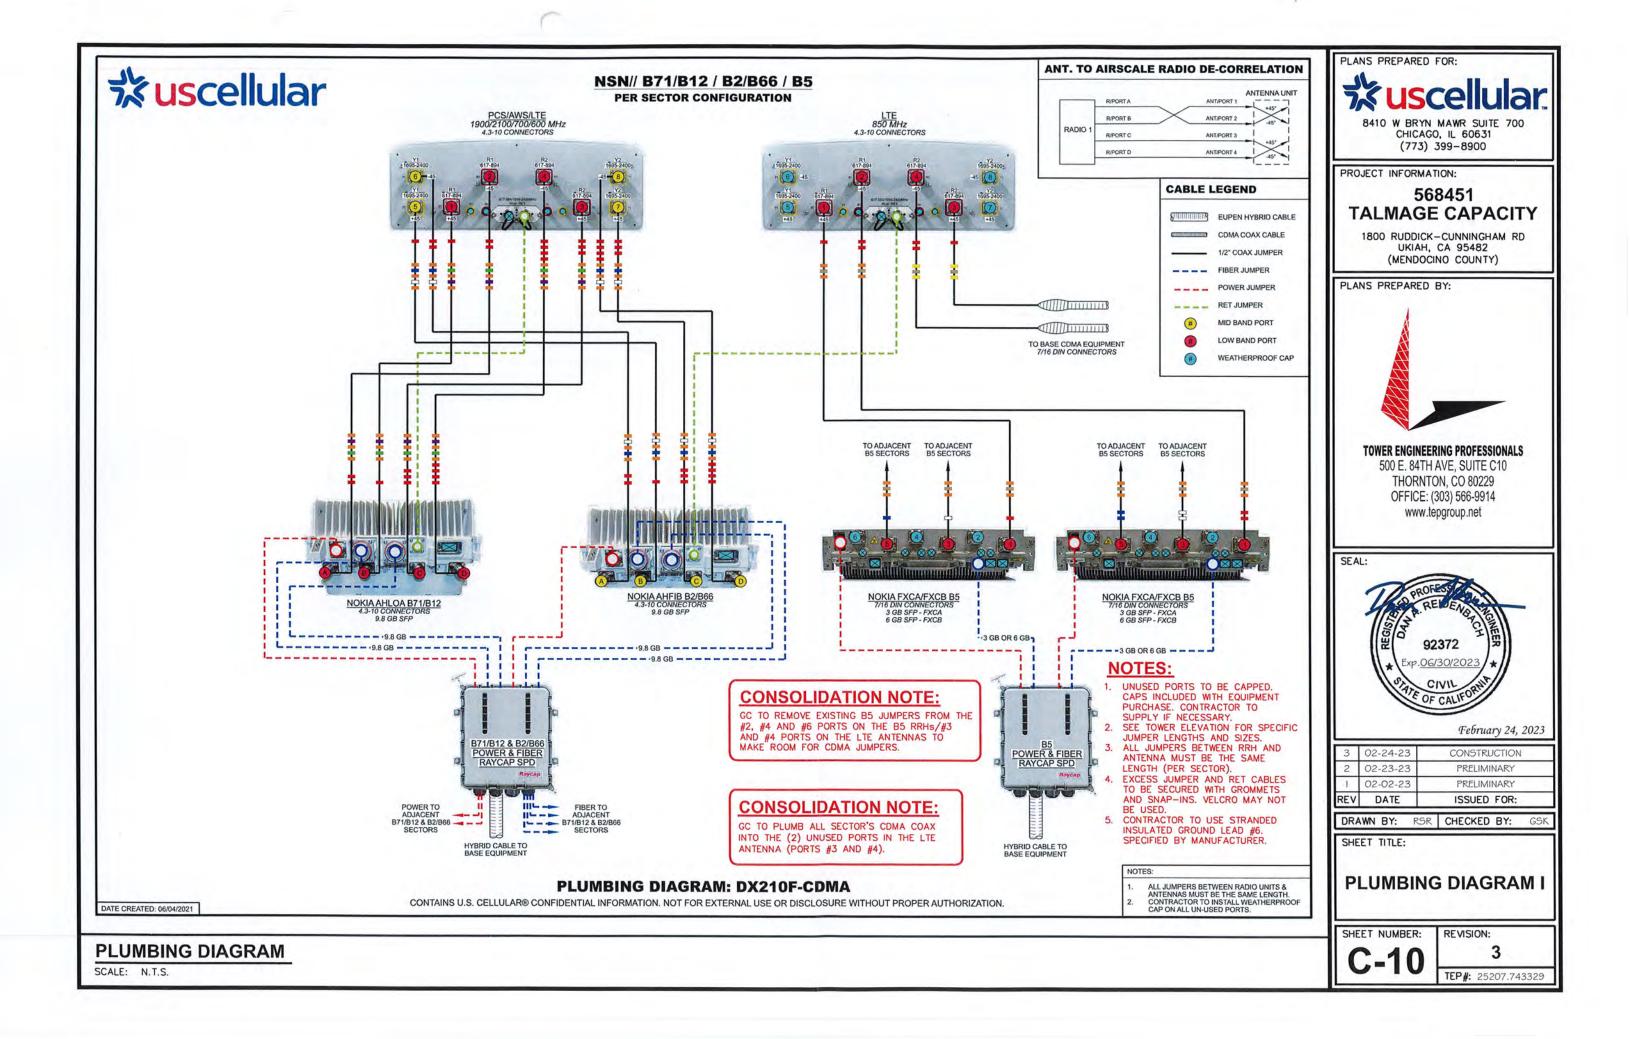


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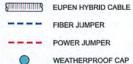
#### NOTES:

- UNUSED PORTS TO BE CAPPED, CAPS INCLUDED WITH EQUIPMENT PURCHASE, CONTRACTOR TO SUPPLY IF NECESSARY.
- SEE TOWER ELEVATION FOR SPECIFIC JUMPER LENGTHS AND SIZES.
- 3. ALL JUMPERS BETWEEN RRH AND ANTENNA MUST BE THE SAME LENGTH (PER SECTOR).
- 4. EXCESS JUMPER AND RET CABLES TO BE SECURED WITH GROMMETS AND SNAP-INS. VELCRO MAY NOT BE
- 5. CONTRACTOR TO USE STRANDED INSULATED GROUND LEAD #6. SPECIFIED BY MANUFACTURER.

#### NSN// C-BAND & DoD WITH DEDICATED RAYCAP SPD PER SECTOR CONFIGURATION

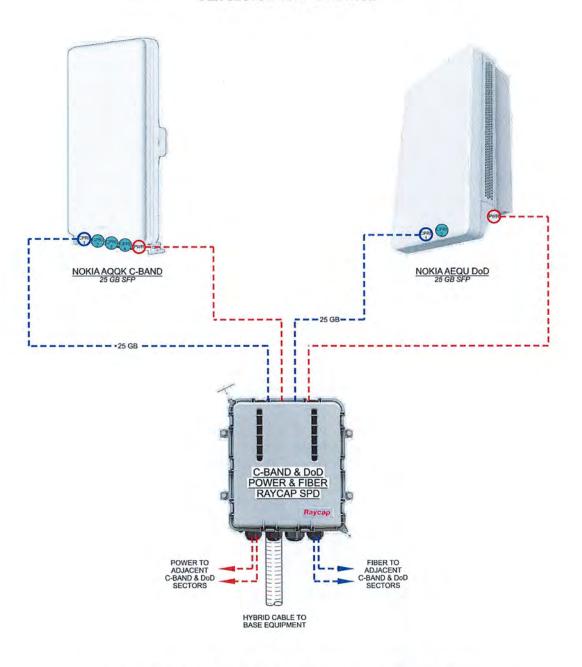

#### CABLE LEGEND



PLUMBING DIAGRAM: NOKIA C-BAND & DoD

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#### PLUMBING DIAGRAM

SCALE: N.T.S.

# USCEllular

10 W BRYN MAWR SUITE 700 CHICAGO, IL 60631 (773) 399-8900

PROJECT INFORMATION:

#### 568451 TALMAGE CAPACITY

1800 RUDDICK-CUNNINGHAM RD UKIAH, CA 95482 (MENDOCINO COUNTY)

PLANS PREPARED BY:



#### **TOWER ENGINEERING PROFESSIONALS**

500 E. 84TH AVE, SUITE C10 THORNTON, CO 80229 OFFICE: (303) 566-9914 www.tepgroup.net

SEAL:



February 24, 2023

REV	DATE	ISSUED FOR:
.1	02-02-23	PRELIMINARY
2	02-23-23	PRELIMINARY
3 02-24-23		CONSTRUCTION

DRAWN BY: RSR CHECKED BY: GSK


SHEET TITLE:

PLUMBING DIAGRAM II

SHEET NUMBER:

C-11

REVISION:

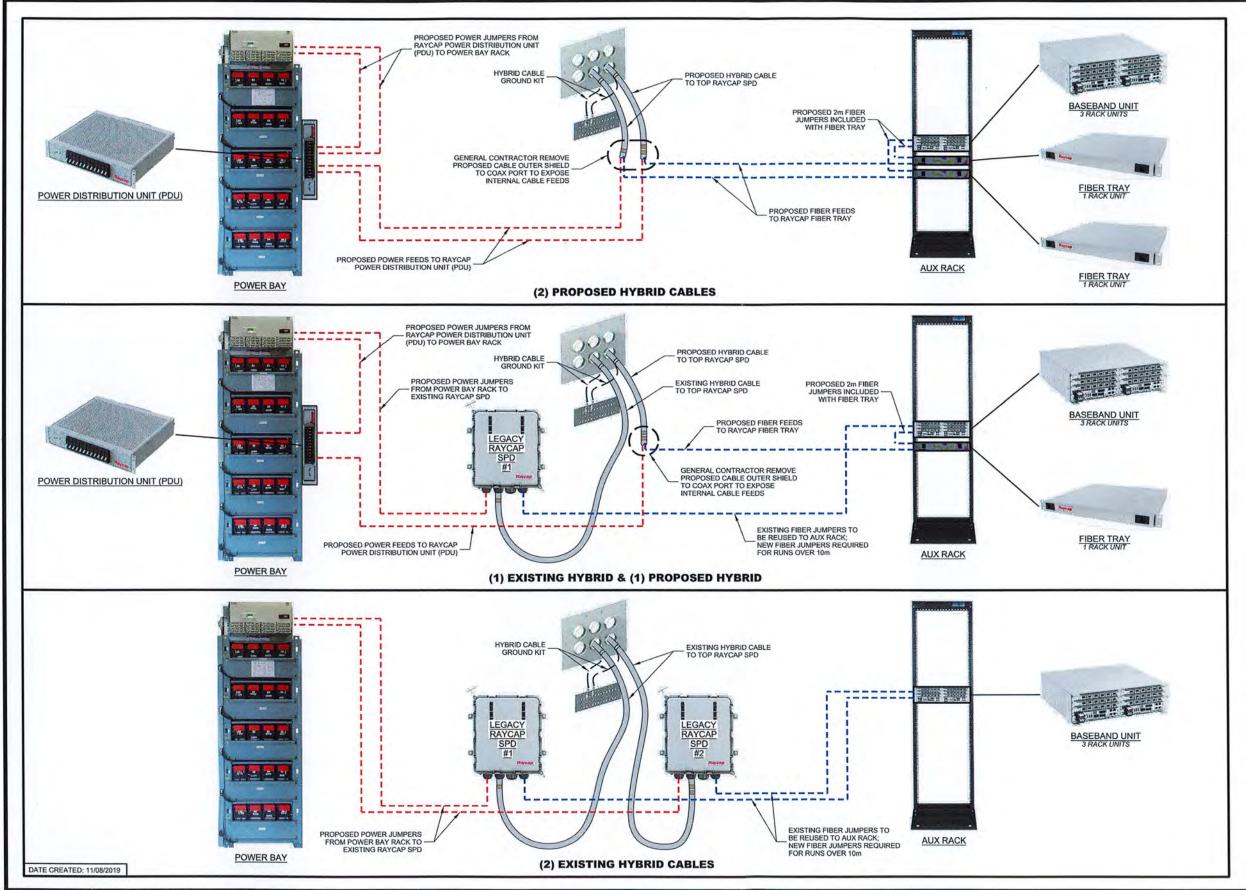

SHELTER BLOCK DIAGRAM

SCALE: N.T.S.

# PLANS PREPARED FOR: USCEllular

0 W BRYN MAWR SUITE 700 CHICAGO, IL 60631 (773) 399-8900

PROJECT INFORMATION:

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DRAWN BY: RSR CHECKED BY: GS

SHEET TITLE:

SHELTER BLOCK DIAGRAM

SHEET NUMBER:

C-12


REVISION:

#### NOTE:

KIT INCLUDES:

- (8) M8-1.25x20mm HEX BOLTS
- (4) M10-1.50x150mm SOCKET HEAD SCREWS W/ATTACHED FLAT WASHERS
- (1) M10-1.50x300mm PARTIALLY THREADED SOCKET HEAD SCREW



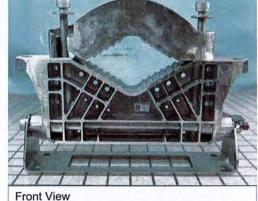

**UPPER MOUNTING BRACKET** 

LOWER MOUNTING BRACKET

#### **SXK 109 2065/1 MOUNTING KIT**

SCALE: N.T.S.

#### **AIRSCALE MAA DIMENSIONS**

MODEL	HEIGHT (H) x WIDTH (W) x DEPTH (D)	
AEQU (1H2022) 64T64R	750 x 450 x 240 mm	

AIRSCALE MAA & MOUNTING KIT WEIGHT				
MODEL	TYPE	WEIGHT		
AEQU (1H2022) 64T64R	ANTENNA/RADIO	45 kg		
AMPF	MOUNTING KIT	6.5 kg		



#### **NOKIA AEUQ DoD RRH W/ INTEGRATED ANTENNA**

SCALE: N.T.S.

#### **AIRSCALE MAA DIMENSIONS**

MODEL	HEIGHT (H) x WIDTH (W) x DEPTH (D)		
AQQK (1H2022) 64T64R	1001 x 448 x 113 mm		

#### **AIRSCALE MAA & MOUNTING KIT WEIGHT**

MODEL	TYPE	WEIGHT	
AQQK (1H2022) 64T64R	ANTENNA/RADIO	36 kg	
AMPF	MOUNTING KIT	6.5 kg	




#### **NOKIA AQQK CBAND RRH W/ INTEGRATED ANTENNA**

SCALE: N.T.S.

NOTE:

GC TO ALIGN T/CBAND WITH T/LTE ANTENNAS AND B/DOD WITH B/LTE ANTENNAS TO MAXIMIZE THE DISTANCE BETWEEN CBAND AND DoD.

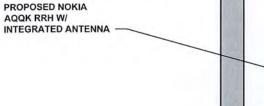

MANUFACTURER SUPPLIED ANTENNA MOUNTING BRACKETS (NOKIA AMFP)

PROPOSED MOUNT PIPE

PROPOSED NOKIA AEQU RRH W/ INTEGRATED ANTENNA

**ANTENNA MOUNTING DETAILS** 

SCALE: N.T.S.

# PLANS PREPARED FOR:

CHICAGO, IL 60631 (773) 399-8900

PROJECT INFORMATION:

#### 568451 **TALMAGE CAPACITY**

1800 RUDDICK-CUNNINGHAM RD UKIAH, CA 95482 (MENDOCINO COUNTY)

PLANS PREPARED BY:



#### **TOWER ENGINEERING PROFESSIONALS**

500 E. 84TH AVE, SUITE C10 THORNTON, CO 80229 OFFICE: (303) 566-9914 www.tepgroup.net

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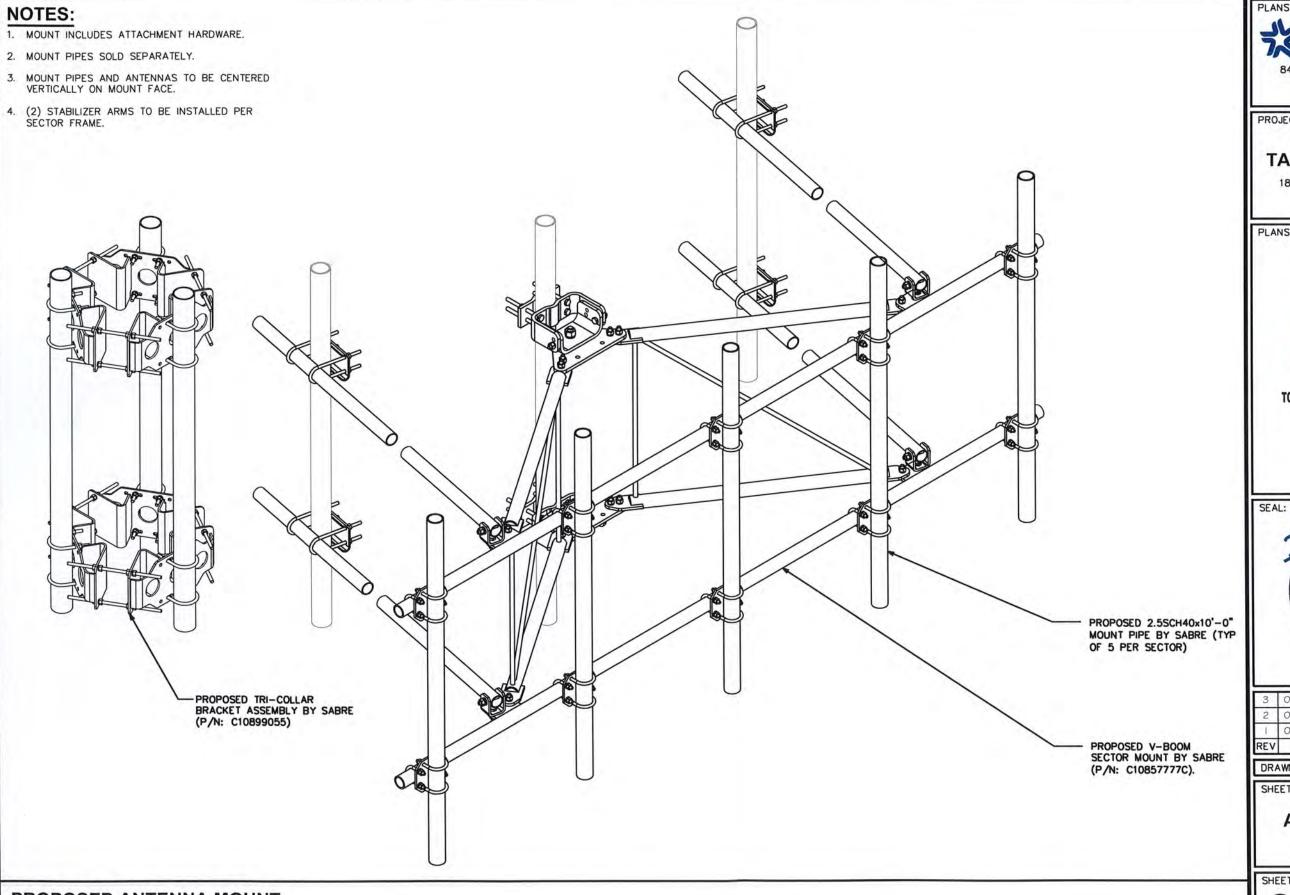
DRAWN BY: RSR CHECKED BY: GSI

SHEET TITLE:

C-BAND AND DOD **SPECIFICATIONS** 

SHEET NUMBER:

REVISION:



PLANS PREPARED FOR:

USCEllular

8410 W BRYN MAWR SUITE 700 CHICAGO, IL 60631 (773) 399-8900

PROJECT INFORMATION:

#### 568451 TALMAGE CAPACITY

1800 RUDDICK-CUNNINGHAM RD UKIAH, CA 95482 (MENDOCINO COUNTY)

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DRAWN BY: RSR CHECKED BY: GSK

SHEET TITLE

ANTENNA MOUNT SPEC SHEET

SHEET NUMBER:

C-14


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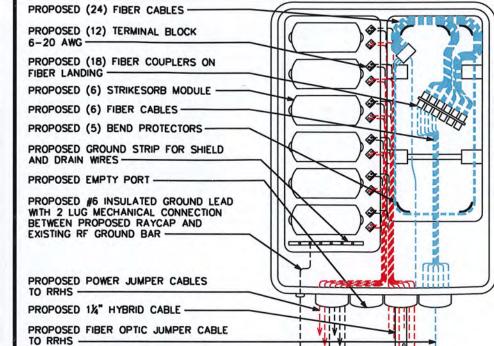
REVISION:

TEP#: 25207.743329

PROPOSED ANTENNA MOUNT





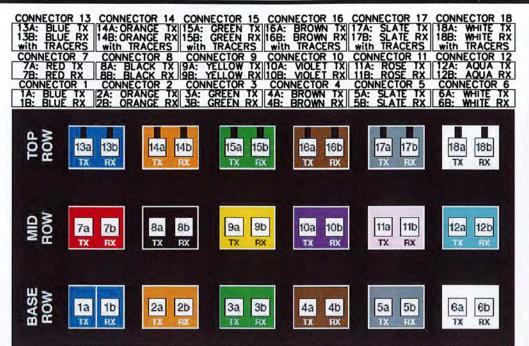

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CHICAGO, IL 60631 (773) 399-8900

PROJECT INFORMATION:

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DRAWN BY: RSR CHECKED BY: GSK

SHEET TITLE:

FIBER AND COAX LABELLING STANDARDS I

SHEET NUMBER:


REVISION:

TEP#: 25207.743329

#### FIBER CABLE LABELING


RAYCAP CABLING

SCALE: N.T.S.

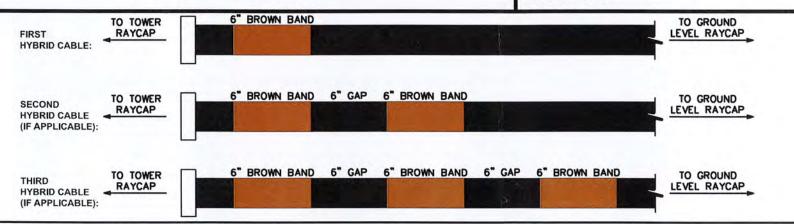

#### **HYBRID CABLE BANDING**

SCALE: N.T.S.

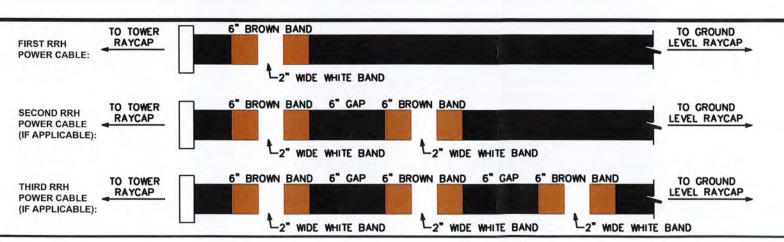

#### **POWER CABLE BANDING**

Sector Band Assignments (Most Common Case: Single Technology within the Sector)						
Sector Band	Assigned Color	Line 1	Line 2	Line 3	Line 4	
Alpha (Sector 1)	ned	1 red band	2 red bands	3 red bands	4 red bands	
Beta (Sector 2)	white	1 white band	2 white bands	3 white bands	4 white bands	
Gamma (Sector 3)	blue	1 blue band	2 blue bands	3 blue bands	4 blue bands	
Delta (Sector 4, if applicable)	green	1 green band	2 green bands	3 green bands	4 green bands	
Epsilon (Sector 5, if applicable)	violet	1 violet band	2 violet bands	3 violet bands	4 violet bands	
Zeta (Sector 6, if applicable)	brown	1 brown band	2 brown bands	3 brown bands	4 brown bands	

FREQUENCY	BAND

FREQUENCY BAND	
GREEN	
BROWN	
BLUE	
WHITE	
GREY	
VIOLET	
RED	

# PLANS PREPARED FOR:

CHICAGO, IL 60631 (773) 399-8900

PROJECT INFORMATION:

#### 568451 **TALMAGE CAPACITY**

1800 RUDDICK-CUNNINGHAM RD UKIAH, CA 95482 (MENDOCINO COUNTY)



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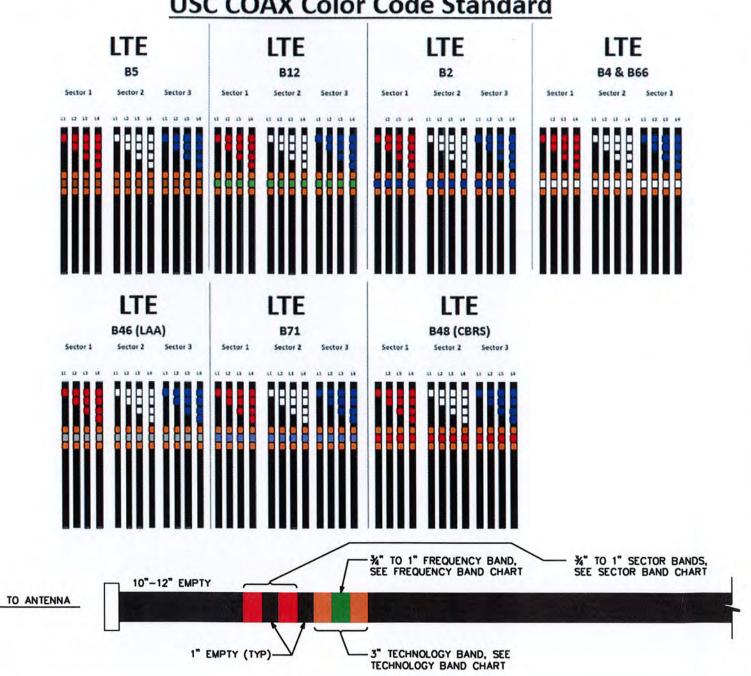
**FIBER AND COAX** LABELLING **STANDARDS II** 

SHEET NUMBER:


REVISION:

TEP#: 25207.743329

#### **USC COAX Color Code Standard**



#### **RET SECTOR BAND** LINE 1 - FIRST **LINE 2 - FIRST SECTOR TECHNOLOGY TECHNOLOGY** (2) RED BAND (1) RED BAND ALPHA BETA (1) WHITE BAND (2) WHITE BAND GAMMA (1) BLUE BAND (2) BLUE BAND

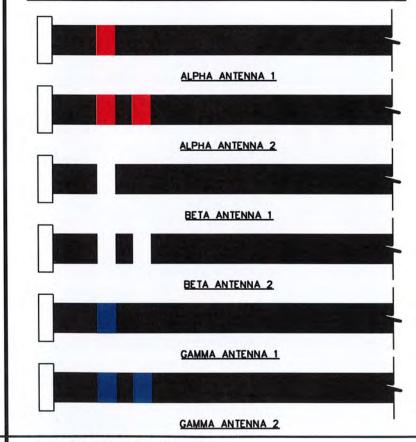

#### **COAX CABLE BANDING**

SCALE: N.T.S.

#### **RET CABLE BANDING**

#### **GENERAL NOTES:**

- ALL REFERENCES TO OWNER IN THESE DOCUMENTS SHALL BE CONSIDERED U.S. CELLULAR OR IT'S DESIGNATED REPRESENTATIVE.
- 2. ALL WORK PRESENTED ON THESE DRAWINGS MUST BE COMPLETED BY THE CONTRACTOR UNLESS NOTED OTHERWISE. THE CONTRACTOR MUST HAVE CONSIDERABLE EXPERIENCE IN PERFORMANCE OF WORK SIMILAR TO THAT DESCRIBED HEREIN. BY ACCEPTANCE OF THIS ASSIGNMENT, THE CONTRACTOR IS ATTESTING THAT HE DOES HAVE SUFFICIENT EXPERIENCE AND ABILITY, THAT HE IS KNOWLEDGEABLE OF THE WORK TO BE PERFORMED AND THAT HE IS PROPERLY LICENSED AND PROPERLY REGISTERED TO DO THIS WORK IN THE STATE OF CALIFORNIA.
- STRUCTURE IS DESIGNED IN ACCORDANCE WITH ANSI/TIA-222-H, AND THE REQUIREMENTS OF THE CALIFORNIA BUILDING CODE, 2022 EDITION.
- 4. WORK SHALL BE COMPLETED IN ACCORDANCE WITH THE CALIFORNIA BUILDING CODE, 2022 EDITION.
- 5. UNLESS SHOWN OR NOTED OTHERWISE ON THE CONTRACT DRAWINGS, OR IN THE SPECIFICATIONS, THE FOLLOWING NOTES SHALL APPLY TO THE MATERIALS LISTED HEREIN, AND TO THE PROCEDURES TO BE USED ON THIS PROJECT.
- ALL HARDWARE ASSEMBLY MANUFACTURER'S INSTRUCTIONS SHALL BE FOLLOWED EXACTLY AND SHALL SUPERCEDE ANY CONFLICTING NOTES ENCLOSED HEREIN.
- 7. IT IS THE CONTRACTOR'S SOLE RESPONSIBILITY TO DETERMINE ERECTION PROCEDURE AND SEQUENCE TO INSURE THE SAFETY OF THE STRUCTURE AND IT'S COMPONENT PARTS DURING ERECTION AND/OR FIELD MODIFICATIONS. THIS INCLUDES, BUT IS NOT LIMITED TO, THE ADDITION OF TEMPORARY BRACING, GUYS OR TIE DOWNS THAT MAY BE NECESSARY. SUCH MATERIAL SHALL BE REMOVED AND SHALL REMAIN THE PROPERTY OF THE CONTRACTOR AFTER THE COMPLETION OF THE PROJECT.
- 8. ALL DIMENSIONS, ELEVATIONS, AND EXISTING CONDITIONS SHOWN ON THE DRAWINGS SHALL BE FIELD VERIFIED BY THE CONTRACTOR PRIOR TO BEGINNING ANY MATERIALS ORDERING, FABRICATION OR CONSTRUCTION WORK ON THIS PROJECT. CONTRACTOR SHALL NOT SCALE CONTRACT DRAWINGS IN LIEU OF FIELD VERIFICATIONS. ANY DISCREPANCIES SHALL BE IMMEDIATELY BROUGHT TO THE ATTENTION OF THE OWNER AND THE OWNER'S ENGINEER. THE DISCREPANCIES MUST BE RESOLVED BEFORE THE CONTRACTOR IS TO PROCEED WITH THE WORK. THE OWNER SHALL HAVE A SET OF APPROVED. PLANS AVAILABLE AT THE SITE AT ALL TIMES WHILE WORK IS BEING PERFORMED. A DESIGNATED RESPONSIBLE EMPLOYEE SHALL BE AVAILABLE FOR CONTACT BY GOVERNING AGENCY INSPECTORS. THE CONTRACT DOCUMENTS DO NOT INDICATE THE METHOD OF CONSTRUCTION. THE CONTRACTOR SHALL SUPERVISES AND DIRECT THE WORK AND SHALL BE SOLELY RESPONSIBLE FOR ALL CONSTRUCTION MEANS, METHODS, TECHNIQUES, SEQUENCES, AND PROCEDURES. OBSERVATION VISITS TO THE SITE BY THE OWNER AND/OR THE ENGINEER SHALL NOT INCLUDE INSPECTION OF THE PROTECTIVE MEASURES OR THE PROCEDURES.
- 9. ALL MATERIALS AND EQUIPMENT FURNISHED SHALL BE NEW AND OF GOOD QUALITY, FREE FROM FAULTS AND DEFECTS AND IN CONFORMANCE WITH THE CONTRACT DOCUMENTS. ANY AND ALL SUBSTITUTIONS MUST BE PROPERLY APPROVED AND AUTHORIZED IN WRITING BY THE OWNER AND ENGINEER PRIOR TO INSTALLATION. THE CONTRACTOR SHALL FURNISH SATISFACTORY EVIDENCE AS TO THE KIND AND QUALITY OF THE MATERIALS AND EQUIPMENT BEING SUBSTITUTED.
- 10. THE CONTRACTOR SHALL BE RESPONSIBLE FOR INITIATING, MAINTAINING, AND SUPERVISING ALL SAFETY PRECAUTIONS AND PROGRAMS IN CONNECTION WITH THE WORK. THE CONTRACTOR IS RESPONSIBLE FOR INSURING THAT THIS PROJECT AND RELATED WORK COMPLIES WITH ALL APPLICABLE LOCAL, STATE, AND FEDERAL SAFETY CODES AND REGULATIONS GOVERNING THIS WORK.
- 11. ACCESS TO THE PROPOSED WORK SITE MAY BE RESTRICTED. THE CONTRACTOR SHALL COORDINATE INTENDED CONSTRUCTION ACTIVITY, INCLUDING WORK SCHEDULE AND MATERIALS ACCESS, WITH THE RESIDENT LEASING AGENT FOR APPROVAL.
- 12. BILL OF MATERIALS AND PART NUMBERS LISTED ON CONSTRUCTION DRAWINGS ARE INTENDED TO AID CONTRACTOR. CONTRACTOR SHALL VERIFY PARTS AND QUANTITIES WITH MANUFACTURER PRIOR TO BIDDING AND/OR ORDERING MATERIALS.
- 13. ALL PERMITS THAT MUST BE OBTAINED ARE THE RESPONSIBILITY OF THE CONTRACTOR. THE CONTRACTOR WILL BE RESPONSIBLE FOR ABIDING BY ALL CONDITIONS AND REQUIREMENTS OF THE PERMITS.
- 14. 24 HOURS PRIOR TO THE BEGINNING OF ANY CONSTRUCTION, THE CONTRACTOR MUST NOTIFY THE APPLICABLE JURISDICTIONAL (STATE, COUNTY OR CITY) ENGINEER.
- 15. THE CONTRACTOR SHALL REWORK (DRY, SCARIFY, ETC.) ALL MATERIAL NOT SUITABLE FOR SUBGRADE IN IT PRESENT STATE. AFTER REWORKING, IF THE MATERIAL REMAINS UNSUITABLE, THE CONTRACTOR SHALL UNDERCUT THIS MATERIAL AND REPLACE WITH APPROVED MATERIAL. ALL SUBGRADES SHALL BE PROOFROLLED WITH A FULLY LOADED TANDEM AXLE DUMP TRUCK PRIOR TO PAVING. ANY SOFTER MATERIAL SHALL BE REWORKED OR REPLACED.

#### STRUCTURAL STEEL NOTES:


- THE FABRICATION AND ERECTION OF STRUCTURAL STEEL SHALL CONFORM TO THE AISC SPECIFICATIONS AND MANUAL OF STEEL CONSTRUCTION, 15TH EDITION.
- 2. UNLESS OTHERWISE NOTED, ALL STRUCTURAL ELEMENTS SHALL CONFORM TO THE FOLLOWING REQUIREMENTS:

A. STRUCTURAL STEEL, ASTM DESIGNATION A36 OR GR50.

- B. ALL BOLTS, ASTM A325 TYPE I GALVANIZED HIGH STRENGTH BOLTS.
- C. ALL NUTS, ASTM A563 CARBON AND ALLOY STEEL NUTS.
  D. ALL WASHERS, ASTM F436 HARDENED STEEL WASHERS.
- o, her monera, norm rico mindenes orece monero.
- ALL CONNECTIONS NOT FULLY DETAILED ON THESE PLANS SHALL BE DETAILED BY THE STEEL FABRICATOR
  IN ACCORDANCE WITH AISC SPECIFICATIONS AND MANUAL OF STEEL CONSTRUCTION, 15TH EDITION.
- 4. HOLES SHALL NOT BE FLAME CUT THRU STEEL UNLESS APPROVED BY THE ENGINEER
- HOT-DIP GALVANIZE ALL ITEMS UNLESS OTHERWISE NOTED, AFTER FABRICATION WHERE PRACTICABLE. GALVANIZING: ASTM A123, ASTM, A153/A153M OR ASTM A653/A653M, G90, AS APPLICABLE.
- 6. REPAIR DAMAGED SURFACES WITH GALVANIZING REPAIR METHOD AND PAINT CONFORMING TO ASTM A780 OR BY APPLICATION OF STICK OR THICK PASTED MATERIAL SPECIFICALLY DESIGNED FOR REPAIR OF GALVANIZING, CLEAN AREAS TO BE REPAIRED AND REMOVE SLAG FROM WELDS. HEAT SURFACES TO WHICH STICK OR PASTE MATERIAL IS APPLIED, WITH A TORCH TO A TEMPERATURE SUFFICIENT TO MELT THE METALLICS IN STICK OR PASTED; SPREAD MOLTEN MATERIAL UNIFORMLY OVER SURFACES TO BE COATED AND WIPE OFF EXCESS MATERIAL.
- 7. A NUT LOCKING DEVICE SHALL BE INSTALLED ON ALL PROPOSED AND/OR REPLACED BOLTS.
- 8. ALL PROPOSED AN/OR REPLACED BOLTS SHALL BE OF SUFFICIENT LENGTH TO EXCLUDE THE THREADS FROM THE SHEAR PLANE.
- ALL PROPOSED AND/OR REPLACED BOLTS SHALL BE OF SUFFICIENT LENGTH SUCH THAT THE END OF THE BOLT BE AT LEAST FLUSH WITH THE FACE OF THE NUT. IT IS NOT PERMITTED FOR THE BOLT END TO BE BELOW THE FACE OF THE NUT AFTER TIGHTENING IS COMPLETED.
- 10. ALL ASSEMBLY AND ANCHOR BOLTS ARE TO BE TIGHTENED TO A "SNUG TIGHT" CONDITION AS DEFINED IN SECTION 8.1 OF THE AISC, "SPECIFICATION FOR STRUCTURAL JOINTS USING ASTM A325 OR A490 BOLTS", DATED JUNE 30, 2004.
- 11. FLAT WASHERS ARE TO BE INSTALLED WITH BOLTS OVER SLOTTED HOLES.
- 12. DO NOT OVER TORQUE ASSEMBLY BOLTS. GALVANIZING ON BOLTS, NUTS, AND STEEL PARTS ; MAY ACT AS A LUBRICANT, THUS OVER TIGHTENING MAY OCCUR AND MAY CAUSE BOLTS TO CRACK AND SNAP OFF.
- 13. PAL NUTS ARE TO BE INSTALLED AFTER NUTS ARE TIGHT AND WITH EDGE LIP OUT. PAL NUTS ARE NOT REQUIRED WHEN SELF-LOCKING NUTS ARE PROVIDED.
- 14. GALVANIZED ASTM A325 BOLTS SHALL NOT BE REUSED.
- 15. ALL WELDING SHALL BE IN ACCORDANCE WITH THE AWS D1.1:2020, STRUCTURAL WELDING CODE-REINFORCING STEEL. ALL WELDERS SHALL DISPLAY PROPER CERTIFICATION OF QUALIFICATION.

#### **GROUNDING NOTES:**

- ALL CADWELD CONNECTIONS TO GALVANIZED MATERIAL SHALL BE PROPERLY PREPARED TO ASSURE A SATISFACTORY CADWELD.
- 2. CADWELD CONNECTION SHALL BE COATED WITH COLD GALVANIZING SPRAY.
- 3. ALL VERTICAL JUMPERS SHALL NOT BE WELDED WITHIN TWO FT OF THE GROUND ROD.
- 4. SECTOR GROUNDING DIAGRAM:

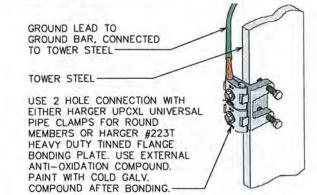



CHICAGO, IL 60631 (773) 399-8900

PROJECT INFORMATION:

#### 568451 TALMAGE CAPACITY

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PLANS PREPARED BY:



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**GENERAL NOTES** 


SHEET NUMBER:

N-1

REVISION:

TEP#: 25207.743329

February 24, 2023

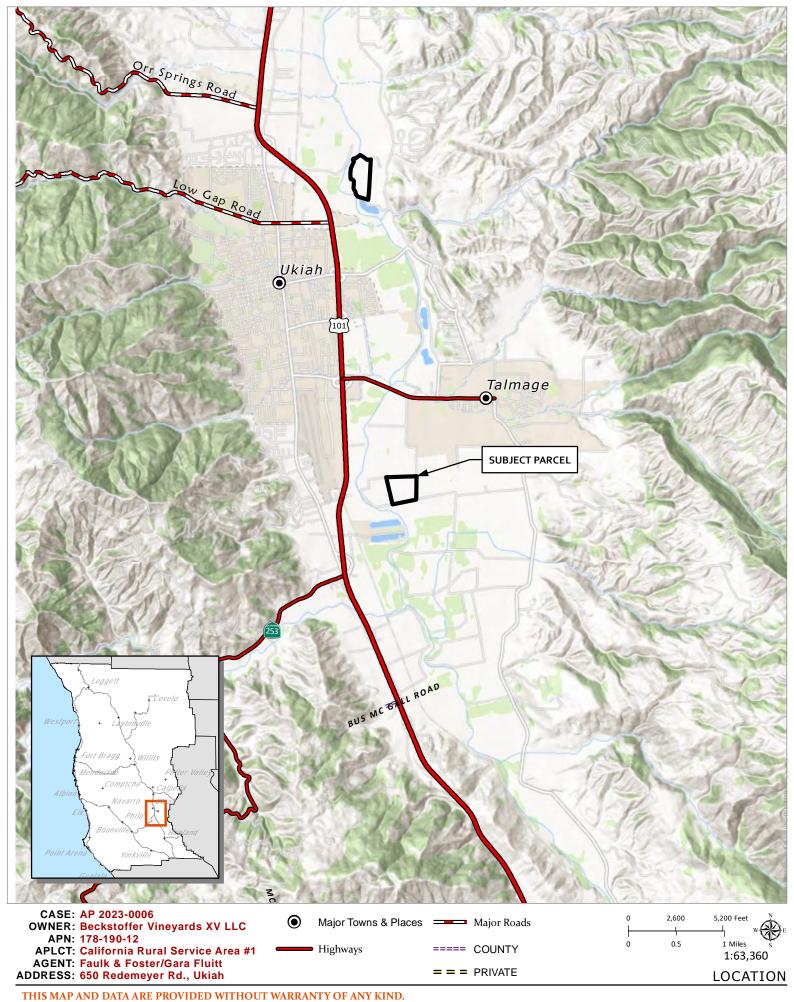



CASE: AP 2023-0008


**OWNER: Ruddick Ranch Incorporated** 

APN: 183-030-02

APLCT: California Rural Service Area #1
AGENT: Faulk & Foster/Gara Fluitt
ADDRESS: 1800 Ruddick Cunningham Rd., Talmage

Approved Wireless Sites

Public Roads

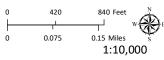

**AERIAL IMAGERY** 




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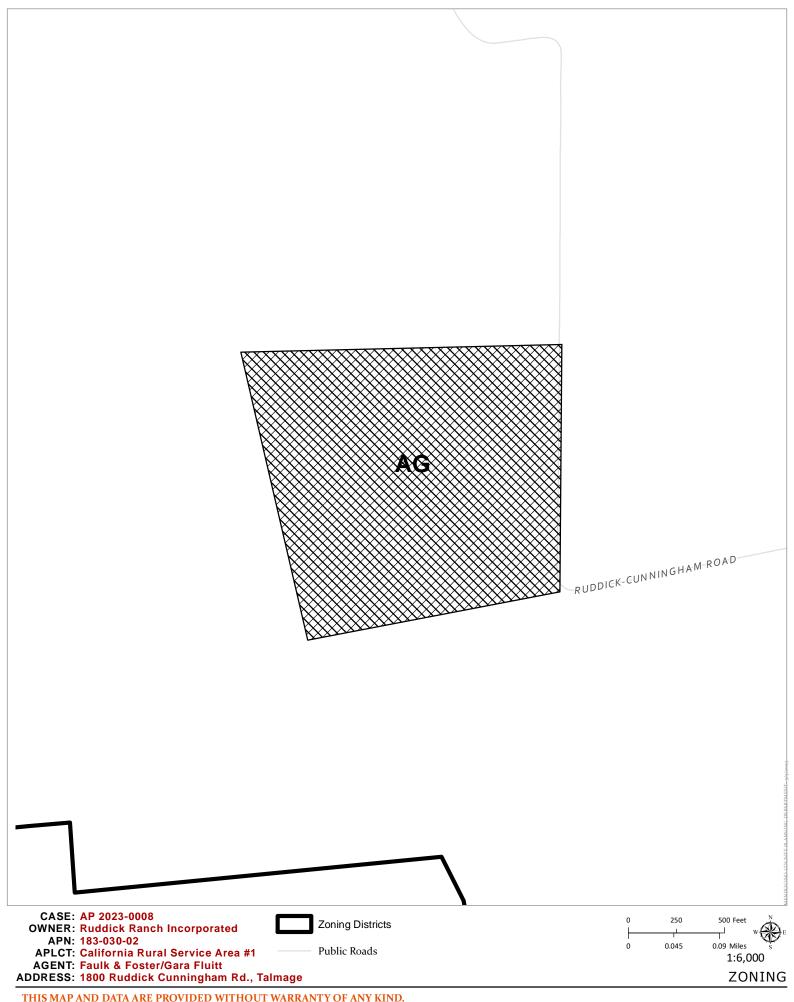
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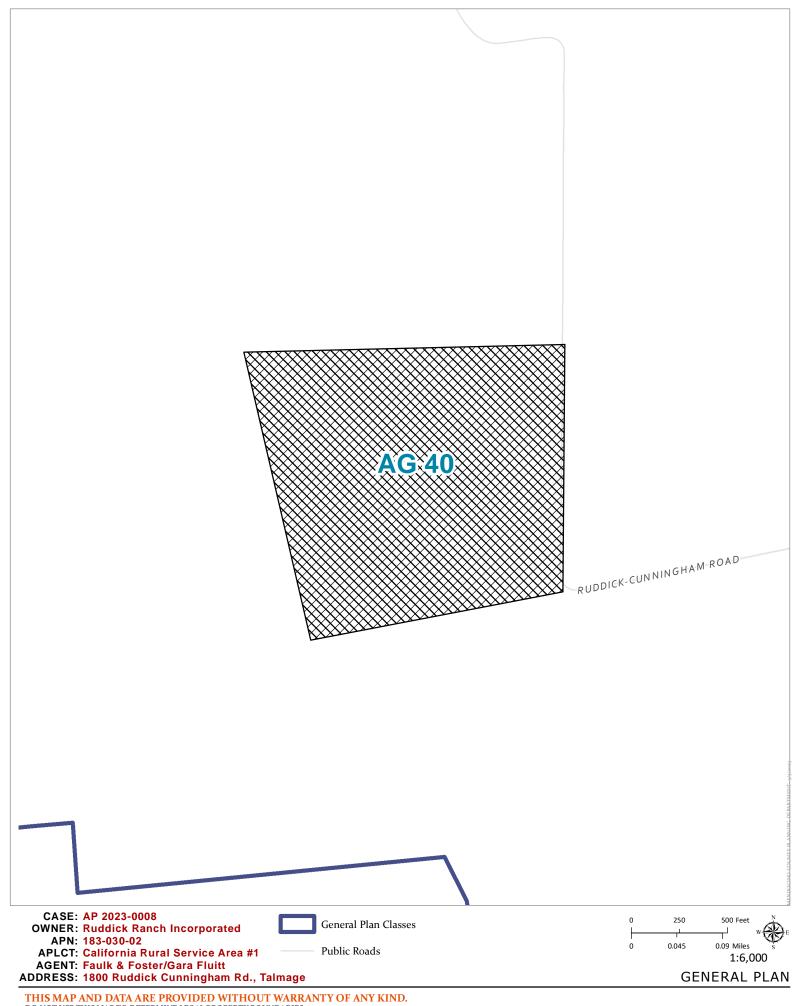
Public Roads

Approved Wireless Sites





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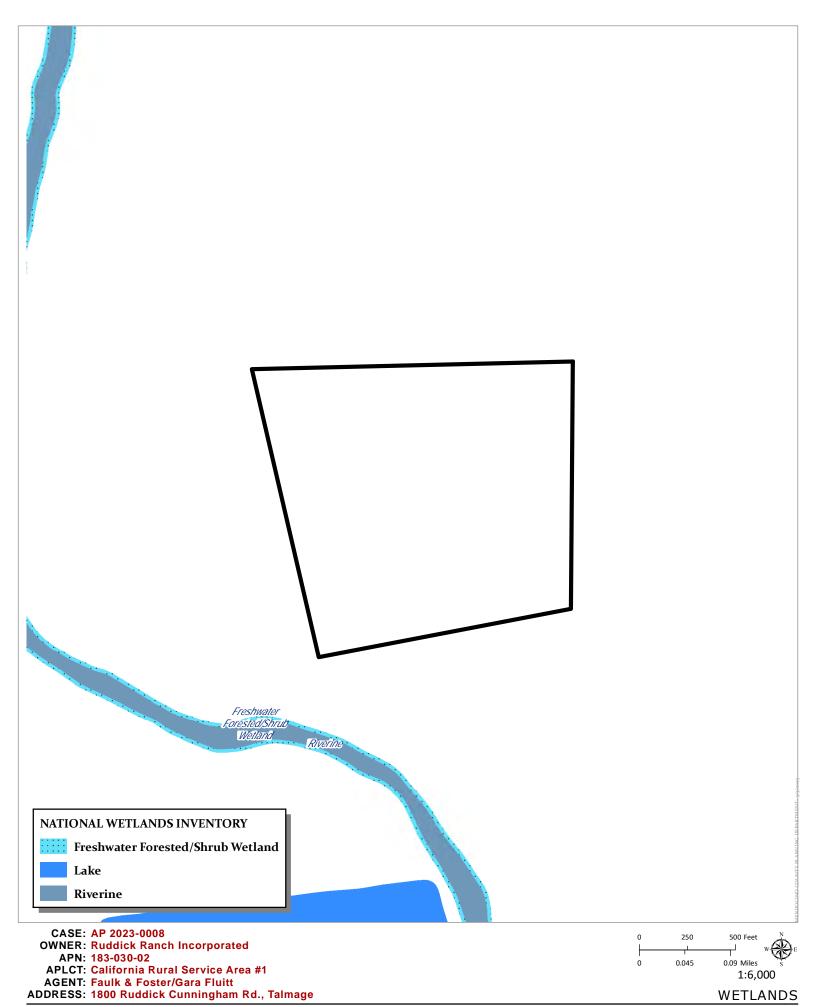





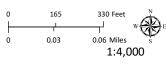




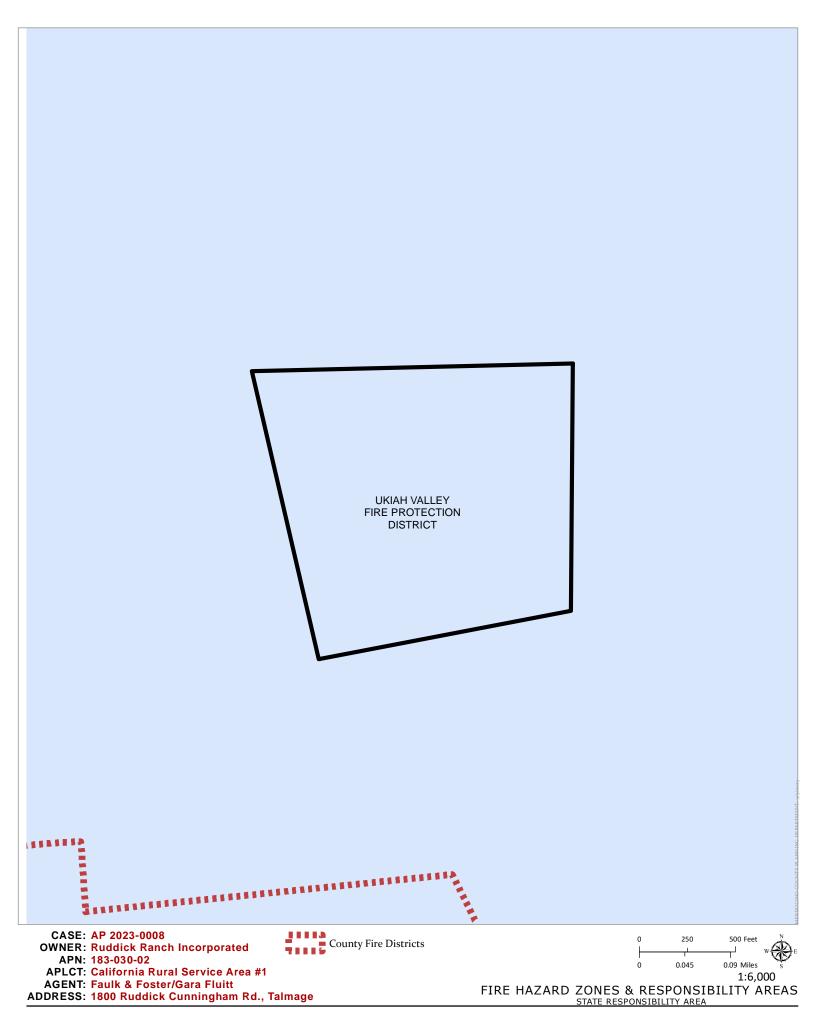

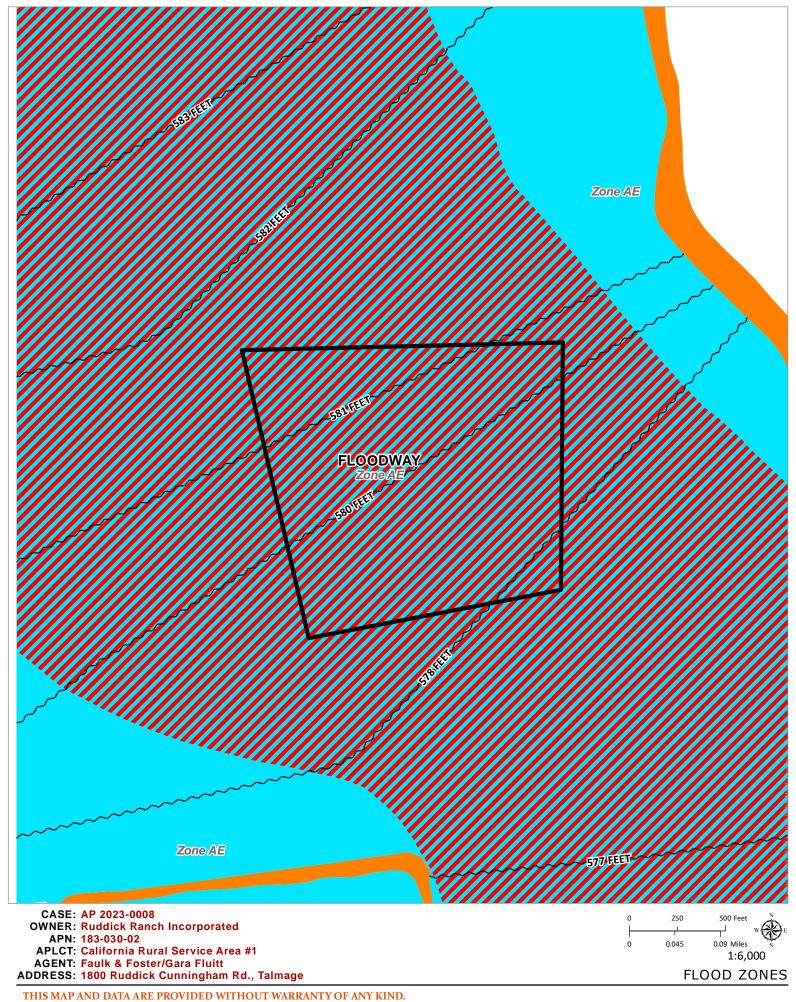

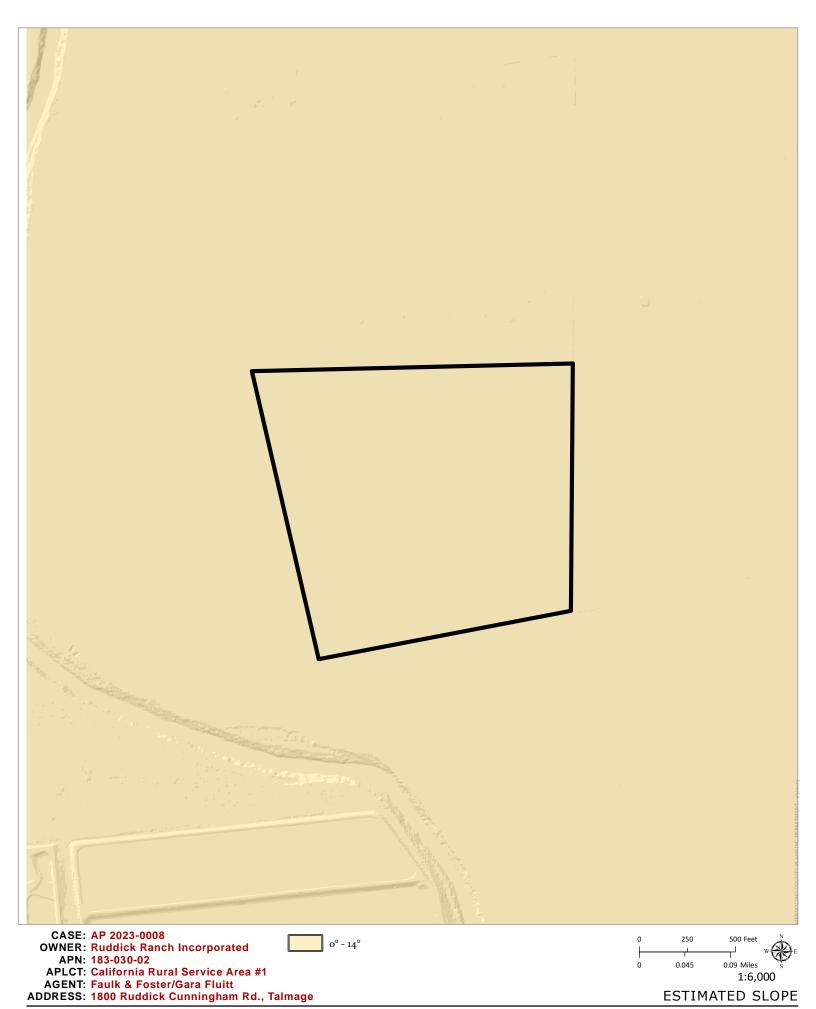


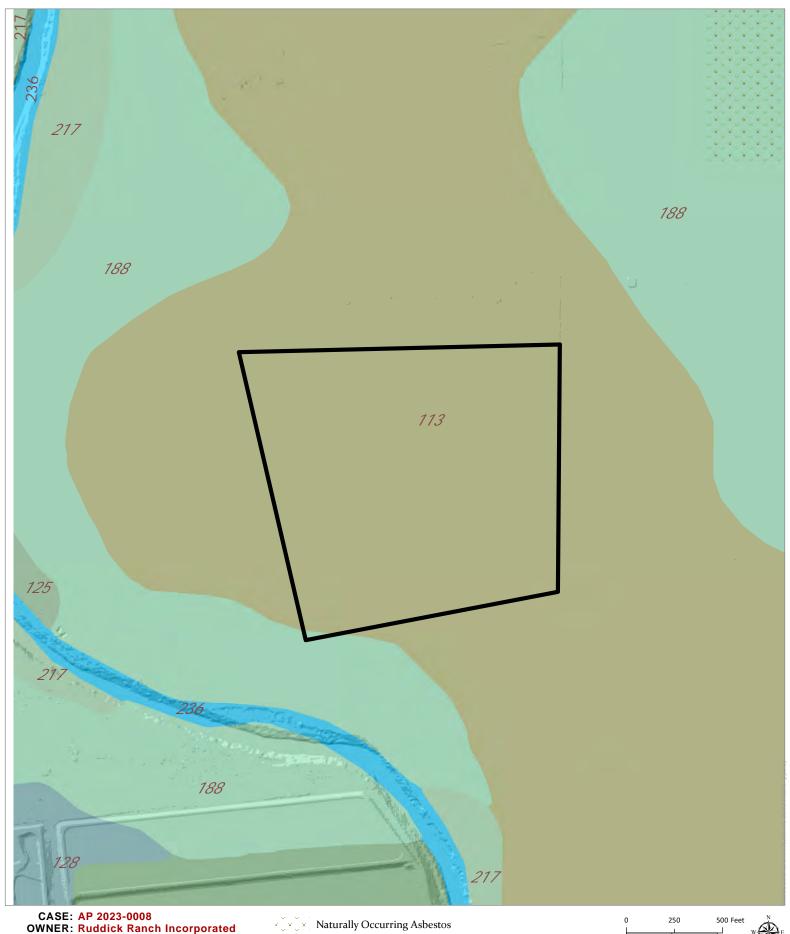

APLCT: California Rural Service Area #1 AGENT: Faulk & Foster/Gara Fluitt ADDRESS: 1800 Ruddick Cunningham Rd., Talmage

APN: 183-030-02

0.045 0.09 Miles 1:6,000

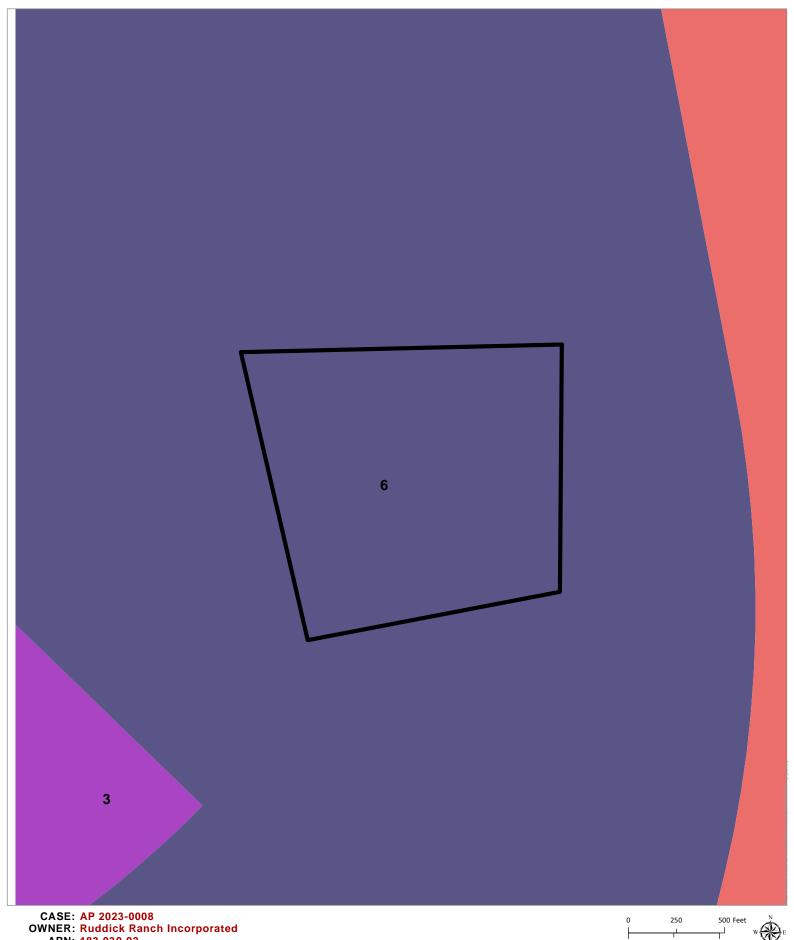


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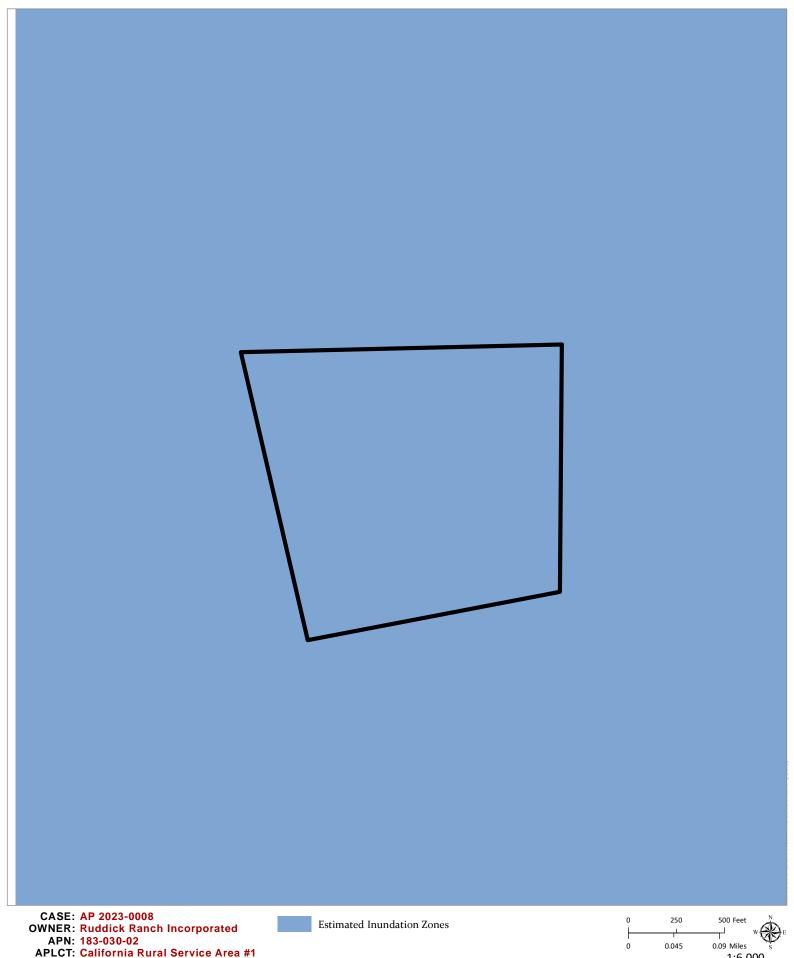
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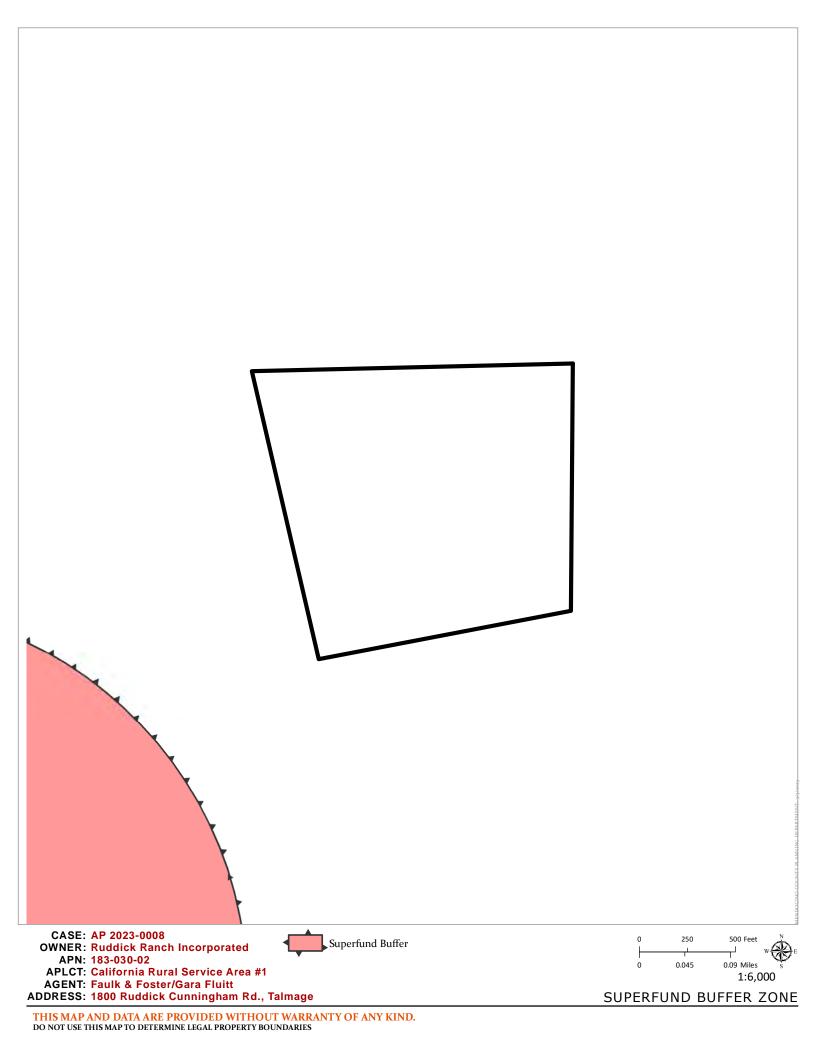
**UKIAH AIRPORT ZONES** 






AGENT: Faulk & Foster/Gara Fluitt ADDRESS: 1800 Ruddick Cunningham Rd., Talmage 1:6,000

DAM INUNDATION ZONE

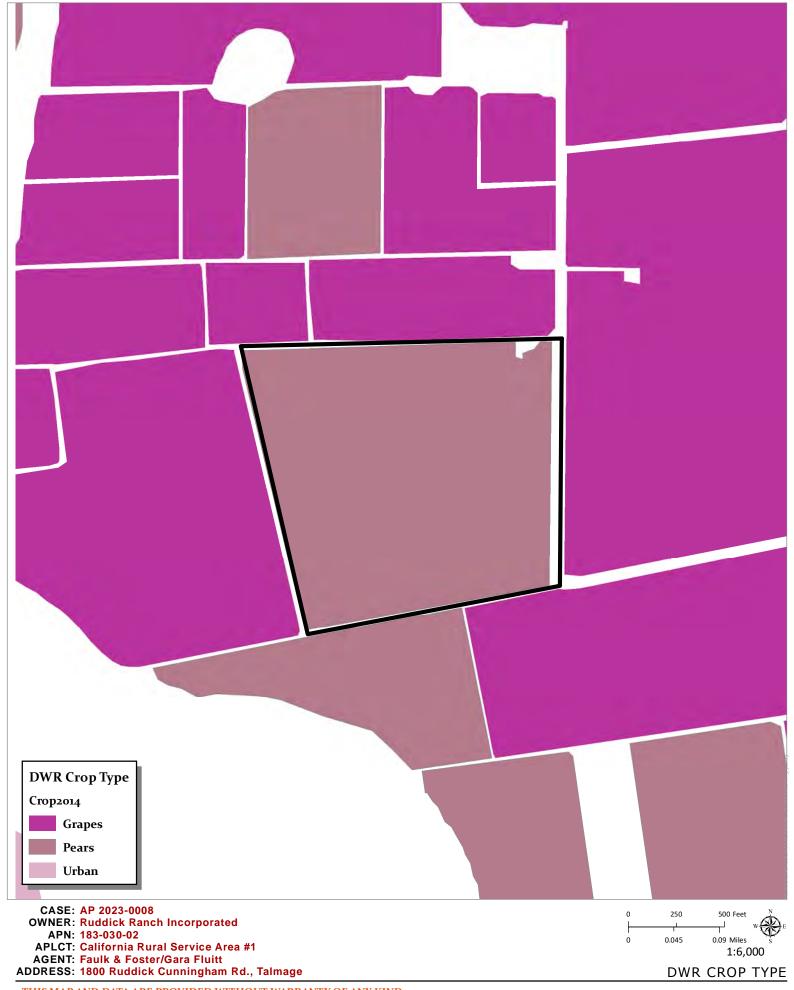

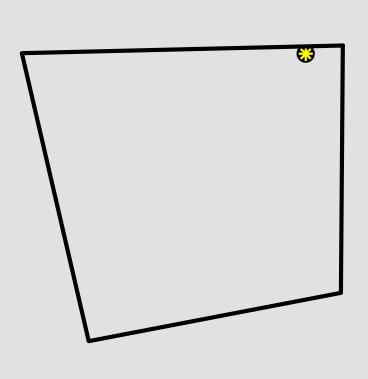


CASE: AP 2023-0008

**OWNER: Ruddick Ranch Incorporated** 


APN: 183-030-02

**APLCT: California Rural Service Area #1** 

AGENT: Faulk & Foster/Gara Fluitt ADDRESS: 1800 Ruddick Cunningham Rd., Talmage

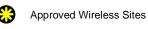

UVAP Boundary

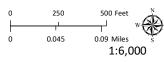

UKIAH VALLEY AREA PLAN