

### COUNTY OF MENDOCINO DEPARTMENT OF PLANNING AND BUILDING SERVICES

860 NORTH BUSH STREET · UKIAH · CALIFORNIA · 95482 120 WEST FIR STREET · FT. BRAGG · CALIFORNIA · 95437 JULIA KROG, DIRECTOR TELEPHONE: 707-234-6650 FAX: 707-463-5709 FB PHONE: 707-964-5379 FB FAX: 707-961-2427 pbs@mendocinocounty.org/pbs www.mendocinocounty.org/pbs

March 14, 2023

Building Inspection - Ukiah Air Quality Management

Cloverdale Rancheria Redwood Valley Rancheria Sherwood Valley Band of Pomo Indians Ukiah Valley Fire District

**CASE#:** AP\_2023-0005 **DATE FILED:** 2/28/2023

OWNER: MENDOCINO LAKE CLUBHOUSE INC APPLICANT: CALIFORNIA RURAL SERVICE AREA #1 AGENT: FAULK AND FOSTER/TRACEY MALONE

REQUEST: Administrative Permit to modify an existing telecommunication site with the removal and replacement

of six (6) CDMA antennas. Three (3) C-Band antennas and three (3) DoD antennas are proposed as

replacements with no net change in the number of antennas. The six (6) existing LTE/CDMA/PCS/AWS antennas will remain but will be relocated. The height of the tower will not change.

**LOCATION:** 3.9± miles northeast of the City of Ukiah center, lying on the west side of Lake Mendocino Drive (CR 227B), 0.4± miles northeast of its intersection with East Side Calpella Road (CR 227), located at 1500 Lake

Mendocino Dr., Ukiah; APN: 168-210-08.

**SUPERVISORIAL DISTRICT: 1** 

**STAFF PLANNER:** STEVEN SWITZER **RESPONSE DUE DATE:** March 28, 2023

### PROJECT INFORMATION CAN BE FOUND AT:

www.mendocinocounty.org

Select "Government" from the drop-down; then locate Planning and Building Services/Public Agency Referrals.

Mendocino County Planning & Building Services is soliciting your input, which will be used in staff analysis and forwarded to the appropriate public hearing. You are invited to comment on any aspect of the proposed project(s). Please convey any requirements or conditions your agency requires for project compliance to the project coordinator at the above address, or submit your comments by email to <a href="mailto:pbs@mendocinocounty.org">pbs@mendocinocounty.org</a>. Please note the case number and name of the project coordinator with all correspondence to this department.

We have reviewed the above appl	ication and recommend the following	ng (please check one):
☐ No comment at this time.		
☐ Recommend conditional approv	val (attached).	
	nformation (attach items needed, o in any correspondence you may h	r contact the applicant directly, copying ave with the applicant)
☐ Recommend denial (Attach rea	sons for recommending denial).	
☐ Recommend preparation of an	Environmental Impact Report (atta	ch reasons why an EIR should be required).
Other comments (attach as nec	cessary).	
REVIEWED BY:		
Signature	Department	Date

**CASE:** AP 2023-0005

OWNER: MENDOCINO LAKE CLUBHOUSE, INC.

**APPLICANT:** CALIFORNIA RURAL SERVICES AREA #1, INC.

TRACEY MALONE C/O FAULK & FOSTER AGENT:

**REQUEST:** Administrative Permit to modify an existing telecommunication site with the removal and replacement of six (6)

> CDMA antennas. Three (3) C-Band antennas and three (3) DoD antennas are proposed as replacements with no net change in the number of antennas. The six (6) existing LTE/CDMA/PCS/AWS antennas will remain but will be

relocated. The height of the tower will not change.

LOCATION: 3.9± miles northeast of the City of Ukiah center, lying on the west side of Lake Mendocino Drive (CR 227B), 0.4±

miles northeast of its intersection with East Side Calpella Road (CR 227), located at 1500 Lake Mendocino Dr.,

Ukiah; APN: 168-210-08.

168-210-08 APN/S:

**PARCEL SIZE:** 5.31± Acres

GENERAL PLAN: Suburban Residential (SR)

**ZONING:** Suburban Residential (SR)

**EXISTING USES:** Wireless Communications facility

**DISTRICT:** 1 (McGourty)

RELATED CASES: U 21-2006, UM 21-2006/2013, AP 2017-0003, AP 2020-0011, AP 2022-0026

	ADJACENT GENERAL PLAN	ADJACENT ZONING	ADJACENT LOT SIZES	ADJACENT USES
NORTH:	RR5	RR:5	32.72± acres	Residential; Agriculture
EAST:	PL	PF	5.42± acres	Public Facilities
SOUTH:	RR1	RR:1	1.21±; 1.15±; 1.9±; 1.3± acres	Residential
WEST:	SR	SR:12K	4.9±; 1.5±; 1.35± acres	Residential

### **REFERRAL AGENCIES**

**TRIBAL** LOCAL

☑ Air Quality Management District ☑ Building Division Ukiah

☑ Ukiah Valley Fire District

 □ Cloverdale Rancheria ☑ Redwood Valley Rancheria

☑ Sherwood Valley Band of Pomo Indians

### **ADDITIONAL INFORMATION:**

Use Permit U 21-2006 - permitted the construction of the subject 60-foot tall monopine within a 2,500 square-foot lease area

Use Permit Modification UM 21-2006/2013 -

AP\_2017-0003 - Administrative Permit for US Cellular antenna modifications to an existing tower

AP\_2020-0011 - Administrative Permit to remove six (6) LTE antennas, six (6) RRHs, and twelve (12) combiners and add six (6) antennas and RRH mount. Two (2) Raycaps and two (2) RRHs to be relocated to proposed RRH mount. No electrical work to be completed.

AP 2022-0026 - Administrative Permit to add a 30 Kw diesel fuel electricity generator with an attached 373 gallon fuel tank for emergency power needs during power outages on a new four foot by nine foot concrete pad within the existing fenced lease area.

**DATE:** 3/8/2023 STAFF PLANNER: Steven Switzer

### **ENVIRONMENTAL DATA**

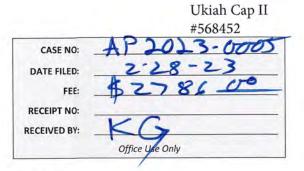
13. AIRPORT LAND USE PLANNING AREA: 1. MAC: N/A 2. FIRE HAZARD SEVERITY ZONE: 14. SUPERFUND/BROWNFIELD/HAZMAT SITE: N/A NO 3. FIRE RESPONSIBILITY AREA: **15. NATURAL DIVERSITY DATABASE:** Ukiah Valley Fire District 4. FARMLAND CLASSIFICATION: 16. STATE FOREST/PARK/RECREATION AREA ADJACENT: N/A N/A 5. FLOOD ZONE CLASSIFICATION: **17. LANDSLIDE HAZARD:** NO N/A 6. COASTAL GROUNDWATER RESOURCE AREA: 18. WATER EFFICIENT LANDSCAPE REQUIRED: N/A N/A 7. SOIL CLASSIFICATION: 19. WILD AND SCENIC RIVER: Western Part N/A 8. PYGMY VEGETATION OR PYGMY CAPABLE SOIL: 20. SPECIFIC PLAN/SPECIAL PLAN AREA: N/A 9. WILLIAMSON ACT CONTRACT: NO 21. STATE CLEARINGHOUSE REQUIRED: N/A **10. TIMBER PRODUCTION ZONE:** NO 22. OAK WOODLAND AREA: 11. WETLANDS CLASSIFICATION: N/A N/A 23. HARBOR DISTRICT:

N/A

12. EARTHQUAKE FAULT ZONE:

NO





### Planning & Building Service APPLICATION FORM

APPLICANT:  California Rura  Name: Faulk and Foste	l Service Area #1, I	nc. by its agent	Phone:	616-460-5889
Mailing Address: 8410 V		venue, Suite 700		
city: Chicago	_State/Zip:_IL		Email:	tracey.malone@faulkandfoster.com
PROPERTY OWNER:				
Name: Mendocino-Lal	ke Clubhouse, Inc.		Dhono	not applicable - all permission given in
		visto	Phone:	assignment
Mailing Address: 1500 I	Lake Mendocino Di	rive		
City:Ukiah	State/Zip:C	A/95485	Email:	not applicable - all permission given in assignment
AGENT:				
Name: Faulk and Fost	ter by Tracey Malor	ne	Phone:	616-460-5889
Mailing Address: 1811	Auburn Avenue			
City: Monroe	State/Zip:L	A/71201	Email:_	tracey.malone@faulkandfoster.com
ASSESSOR'S PARCEL	NUMBER/S:16	8-210-08		
TYPE OF APPLICATION	N:			
Administrative Permi	t	☐ General Pla	n Amendment	t ☐ Use Permit – Cottage
☐ Agricultural Preserve	: New Contract	☐ Land Division	on – Minor	☐ Use Permit – Minor
☐ Agricultural Preserve	: Cancellation	☐ Land Division		☐ Use Permit – Major
☐ Agricultural Preserve	: Rescind & ReEnter	☐ Land Division		☐ Use Permit – Modification
☐ Airport Land Use			on – Re-Subdiv	
☐ Development Review	ı	☐ Reversion t	on of Condition	other 🗆 Other
<ul><li>☐ Exception</li><li>☐ Flood Hazard Develo</li></ul>	pment Permit	☐ Rezoning	to Acreage	
certify that the informatio	n submitted with this ap	olication is true and	l accurate.	

Signature of Applicant/Agent

Daces Milone

2/18/22 Date see attached assignment

Signature of Owner

Date

### SITE AND PROJECT DESCRIPTION QUESTIONNAIRE

The purpose of this questionnaire is to relate information concerning your application to the Department of Planning and Building Services and other agencies who will be reviewing your project proposal. Please remember that the clearer picture that you give us of your project and the site, the easier it will be to promptly process your application. Please answer all questions. Those questions which do not pertain to your project please indicate "Not applicable" or "N/A".

### THE PROJECT

	id equipment pursu	ant to the scope of	work and a nai	rative descriptio	n.
Original Permit: UP-21-20	006				
			<del></del>		·
	NO 0	C. LINUTC	1	SOLIABE FOOTAGE	
2. Structures/Lot Coverage		F UNITS		SQUARE FOOTAGE	
2. Structures/Lot Coverage	NO. O	F UNITS PROPOSED	EXISTING	SQUARE FOOTAGE PROPOSED	TOTAL
					TOTAL
2. Structures/Lot Coverage  ☐ Single Family ☐ Mobile Home					TOTAL
☐ Single Family					TOTAL
☐ Single Family ☐ Mobile Home ☐ Duplex ☐ Multifamily					TOTAL
☐ Single Family ☐ Mobile Home ☐ Duplex ☐ Multifamily ☐ Other:					TOTAL
☐ Single Family ☐ Mobile Home ☐ Duplex ☐ Multifamily					TOTAL
☐ Single Family ☐ Mobile Home ☐ Duplex ☐ Multifamily ☐ Other: ☐ Other:	EXISTING				TOTAL
☐ Single Family ☐ Mobile Home ☐ Duplex ☐ Multifamily ☐ Other:	EXISTING				TOTAL
☐ Single Family ☐ Mobile Home ☐ Duplex ☐ Multifamily ☐ Other: ☐ Other: GRAND TOTAL (Equal to gross area	EXISTING a of Parcel):	PROPOSED	EXISTING		TOTAL
☐ Single Family ☐ Mobile Home ☐ Duplex ☐ Multifamily ☐ Other: ☐ Other: GRAND TOTAL (Equal to gross area.)	EXISTING  a of Parcel):	PROPOSED	EXISTING		TOTAL
☐ Single Family ☐ Mobile Home ☐ Duplex ☐ Multifamily ☐ Other: ☐ Other:	EXISTING  a of Parcel):  ustrial or institutional, on if:	PROPOSED	EXISTING		TOTAL

l the project be phased? YES	in your plans for phasing:
Λ	
Vill vegetation he removed on area	s other than the building sites and roads?
☐ YES 💢 NO If no, explain	
N*(1 )	in and of materially horoundous materials such as toyic substances. flammables, or explosives?
Will the project involve the use or di $\square$ YES $\qquad \colony \square$ NO $\square$ If yes, explai	isposal of potentially hazardous materials such as toxic substances, flammables, or explosives? in:
A TES A TES IT YES, EXPIRE	
<u> </u>	
-	
How much off-street parking will be	
No. of covered spaces:	
No. of uncovered spaces No. of standard spaces:	
No. of accessible space	
Existing no. of spaces:	
Proposed additional sp Total:	aces:
TOtal.	
Is any road construction or grading	planned? If yes, grading and drainage plans may be required.
☐ <b>YES</b>	e describe the terrain to be traversed. (e.g., steep, moderate slope, flat, etc.)
For grading or road construction, co	omplete the following:
Amount of cut:	
	cubic yards
Amount of fill:	
Amount of fill:Max. height of fill slope:	
	feet
Max. height of fill slope:	feet

		ect involve sand removal, mining or gravel extraction? If yes, detailed extraction, reclamation and monitoring plans
-	be required. YES	⊠NO
	Vill the prop	osed development convert land currently or previously used for agriculture to another use? $\mathbb X$ NO
	Vill the deve □ YES	Iopment provide public or private recreation opportunities?  **NO** If yes, explain how:
	s the propos □ YES	ed development visible from State Highway 1 or other scenic route?  \[ \infty \text{NO} \]
	s the propos	ed development visible from a park, beach or other recreational area? $ m X$ NO
<b>15.</b> [	Does the dev	elopment involve diking, filling, dredging or placing structures in open coastal water, wetlands, estuaries or lakes?
	Diking: Filling: Dredging: Structures:	□ YES NO □ YES NO □ YES NO □ Open Coastal Waters □ Wetlands □ Estuaries □ Lakes
	If so, what is t	the amount of material to be dredged/filled?: cubic <b>y</b> ards
	Location of dr	redged material disposal site?:
	Has a U.S. Arr	ny Corps of Engineers permit been applied for? $\square$ YES $\square$ NO
16.	Will there be □ YES no change	e any exterior lighting?  NO If yes, describe below and identify the location of all exterior lighting on the plot and building plans.
17.	<b>Utilities will</b> Electricity:	be supplied to the site as follows: no change  ☐ Utility Company (service exists to parcel) ☐ Utility Company (requires extension of service to site): feet miles ☐ On Site Generation – Specify:
	Gas:	<ul> <li>☐ Utility Company/Tank</li> <li>☐ On Site Generation – Specify:</li> <li>☐ None</li> </ul>
	Telephone:	□ YES □ NO

Septic Tank   Other (specify):
☐ Community Water System (specify supplier): ☐ Well ☐ Spring ☐ Other (specify): ☐ Other
20. Are there any associated projects and/or adjacent properties under your ownership?  ☐ YES ☑ NO If yes, explain: (e.g., Assessor's Parcel Number, address, etc.)
21. List and describe any other related permits and other public approval required for this project, including those required by other County departments, city, regional, State and Federal agencies:
nothing new
22. Describe the location of the site in terms of readily identifiable landmarks: (e.g., mailboxes, mile posts, street intersections, etc.)  see construction drawings
23. Are there existing structures on the property? If yes, describe below and identify the use of each structure on the plot plan or tentative map if the proposal is for a subdivision.  ☐ YES ☐ NO
no change
24. Will any existing structure be demolished or removed? If yes, describe the type of development to be demolished or removed, including the relocation site, if applicable.
□ YES □ NO no change
no change

25. What is the		_	structures?							
Existing:	70	_ feet								
Proposed:		_feet								
26. What is the	gross floor	r areas of all	structures, i	ncluding cove	ered parkin	g and accesso	ry buildings?	none		
		_ square feet	·	_	-					
Proposed:		_ square feet								
27. What is the										
Total Lot Are	ea: 34.64	X	lacres ∟ squ	iare feet						
28. Briefly desc	ribe the pr	oject site as	it exists bef	ore the proje	ct, includin	g information	on existing s	tructures and	d their uses, slope	s,
soil stability, pl	ants and a	nimals, and	any cultural,	historical or	scenic aspe	ects. Attach ar	ny photograp	hs of the sit	e that you feel wo	uld
be helpful:										
					<del></del> .					—
							-			
							اربو برمو مصد	tural hictor	ic or scenic aspects	·c
29. Briefly desc	ribe the su	irrounding p	roperties, in	icluding infor	mation on	piants, animai	s and any cu	tho vicinity t	ic or scenic aspects	۲. ۲.
	pe of land	use (use cha	irt below) an	d its general	intensity.	Attach any pho	otographs of	the vicinity	that you feel would	u
be helpful.										
					· · · · · · · · · · · · · · · · · · ·					
30. Indicate th	o curround	ling land use	oc.							
50. muicate m				Commercial	Industrial	Public Facility	Timberland	Other		
North:			, 18. 10a. 1							
East:										
South:										
			n	n						
West:						_	_			

### CERTIFICATION AND SITE VIEW AUTHORIZATION

1.	application, and all attached appendices requested information or any misstaten accept this application, for denying the	npleted application and that, to the best of and exhibits, is complete and correct. I undepents submitted in support of the application permit, for suspending or revoking a permit ch further relief as may seem proper to the	derstand that the failure to provide any shall be grounds for either refusing to issued on the basis of such
2.	I hereby grant permission for County Pipremises for which this application is mand render its decision.	anning and Building Services staff and hearir ade in order to obtain information necessar <b>y</b>	g bodies to enter upon and site view the for the preparation of required reports
	Owner/A	uthorized Agent	Date
N	NOTE: IF SIGNED BY AGENT, OWNER MUST	SIGN BELOW.	
<u> </u>	AUTHORIZATION OF AGENT		
1	hereby authorize and to bind me in all matters concerning th	s application.	to act as my representative
•	The to sink the man the second of		
		Owner	Date
		MAIL DIRECTION	
Т	o facilitate proper handling of this applic correspondence and/or staff rep	ation, please indicate the names and mailing orts mailed <u>if different from those identified</u>	on Page 1 of the application form.
	Name	Name	Name
	Mailing Address	Mailing Address	Mailing Address

RE: Notice of Grant of Easement and Assignment of Lease

Premises address: 1500 Lake Mendocino Dr, Ukiah CA 95482 (the "Property")

Lease dated as of Sep 12, 2006 (the "Lease")

Tenant Reference #: 568452

Current Payor: California Rural Service Area #1, Inc., a California Corporation

Landmark Site Number: TC120742

Dear Tenant:

Please take notice that as of \_\_\_\_\_\_, the undersigned, as fee owner of the above-referenced Property has granted a perpetual easement and assigned all rights, title and interest in and to the Lease to LD Holdings LLC, a Delaware limited liability company ("Landmark"). The undersigned will continue to own the Property and retain the obligations and liabilities of landlord under the Lease. The undersigned shall also retain possession and control of all security deposits and LD Holdings LLC shall have no obligation with respect to any such security deposits.

After the date hereof, except for payments in respect of utility fees, real property taxes and assessments payable by you to the undersigned as landlord under the Lease, all future rent payments are hereby directed to be made payable to "LD Holdings LLC" and delivered, subject to any further instructions you may hereafter receive, to:

LD Holdings LLC 1700 East Walnut Avenue, Suite 400 El Segundo, CA 90245 Ref: Landmark # TC120742

All future communications regarding the Lease should be made directly to Landmark. If you have any questions about the foregoing, please contact Landmark at (310) 294-8189.

Best regards,

MENDOCINO-LAKE CLUBHOUSE, INC., a California corporation

Name: James M. Busch

Title: President

Date: 4 13/12

Name: John Simmons

Title: Treasurer

### **Indemnification And Hold Harmless**

ORDINANCE NO. 3780, adopted by the Board of Supervisors on June 4, 1991, requires applicants for discretionary land use approvals, to sign the following Indemnification Agreement. Failure to sign this agreement will result in the application being considered incomplete and withheld from further processing.

### Indemnification Agreement

As part of this application, applicant agrees to defend, indemnify, release and hold harmless the County of Mendocino, its agents, officers, attorneys, employees, boards and commissions, as more particularly set forth in Mendocino County Code Section 1.04.120, from any claim, action or proceeding brought against any of the foregoing individuals or entities, the purpose of which is to attack, set aside, void or annul the approval of this application or adoption of the environmental document which accompanies it. The indemnification shall include, but not be limited to, damages, costs, expenses, attorney fees or expert witness fees that may be asserted by any person or entity, including the applicant, arising out of or in connection with the approval of this application, whether or not there is concurrent, passive or active negligence on the part of the County, its agents, officers, attorneys, employees, boards and commissions.

California RSA #1 by its agent Faulk & Foster, Tracey Malone

2/18/2022	· Sees Mone
Date	Applicant
	As expression of the second se

### **County of Mendocino** Department of Planning and Building Services Fax: 707-463-5709 FB PHONE: 707-964-5379 FB FAX: 707-964-5379 FB FAX: 707-961-2427 FB FAX: 707-961-2427 FB FAX: 707-961-2427

120 WEST FIR STREET · FORT BRAGG · CALIFORNIA · 95437

IGNACIO GONZALEZ, INTERIM DIRECTOR JULIA KROG, ASSISTANT DIRECTOR PHONE: 707-234-6650 FAX: 707-463-5709 pbs@mendocinocounty.org www.mendocinocounty.org/pbs

> 2023 C-Band and DoD Ukiah Cap II #568452

### **AGENT/APPLICANT AUTHORIZATION**

I, California Rural Service Area #1, authorize the fol project. The Authorized Agent/Applicant has my permiprocessing of this application. If at any time I wish to remothat I shall notify the Planning and Building Department in writing the processing of this application.	ission to make decisions regarding the ove/replace this authorization, I understand
Site Address: <u>1500 Lake Mendocino Drive, Ukiah, California</u>	<u>95485</u>
Scope (description) of work:Modification of antennas and	equipment
Authorized Agent/Applicant	
Name (Please Print): Tracey Malone and Faulk & Foster	
Mailing Address: 1811 Auburn Avenue,	
City/State/Zip: Monroe, Louisiana 71201	
Phone Number: 616-460-5889	
E-Mail:tracey.malone@faulkandfoster.com	
I declare under penalty of perjury that I represent the tower of listed above and I personally reviewed the above information California Rural Service Area #1	owner located at the addresses n and certify its accuracy.
Owner Signature:	Date:
TO BE FILLED OUT BY PLANNING AND BUILDING STAFF	
	ACCEPTED BY:
APPLICATION NUMBER:	· · · · <del> · ·</del>



February 3, 2023

RE: Faulk & Foster Authorization

To Whom it may concern,

U.S. Cellular® authorizes Faulk and Foster to represent U.S. Cellular® in the performance pf project management, zoning, and permitting activities for various projects in the states of California, Oregon, Washington, Texas, Oklahoma, Missouri, Kansas, Nebraska, Iowa, Illinois, Wisconsin, Tennessee, South Carolina, North Carolina, West Virginia, Virginia, Pennsylvania, New Hampshire, Maine.

Best regards,

Brandi Vandenberg

Brandi Vandenberg U.S. Cellular® Sr Manager Access Deployment 10343 Military Road Omaha, NE 68134 (402) 515-8275 brandi.vandenberg@uscellular.com





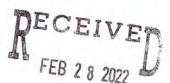
February 18, 2023

Keith Gronendyke, Planner II Mendocino County Planning and Building Services 860 North Bush St

Ukiah, CA 95482

Phone: (707) 234-6650 FAX: (707) 463-5709

email: gronendykek@mendocinocounty.org
Web site: www.co.mendocino.ca.us/planning/



Planning & Building Services

RE: Administrative Antenna Review - Address: 1500 Lake Mendocino Drive, Ukiah,

California 95485; Site Name: Ukiah Cap II #568452

### Dear Keith:

Please consider this submission an antenna change report. Please note that this project does not involve the addition of antennas. It involves the removal and replacement of antennas and equipment. **There is no net change in the number of antennas.** 

My intent is to fully describe the changes to the installation at the address above. The tower at this location is an existing monopine stealth wireless facility. Currently, twelve (12) antennas are mounted at the 68' level. At the end of the installation, the number of antennas will be twelve (12). Two RAYCAPS to be removed and one RAYCAP to be added for surge protection. One lightning rod will be added. One hybrid cable will be added

### Removed Antennas:

The four LPA-80063-EDIN (4) CDMA antennas that are being removed have the dimensions of 71.1 x 15.2 x 13.1 inches (LxWxD). The two RWA-80017LS EDL (2) CDMA antennas that are being removed are  $96.5 \times 11.2 \times 5.9$  (LxWxD).

### Added Antennas:

The three (3) proposed C-Band panel antenna that are being added have a dimension of  $39.4 \times 17.64 \times 4.45$  inches (HxWxD). The three (3) proposed DoD panel antenna that are being added have a dimension of  $29.52 \times 17.71 \times 9.44$  inches (HxWxD). The new antennas will reside in three different locations (in three different directions. The C-Band antenna will

be above the DoD antennas in each footprint. Together, each footprint location in sum is shorter and basically the same width and depth.

### Remaining Antennas:

The six existing LTE/CDMA/PCS/AWS antennas will remain; but, some of them are being relocated and repurposed. The existing microwave antenna dish will also remain.

Chapter 20.236 of the Mendocino County Code Section 20.236.020(A) allows an eligible facilities request as defined in 47 Code of Federal Regulations 1.40001 to be reviewed by administrative permit. 47 CRF 1.40001 (3) defines an eligible facilities request as any request for the modification of an existing tower involving the replacement of equipment that does not substantially change the physical dimensions of such tower. This proposed modification is not a substantial change to the tower because it will not change the height of the tower, it will add panel antennas to the existing elevation. The new antenna mount framework will be interior to the existing mount. All work on the ground will be interior to the existing equipment shelter.

Chapter 20.236 of the Mendocino County Code Section 20.236.020(B) allows those applications for additional antennas and associated equipment to be approved by administrative permit if the changes are in keeping with the development standards found in Section 20.236.025. This project is in compliance with the development standards of Section 20.236.025(A) as a request for additional antennas and equipment located on an existing tower. It is my belief that the proposal is consistent with the requirements of the original use permit. The height of the tower will not change. The new panel antennas will not increase the total structure height with attachments because the new antennas are shorter than those that are being removed. The facility will also remain in compliance with the maximum permissible exposure levels set by the FCC.

For these reasons, the project is subject to administrative approval. I have provided excerpts from the construction drawings to show you the changes that are proposed.

Thanks for your continued assistance with this. Please contact me with questions. Please note my new mailing address.

Sincerely,

Tracey

Tracey Malone
Faulk & Foster
Tracey Malone | Zoning Specialist
Office 616.647.3720 x104
Mobile 616.460.5889 | Fax 616.647.8614
E-mail tracey.malone@faulkandfoster.com

1811 Auburn Avenue Monroe, LA 71201

### SCOPE OF WORK

### TOWER SCOPE:

- EXISTING EQUIPMENT TO REMAIN:

  (5) DENCYO CCT8—2LX2HX—BW65 LTE PANEL ANTENNAS

  (3) NOKIA AHLOA B12/B51 RRHs
  (3) NOKIA AHRIB B2/B56 RRHs
  (2) NOKIA FXCB B5 RRHs
  (2) NOKIA FXCB B5 RRHs
  (2) RAYCAPS RUSOC—6267—PF—48
  (2) 1½" HYBRID CABLES
  (6) FH ½" CDWA COAX

### PROPOSED EQUIPMENT:

- (3) NORIA AROK C-BAND RRH W/INTEGRATED ANTENNA (3) NORIA ABOU DED RRH W/INTEGRATED ANTENNA (1) RAYCAP RUSDC-6267-PF-48 (1) 18" HYBRID CABLE

- C-BAND/DoD JUMPERS:

  (3) FIBER JUMPERS FROM RAYCAP TO C-BAND RRHs
  (3) FIBER JUMPERS FROM RAYCAP TO DOD RRHs
  (3) POWER JUMPERS FROM RAYCAP TO C-BAND RRHs
  (3) POWER JUMPERS FROM RAYCAP TO DOD RRHs

TOP TOWER GROUND BAR: UNABLE TO DETERMINE IF MONOPINE HAS AN EXISTING GROUND BAR. PROPOSED GROUND BAR REQUIRED.

BOTTOM TOWER GROUND BAR: CAN ACCOMMODATE ADDITIONAL GROUND LEAD.

### SHELTER EXTERIOR SCOPE:

CAN ACCOMMODATE ADDITION OF (1) HYBRID CABLE. (1) GPS CABLE AND

### (1) GPS.

SHELTER COAX PORT:

CAN ACCOMMODATE ADDITION OF (1) HYBRID CABLE AND (1) GPS CABLE

### SHELTER EXTERIOR GROUND BAR:

CAN ACCOMMODATE ADDITIONAL GROUND LEAD.

### SHELTER INTERIOR SCOPE:

### EXISTING EQUIPMENT:

- (1) RAYCAP RUSDC-6267-PF-48 TO REMAIN (1) RAYCAP RUSDC-8999-P-48 TO BE REMOVED
- (1) RAYCAP SURGE/POU BOX TO REMAIN ON POWER BAY

### PROPOSED EQUIPMENT:

- (1) PROPOSED RAYCAP FIBER SLACK TRAY (1) PROPOSED RAYCAP SURGE/PDU BOX (BY OTHERS)

SHELTER INTERNAL GROUND BAR: CAN ACCOMMODATE ADDITIONAL GROUND LEAD.

### SPECIAL REQUIREMENTS:

### ANTENNA AZIMUTHS:

PROPOSED C-BAND AND DOD RRHS TO BE INSTALLED AT THE DESIGN AZIMUTH AZIMUTH CHANGES MUST BE PRE SCHEDULED WITH USCC.

### ANTENNA MOUNT:

EXISTING MOUNT HAS SUFFICIENT CAPACITY TO HOLD PROPOSED LOADING, SEE APPURTENANCE MOUNT ANALYSIS BY TEP, DATED DECEMBER 09, 2022 FOR MORE DETAILS.

### ANTENNA CONFIGURATION:

PROPOSED C-BAND AND DOD RRHs TO BE INSTALLED AT 58'-0" AND PLACED ON MOUNT POSITIONS AZ, BZ AND GZ.

### LIGHTNING RODS

CONTRACTOR TO INSTALL 5' LIGHTNING ROD ON TOP OF TOWER, SEE SHEET C-4 FOR DETAILS.

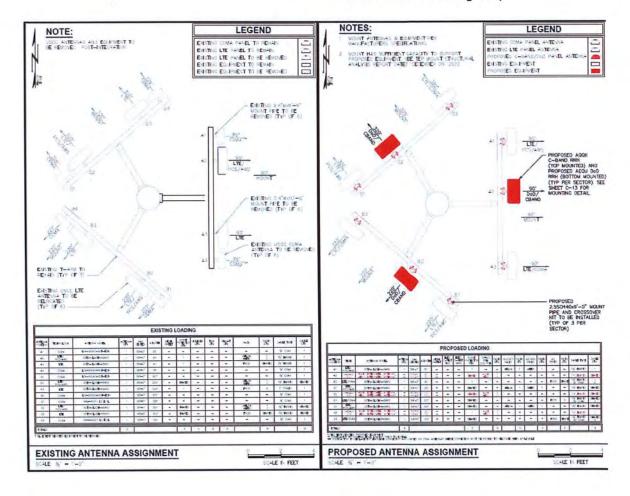
### DECOMMISSIONED EQUIPMENT REMOVAL:

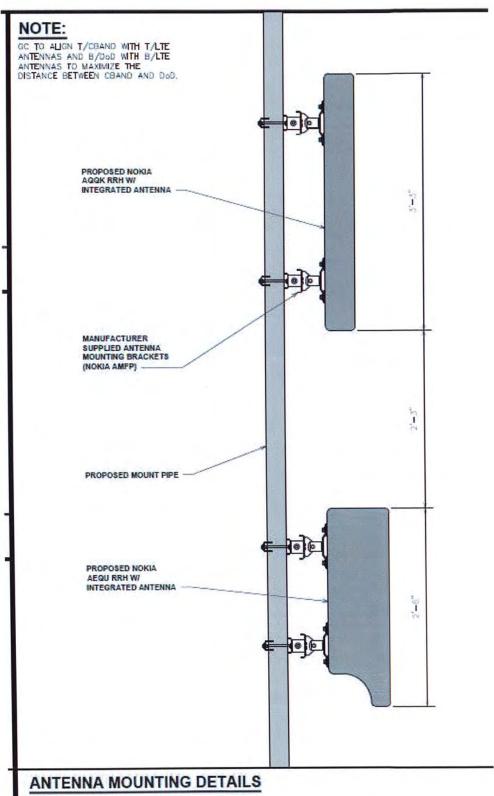
### EQUIPMENT REMOVAL:

- (4) ANTEL LPA-80063-80F-EDIN CDWA PANEL ANTENNAS
- (2) ANTEL RWA-80017 LS E DL CDMA PANEL ANTENNAS
- (2) RAYCAP RUSDC-8999-P-48 (FROM SHELTER AND TOWER)
- (1) 1" POWER CABLE
- 4POST-INTEGRATION


### Twelve Existing Antennae


Twelve Proposed/Remaining Antennae
(Note the C-Band and the DoD antennas
One on top of the other at the same
location on this diagram)





SCALE: N.T.S.

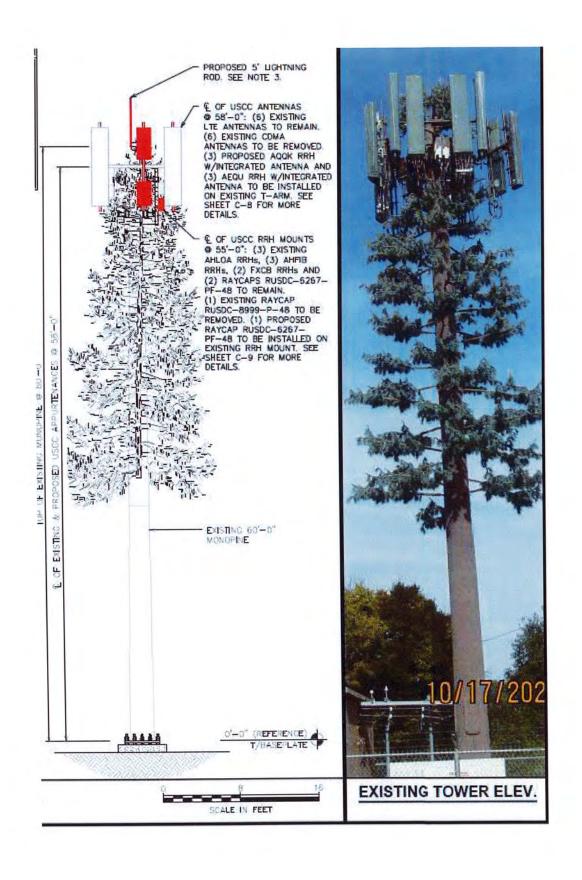

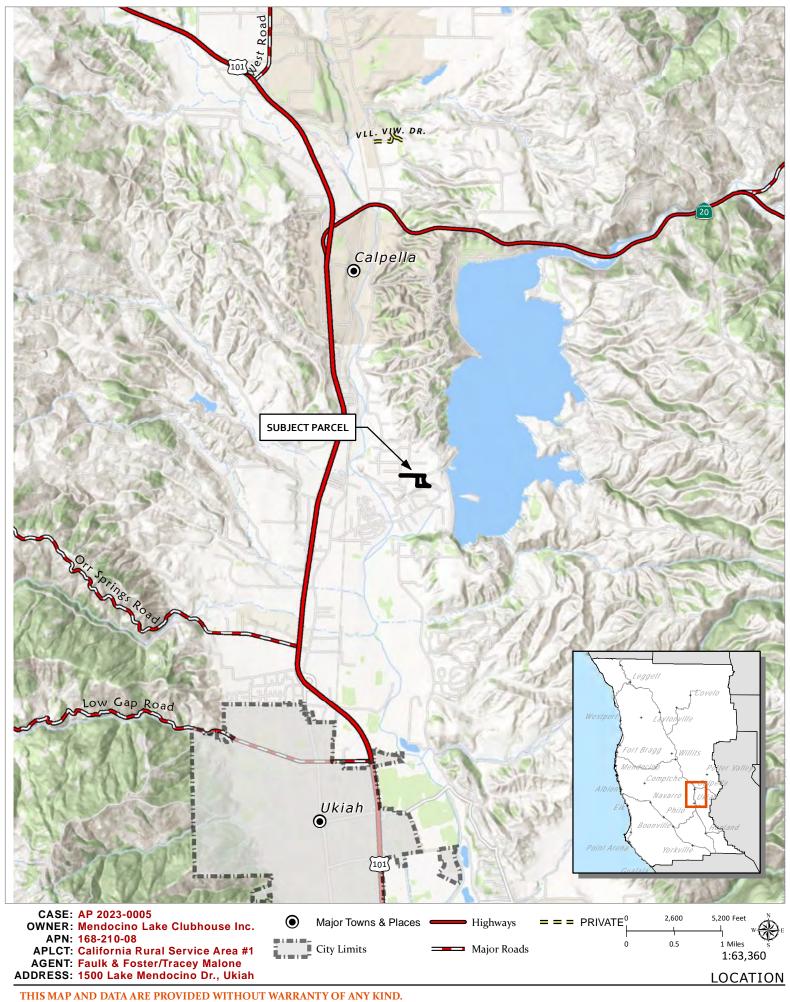




CASE: AP 2023-0005

**OWNER: Mendocino Lake Clubhouse Inc.** 

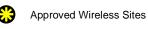APN: 168-210-08

APLCT: California Rural Service Area #1
AGENT: Faulk & Foster/Tracey Malone
ADDRESS: 1500 Lake Mendocino Dr., Ukiah









CASE: AP 2023-0005

**OWNER: Mendocino Lake Clubhouse Inc.** 
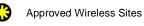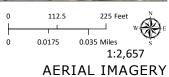
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APLCT: California Rural Service Area #1
AGENT: Faulk & Foster/Tracey Malone
ADDRESS: 1500 Lake Mendocino Dr., Ukiah





## STATE LOCATION

# SITE LOCATION

### **PROJECT TEAM**

### PROJECT CONTACT:

NAME

U.S. CELLULAR CORPORATION ADDRESS 8410 W BRYN MAWR SUITE 700

CITY, STATE, ZIP CHICAGO, IL 60631 RANDALL MATTSON CONTACT

### SITE ACQUISITION:

FAULK & FOSTER NAME 1811 AUBURN AVENUE **ADDRESS** MONROE, LA 71201 CITY, STATE, ZIP

DAN HOOVER CONTACT (318) 807-4666

### TOWER OWNER:

US CELLULAR CORPORATION ADDRESS 8410 W. BRYN MAWR, SUITE 700

CITY, STATE, ZIP CHICAGO, IL 60631 CONTACT RANDALL MATTSON

### CIVIL ENGINEER:

TOWER ENGINEERING PROFESSIONALS, INC.

4710 E. ELWOOD ST. #9 **ADDRESS** PHOENIX, AZ 85040 CITY, STATE, ZIP DAN REIDENBACH, P.E.

CONTACT (480) 750-9062 PHONE

### **C-BAND & DoD - DRAWINGS**

### **UKIAH CAP 2**

568452

### 1500 LAKE MENDOCINO DRIVE **UKIAH, CA 95482** (MENDOCINO COUNTY)

### PROJECT INFORMATION

LATITUDE: LONGITUDE:

N 39° 12' 05.8" \* W 123° 11' 21.3" \* GROUND ELEVATION: 765'± (GOOGLE EARTH)

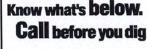
\* INFORMATION PROVIDED USCC

\*\* INFORMATION FROM GOOGLE EARTH

TOWER TYPE: LOADING TYPE: 60'-0" MONOPINE DX210F-CDMA/ **NOKIA C-BAND & DoD** 

ACCESS ISSUES: **GATE COMBO:** 

7CI KEY AND MAN LIFT REQUIRED



### INDEX OF SHEETS

NO.	SHEET TITLE	REV
T-1	TITLE SHEET	3
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C-2	COMPOUND DETAIL	3
C-3	SHELTER DETAIL	3
C-4	TOWER ELEVATION	3
C-5	HATCH PLATE & ICE BRIDGE DETAILS	3
C-6	COAX LAYOUT	3
C-7	GROUND BAR DETAILS	3
C-8	ANTENNA MOUNTING DETAIL	3
C-9	RAYCAP & RRH LAYOUT	3
C-10	PLUMBING DIAGRAM I	3
C-11	PLUMBING DIAGRAM II	3
C-12	SHELTER BLOCK DIAGRAM	3
C-13	C-BAND AND DOD SPECIFICATIONS	3
C-14	FIBER AND COAX LABELLING STANDARDS I	3
C-15	FIBER AND COAX LABELLING STANDARDS II	3
N-1	GENERAL NOTES	3
-		
-	-	-

### STRUCTURAL NOTE

STRUCTURAL STATUS:

TOWER SA - PASSING (DECEMBER 07, 2022)

MOUNT SA - PASSING (DECEMBER 09, 2022)

### SCOPE OF WORK

### TOWER SCOPE:

EXISTING EQUIPMENT TO REMAIN:

(6) DENGYO OCT8-2LX2HX-BW65 LTE PANEL AND ECEIVE

(3) NOKIA AHLOA B12/B71 RRHs

(3) NOKIA AHLOA B12/B71 RRHs

(4) DENGYO OCT8-2LX2HX-BW65 LTE PANEL AND ECEIVE

NOKIA AHFIB B2/B66 RRHs NOKIA FXCB B5 RRHs

2) RAYCAPS RUSDC-6267-PF-48
2) 1½" HYBRID CABLES
6) FH %" CDMA COAX

PROPOSED EQUIPMENT:
(3) NOKIA AQOK C-BAND RRH W/ INTEGRATE PLANTENNA
(3) NOKIA AEOU DOD RRH W/INTEGRATED ANTENNIQING & Building Service
(1) RAYCAP RUSDC-6267-PF-48
(1) 1¼" HYBRID CABLE

C-BAND/DoD JUMPERS:

(3) FIBER JUMPERS FROM RAYCAP TO C-BAND RRHs
(3) FIBER JUMPERS FROM RAYCAP TO DOD RRHs
(3) POWER JUMPERS FROM RAYCAP TO C-BAND RRHs
(3) POWER JUMPERS FROM RAYCAP TO DOD RRHs

TOP TOWER GROUND BAR: UNABLE TO DETERMINE IF MONOPINE HAS AN EXISTING GROUND BAR. PROPOSED GROUND BAR REQUIRED.

BOTTOM TOWER GROUND BAR:
CAN ACCOMMODATE ADDITIONAL GROUND LEAD.

### SHELTER EXTERIOR SCOPE:

CAN ACCOMMODATE ADDITION OF (1) HYBRID CABLE, (1) GPS CABLE AND

SHELTER COAX PORT:

CAN ACCOMMODATE ADDITION OF (1) HYBRID CABLE AND (1) GPS CABLE.

SHELTER EXTERIOR GROUND BAR:
CAN ACCOMMODATE ADDITIONAL GROUND LEAD.

### SHELTER INTERIOR SCOPE:

EXISTING EQUIPMENT:

(1) RAYCAP RUSDC-6267-PF-48 TO REMAIN

(1) RAYCAP RUSDC-8999-P-48 TO BE REMOVED (1) RAYCAP SURGE/PDU BOX TO REMAIN ON POWER BAY

PROPOSED EQUIPMENT:

(1) PROPOSED RAYCAP FIBER SLACK TRAY
(1) PROPOSED RAYCAP SURGE/PDU BOX (BY OTHERS)

SHELTER INTERNAL GROUND BAR:
CAN ACCOMMODATE ADDITIONAL GROUND LEAD.

### SPECIAL REQUIREMENTS:

ANTENNA AZIMUTHS:

PROPOSED C-BAND AND DOD RRHS TO BE INSTALLED AT THE DESIGN AZIMUTH. AZIMUTH CHANGES MUST BE PRE SCHEDULED WITH USCC.

ANTENNA MOUNT:

EXISTING MOUNT HAS SUFFICIENT CAPACITY TO HOLD PROPOSED LOADING. SEE APPURTENANCE MOUNT ANALYSIS BY TEP, DATED DECEMBER 09, 2022 FOR MORE DETAILS.

ANTENNA CONFIGURATION:

PROPOSED C-BAND AND DOD RRHS TO BE INSTALLED AT 58'-0" AND PLACED ON MOUNT POSITIONS A2, B2 AND G2.

CONTRACTOR TO INSTALL 5' LIGHTNING ROD ON TOP OF TOWER. SEE SHEET C-4 FOR DETAILS.

### **DECOMMISSIONED EQUIPMENT REMOVAL:**

EQUIPMENT REMOVAL:

(4) ANTEL LPA-80063-8CF-EDIN CDMA PANEL ANTENNAS (2) ANTEL RWA-80017 LS E DL CDMA PANEL ANTENNAS

(2) RAYCAP RUSDC-8999-P-48 (FROM SHELTER AND TOWER)

(1) 1" POWER CABLE

\*POST-INTEGRATION

PLANS PREPARED FOR:



CHICAGO, IL 60631 (773) 399-8900

PROJECT INFORMATION:

### 568452 **UKIAH CAP 2**

1500 LAKE MENDOCINO DRIVE UKIAH, CA 95482 (MENDOCINO COUNTY)

PLANS PREPARED BY:



### TOWER ENGINEERING PROFESSIONALS

500 E. 84TH AVE, SUITE C10 THORNTON, CO 80229 OFFICE: (303) 566-9914 www.tepgroup.net

SEAL:



REV	DATE	ISSUED FOR:
1	01-19-23	PRELIMINARY
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3	02-08-23	CONSTRUCTION

RSR CHECKED BY:

SHEET TITLE:

TITLE SHEET

SHEET NUMBER:

REVISION:

TEP#: 25217.74335



### **BIRD'S EYE AERIAL OVERVIEW**



### SITE OVERVIEW



SCALE: N.T.S

**COMPOUND SIGNAGE** 



PLANS PREPARED FOR:

Suscellular.

8410 W BRYN MAWR SUITE 700 CHICAGO, IL 60631 (773) 399-8900

PROJECT INFORMATION:

### 568452 UKIAH CAP 2

1500 LAKE MENDOCINO DRIVE UKIAH, CA 95482 (MENDOCINO COUNTY)

PLANS PREPARED BY:



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February 8, 202.

REV	DATE	ISSUED FOR:
-	01-19-23	PRELIMINARY
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DRAWN BY: RSR CHECKED BY: GSK

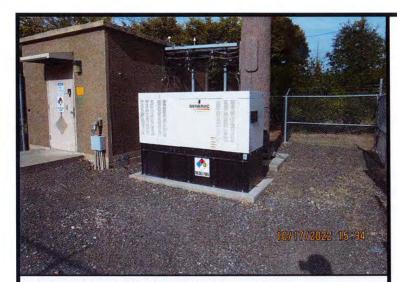
SHEET TITLE:

SITE PLAN


SHEET NUMBER:

REVISION:

TEP#: 25217.743352




**COMPOUND VIEW "A"** 

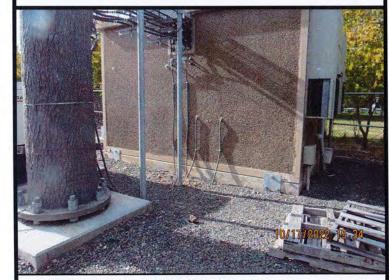

**COMPOUND VIEW "B"** 



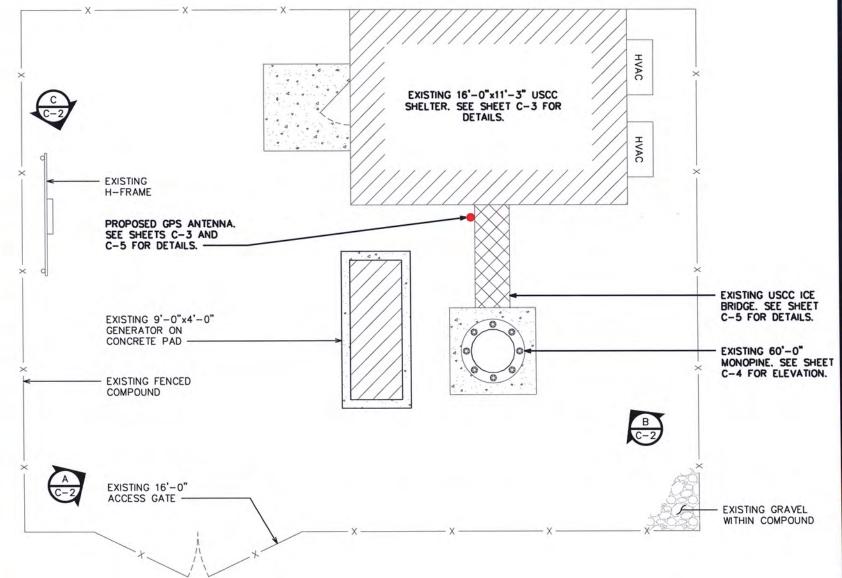**COMPOUND VIEW "C"** 



PLANS PREPARED FOR:

8410 W BRYN MAWR SUITE 700 CHICAGO, IL 60631 (773) 399-8900

PROJECT INFORMATION:

### 568452 **UKIAH CAP 2**

1500 LAKE MENDOCINO DRIVE UKIAH, CA 95482 (MENDOCINO COUNTY)

PLANS PREPARED BY:



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DRAWN BY: RSR CHECKED BY: GSH

SHEET TITLE:

**COMPOUND DETAIL** 

SHEET NUMBER:

REVISION:

TEP#: 25217.743352

**COMPOUND DETAIL** 

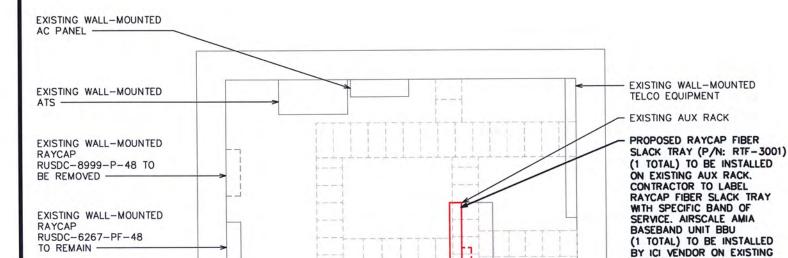
SCALE:  $\frac{3}{16}$ " = 1'-0"

SCALE IN FEET

### NOTE:

CONTRACTOR TO REMOVE OUTER JACKET OF HYBRID CABLE AT THE COAX PORT TO EXPOSE THE FIBER AND POWER RUNS. FIBER RUNS ARE TO BE ROUTED TO THE AUXILIARY RACK AND THE POWER RUNS ARE TO BE ROUTED TO THE RAYCAP/PDU BOX ON THE POWER BAY.





PROPOSED FIBER RUN FROM
COAX PORT TO AUX RACK
(12'-2")

PROPOSED 1¼" HYBRID CABLE

AUX RACK

- EXISTING USCC HATCH PLATE. SEE SHEET C-5 FOR DETAILS.


PROPOSED POWER PAIRS FROM COAX PORT TO POWER BAY (11'-8")

PROPOSED RAYCAP SURGE/PDU BOX TO BE INSTALLED BY OTHERS ABOVE EXISTING RAYCAP SURGE/PDU BOX ON EXISTING DC POWER PLANT

EXISTING DC POWER PLANT/BATTERY RACK


### NOTES:

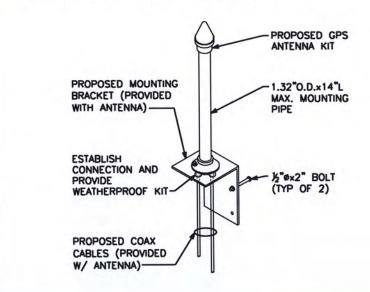- LOCATION OF ANTENNA MUST HAVE CLEAR VIEW OF SOUTHERN SKY AND CANNOT HAVE ANY BLOCKAGES EXCEEDING 25% OF THE SURFACE AREA OF A HEMISPHERE AROUND THE GPS ANTENNA.
- ALL GPS ANTENNA LOCATIONS MUST BE ABLE TO RECEIVE CLEAR SIGNALS FROM A MINIMUM OF FOUR (4) SATELLITES. VERIFY WITH HANDHELD GPS BEFORE FINAL LOCATION OF GPS ANTENNA.



### **GPS ANTENNA KIT DETAIL**

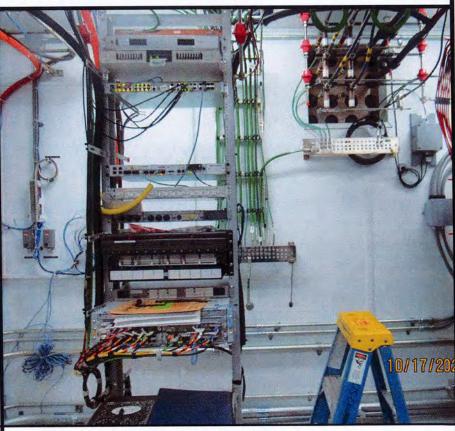SCALE: N.T.S.



**EXISTING AUX RACK LOCATION** 

PLANS PREPARED FOR:

USCEllular

8410 W BRYN MAWR SUITE 700 CHICAGO, IL 60631 (773) 399-8900

PROJECT INFORMATION:

### 568452 UKIAH CAP 2

1500 LAKE MENDOCINO DRIVE UKIAH, CA 95482 (MENDOCINO COUNTY)

PLANS PREPARED BY:



### **TOWER ENGINEERING PROFESSIONALS**

500 E. 84TH AVE, SUITE C10 THORNTON, CO 80229 OFFICE: (303) 566-9914 www.tepgroup.net

SEAL:



February 8, 2023

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3	02-08-23	CONSTRUCTION	

DRAWN BY: RSR CHECKED BY:

SHEET TITLE:

SHELTER DETAIL

SHEET NUMBER:

REVISION:

TEP#: 25217.74335

INTERIOR SHELTER LAYOUT

SCALE: 3/8" = 1'-0"

EXISTING USCC EMPTY

EXISTING CDMA RACK

EXISTING OVERHEAD CABLE LADDER —

HATCH PLATE

(TYP OF 2) -

2

SCALE IN FEET

### **EUPEN HYBRID CABLE LENGTH**

TOTAL EST. LENGTH OF HYBRID CABLE (ROUNDED UP):	100-FT
TOTAL ESTIMATED LENGTH OF HYBRID CABLE:	88-FT
RAYCAP CENTERLINE + 12-FT BUFFER:	67-FT
ICE BRIDGE LENGTH:	8-FT
LONGEST ROUTE TO COAX PORT IN SHELTER:	13-FT
EXISTING POWER CABLE QUANTITY:	1
EXISTING HYBRID CABLE QUANTITY:	2
PROPOSED HYBRID CABLE QUANTITY:	1

### **JUMPER INFO**

JUMPER QUANTITIES		
FIBER JUMPERS:	6	
COAX JUMPERS:	0	
RET JUMPERS:	0	

FIBER JUMPER LEI	NGTH FROM RAYCA	AP TO RRH
	C-BAND	DoD
ALPHA SECTOR:	10-M	10-M
BETA SECTOR:	10-M	10-M
GAMMA SECTOR:	10-M	10-M

PROPOSED 5' LIGHTNING ROD. SEE NOTE 3.

OF USCC ANTENNAS ● 58'-0": (6) EXISTING LTE ANTENNAS TO REMAIN. (6) EXISTING CDMA ANTENNAS TO BE REMOVED. (3) PROPOSED AQQK RRH W/INTEGRATED ANTENNA AND (3) AEQU RRH W/INTEGRATED
ANTENNA TO BE INSTALLED
ON EXISTING T-ARM. SEE SHEET C-8 FOR MORE DETAILS.

© OF USCC RRH MOUNTS

• 55'-0": (3) EXISTING AHLOA RRHS, (3) AHFIB RRHS, (2) FXCB RRHS AND (2) RAYCAPS RUSDC-6267-PF-48 TO REMAIN.
(1) EXISTING RAYCAP RUSDC-8999-P-48 TO BE REMOVED. (1) PROPOSED
RAYCAP RUSDC-6267PF-48 TO BE INSTALLED ON
EXISTING RRH MOUNT. SEE
SHEET C-9 FOR MORE

FXISTING 60'-0" MONOPINE

### NOTES:

- EXISTING AND PROPOSED USCC ANTENNAS ARE TO BE VERTICALLY CENTERED ON ANTENNA MOUNT.
- 2. PROPOSED ANTENNAS TO BE PAINTED TO MATCH EXISTING ANTENNAS
- 3. CONTRACTOR TO INSTALL 5' LIGHTNING ROD ON TOP OF TOWER. CONTRACTOR TO ENSURE LIGHTNING ROD HAS MINIMUM 2' CLEARANCE ABOVE NEXT HIGHEST APPURTENANCE.

EXISTING LTE PANEL TO REMAIN: EXISTING CDMA PANEL TO REMAIN: PROPOSED C-BAND/DoD PANEL TO BE INSTALLED:

### PROPOSED TOWER ELEVATION

SCALE: 1 = 1'-0"

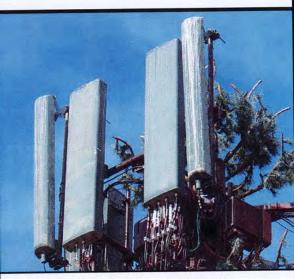


0'-0" (REFERENCE)
T/BASEPLATE

### **EXISTING TOWER ELEV.**

**EXISTING GAMMA SECTOR** 

**EXISTING ALPHA SECTOR** 



**EXISTING BETA SECTOR** 





CHICAGO, IL 60631 (773) 399-8900

PROJECT INFORMATION:

### 568452 **UKIAH CAP 2**

1500 LAKE MENDOCINO DRIVE UKIAH, CA 95482 (MENDOCINO COUNTY)

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DRAWN BY: RSR CHECKED BY: GSH

SHEET TITLE:

**TOWER ELEVATION** 

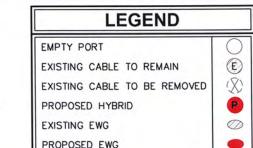
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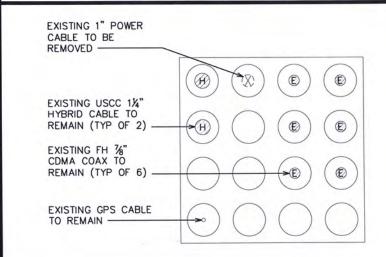
REVISION:

TEP#: 25217.743352

### NOTES:

- 1. ALL VIEWS ARE LOOKING FROM THE TOWER TOWARDS THE SHELTER.
- 2. ANALOG COAX (IF APPLICABLE) TO BE REMOVED IS LABELED WITH GREEN TAPE.



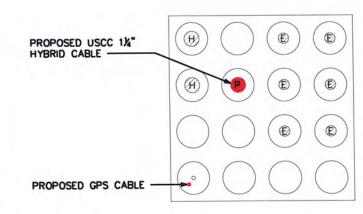


### **EXISTING HATCH PLATE LAYOUT**

SCALE: N.T.S.

### NOTE:

CONTRACTOR TO VERIFY COAX LOCATION WITH STRUCTURAL ANALYSIS AND TOWER OWNER PRIOR TO INSTALLATION.




### PROPOSED HATCH PLATE LAYOUT

SCALE: N.T.S.


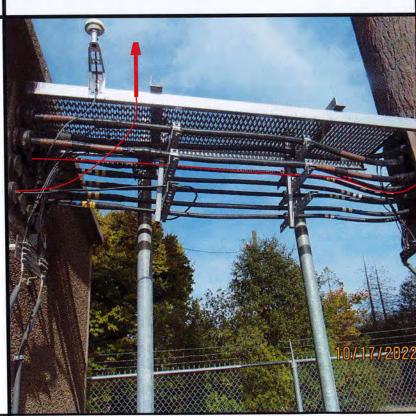
### **EXISTING HATCH PLATE**




**EXISTING ICE BRIDGE ELEVATION** 

# EXISTING 1" POWER CABLE TO BE REMOVED EXISTING USCC 1½" HYBRID CABLE TO REMAIN (TYP OF 2) EXISTING FH ½" CDMA COAX TO REMAIN (TYP OF 6)

### **EXISTING ICE BRIDGE CONFIGURATION**

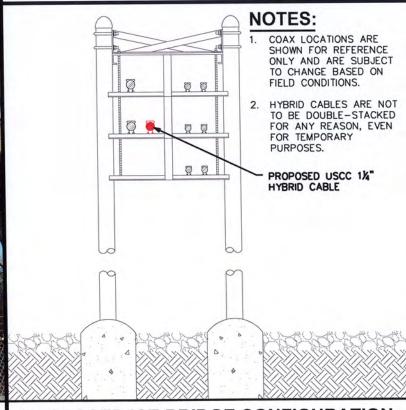SCALE: N.T.S.



### PROPOSED ICE BRIDGE CONFIGURATION

SCALE: N.T.S.

## PLANS PREPARED FOR: \*\*SUSCEILLAR.\*\* 8410 W BRYN MAWR SUITE 700 CHICAGO IL 60631

CHICAGO, IL 60631 (773) 399-8900

PROJECT INFORMATION:

### 568452 UKIAH CAP 2

1500 LAKE MENDOCINO DRIVE UKIAH, CA 95482 (MENDOCINO COUNTY)

PLANS PREPARED BY:



### TOWER ENGINEERING PROFESSIONALS

500 E. 84TH AVE, SUITE C10 THORNTON, CO 80229 OFFICE: (303) 566-9914 www.tepgroup.net

SEAL:



February 8, 202.

	5		_
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DRAWN BY: RSR CHECKED BY: GS

SHEET TITLE:

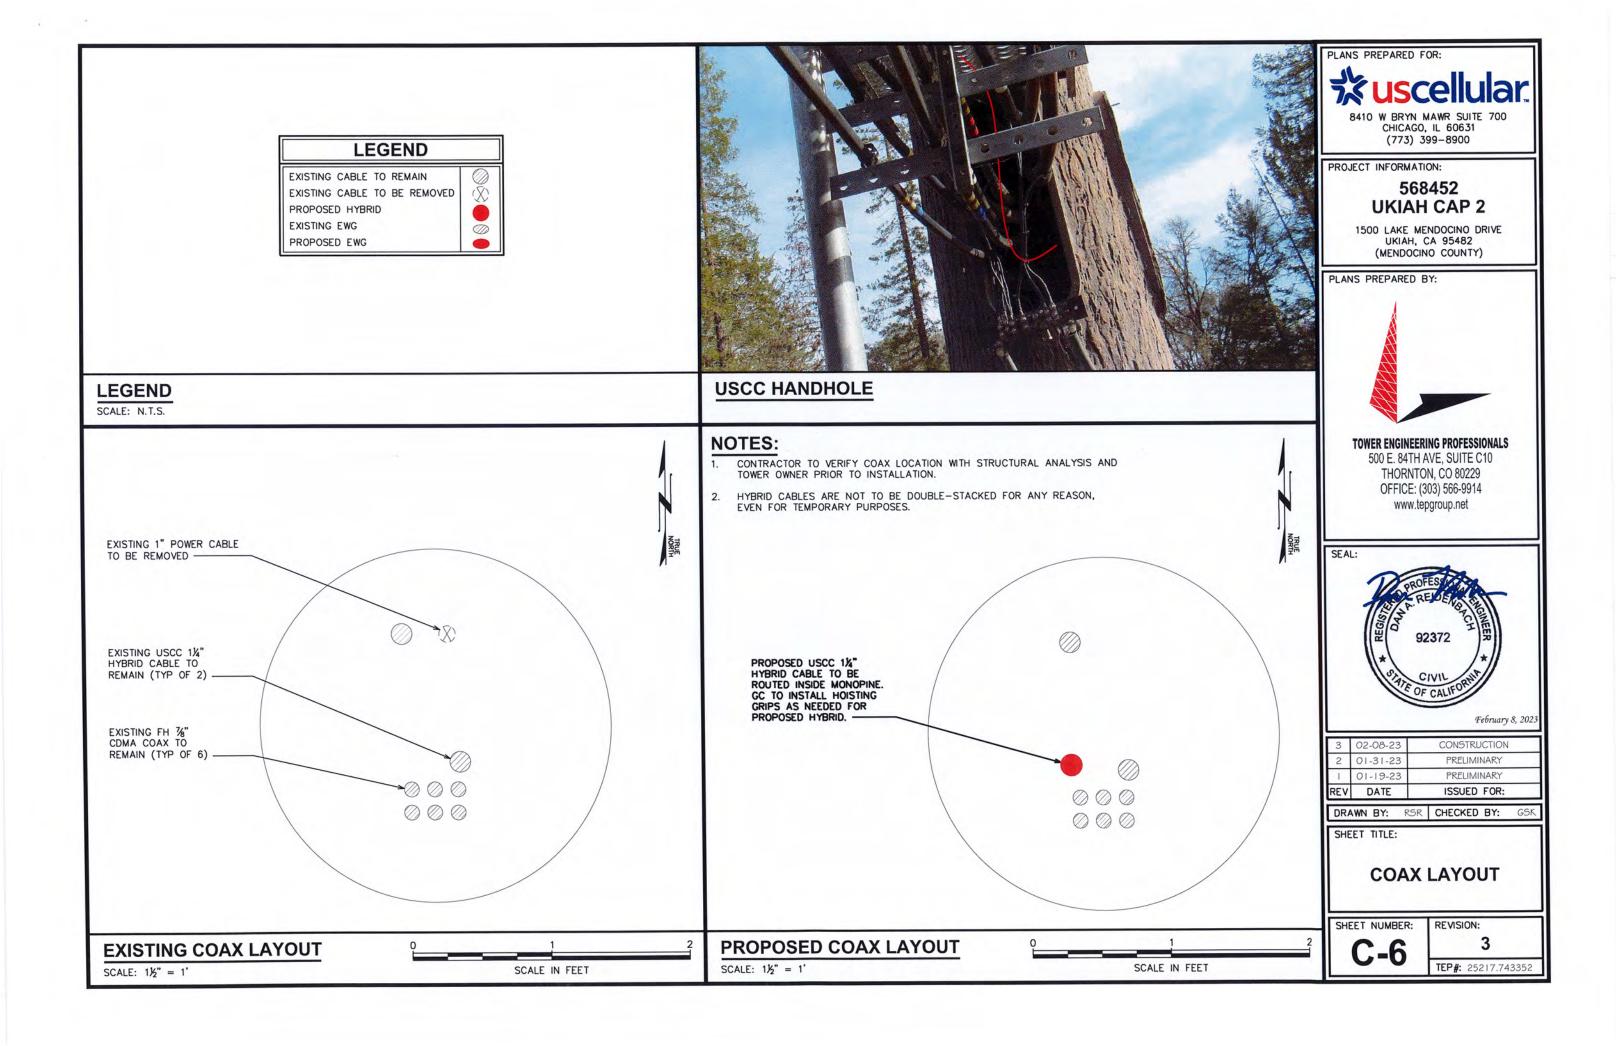
### HATCH PLATE & ICE BRIDGE DETAILS

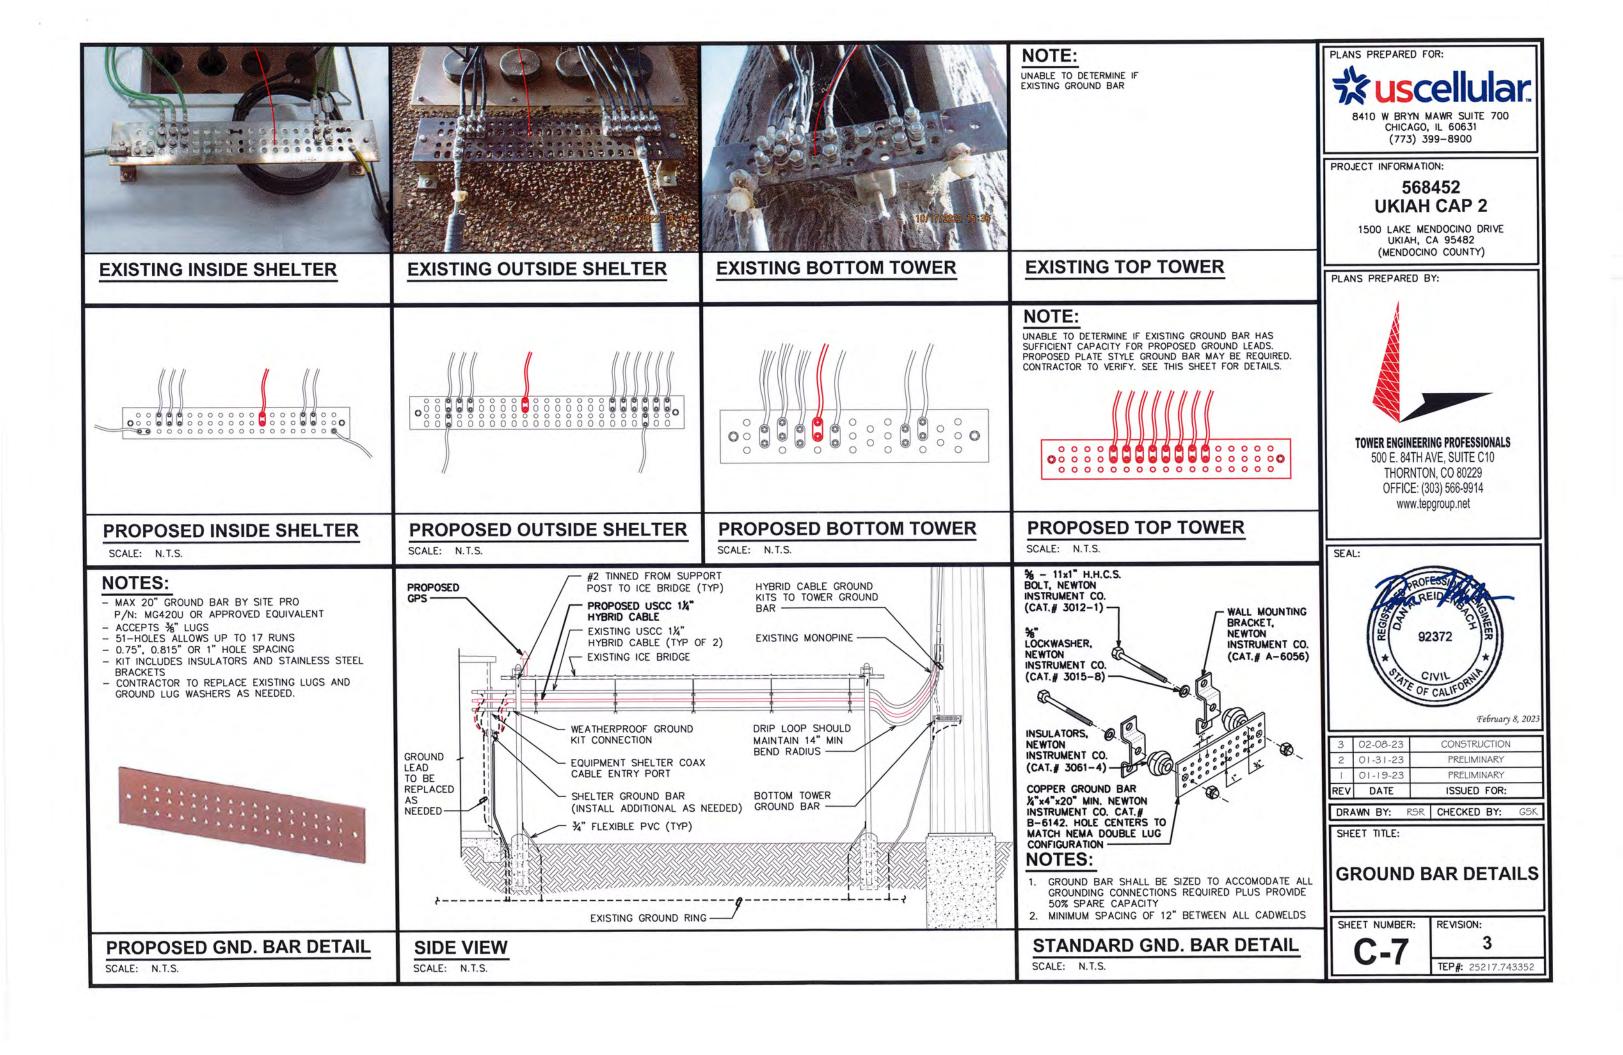
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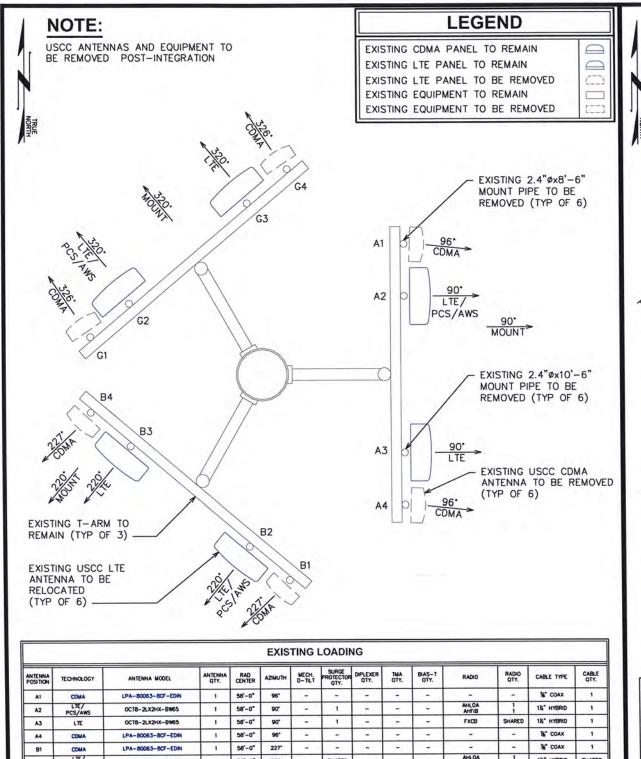
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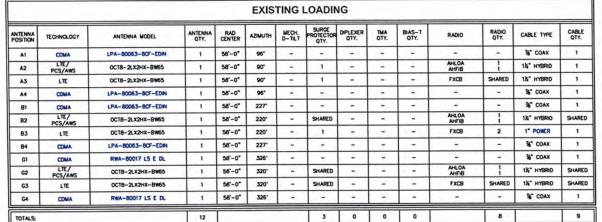
C-5

TEP#: 25217.743352









**EXISTING ANTENNA ASSIGNMENT** 

SCALE: 3/8" = 1'-0"

SCALE IN FEET

### NOTES:

- MOUNT ANTENNAS & EQUIPMENT PER MANUFACTURERS SPECIFICATIONS.
- MOUNT HAS SUFFICIENT CAPACITY TO SUPPORT PROPOSED EQUIPMENT. SEE TEP MOUNT STRUCTURAL ANALYSIS REPORT DATED DECEMBER 09, 2022.

### **LEGEND**

EXISTING CDMA PANEL ANTENNA EXISTING LTE PANEL ANTENNA PROPOSED C-BAND/DoD PANEL ANTENNA EXISTING EQUIPMENT PROPOSED EQUIPMENT

> 90° PCS/AWS

> > DoD/

CBAND

90°

LTE/CDMA

AHFIB

PROPOSED AQQK C-BAND RRH

MOUNTING DETAIL.

PROPOSED

2.5SCH40x9'-0" MOUNT

PIPE AND CROSSOVER KIT TO BE INSTALLED (TYP OF 3 PER SECTOR)

FXCB SHARE 14" HYBRID

SCALE IN FEET

(TOP MOUNTED) AND

PROPOSED AEQU DoD RRH (BOTTOM MOUNTED)

(TYP PER SECTOR). SEE SHEET C-13 FOR

PLANS PREPARED FOR: 8410 W BRYN MAWR SUITE 700 CHICAGO, IL 60631 (773) 399-8900

PROJECT INFORMATION:

### 568452 **UKIAH CAP 2**

1500 LAKE MENDOCINO DRIVE UKIAH, CA 95482 (MENDOCINO COUNTY)



### **TOWER ENGINEERING PROFESSIONALS**

500 E. 84TH AVE, SUITE C10 THORNTON, CO 80229 OFFICE: (303) 566-9914 www.tepgroup.net



REV	DATE	ISSUED FOR:	
1	01-19-23	PRELIMINARY	
2	01-31-23	PRELIMINARY	
3	02-08-23	CONSTRUCTION	

DRAWN BY: RSR CHECKED BY:

SHEET TITLE:

ANTENNA MOUNTING DETAIL

SHEET NUMBER:

REVISION:

TEP#: 25217.743352

B1 PCS/AWS B2 FXCB 2 1½" HYBRID 36" COAX OCT8-2LX2HX-BW65 58'-0" 220' LTE/ 1 58'-0" 320" AHLOA AHFIB OCT8-2LX2HX-RW65 - FXCB SHARE 1% HYBRID 3 6 3 3 RED LEXT DENOTES PROPOSED EQUINENT

"CONTRACTOR TO COMPAN FINAL LOADING PRIOR TO INSTALL

"CONTRACTOR TO COMPAN FINAL LOADING PRIOR TO INSTALL

"CONTRACTOR TO REPLACE TO HARDLING CONNECTOR AND JUMPER ON COMA ANTENNAS WHERE CONNECTION MUST BE BROKEN TO RELOCATE WHEN APPLICABLE.

PROPOSED LOADING

1 58'-0" 90"

1 58'-0" 220'

### PROPOSED ANTENNA ASSIGNMENT

SCALE: 3/8" = 1'-0"

TECH


A3 LTE/CDMA

ANTENNA MODEL

OCT8-2LX2HX-BW65

OCT8-2LX2HX-BW65

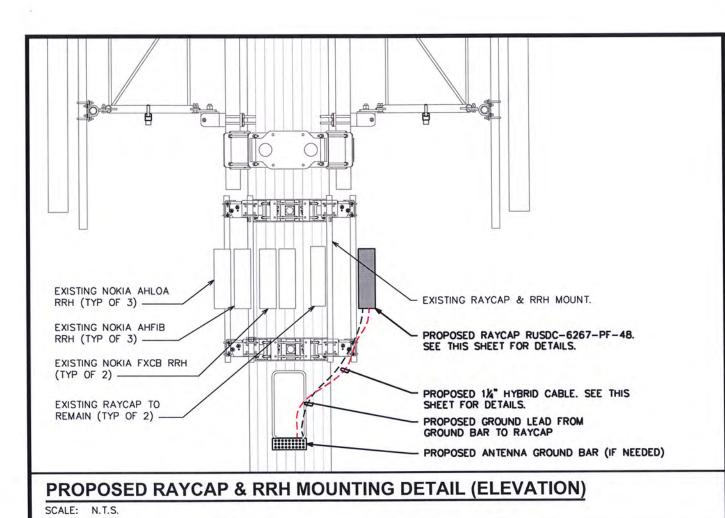OCT8-2LX2HX-BW65



### EXISTING RAYCAP RUSDC-6267-PF-48 TO REMAIN (TYP OF 2) EXISTING RAYCAP RUSDC-8999-P-48 TO BE REMOVED EXISTING NOKIA AHLOA RRHs (TYP OF 3) AHLOA AHFIB EXISTING NOKIA AHFIB RRHs (TYP OF 3) EXISTING RRH MOUNT TO REMAIN (TYP OF 3) EXISTING FXCB RRHs TO REMAIN (TYP OF 2)

### PLANS PREPARED FOR:

CHICAGO, IL 60631 (773) 399-8900

PROJECT INFORMATION:

### 568452 **UKIAH CAP 2**

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DRAWN BY: RSR CHECKED BY: GSK

SHEET TITLE:

**RAYCAP & RRH** LAYOUT

SHEET NUMBER:

REVISION:

TEP#: 25217.743352

### **EXISTING RAYCAP & RRH MOUNTING DETAIL (PLAN)**

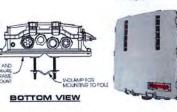
SCALE: N.T.S.

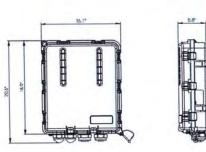
### NOTES:

- P/N: RUSDC-6267-PF-48
- 20.6"Hx18.9"Wx5.8"D 19.95 LBS.



SIDE VIEW





FRONT VIEW

(2' O.D.)

NOTES:

O.D.) AT EACH END

### **EUPEN HYBRID CABLE**

- 1½" FIBER OPTIC CABLE WITH 48V ENERGY FEEDER IN CORRUGATED ALUMINUM SHIELDING WITH UV RESISTANT PE JACKET.

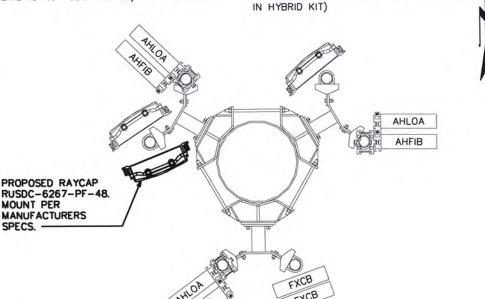
- MINIMUM BENDING RADIUS: 360mm (14") - MAXIMUM PULLING STRENGTH: 150daN - MAXIMUM HANGER SPACING: 1.0m

- APPROX WEIGHT: 2300kg/km (1.55LB/FT) - SHIPPED W/4' PROTECTED JACKET (2.25"

- NON-ARMORED ENDS ARE 3" IN LENGTH

SCALE: N.T.S.

NOTES: CONTRACTOR TO LEAVE OPENING FOR SAFETY CLIMB AND ENSURE SAFETY CLIMB IS NOT OBSTRUCTED/COMPROMISED.



2. TOWER TOP FIBER/POWER CONNECTIONS

SHIELDED IN 1" INTERDUCT (75' PROVIDED


FROM RAYCAP TO RRH SHOULD BE

PROPOSED RAYCAP & RRH MOUNTING DETAIL (PLAN)

SCALE: N.T.S.

### RAYCAP SPEC SHEET

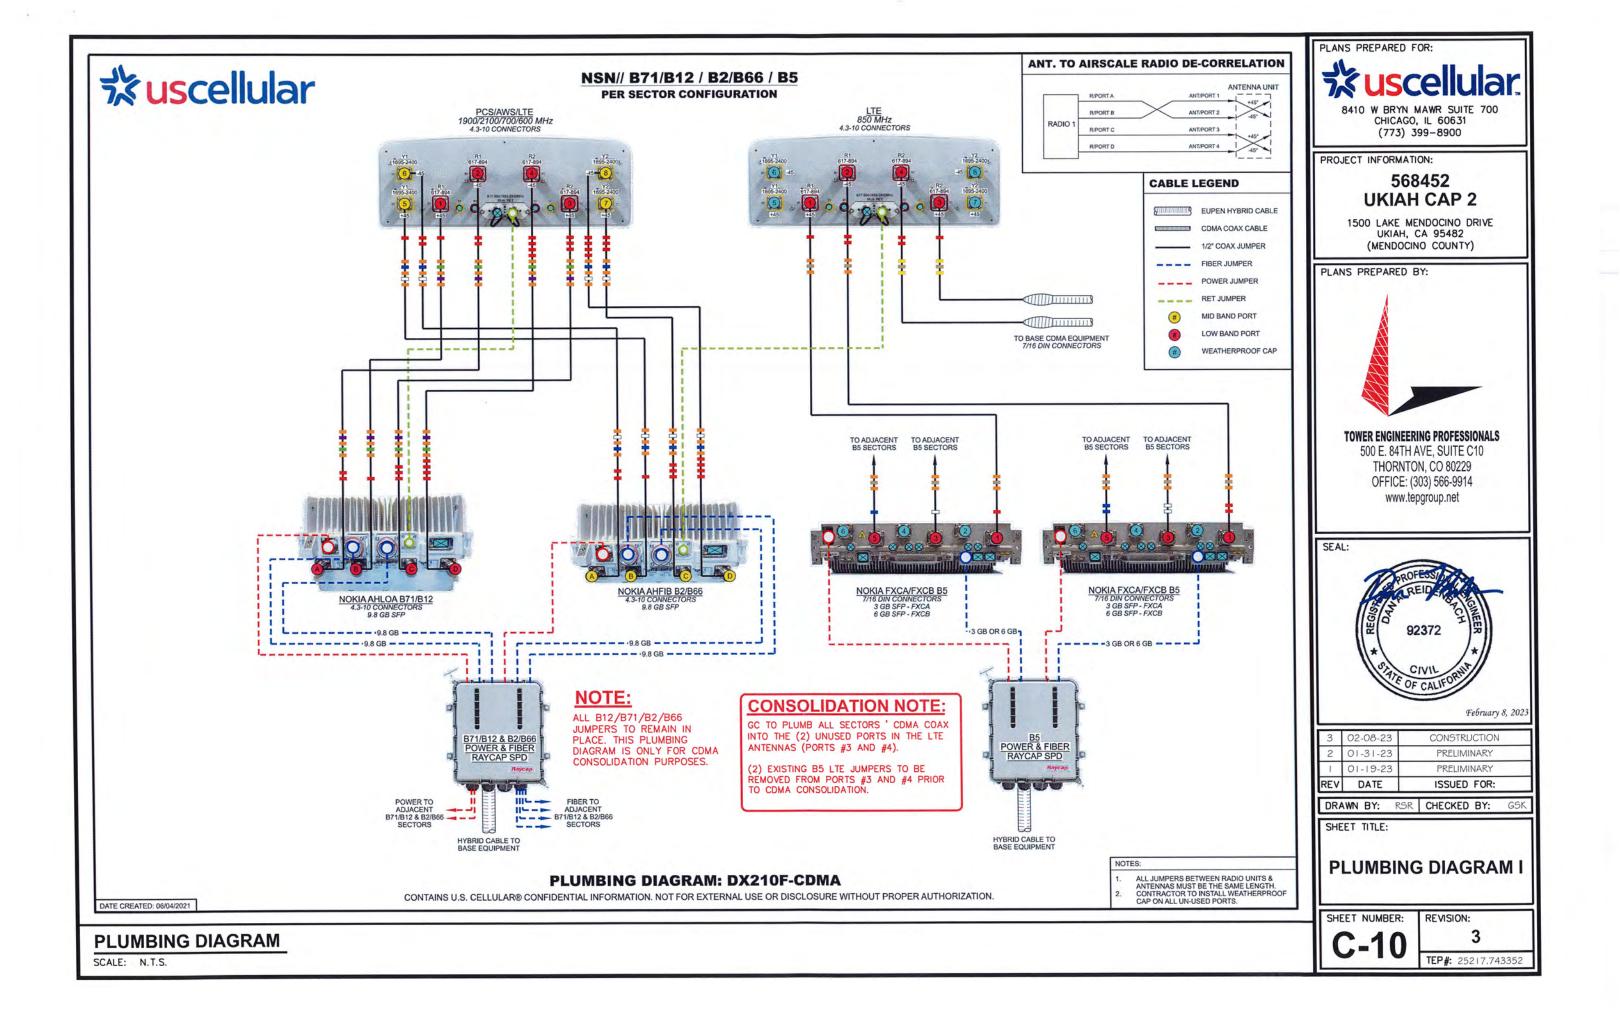SCALE: N.T.S.




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### NOTES:

- 1. UNUSED PORTS TO BE CAPPED. CAPS INCLUDED WITH EQUIPMENT PURCHASE. CONTRACTOR TO SUPPLY IF NECESSARY.
- 2. SEE TOWER ELEVATION FOR SPECIFIC JUMPER LENGTHS AND SIZES.
- ALL JUMPERS BETWEEN RRH AND ANTENNA MUST BE THE SAME LENGTH (PER SECTOR).
- 4. EXCESS JUMPER AND RET CABLES TO BE SECURED WITH GROMMETS AND SNAP-INS. VELCRO MAY NOT BE
- 5. CONTRACTOR TO USE STRANDED INSULATED GROUND LEAD #6. SPECIFIED BY MANUFACTURER.

### NSN// C-BAND & DoD WITH DEDICATED RAYCAP SPD PER SECTOR CONFIGURATION

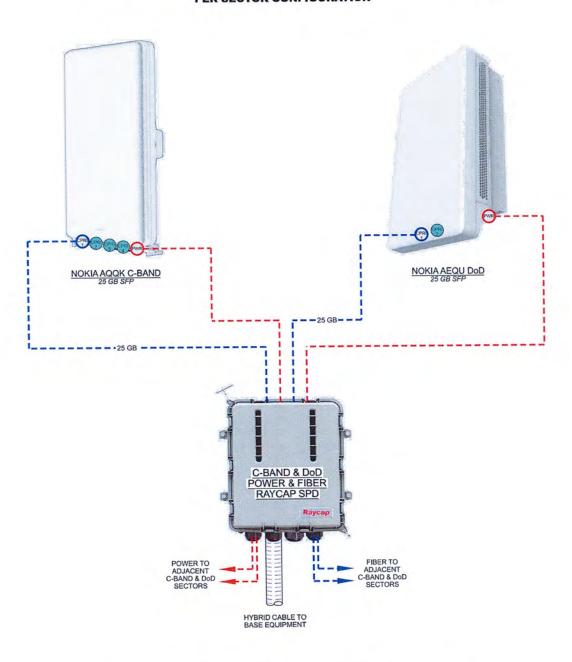

### **CABLE LEGEND**

EUPEN HYBRID CABLE ---- FIBER JUMPER

--- POWER JUMPER WEATHERPROOF CAP **PLUMBING DIAGRAM: NOKIA C-BAND & DoD** 

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### **PLUMBING DIAGRAM**

SCALE: N.T.S.

PLANS PREPARED FOR:

8410 W BRYN MAWR SUITE 700 CHICAGO, IL 60631 (773) 399-8900

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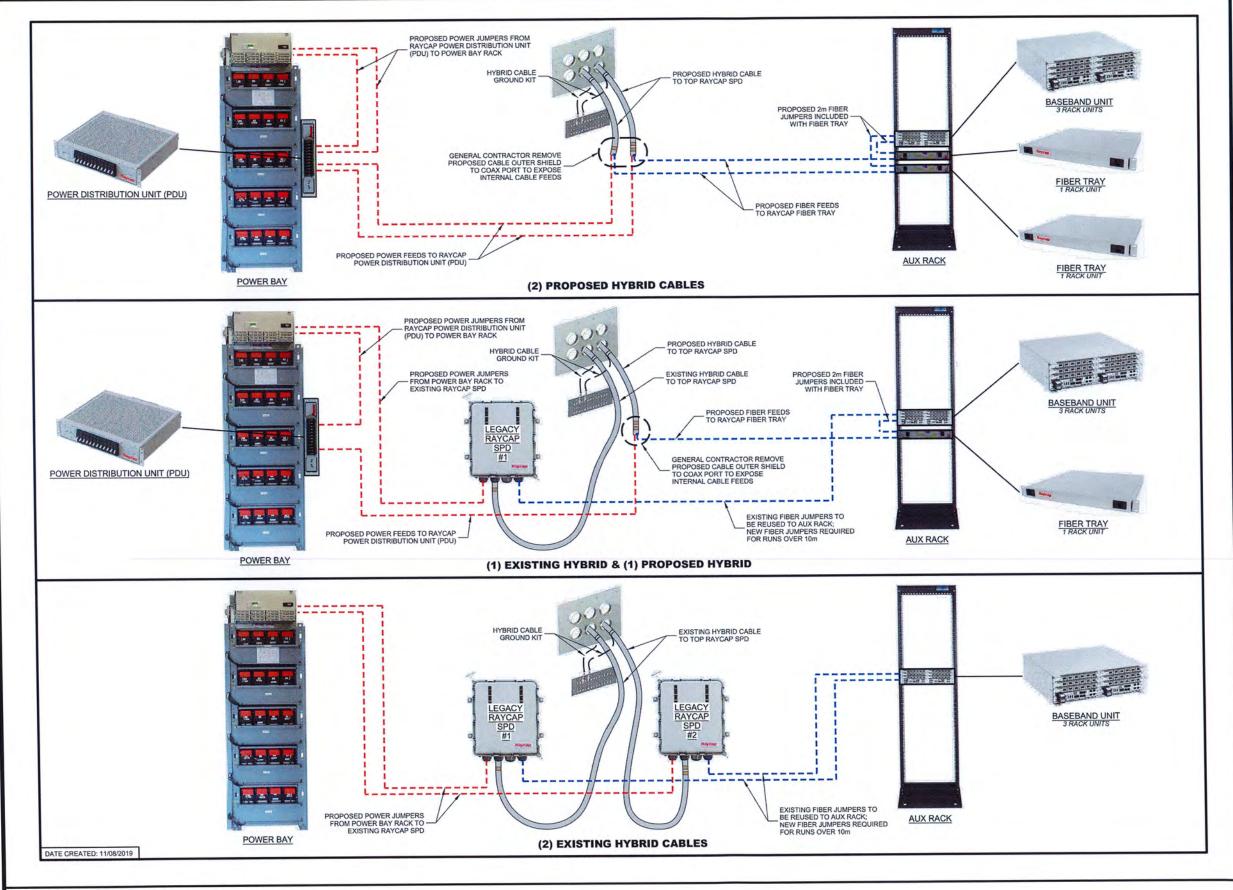
SHEET TITLE:

PLUMBING DIAGRAM II

SHEET NUMBER:

REVISION:

TEP#: 25217.743352



SHELTER BLOCK DIAGRAM

SCALE: N.T.S.

SHEET NUMBER:

C-12

02-08-23

01-31-23

01-19-23

DATE

DRAWN BY: SHEET TITLE:

REV

PLANS PREPARED FOR:

PROJECT INFORMATION:

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SEAL:

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568452

**UKIAH CAP 2** 

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(MENDOCINO COUNTY)

TOWER ENGINEERING PROFESSIONALS

500 E. 84TH AVE, SUITE C10

THORNTON, CO 80229 OFFICE: (303) 566-9914 www.tepgroup.net

92372

REVISION:

SHELTER BLOCK

**DIAGRAM** 

TEP#: 25217.743352

February 8, 202

CONSTRUCTION

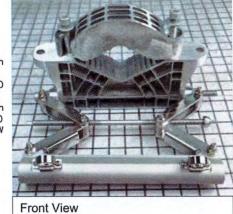
PRELIMINARY PRELIMINARY

ISSUED FOR:

#### NOTE:

KIT INCLUDES:

- (8) M8-1.25x20mm HEX BOLTS
- (4) M10-1.50x150mm SOCKET HEAD SCREWS W/ATTACHED FLAT WASHERS
- (1) M10-1.50x300mm PARTIALLY THREADED SOCKET HEAD SCREW





# Front View

LOWER MOUNTING BRACKET

## **SXK 109 2065/1 MOUNTING KIT**

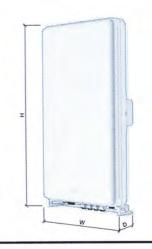
SCALE: N.T.S.

#### **AIRSCALE MAA DIMENSIONS**

MODEL	HEIGHT (H) x WIDTH (W) x DEPTH (D)
AQQK (1H2022) 64T64R	1001 x 448 x 113 mm

#### **AIRSCALE MAA & MOUNTING KIT WEIGHT**

MODEL	TYPE	WEIGHT
AQQK (1H2022) 64T64R	ANTENNA/RADIO	36 kg
AMPF	MOUNTING KIT	6.5 kg



# **NOKIA AQQK CBAND RRH W/ INTEGRATED ANTENNA**

SCALE: N.T.S.

#### **AIRSCALE MAA DIMENSIONS**

1	MODEL	HEIGHT (H) x WIDTH (W) x DEPTH (D)
	AEQU (1H2022) 64T64R	750 x 450 x 240 mm

#### **AIRSCALE MAA & MOUNTING KIT WEIGHT**

MODEL	TYPE	WEIGHT
AEQU (1H2022) 64T64R	ANTENNA/RADIO	45 kg
AMPF	MOUNTING KIT	6.5 kg

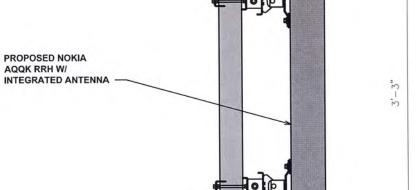


# **NOKIA AEQU DoD RRH W/ INTEGRATED ANTENNA**

SCALE: N.T.S.

### NOTE:

GC TO ALIGN T/CBAND WITH T/LTE ANTENNAS AND B/DoD WITH B/LTE ANTENNAS TO MAXIMIZE THE DISTANCE BETWEEN CBAND AND DoD.



MANUFACTURER SUPPLIED ANTENNA MOUNTING BRACKETS (NOKIA AMFP)

PROPOSED MOUNT PIPE

PROPOSED NOKIA AEQU RRH W/ INTEGRATED ANTENNA

**ANTENNA MOUNTING DETAILS** 

SCALE: N.T.S.

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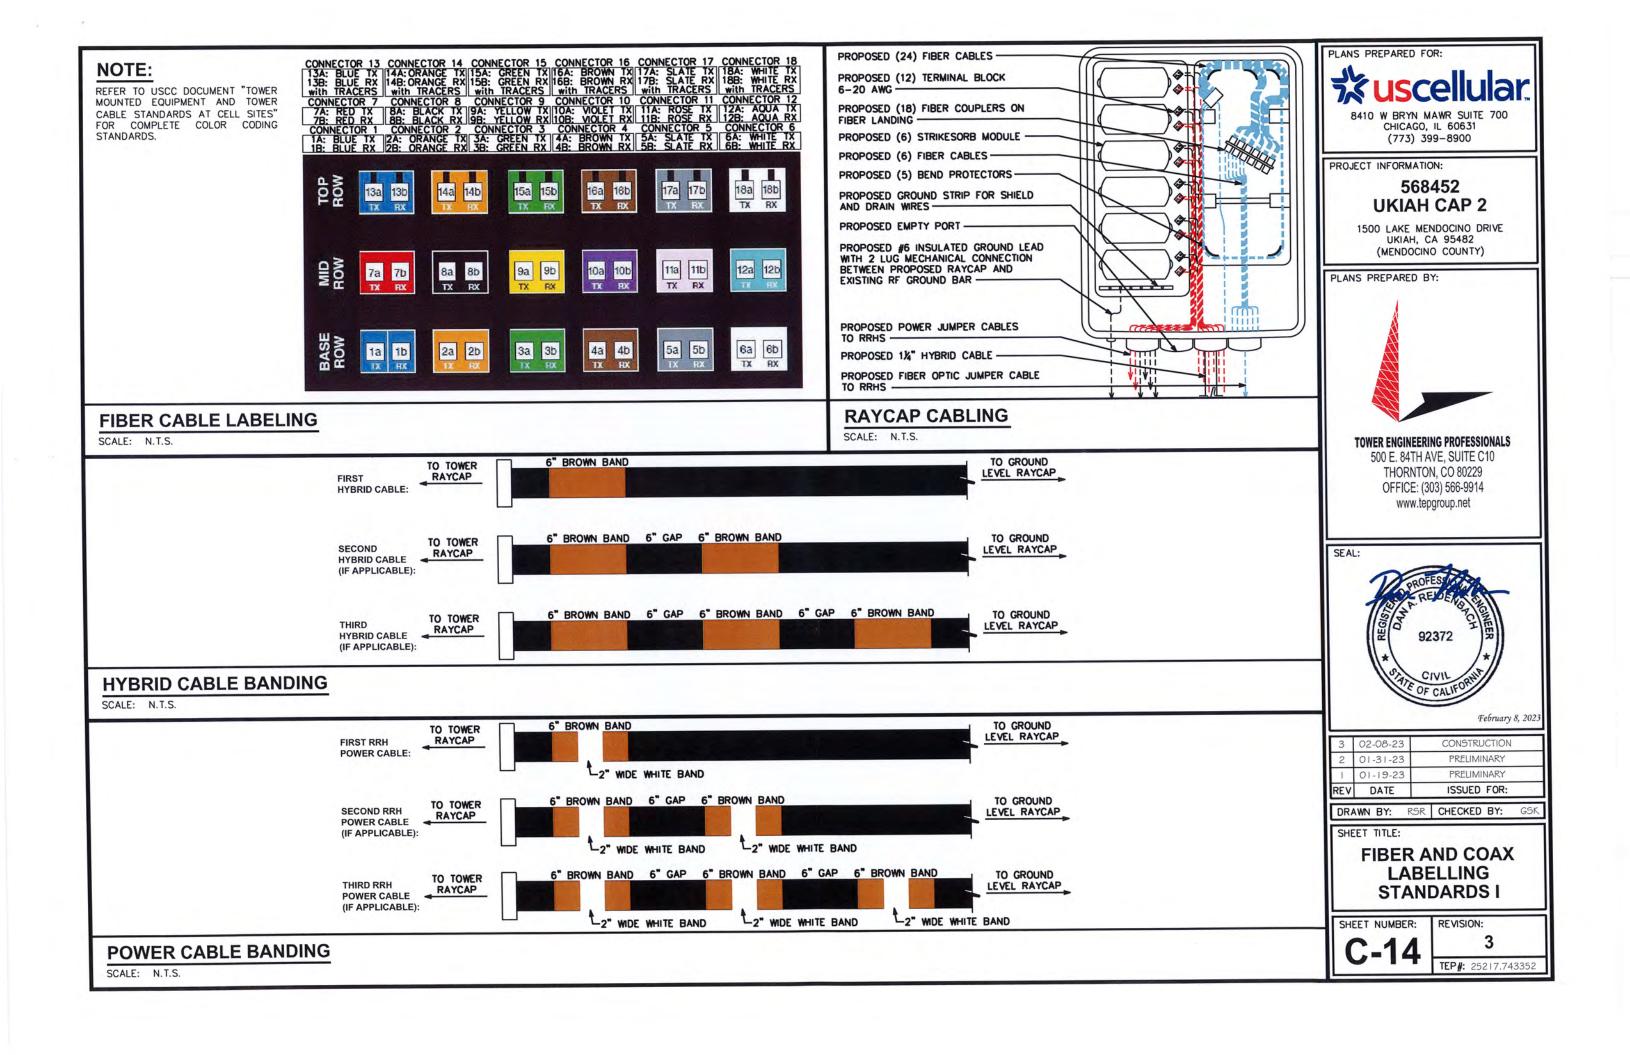
SHEET TITLE:

C-BAND AND DOD **SPECIFICATIONS** 

SHEET NUMBER:

REVISION:

TEP#: 25217.743352



	Sector Band Assignments	(Most Common Case: Single Tec	chnology within the Sector)		
Sector Band	Assigned Color	Line 1	Line 2	Line 3	Line 4
Alpha (Sector 1)	red	1 red band	2 red bands	3 red bands	4 red bands
Beta (Sector 2)	white	1 white band	2 white bands	3 white bands	4 white bands
Gamma (Sector 3)	blue	1 blue band	2 blue bands	3 blue bands	4 blue bands
Delta (Sector 4, if applicable)	green:	1 green band	2 green bands	3 green bands	4 green bands
Epsilon (Sector 5, if applicable)	violet	1 violet band	2 violet bands	3 violet bands	4 violet bands
Zeta (Sector 6, if applicable)	brown	1 brown band	2 brown bands	3 brown bands	4 brown bands

## **FREQUENCY BAND**

FREQUENCY	FREQUENCY BAND
700 (B12)	GREEN
800 (B5)	BROWN
1900 (B2)	BLUE
2100 (B4 & B66)	WHITE
5100 (B66)-LAA	GREY
600 (B71)	VIOLET
3500 (B48)-CBRS	RED

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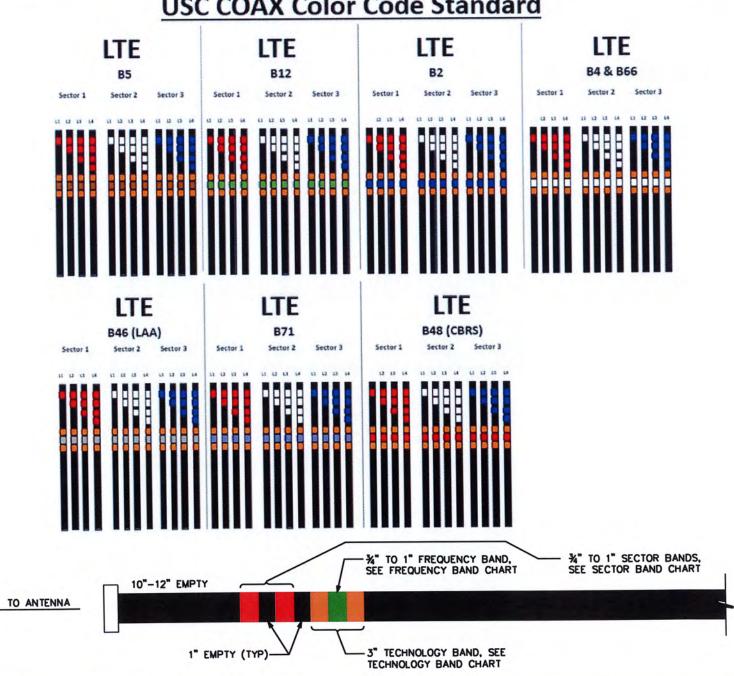
**FIBER AND COAX** LABELLING **STANDARDS II** 

SHEET NUMBER:


REVISION:

TEP#: 25217.743352

**USC COAX Color Code Standard** 


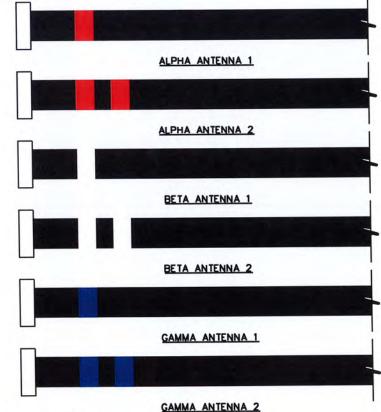
#### **RET SECTOR BAND** LINE 1 - FIRST **LINE 2 - FIRST** SECTOR **TECHNOLOGY TECHNOLOGY** (2) RED BAND (1) RED BAND ALPHA (1) WHITE BAND (2) WHITE BAND BETA (2) BLUE BAND GAMMA (1) BLUE BAND



# **RET CABLE BANDING**

SCALE: N.T.S.

# **COAX CABLE BANDING**

SCALE: N.T.S.

#### **GENERAL NOTES:**

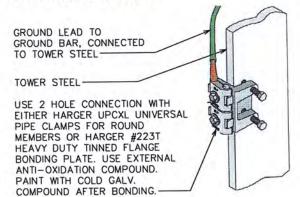
- 1. ALL REFERENCES TO OWNER IN THESE DOCUMENTS SHALL BE CONSIDERED U.S. CELLULAR OR IT'S DESIGNATED REPRESENTATIVE
- 2. ALL WORK PRESENTED ON THESE DRAWINGS MUST BE COMPLETED BY THE CONTRACTOR UNLESS NOTED OTHERWISE. THE CONTRACTOR MUST HAVE CONSIDERABLE EXPERIENCE IN PERFORMANCE OF WORK SIMILAR TO THAT DESCRIBED HEREIN. BY ACCEPTANCE OF THIS ASSIGNMENT, THE CONTRACTOR IS ATTESTING THAT HE DOES HAVE SUFFICIENT EXPERIENCE AND ABILITY, THAT HE IS KNOWLEDGEABLE OF THE WORK TO BE PERFORMED AND THAT HE IS PROPERLY LICENSED AND PROPERLY REGISTERED TO DO THIS WORK IN THE STATE OF CALIFORNIA.
- 3. STRUCTURE IS DESIGNED IN ACCORDANCE WITH ANSI/TIA-222-H, AND THE REQUIREMENTS OF THE CALIFORNIA BUILDING CODE, 2022 EDITION.
- 4. WORK SHALL BE COMPLETED IN ACCORDANCE WITH THE CALIFORNIA BUILDING CODE, 2022 EDITION.
- UNLESS SHOWN OR NOTED OTHERWISE ON THE CONTRACT DRAWINGS, OR IN THE SPECIFICATIONS, THE FOLLOWING NOTES SHALL APPLY TO THE MATERIALS LISTED HEREIN, AND TO THE PROCEDURES TO BE USED ON THIS PROJECT.
- ALL HARDWARE ASSEMBLY MANUFACTURER'S INSTRUCTIONS SHALL BE FOLLOWED EXACTLY AND SHALL SUPERCEDE ANY CONFLICTING NOTES ENCLOSED HEREIN.
- 7. IT IS THE CONTRACTOR'S SOLE RESPONSIBILITY TO DETERMINE ERECTION PROCEDURE AND SEQUENCE TO INSURE THE SAFETY OF THE STRUCTURE AND IT'S COMPONENT PARTS DURING ERECTION AND/OR FIELD MODIFICATIONS. THIS INCLUDES, BUT IS NOT LIMITED TO, THE ADDITION OF TEMPORARY BRACING, GUYS OR TIE DOWNS THAT MAY BE NECESSARY. SUCH MATERIAL SHALL BE REMOVED AND SHALL REMAIN THE PROPERTY OF THE CONTRACTOR AFTER THE COMPLETION OF THE PROJECT.
- 8. ALL DIMENSIONS, ELEVATIONS, AND EXISTING CONDITIONS SHOWN ON THE DRAWINGS SHALL BE FIELD VERIFIED BY THE CONTRACTOR PRIOR TO BEGINNING ANY MATERIALS ORDERING, FABRICATION OR CONSTRUCTION WORK ON THIS PROJECT. CONTRACTOR SHALL NOT SCALE CONTRACT DRAWINGS IN LIEU OF FIELD VERIFICATIONS. ANY DISCREPANCIES SHALL BE IMMEDIATELY BROUGHT TO THE ATTENTION OF THE OWNER AND THE OWNER'S ENGINEER. THE DISCREPANCIES MUST BE RESOLVED BEFORE THE CONTRACTOR IS TO PROCEED WITH THE WORK. THE OWNER SHALL HAVE A SET OF APPROVED. PLANS AVAILABLE AT THE SITE AT ALL TIMES WHILE WORK IS BEING PERFORMED. A DESIGNATED RESPONSIBLE EMPLOYEE SHALL BE AVAILABLE FOR CONTACT BY GOVERNING AGENCY INSPECTORS. THE CONTRACT DOCUMENTS DO NOT INDICATE THE METHOD OF CONSTRUCTION. THE CONTRACTOR SHALL SUPERVISES AND DIRECT THE WORK AND SHALL BE SOLELY RESPONSIBLE FOR ALL CONSTRUCTION MEANS, METHODS, TECHNIQUES, SEQUENCES, AND PROCEDURES. OBSERVATION VISITS TO THE SITE BY THE OWNER AND/OR THE ENGINEER SHALL NOT INCLUDE INSPECTION OF THE PROTECTIVE MEASURES OR THE PROCEDURES.
- 9. ALL MATERIALS AND EQUIPMENT FURNISHED SHALL BE NEW AND OF GOOD QUALITY, FREE FROM FAULTS AND DEFECTS AND IN CONFORMANCE WITH THE CONTRACT DOCUMENTS. ANY AND ALL SUBSTITUTIONS MUST BE PROPERLY APPROVED AND AUTHORIZED IN WRITING BY THE OWNER AND ENGINEER PRIOR TO INSTALLATION. THE CONTRACTOR SHALL FURNISH SATISFACTORY EVIDENCE AS TO THE KIND AND QUALITY OF THE MATERIALS AND EQUIPMENT BEING SUBSTITUTED.
- 10. THE CONTRACTOR SHALL BE RESPONSIBLE FOR INITIATING, MAINTAINING, AND SUPERVISING ALL SAFETY PRECAUTIONS AND PROGRAMS IN CONNECTION WITH THE WORK. THE CONTRACTOR IS RESPONSIBLE FOR INSURING THAT THIS PROJECT AND RELATED WORK COMPLIES WITH ALL APPLICABLE LOCAL, STATE, AND FEDERAL SAFETY CODES AND REGULATIONS GOVERNING THIS WORK.
- 11. ACCESS TO THE PROPOSED WORK SITE MAY BE RESTRICTED. THE CONTRACTOR SHALL COORDINATE INTENDED CONSTRUCTION ACTIVITY, INCLUDING WORK SCHEDULE AND MATERIALS ACCESS, WITH THE RESIDENT LEASING AGENT FOR APPROVAL.
- 12. BILL OF MATERIALS AND PART NUMBERS LISTED ON CONSTRUCTION DRAWINGS ARE INTENDED TO AID CONTRACTOR. CONTRACTOR SHALL VERIFY PARTS AND QUANTITIES WITH MANUFACTURER PRIOR TO BIDDING AND/OR ORDERING MATERIALS.
- 13. ALL PERMITS THAT MUST BE OBTAINED ARE THE RESPONSIBILITY OF THE CONTRACTOR. THE CONTRACTOR WILL BE RESPONSIBLE FOR ABIDING BY ALL CONDITIONS AND REQUIREMENTS OF THE PERMITS.
- 14. 24 HOURS PRIOR TO THE BEGINNING OF ANY CONSTRUCTION, THE CONTRACTOR MUST NOTIFY THE APPLICABLE JURISDICTIONAL (STATE, COUNTY OR CITY) ENGINEER.
- 15. THE CONTRACTOR SHALL REWORK (DRY, SCARIFY, ETC.) ALL MATERIAL NOT SUITABLE FOR SUBGRADE IN IT PRESENT STATE. AFTER REWORKING, IF THE MATERIAL REMAINS UNSUITABLE, THE CONTRACTOR SHALL UNDERCUT THIS MATERIAL AND REPLACE WITH APPROVED MATERIAL. ALL SUBGRADES SHALL BE PROOFROLLED WITH A FULLY LOADED TANDEM AXLE DUMP TRUCK PRIOR TO PAVING. ANY SOFTER MATERIAL SHALL BE REWORKED OR REPLACED.

#### STRUCTURAL STEEL NOTES:

- THE FABRICATION AND ERECTION OF STRUCTURAL STEEL SHALL CONFORM TO THE AISC SPECIFICATIONS AND MANUAL OF STEEL CONSTRUCTION, 15TH EDITION.
- 2. UNLESS OTHERWISE NOTED, ALL STRUCTURAL ELEMENTS SHALL CONFORM TO THE FOLLOWING REQUIREMENTS:
  - A. STRUCTURAL STEEL, ASTM DESIGNATION A36 OR GR50.
  - B. ALL BOLTS, ASTM A325 TYPE I GALVANIZED HIGH STRENGTH BOLTS.
  - C. ALL NUTS, ASTM A563 CARBON AND ALLOY STEEL NUTS.
  - D. ALL WASHERS, ASTM F436 HARDENED STEEL WASHERS.
- 3. ALL CONNECTIONS NOT FULLY DETAILED ON THESE PLANS SHALL BE DETAILED BY THE STEEL FABRICATOR IN ACCORDANCE WITH AISC SPECIFICATIONS AND MANUAL OF STEEL CONSTRUCTION, 15TH EDITION.
- 4. HOLES SHALL NOT BE FLAME CUT THRU STEEL UNLESS APPROVED BY THE ENGINEER.
- HOT-DIP GALVANIZE ALL ITEMS UNLESS OTHERWISE NOTED, AFTER FABRICATION WHERE PRACTICABLE. GALVANIZING: ASTM A123, ASTM, A153/A153M OR ASTM A653/A653M, G90, AS APPLICABLE.
- 6. REPAIR DAMAGED SURFACES WITH GALVANIZING REPAIR METHOD AND PAINT CONFORMING TO ASTM A780 OR BY APPLICATION OF STICK OR THICK PASTED MATERIAL SPECIFICALLY DESIGNED FOR REPAIR OF GALVANIZING. CLEAN AREAS TO BE REPAIRED AND REMOVE SLAG FROM WELDS. HEAT SURFACES TO WHICH STICK OR PASTE MATERIAL IS APPLIED, WITH A TORCH TO A TEMPERATURE SUFFICIENT TO MELT THE METALLICS IN STICK OR PASTED; SPREAD MOLTEN MATERIAL UNIFORMLY OVER SURFACES TO BE COATED AND WIPE OFF EXCESS MATERIAL.
- 7. A NUT LOCKING DEVICE SHALL BE INSTALLED ON ALL PROPOSED AND/OR REPLACED BOLTS.
- 8. ALL PROPOSED AN/OR REPLACED BOLTS SHALL BE OF SUFFICIENT LENGTH TO EXCLUDE THE THREADS FROM THE SHEAR PLANE.
- 9. ALL PROPOSED AND/OR REPLACED BOLTS SHALL BE OF SUFFICIENT LENGTH SUCH THAT THE END OF THE BOLT BE AT LEAST FLUSH WITH THE FACE OF THE NUT. IT IS NOT PERMITTED FOR THE BOLT END TO BE BELOW THE FACE OF THE NUT AFTER TIGHTENING IS COMPLETED.
- 10. ALL ASSEMBLY AND ANCHOR BOLTS ARE TO BE TIGHTENED TO A "SNUG TIGHT" CONDITION AS DEFINED IN SECTION 8.1 OF THE AISC, "SPECIFICATION FOR STRUCTURAL JOINTS USING ASTM A325 OR A490 BOLTS", DATED JUNE 30, 2004.
- 11. FLAT WASHERS ARE TO BE INSTALLED WITH BOLTS OVER SLOTTED HOLES.
- 12. DO NOT OVER TORQUE ASSEMBLY BOLTS. GALVANIZING ON BOLTS, NUTS, AND STEEL PARTS ; MAY ACT AS A LUBRICANT, THUS OVER TIGHTENING MAY OCCUR AND MAY CAUSE BOLTS TO CRACK AND SNAP OFF.
- 13. PAL NUTS ARE TO BE INSTALLED AFTER NUTS ARE TIGHT AND WITH EDGE LIP OUT. PAL NUTS ARE NOT REQUIRED WHEN SELF-LOCKING NUTS ARE PROVIDED.
- 14. GALVANIZED ASTM A325 BOLTS SHALL NOT BE REUSED.
- 15. ALL WELDING SHALL BE IN ACCORDANCE WITH THE AWS D1.1: 2020, STRUCTURAL WELDING CODE-REINFORCING STEEL. ALL WELDERS SHALL DISPLAY PROPER CERTIFICATION OF QUALIFICATION.

### **GROUNDING NOTES:**

- ALL CADWELD CONNECTIONS TO GALVANIZED MATERIAL SHALL BE PROPERLY PREPARED TO ASSURE A SATISFACTORY CADWELD.
- 2. CADWELD CONNECTION SHALL BE COATED WITH COLD GALVANIZING SPRAY.
- 3. ALL VERTICAL JUMPERS SHALL NOT BE WELDED WITHIN TWO FT OF THE GROUND ROD.
- 4. SECTOR GROUNDING DIAGRAM:





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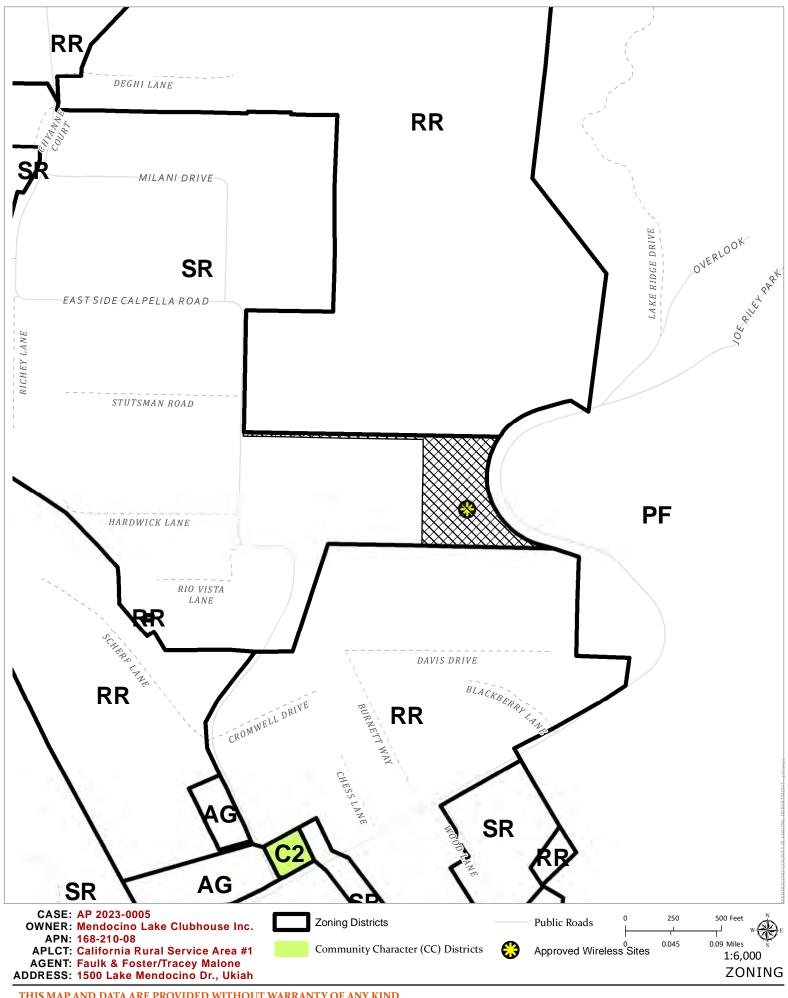
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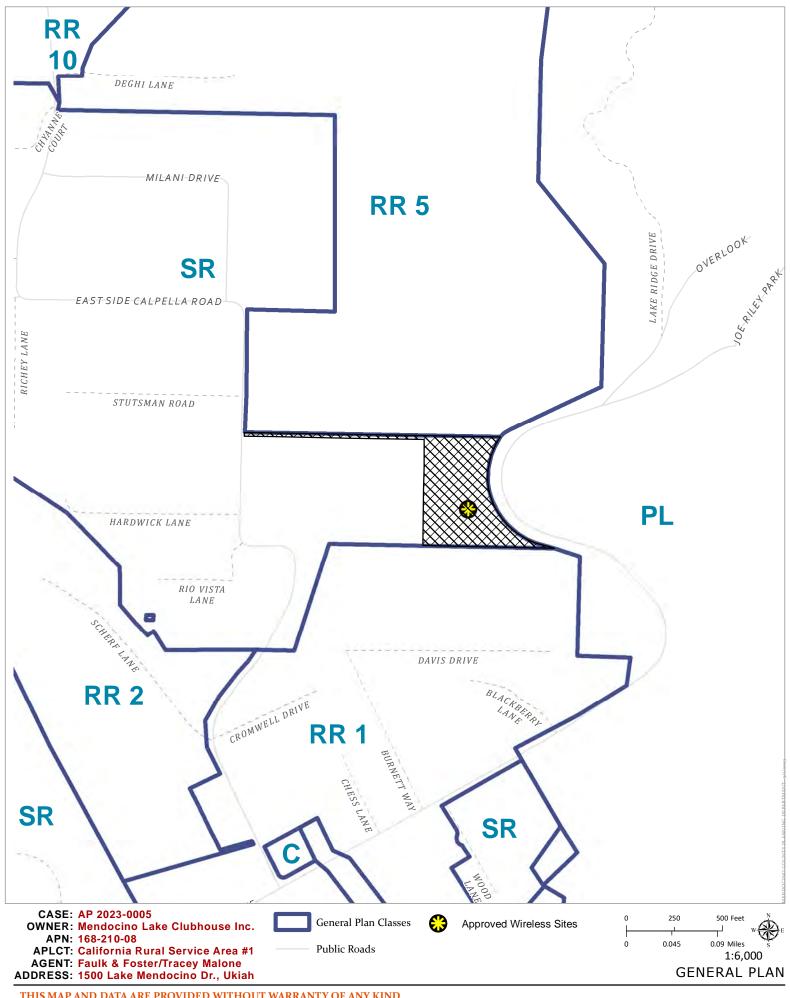
**GENERAL NOTES** 

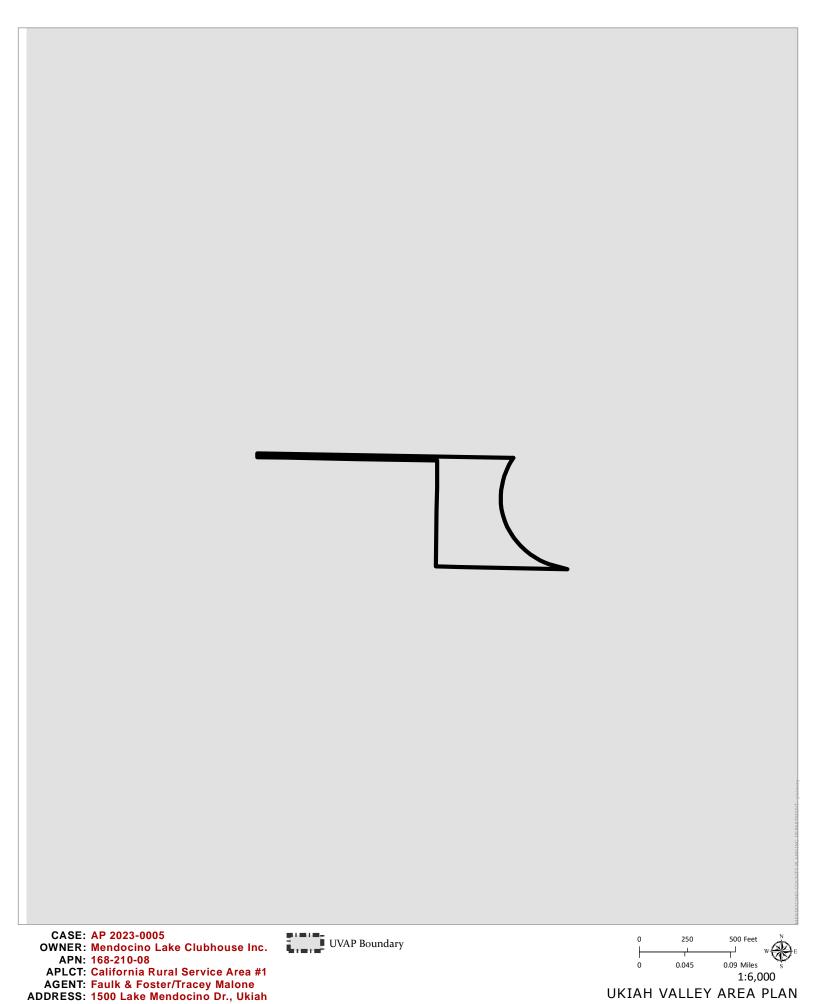
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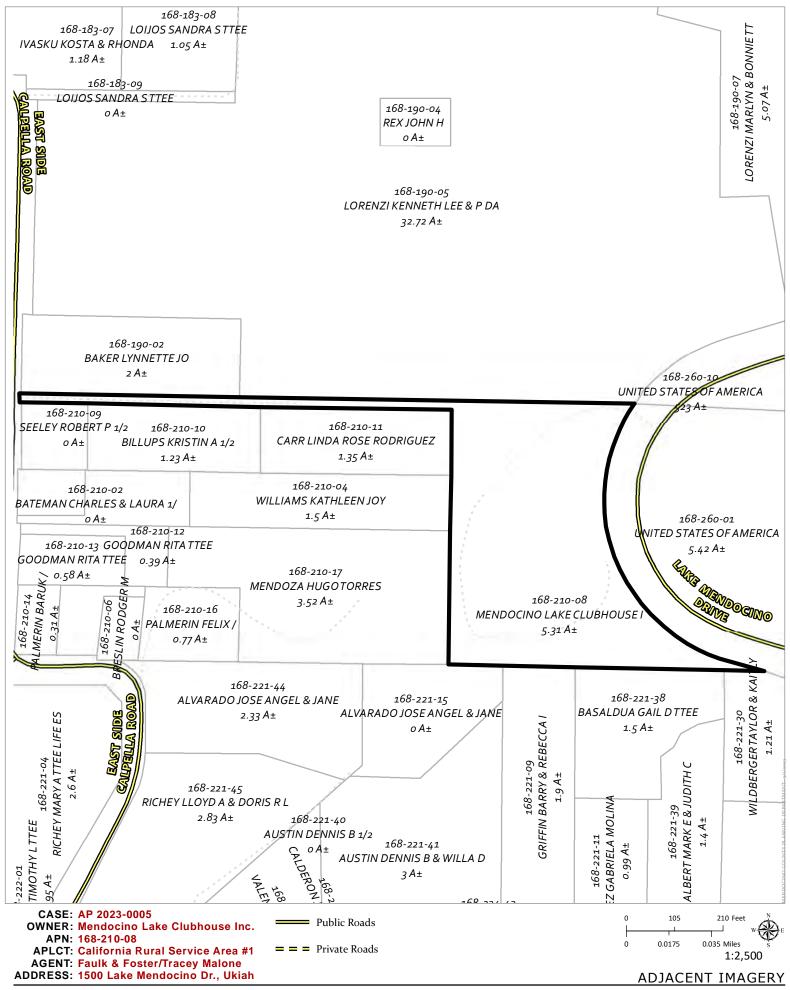
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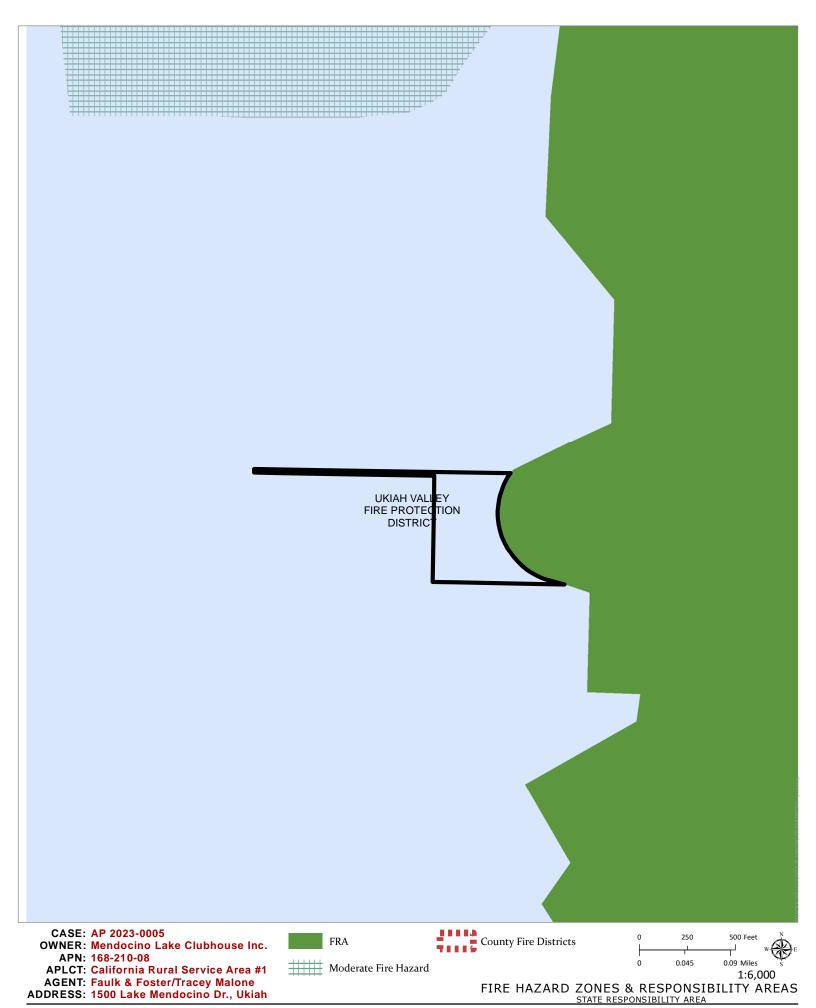






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