COUNTY OF MENDOCINO DEPARTMENT OF PLANNING AND BUILDING SERVICES

860 North Bush Street · Ukiah · California · 95482 120 West Fir Street · Ft. Bragg · California · 95437 JULIA KROG, DIRECTOR TELEPHONE: 707-234-6650 FAX: 707-463-5709 FB PHONE: 707-964-5379 FB FAX: 707-961-2427 pbs@mendocinocounty.org/pbs www.mendocinocounty.org/pbs

March 02, 2023

Department of Transportation Environmental Health - Fort Bragg Building Inspection - Fort Bragg Assessor Archaeological Commission Resource Lands Protection Committee Department of Forestry/ CalFire
-Land Use
Department of Fish and Wildlife
Hopland Municipal Advisory Council
County Addresser
Cloverdale Rancheria

Redwood Valley Rancheria Sherwood Valley Band of Pomo Indians Hopland Rural Fire Protection District Sonoma state University

Date __

CASE#: U_2023-0003

DATE FILED: 1/23/2023

OWNER: JOHN FETZER

APPLICANT: MARC TAUB

AGENT: STEPHANIE STRAWHACKER, MH ARCHITECTS

REQUEST: Conversion of an existing barn into a two-story facility for Transient Habitation (lodging – limited),

with five guestrooms and other improvements.

LOCATION: 1.4± miles north-northwest of Hopland town center, on the west side of a private drive off the northwest end of Hewlitt & Sturtevant Road (CR 112), 0.5 miles northwest of its (CR 112's) intersection with Rd

112A (CR 112A); located at 11704 Hewlitt & Sturtevant Rd, Hopland.

SUPERVISORIAL DISTRICT: 5

Signature

STAFF PLANNER: ROB FITZSIMMONS **RESPONSE DUE DATE:** March 16, 2023

PROJECT INFORMATION CAN BE FOUND AT:

www.mendocinocounty.org

Select "Government" from the drop-down; then locate Planning and Building Services/Public Agency Referrals.

Mendocino County Planning & Building Services is soliciting your input, which will be used in staff analysis and forwarded to the appropriate public hearing. You are invited to comment on any aspect of the proposed project(s). Please convey any requirements or conditions your agency requires for project compliance to the project coordinator at the above address, or submit your comments by email to pbs@mendocinocounty.org. Please note the case number and name of the project coordinator with all correspondence to this department.

| r lease note the case number and name of the project coordinator with all correspondence to this department. |
|---|
| We have reviewed the above application and recommend the following (please check one): |
| ☐ No comment at this time. |
| Recommend conditional approval (attached). |
| Applicant to submit additional information (attach items needed, or contact the applicant directly, copying Planning and Building Services in any correspondence you may have with the applicant) |
| Recommend denial (Attach reasons for recommending denial). |
| Recommend preparation of an Environmental Impact Report (attach reasons why an EIR should be required). |
| Other comments (attach as necessary). |
| |
| |
| REVIEWED BY: |
| |

Department

CASE: U_2023-0003

OWNER: Sundial Ranch LLC

APPLICANT: Marc Taub

AGENT: Stephanie Strawhacker, MH Architects

REQUEST: Conversion of an existing barn into a two-story facility for Transient Habitation (lodging - limited), with five

guestrooms and other improvements.

LOCATION: 1.4± miles north-northwest of Hopland town center, on the west side of a private drive off the northwest end of

Hewlitt & Sturtevant Road (CR 112), 0.5 miles northwest of its (CR 112's) intersection with Rd 112A (CR 112A);

located at 11704 Hewlitt & Sturtevant Rd, Hopland.

APNs: 048-040-08, 048-080-04, 048-040-07, 048-010-05

PARCEL SIZE: 159.7± acres

GENERAL PLAN: Remote Residential (RMR40), Agricultural Lands (AG40), Rangelands (RL160)

ZONING: Agricultural, Rangeland, Upland Residential

EXISTING USES: Agricultural, Residential

DISTRICT: 5, Williams

LOCAL

| | ADJACENT GENERAL PLAN | ADJACENT ZONING | ADJACENT LOT SIZES | ADJACENT USES |
|--------|------------------------------|------------------------|---------------------------|----------------------|
| NORTH: | RMR:40 | UR | 200± | Agricultural |
| EAST: | AG:40 | AG | 249± | Agricultural |
| SOUTH: | RR:5 | RR | 28.8± | Agricultural |
| WEST: | RL:160 | RL | 182± | Agricultural |
| | | | | |

REFERRAL AGENCIES

| | ≡ | | | |
|-------------------|----------------------------------|---|----------------------------------|--|
| □ Agr | ricultural Commissioner | | Sanitation District | ☐ California State Clearinghouse |
| ☐ Air | Quality Management District | | School District | ☐ CALTRANS |
| ☐ Air | port Land Use Commission | | Water District | ☐ Regional Water Quality Control Board |
| ⊠ Arc | haeological Commission | □ Me | ndocino Transit Authority (MTA) | ☐ Sierra Club |
| ⊠ Ass | essor's Office | □ Pla | nning Division | <u>FEDERAL</u> |
| 🛛 Bui | lding Division Fort Bragg | ⊠ Res | source Lands Protection Com. | ☐ Sierra Club |
| ⊠ Coı | unty Addresser | Sor Sor | noma State University | ☐ US Department of Fish & Wildlife |
| ⊠ De _l | partment of Transportation (DOT) | □Tra | ils Advisory Council | ☐ US Department of Health Services |
| ⊠ En\ | vironmental Health (EH) | STATI | <u> </u> | ☐ US Department of Parks & Recreation |
| □ Far | m Advisor | | LFIRE (Land Use) | ☐ US Natural Resources Conservation |
| ☐ For | estry Advisor | ☐ CAI | LFIRE (Resource Management) | TRIBAL |
| | -co | □ Cal | ifornia Coastal Commission | ☑ Cloverdale Rancheria |
| | City Planning Department | □ Cal | ifornia Div. of Mine Reclamation | ☐ Potter Valley Tribe |
| | | | | |

☑ Hopland MAC

☐ Mendocino City Comm Services Dist

☐ California Div. of Mine Reclamation ☑ California Dept. of Fish & Wildlife

☐ California Highway Patrol

□ California Native Plant Society

☑ Redwood Valley Rancheria

Sherwood Valley Band of Pomo Indians

ADDITIONAL INFORMATION:

The current configuration of the subject parcels was set by the most recent recorded Boundary Line Adjustment on file, B_2017-0062. There is also a more recent Boundary Line Adjustment B_2021-0004 on file, approved but as yet unrecorded, to transfer the southernmost 4.6 acres of the parcel to the parcel to the south This Boundary Line Adjustment will expire on April 8, 2023 if no further action is taken on it.

Per the applicant, the barn was partially converted into a habitation prior to ownership changing hands, but there is no County record of a permit for this work. Assessor's records suggest this may have occurred sometime prior to 2003. The applicant proposes remodeling the entire structure, including the unfinished areas, but this requires legalizing the use, hence the application for U 2023-0003.

STAFF PLANNER: ROB FITZSIMMONS DATE:

ENVIRONMENTAL DATA

1. MAC:

GIS

HOPLAND

2. FIRE HAZARD SEVERITY ZONE:

CALFIRE FRAP maps/GIS

Moderate/High

3. FIRE RESPONSIBILITY AREA:

CALFIRE FRAP maps/GIS

State Responsibility Area

4. FARMLAND CLASSIFICATION:

GIS

Grazing Land; Rural Residential & Rural Commercial; Prime Farmland; Unique Farmland

5. FLOOD ZONE CLASSIFICATION:

FEMA Flood Insurance Rate Maps (FIRM)

NO

6. COASTAL GROUNDWATER RESOURCE AREA:

Coastal Groundwater Study/GIS

NO

7. SOIL CLASSIFICATION:

Mendocino County Soils Study Eastern/Western Part

178 - Pinole gravelly loam, 2-8% slopes

142 - Hopland Ioam, 50-75% slopes

235 – Yorkville-Yorktree-Squawrock complex, 30-50% slopes

156 – Maxwell clay, 0-9% slopes

233 - Yorktree-Squawrock-Witherell complex, 30-50% slopes

136 – Henneke-Montara complex 15-50% slopes

228 - Yorktree-Yorkville loams, 30-50% slopes

8. PYGMY VEGETATION OR PYGMY CAPABLE SOIL:

LCP maps, Pygmy Soils Maps; GIS

NO

9. WILLIAMSON ACT CONTRACT:

GIS/Mendocino County Assessor's Office

YES

10. TIMBER PRODUCTION ZONE:

GIS

NO

11. WETLANDS CLASSIFICATION:

GIS

NO (Riverine nearby)

12. EARTHQUAKE FAULT ZONE:

Earthquake Fault Zone Maps; GIS

NO

13. AIRPORT LAND USE PLANNING AREA:

Airport Land Use Plan; GIS

NO

14. SUPERFUND/BROWNFIELD/HAZMAT SITE:

GIS: General Plan 3-11

NO

15. NATURAL DIVERSITY DATABASE:

CA Dept. of Fish & Wildlife Rarefind Database/GIS YES (500+ feet from project site)

123 (300) jeet from project site;

16. STATE FOREST/PARK/RECREATION AREA ADJACENT:

GIS; Ger

17. LANDSLIDE HAZARD:

Hazards and Landslides Map; GIS; Policy RM-61; General Plan 4-44

NO

18. WATER EFFICIENT LANDSCAPE REQUIRED:

Policy RM-7; General Plan 4-34

NO

19. WILD AND SCENIC RIVER:

www.rivers.gov (Eel Only); GIS

NC

20. SPECIFIC PLAN/SPECIAL PLAN AREA:

Various Adopted Specific Plan Areas; GIS

NO

21. STATE CLEARINGHOUSE REQUIRED:

Policy

NO

22. OAK WOODLAND AREA:

USDA YES

23. HARBOR DISTRICT:

Sec. 20.51

NO



APPLICANT:

PLANNING & BUILDING SERVICES

| CASE NO: | U 2023 · 0003 | |
|--------------|-----------------|--|
| DATE FILED: | 1 23 23 | |
| FEE: | \$9,894 | |
| RECEIPT NO: | 54108 | |
| RECEIVED BY: | MC | |
| | Office Use Only | |

APPLICATION FORM

| Marc Taub | | | Phone: 516-802- | 4702 |
|--|-----------------------------------|-------|---|---|
| Mailing Address: 48 Ha | rbor Park Driv | ve | | |
| City: Port Washing | | | _{Email:} m@tauk | ofamilyco.com |
| PROPERTY OWNER: | | | | |
| Name: Heritance Vitners, L | LC | | Phone: 516-802- | 4702 |
| Mailing Address: | | | | |
| City: | State/Zip: | | Email: | |
| AGENT: | | | | |
| Name: Stephanie Strawhacke | er, MH Architects | | Phone: 51648027 | 4 1 702 xt 104 |
| Mailing Address: 2325 Th | ird Street #426 | | | |
| City: San Francisco | State/Zip: | 94109 | stephanie Email: | e@matthollis.com |
| ASSESSOR'S PARCEL N | IUMBER/S: | | | |
| TYPE OF APPLICATION | lt i | | | |
| ☐ Administrative Permit☐ Agricultural Preserve: N☐ Agricultural Preserve: N☐ Agricultural Preserve: N☐ Airport Land Use☐ Development Review☐ Exception☐ Flood Hazard Development | Cancellation Sescind & ReEnter | | n – Minor n – Major n – Parcel n – Re-Subdivision n of Conditions | ☐ Use Permit — Cottage ☐ Use Permit — Minor ☐ Use Permit — Major ☐ Use Permit — Modification ☐ Variance ☐ Other |

I certify that the information submitted with this application is true and accurate.



SITE AND PROJECT DESCRIPTION QUESTIONNAIRE

The purpose of this questionnaire is to relate information concerning your application to the Department of Planning and Building Services and other agencies who will be reviewing your project proposal. Please remember that the clearer picture that you give us of your project and the site, the easier it will be to promptly process your application. Please answer all questions. Those questions which do not pertain to your project please indicate "Not applicable" or "N/A".

THE PROJECT

| 1. Describe your project. Include se | econdary improvemen | ts such as wells, septic | systems, grading, v | vegetation removal | , roads, etc. |
|--|---------------------------|---------------------------|------------------------|------------------------|-------------------|
| Approval sought to use ~ 4,000 sf exi | sting structure with 345 | sf of covered outdoor s | pace for use as Trai | nsient Habitation - Lo | odging (limited). |
| Proposed building area is 5,175 sf - | - 1075 of covered outd | oor area which include | s the demolition an | d replacement of ex | disting finishes, |
| an indoor and outdoor kitchen, wir | ne cellar, pantry, five I | pedrooms with private | bathroom, and ne | ew bathrooms at co | mmon areas. |
| Site improvements to include new pa | aving for accessible par | king and entry, site circ | ulation, fire pit, and | new plantings of tre | es and shrubs. |
| Existing foundation will be utilized for | minimal grading, new se | eptic system to be propo | osed. Project to be a | ccessed by current p | aved driveway. |
| | | | | | |
| | | | | | |
| | | | | | |
| | | | | | |
| | | | | | |
| | | | | | |
| | | | | | |
| | | | | | |
| 2 Shrushuras/Lat Cayaraga | NO. C | F UNITS | | SQUARE FOOTAGE | |
| 2. Structures/Lot Coverage | EXISTING | PROPOSED | EXISTING | PROPOSED | TOTAL |
| Circle Femilie | | | | | |
| ☐ Single Family ☐ Mobile Home | | | | | |
| ☐ Duplex | | | | | : |
| ☐ Multifamily | | | | | |
| ☐ Other: | | | | | |
| ☐ Other: | | | | | |
| GRAND TOTAL (Equal to gross area | of Parcel): | | | .1 | |
| | | - | | | |
| 3. If the project is commercial, indu | strial or institutional, | complete the following | : | | |
| Estimated No. of Employees per sh | • | | | | |
| Estimated No. of shifts per day: | | | | | |
| Type of loading facilities proposed: | | | | | |

| ll the project ! □ YES | NO If yes, explain your pla | ans for phasing: | |
|---------------------------|---|---------------------------------------|--|
| | | | |
| | | | |
| | | | |
| | | | |
| | | | |
| | | | |
| | | an the building sites and roads? | |
| ☐ YES ■ | NO If no, explain: | | |
| | | | |
| | | | |
| | | | |
| | | | |
| | | | |
| | : | natantially barandays materials | |
| | invoive the use or disposal of NO If yes, explain: | potentially nazardous materials s | such as toxic substances, flammables, or explosives? |
| · | = NO II yes, explain. | | |
| | | | |
| | | | |
| | | | |
| | | | |
| 1 1 3 | No. of covered spaces: No. of uncovered spaces: No. of standard spaces: No. of accessible spaces: Existing no. of spaces: Proposed additional spaces: | 6 uncovered standard 1 accessible | |
| ٦ | Гotal: | 7 | |
| Is any road cons | truction or grading planned? | If yes, grading and drainage plans | s may be required. |
| • | | the terrain to be traversed. (e.g., s | • |
| | | . 5, | |
| ····· | | | |
| | | | |
| | | | |
| | | | |
| | | | |
| . For grading or re | oad construction, complete th | ne following: | |
| Amount of sut | | cubic varde | |
| | | | |
| | | | |
| | fill slope: | | |
| Max. height of | cut slope: | feet | |
| Amount of imp | ort/export: | cubic yards | |
| Location of bor | row or disposal site: | | |

| | Does the pro | eject involve sand removal, mining or gravel extraction? If yes, detailed extraction, reclamation and monitoring plans |
|-----|----------------------------------|---|
| | ☐ YES | ■ NO |
| 11. | Will the prop | oosed development convert land currently or previously used for agriculture to another use? |
| 12. | Will the deve | elopment provide public or private recreation opportunities? NO If yes, explain how: |
| | | The in yes, explain now. |
| | | |
| | | |
| | | |
| 13. | Is the propos | sed development visible from State Highway 1 or other scenic route? |
| 14. | Is the propos | sed development visible from a park, beach or other recreational area? |
| 15. | Does the dev | velopment involve diking, filling, dredging or placing structures in open coastal water, wetlands, estuaries or lakes? |
| | Diking: Filling: Dredging: | ☐ YES ☐ NO ☐ YES ☐ NO ☐ YES ☐ NO |
| | Structures: | ☐ Open Coastal Waters ☐ Wetlands ☐ Estuaries ☐ Lakes |
| | | the amount of material to be dredged/filled?: cubic yards |
| | | redged material disposal site?: |
| | паз а О.З. АП | my Corps of Engineers permit been applied for? VES NO |
| 16. | | e any exterior lighting? \square NO \square If yes, describe below and identify the location of all exterior lighting on the plot and building plans. |
| All | exterior lighti | ng to be code compliant and addressed with building permit. |
| | | |
| | | |
| | | |
| | | |
| 17. | Electricity: | be supplied to the site as follows: Utility Company (service exists to parcel) |
| | · | ☐ Utility Company (requires extension of service to site): feet miles ☐ On Site Generation — Specify: |
| | Gas: | ☐ Utility Company/Tank ☐ On Site Generation – Specify: ☐ None |
| | Talanhona: | □ VES □ NO |

| 18. What will be the method of sewage disposal? | |
|---|-------------|
| ☐ Community Sewage System (specify supplier): ☐ Septic Tank | |
| ☐ Other (specify): | |
| 19. What will be the domestic water source: | |
| Community Water System (specify supplier): | |
| ■ Well | |
| □ Spring | |
| ☐ Other (specify): | |
| 20. Are there any associated projects and/or adjacent properties under your ownership? ■ YES □ NO If yes, explain: (e.g., Assessor's Parcel Number, address, etc.) | |
| 048-010-12 & 13, 048-040-02,04,05, and 048-050-03 formerly known as 48-010-04, 48-040-01, and 48-050-02. | |
| 11684 US-101, 11700-704 US-101 | |
| 11004 03-101, 11700-704 03-101 | |
| | |
| | |
| | |
| 21. List and describe any other related permits and other public approval required for this project, including those required by ot | her |
| County departments, city, regional, State and Federal agencies: | |
| | |
| | |
| | |
| | |
| | · |
| | |
| 22. Describe the location of the site in terms of readily identifiable landmarks: (e.g., mailboxes, mile posts, street intersections, e | tc.) |
| Property is accessed from a paved entrance right off of highway 101. entrance include winery signage, cypress trees, and artificial fountain and p | |
| | |
| | |
| | |
| | |
| | |
| 22. And there existing atmost upon on the managers of five describe heles, and identify the case of each atmost upon on the plat upon | _ |
| 23. Are there existing structures on the property? If yes, describe below and identify the use of each structure on the plot plan o tentative map if the proposal is for a subdivision. | Г |
| ■ YES □ NO | |
| 4,000 sf Single Family Residence with a 1,300 sf garage and 750 sf Pool House; and 1,633 sf caretaker home/office. | |
| 4,000 31 Olligio i altiliy riesidence with a 1,000 31 garage and 730 31 Tool riodse, and 1,000 31 caretaker homeronice. | |
| | |
| | |
| | |
| | |
| | |
| 24. Will any existing structure be demolished or removed? If yes, describe the type of development to be demolished or removed | ∍d, |
| including the relocation site, if applicable. | |
| □ YES ■ NO | |
| | |
| | |
| | |
| | |

| 25. What is the | e maximun | n height of a | ll structures? | ? | | | | | | |
|--|---------------------------------------|-------------------|------------------|--------------------|------------------|----------------------------------|------------------|---------------------------------------|----------------|---------------------------------------|
| | '-8" | | | | | | | | | |
| Proposed: | | feet | | | | | | | | |
| 26. What is the | e gross floc | or areas of al | l structures, | including cov | vered parki | ng and accesso | ory buildings | ? | | |
| Existing: 69 | 946 | square feet | | | | | | | | |
| Proposed: | 7883 | square feet | | | | | | | | |
| 27. What is the | e total lot a | rea within p | roperty lines | s? | | | | | | |
| Total Lot A | rea: <u>14.4</u> | | acres 🗆 squ | uare feet | | | | | | |
| soil stability, p be helpful: Residential and ag | | | | | | | ny photograp | ohs of th | e site that | you feel would |
| | · · · · · · · · · · · · · · · · · · · | | | | | | | | | |
| | | | | | - | | | · · · · · · · · · · · · · · · · · · · | | |
| | | | | | | | | | | |
| 29. Briefly des Indicate the ty be helpful. | | | • | _ | | plants, animal Attach any pho | _ | | | |
| • | de rolling hills o | f vineyards and p | lanes adorned wi | th weeping willows | s, cypress trees | , and native shrubs. | Three large pond | s are prese | nt and are mos | stly incorporated into |
| building orientation | and site expe | rience. | | | *** | | 7 | | | · · · · · · · · · · · · · · · · · · · |
| Danaing Grioritation | Tana one expe | | | | | | | | | |
| | | | | | | | | | | |
| 30. Indicate th | | | | _ | | | | | | |
| | | | | Commercial | | Public Facility | Timberland | Other | | |
| North: | | | \square | | | | | | | |
| East: | | | \square | | | | | | | |
| South: | | | \mathbf{X} | | | | | | | |
| West: | | X | | | | | | | | |
| | | | | | | | | | | |

CERTIFICATION AND SITE VIEW AUTHORIZATION

1. I hereby certify that I have read this completed application and that, to the best of my knowledge, the information in this

| | requested information or any misstaten accept this application, for denying the | s and exhibits, is complete and correct. I undepends submitted in support of the application of the application of the application of the application of the control of the | shall be grounds for either refusing to such |
|----|---|--|--|
| 2. | | anning and Building Services staff and hearing ade in order to obtain information necessary f | |
| | Owner/A | uthorized Agent | Date |
| | OTE: IF SIGNED BY AGENT, <u>OWNER</u> MUST | SIGN BELOW. | |
| | nereby authorize | | to act as my representative |
| aı | nd to bind me in all matters concerning thi | s application. | |
| | | Owner | Date |
| _ | correspondence and/or staff repo | MAIL DIRECTION Ition, please indicate the names and mailing a rts mailed if different from those identified or | Page 1 of the application form. |
| | Name | Name | Name |
| | | | |
| I | Mailing Address | Mailing Address | Mailing Address |

COMPLETE FOR PROJECTS LOCATED IN THE COASTAL ZONE ONLY

DECLARATION OF POSTING

At the time the application is submitted for filing, the applicant must **Post**, at a conspicuous place, easily read by the public and as close as possible to the site of the proposed development, notice that an application for the proposed development has been submitted. Such notice shall contain a general description of the nature of the proposed development and shall be on the standard form provided in the application packet. If the applicant fails to post the completed notice form and sign the **Declaration of Posting**, the Department of Planning and Building Services cannot process the application.

As Proof of Posting, please sign and date this Declaration of Posting form when the site is posted; it serves as proof of posting. It should be returned to the Department of Planning and Building Services with the application. Pursuant to the requirements of Section 20.532.025(H) of the Mendocino County Code, I hereby certify that on ____ (date of posting), I or my authorized representative posted the "NOTICE OF PENDING PERMIT" for application to obtain a Coastal Development Permit for the development of: (Description of development) Located at: (Address of development and Assessor's Parcel Number) The public notice was posted at: (A conspicuous place, easily seen by the public and as close as possible to the site of proposed development) Owner/Authorized Representative Date

(A copy of the notice which was posted shall be attached to this form).

NOTE: YOUR APPLICATION CANNOT BE PROCESSED UNTIL THIS "<u>DECLARATION OF POSTING</u>" IS SIGNED AND RETURNED TO PLANNING AND BUILDING SERVICES.

COMPLETE FOR PROJECTS LOCATED IN THE COASTAL ZONE ONLY

NOTICE OF PENDING PERMIT

| COASTAL PERMIT APPLICATION FOR DEVELOPMENT ON THIS SITE IS PENDING BEFORE THE COUNTY OF ENDOCINO. | A COASTAL PERMIT APPLICA MENDOCINO. |
|---|---|
| OPOSED DEVELOPMENT: | PROPOSED DEVELOPMENT: |
| | |
| | - |
| | |
| | - |
| | |
| | |
| CATION: | LOCATION: |
| | |
| PLICANT: | APPLICANT: |
| SESSOR'S PARCEL NUMBER: | Total Control of the |
| ATE NOTICE POSTED: | DATE NOTICE POSTED: |

FURTHER INFORMATION IS AVAILABLE AT:

COUNTY OF MENDOCINO
DEPARTMENT OF PLANNING & BUILDING SERVICES

pbs@mendocinocounty.org

860 North Bush Street, Ukiah, CA 95482, 707-234-6650

120 West Fir Street, Fort Bragg, CA 95437, 707-964-5379

HOURS: 8:00 - 5:00


Indemnification And Hold Harmless


ORDINANCE NO. 3780, adopted by the Board of Supervisors on June 4, 1991, requires applicants for discretionary land use approvals, to sign the following Indemnification Agreement. Failure to sign this agreement will result in the application being considered incomplete and withheld from further processing.

Indemnification Agreement

As part of this application, applicant agrees to defend, indemnify, release and hold harmless the County of Mendocino, its agents, officers, attorneys, employees, boards and commissions, as more particularly set forth in Mendocino County Code Section 1.04.120, from any claim, action or proceeding brought against any of the foregoing individuals or entities, the purpose of which is to attack, set aside, void or annul the approval of this application or adoption of the environmental document which accompanies it. The indemnification shall include, but not be limited to, damages, costs, expenses, attorney fees or expert witness fees that may be asserted by any person or entity, including the applicant, arising out of or in connection with the approval of this application, whether or not there is concurrent, passive or active negligence on the part of the County, its agents, officers, attorneys, employees, boards and commissions.

| Date | Applicant |
|------|-----------|

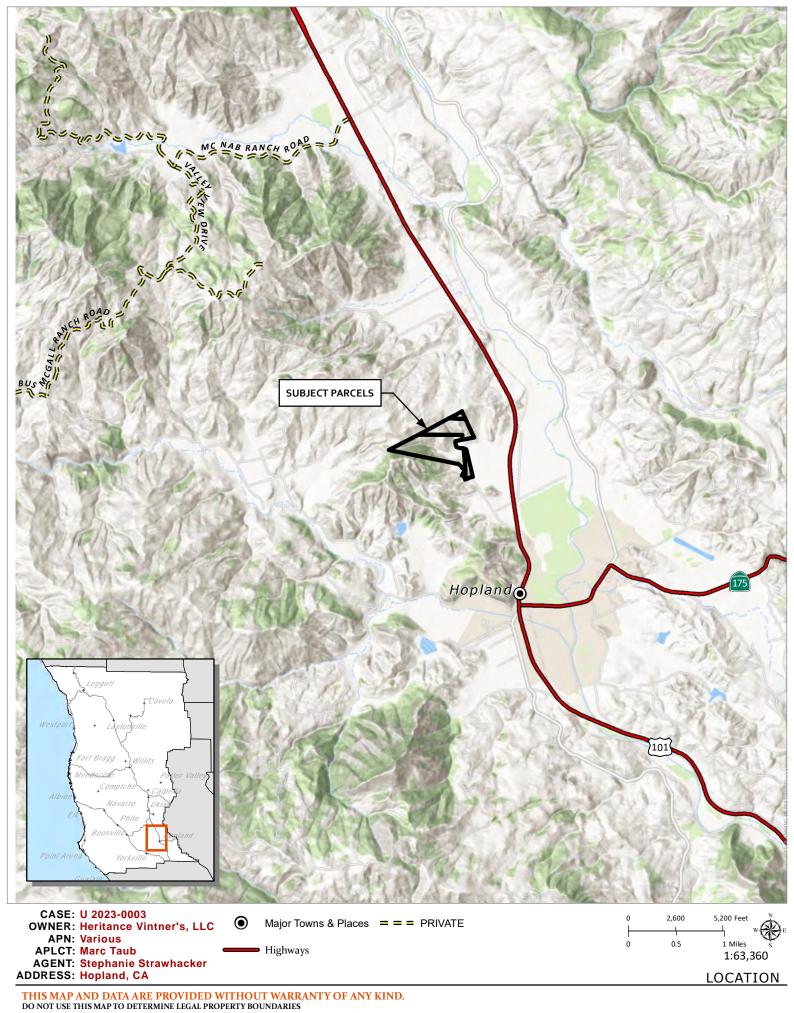

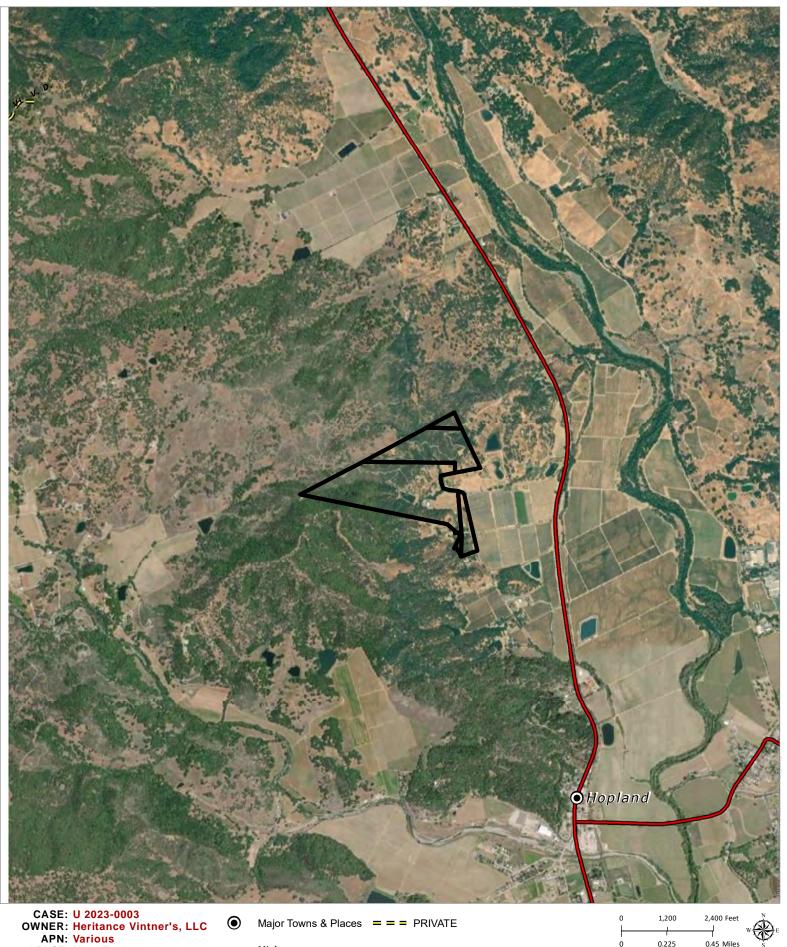


APLCT: Marc Taub
AGENT: Stephanie Strawhacker
ADDRESS: Hopland, CA

Major Towns & Places = = = PRIVATE Highways

1,200 2,400 Feet 0.45 Miles 1:30,000

AERIAL

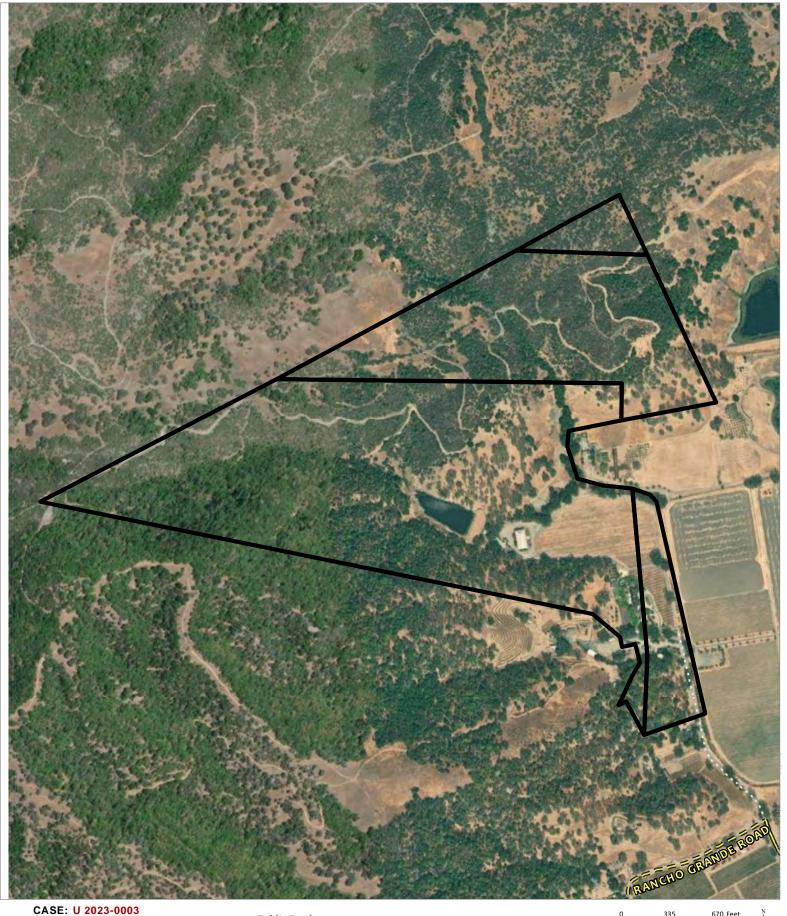

OWNER: Heritance Vintner's, LLC
APN: Various
APLCT: Marc Taub
AGENT: Stephanie Strawhacker
ADDRESS: Hopland, CA Public Roads

= = = Private Roads

0.05 0.1 Miles 1:8,000

AERIAL

All work on this project provided by the general contractor (GC) shall conform to the contract documents which include the drawings, specifications, all addenda and modifications issued by

These contract documents intend to describe a finished project ready for legal use. the GC shall furnish and install all required elements for a complete operating system.

The project shall be constructed according to the locally adopted edition of the uniform buildingcode, the state of california, local municipality amendments and all other applicable codes. Governing authorities and codes take precedence over drawings and specifications. The GC shall report all discrepancies to the architect immediately.

The GC shall maintain a current copy of the 2019 CBC on site at all times.

The GC shall install all materials and products in strict accordance with manufacturers' recommendations. all manufacturers' articles, materials and equipment shall be applied installed, connected, erected, cleaned, and conditioned as per the manufacturers' instructions and applicable icbo reports.

All materials shall be new unless otherwise noted and like materials shall be consistent in appearance unless specified otherwise

The GC and all subcontractors shall provide a one-year guarantee after project completion for all

Mechanics, craftsmen, and workers skilled and experienced in the fabrication and installation of the work involved shall perform shop and fieldwork. all work on this project shall be performed in accordance with the best-accepted practices of the respective trades involved and in accordance with the drawings, submitted shop drawings, and these specifications.

Written dimensions on drawings shall take precedence over scaled drawings. Do not scale drawings at any time. Walls and partitions shown in plan or section are to face of finish material unless otherwise. Interior elevation and cabinet dimensions are to face of finish material.

The GC shall verify dimensions against field conditions, construction documents are based on observation and documentation of existing conditions by the architect and from documents provided by the owner. The architect makes no claim to the accuracy of hidden conditions or conditions inaccessible from direct observation, should the GC encounter field conditions that vary from these construction documents and that effect the intent of these drawings or the contract/ subcontract sum, the architect shall be notified immediately.

Exterior dimensions are to face of CMU or plywood where applicable, u.o.n. Interior dimensions are to face of stud u.o.n.

The GC shall become familiar with the existing conditions of the site and project prior to commencing work and in the case of conflict with the documents, shall notify the architect

The architect shall be notified immediately in the case of conflict between project documents and consultants', manufacturers' or other documents or recommendations.

Should conflicts occur between drawings and specifications, drawings shall govern in matters

All work shall be performed during regular business hours, as permitted by local agencies. work involving excessive noise or dust, or which would otherwise interfere with the normal operation of the building, site or neighboring sites shall be coordinated with the owner.

of dimension or quantity. Specifications shall govern in matters of materials or finishes.

The GC shall coordinate all work, including scheduling times and locations for deliveries, building access, etc...

The commencement of work shall be deemed as an acknowledgement by the GC that all work of the project shall be completed in conformance with the contract documents and schedule.

7 REVISIONS AND CHANGES

Revisions, and changes must be submitted to the architect for review in the form of a change order, prior to the purchase, fabrication, or installation of the work in question.

Any change, modification, or interpretation of the scope or requirements of these documents undertaken without consultation of the architect shall be the responsibility of the GC.

The owner may order extra work or make changes by altering, adding to, or deducting from the work, the contract sum shall be adjusted accordingly.

8 UTILITIES

The architect does not assume responsibility for underground utilities or the existence of other buried objects. The locations of existing underground utilities and or facilities as shown on the drawings are approximate only. the gc shall contact the respective utility company and provide utility location services as required to obtain the exact depth of burial and horizontal location of utility lines, conduits, piping, etc... prior to performing underground construction the gc shall make necessary probes and explorations to identify areas of possible

The GC shall inspect, test, and disconnect utility services at the main source or main branch. The GC shall securely cap and/or valve-off utility service behind final finished surfaces of intended construction or, when noted, at finished face of exist, construction prior to demolition. utility service shall be defined as plumbing, hvac, electric, and fire protection.

Adhesives, sealants and caulks shall be complaint with VOC and other toxic compound limits.

The GC shall arrange for all inspections and permits necessary to obtain a certificate of

occupancy and or final permit signoff & inspection.

10 EXISTING CONDITIONS

Access panels, clean outs, and the like shall be maintained for existing building systems.the GC shall verify that existing walls and floors to remain are within expected tolerances. The GC shall report to the architect any variations in floor levels greater than 1/4" in 10'-0". The GC shall inform the architect of any existing threshold elevation variations greater than 1/2".

11 DEFINITIONS

"Align" shall be defined as the accurate location of finish faces in the same plane. "typical" or "typ." shall be defined as conditions which are representative of similar conditions throughout. unless otherwise noted, details are usually keyed and noted. "typ." only once, when they first occur. "similar" or "sim." shall be defined as conditions which are comparable in characteristics for the conditions noted. verify dimensions and orientation on plans and elevations. "gc" refers to the general contractor, his agents and subcontractors. "architect" refers to the architect of record or his agent.

12 MATERIALS STORAGE AND PROTECTION OF WORK

Improvements on the site, work in progress, stored materials on property shall be protected by the GC from damage arising during the work. all items damaged due to insufficient protection or otherwise shall be fully restored by the gc to their prior condition at no cost to the owner. no part of the structure shall be overloaded beyond its safe carrying capacity at any time.

The GC shall be responsible for securing the site during the course ofthe project. if the site is unattended at any time, it shall be locked.

Any materials of unknown constitution uncovered during the course of construction shall be left untouched and immediately brought to the attention of the owner for testing.

15 CLEAN UP

The site shall be kept broom clean and free of debris during the course of construction. At the completion of the work the GC shall clean the project and the surrounding area, remove all waste materials and rubbish from the project as well as tools, construction equipment, machinery and surplus materials. the gc shall remove caulk, putty, and paint from glass and mirrors and wash and polish the same. clean and remove all labels, grease, dirt, stains, etc. from finished surfaces and equipment to the extent required restoring the intended finish.

Planters and landscape areas shall be cleaned of debris and rough grading shall be completed.

16 COMMISSIONING

Commissioning, Testing and Adjusting, shall be included in the design and by the GC during construction of the project to verify that the building systems and components meet the owner's project requirements.

17 PROTECTION OF DUCT OPENINGS AND MECHANICAL EQUIPMENT DURING CONSTRUCTION The GC shall provide protection for ducts, duct openings, permanent and construction mechanical equipment at the time of rough installation, storage, and untill completion of construction, using materials or methods acceptable to local enforcing agencies in order to reduce dust/ debris that may collect in building systems.

18 BUILDING MAINTENANCE AND OPERATION

At the time of final inspection, the GC shall provide a manual, compact disc, web-based reference or other media acceptable to the enforcing agency which includes an operation and maintenance manual as outlined in CGBC Section 5.410. 19 MOISTURE CONTENT OF BUILDING MATERIALS

Building materials with visible signs of water damage shall not be installled. Wall and floor framing shall not be enclosed when the framing members exceed 19% moisture content. Moisture content shall be measured, verified, and documented in accordance with CGBC Section 5.505.

20 ENVIRONMENTAL TOBACCO SMOKE (ETS) CONTROL


Where outdoor areas are provided for smoking, smoking shall be prohibited 25 feet of building entries, outdoor intakes and operable windows and within the building as prohibited by other laws or regulation per CBC Title 24, Part 11 5.504.7

END OF GENERAL NOTES

Abbreviations

| ACOUS. A.D. ADJ. A.F.F. | Acoustical Area Drain Adjustable Above Finish Floor | LAM. LAV. LVR. L.P. | Laminated Lavatory Louver Low Point |
|--|--|--|--|
| AGGR. ARCH. ASPH. AWN. | Aggregate Architectural Asphalt Awning | M.C. MECH. MIN. MIR. | Medicine Cabinet Mechanical Minimum Mirror |
| BI-FO. DR. BLDG. BLK. | Bi-Folding Door Building Block | MET. M.P.R. | Metal Multi Purpose Room |
| BLKG. BM. B.O. BW | Blocking Beam Bottom Of Bottom of Wall | (N) N.I.C. N.T.S. | New Not In Contract Not To Scale |
| CPT. CAB. C.B. CEM. | Carpet Cabinet Catch Basin Cement | OBS. O.C. O.D. OPN'G | Obscure On Center Outside Diameter Opening |
| C.J. CL. CLG. CLR. C.O. | Construction Joint Closet Ceiling Clear Clean Out | P.LAM. P.L. PL. PLAS. PLYWD | Plastic Laminated Property Line Steel Plate Plaster Plywood |
| COL. CINC. CONT. | Column Concrete Continuos | PT. QTY. | Point |
| CSMT. C.T. C.L. C.S. | Casement Ceramic Tile Center Line Counter Sink | R. RAD. RET. RET. AIR RD. | Riser Radius Retaining Return Air Round |
| DEMO DET. D.H. D.F. DIAG. DIM. | Demolition Detail Double Hung Douglas Fir Diagonal Dimension | R.D. REF. REG. REINF. REQ'D R.O. | Roof Drain Refrigerator Register Rinforced Required Rough Opening |
| DWGS. DN. | Drawings Down | RWD. R.W.L. | Redwood Rain Water Leader |
| (E) E.J. EL. EQ. EXT. | Existing Expansion Joint Elevation Equal Exterior | SAG S.V. S.H. SHT. SHWR. SIM. | Supply Air Grill Sheet Vinyl Single Hung Sheet Shower Similar |
| F.B.T. F.D. F.F. FIN. F.O.C. F.O.S.F.O.W. | Furnished By Tenant Floor Drain Finish Floor Finish Face Of Concrete Face Of StudFace Of Wall | SM. SKY. SL. SL. GL. DR. SQ. S.S.D. | Sheet Metal Skylight Slider Sliding Glass Door Square See Structural Drawings |
| FRDR. FT. FX. | French Door Footing Fixed | ST. STL. STD. STL. STG. | Stainless Steel Standard Steel Storage |
| | Gauge Galvanized Gypsum Board | STRUC. T. | Structural Tread |
| GL. GLU. LAM. G.S.M. GWB | Glass Glue Laminated Galv. Sheet Metal Gypsum Board | TC TEMP. GL. TJI T.O. T.O.C. | Top Of Curb Tempered Glass Truss Joist Top Of Top Of Concrete |
| H.B. HGT. H.M. HOR. | Hose Bibb Height Hollow Metal Horizontal | T.P.D. TYP. TW TS | Toilet Paper Dispenser Typical Top Of Wall Tube Steel |
| H.P. H.W.H. | High Point Hot Water Heater | U.O.N. | Unless Otherwise Noted |
| I.D. INSUL. INT. | Inside Diameter Insulation Interior | VERT. V.I.F. | Vertical Verify In Field |
| J.BOX JT. | Junction Box Joint | W/ W.C. WD. WDW. WP. W.P. | With Water Closet Wood Window Waterproof Work Point |
| | | YD. | Yard |
| | | | |

Symbol Legend

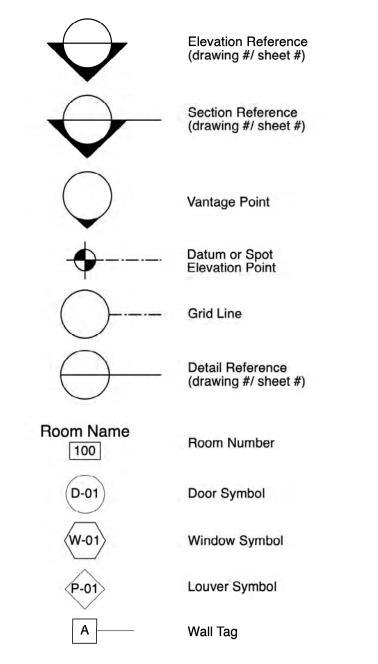

Sheet Index

ARCHITECTURAL DRAWINGS:

A2.01 (E) Elevations

A0.01 Cover Sheet A0.02 Vicinity Site Plan A0.10 Existing Site Plan A0.11 Existing Site Plan - Enlarged A0.12 Proposed Site Plan - Enlarged A1.01 (E) First Floor Plan A1.02 (E) Second Floor Plan A1.03 (N) First Floor Plan A1.04 (N) Second Floor Plan

A2.02 (P) South & West Elevations

A2.03 (P) North & East Elevations

Project Team

ARCHITECT:

MH Architects Matt Hollis Stephanie Strawhacker, Project Manager 2325 3rd Street, Studio 426 San Francisco, CA 94107

415.977.0194 415.977.0196 matt@matthollis.com E: stephanie@matthollis.com

OWNER:

Marc Taub

11684 US-101

Hopland, CA 95449

E: m@taubfamilyco.com

Vicinity Map North Mountain OHV



Project Summary

Approval sought to use existing structure for as Transient Habitation - Lodging (limited) structure, which is permitted use subject to a Major Use Permit per Section 20.052.025 of the Mendocino County zoning

The current structure has a conditioned first floor (with kitchen, bathroom, living & dining room), a built-in outdoor bbq, a trellis on the northwest, and a

The owner is seeking to maintain the residential use of the guesthouse with the following changes and improvements:

An addition over the existing raised platform to the west. An addition to the north.

Replacing the existing trellis. Replacing the existing bbq with an outdoor kitchen.

The second floor will be converted into five bedrooms while maintaining the existing envelope. There are no additions to the 2nd floor and no height changes.

Second-floor deck over the western addition New skylights.

New fire-pit to the northeast of the barn.

Other structures and features on the site include the primary residence & tennis court.

All work shall comply with 2019 versions of California Residential Code (CRC), California Building Code (CBC), California Plumbing Code (CPC), California Mechanical Code (CMC), California Electrical Code (CEC), California Energy Code, California Green Building Standards Code (CGBS), California Fire Code (CFC, if applicable), California Energy Efficiency Standards (CEES), and all applicable local codes.

Site Information

Site Address: 11704 Hewlitt & Sturtevant Rd, Hopland, CA 95449

048-040-08

14.4 Acres Total Lot Size: **Building Code Information**

Zoning Group: AG

Use Group/ Occupancy: R-3

Building Type: Type VB

Flood Zone: No

Fire Jurisdiction: Hopland Fire - structure and wildland fires

School District: None

Supervisoral District: District 5

Fire Resistance

Automatic Fire Sprinkler System To be designed and installed to NFPA 13 - 2019 standards UNDER ŠEPARATE SUBMITTAL

Square Footage

| | EXISTING | PROPOSED | NOTES |
|----------------------------|-----------------|-----------------|-------|
| Conditioned Area | | | |
| 1st Floor Conditioned Area | 1,973.00 Sq.Ft. | 3,178.00 Sq.Ft. | |
| 2nd Floor Conditioned Area | 0 Sq.Ft. | 1,997.00 Sq.Ft. | |
| Covered Outdoor Area | | T | |
| 1st Floor Outdoor Kitchen | 345.00 Sq.Ft. | 343.00 Sq.Ft. | |
| 2nd Floor Outdoor Deck | 0 Sq.Ft. | 732.00 Sq.Ft. | |
| Totals | 2,318.00 Sq.Ft. | 6,250.00 Sq.Ft. | |





Permit (limited) ing Rd gp lajor x Stul 5449 5449 08 Habita Wlitt & CA 95 -040-0

PUBLISH Use Permit Submittal 12/19/22

This drawing is the property of MH Architects. Any unauthorized use in part or in whole without written permission is 12.19.22


2118

Cover Sheet

Drawn by:

Scale:

Project No:

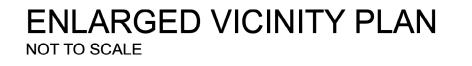



VICINITY PLAN NOT TO SCALE

MH ARCHITECTS

2325 3rd st. studio 426
san francisco, ca 94107
info@matthollis.com
matthollis.com
415 977 0194

e- Major Use Permit itation - Lodging (limited) & Sturtevant Rd 35449

Use Permit Submittal 12/19/22

This drawing is the property of MH Architects. Any unauthorized use in part or in whole without written permission is prohibited.

Vicinity Site Plan









MATT HOLUS 2827 PUR PECOLIATE: 00 /30 /2023

Guesthouse- Major Use Permit
Transient Habitation - Lodging (limited)
11704 Hewlitt & Sturtevant Rd
Hopland, CA 95449
APN: 048-040-08


PUBLISH DATE
Use Permit Submittal 12/19/22

This drawing is the property of MH Architects. Any unauthorized use in part or in whole without written permission is prohibited.

Date: 12.19.22
Drawn by:
Project No: 2118
Scale:

Existing Site
Plan

SHEET NO:
A0.10

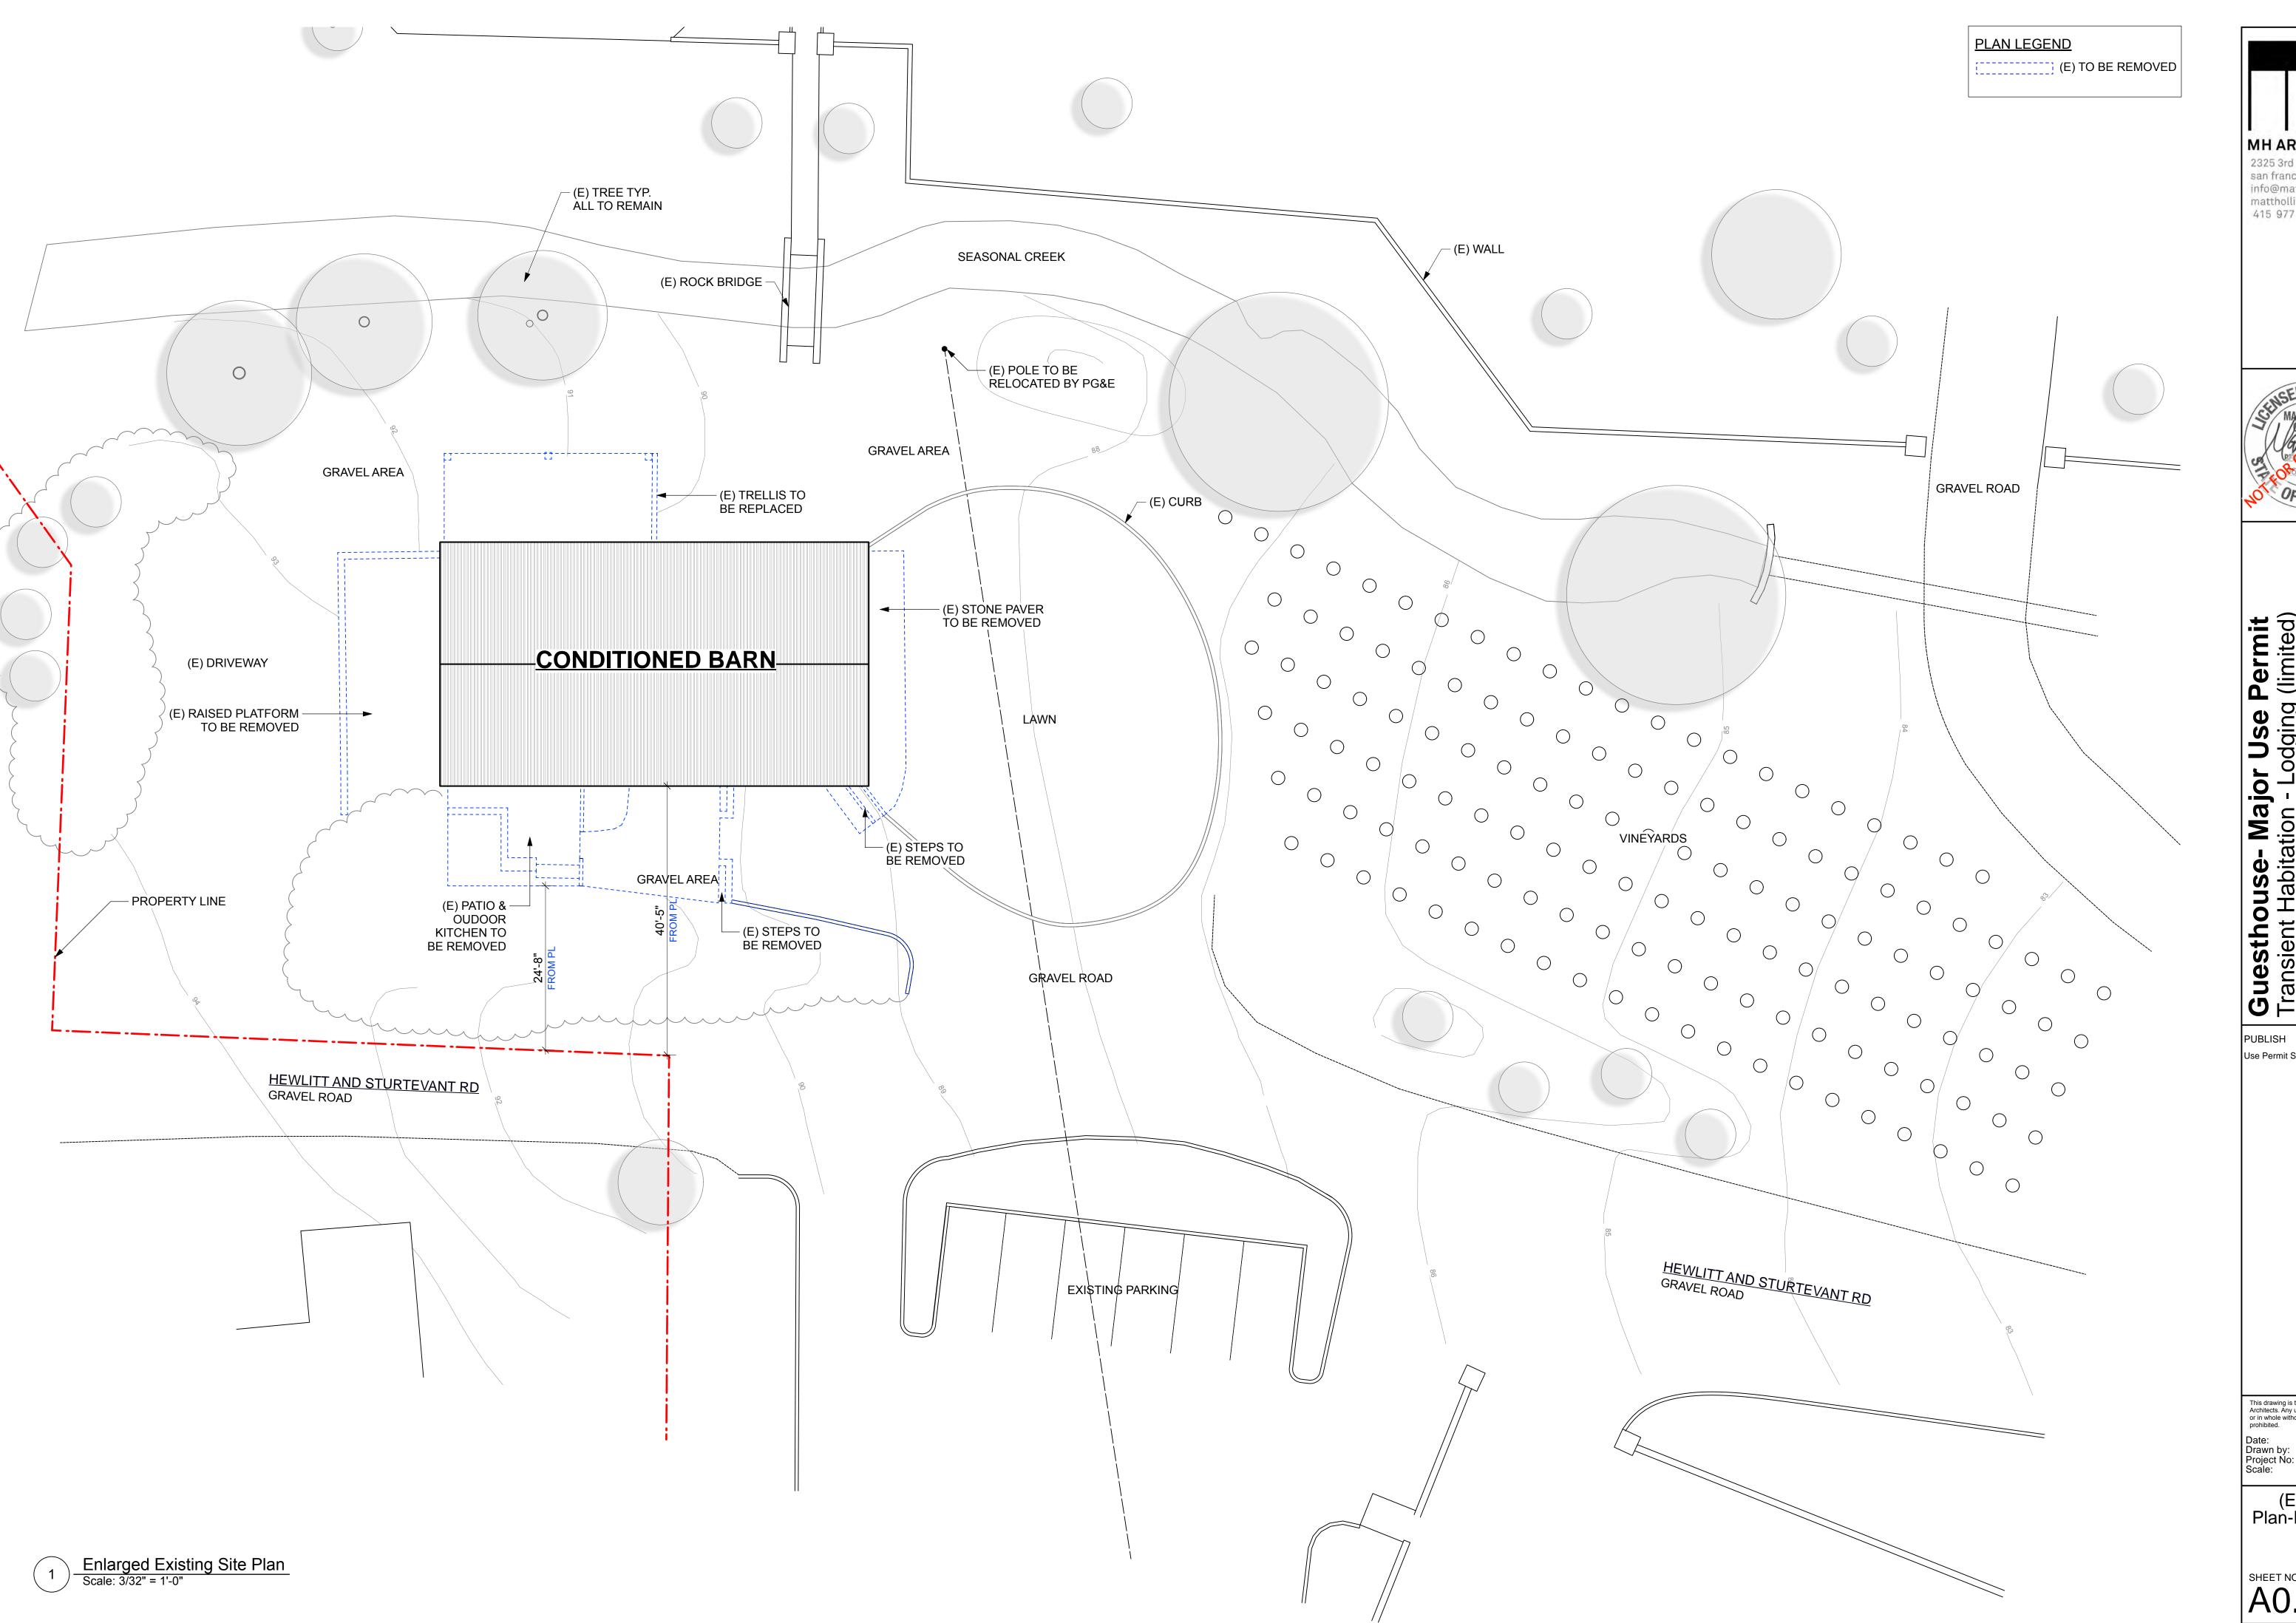





Guesthouse- Major Use Permit

Transient Habitation - Lodging (limited)

11704 Hewlitt & Sturtevant Rd

Hopland, CA 95449


APN: 048-040-08

PUBLISH Use Permit Submittal 12/19/22


This drawing is the property of MH Architects. Any unauthorized use in part or in whole without written permission is

(E) Site Plan-Énlarged

SHEET NO:

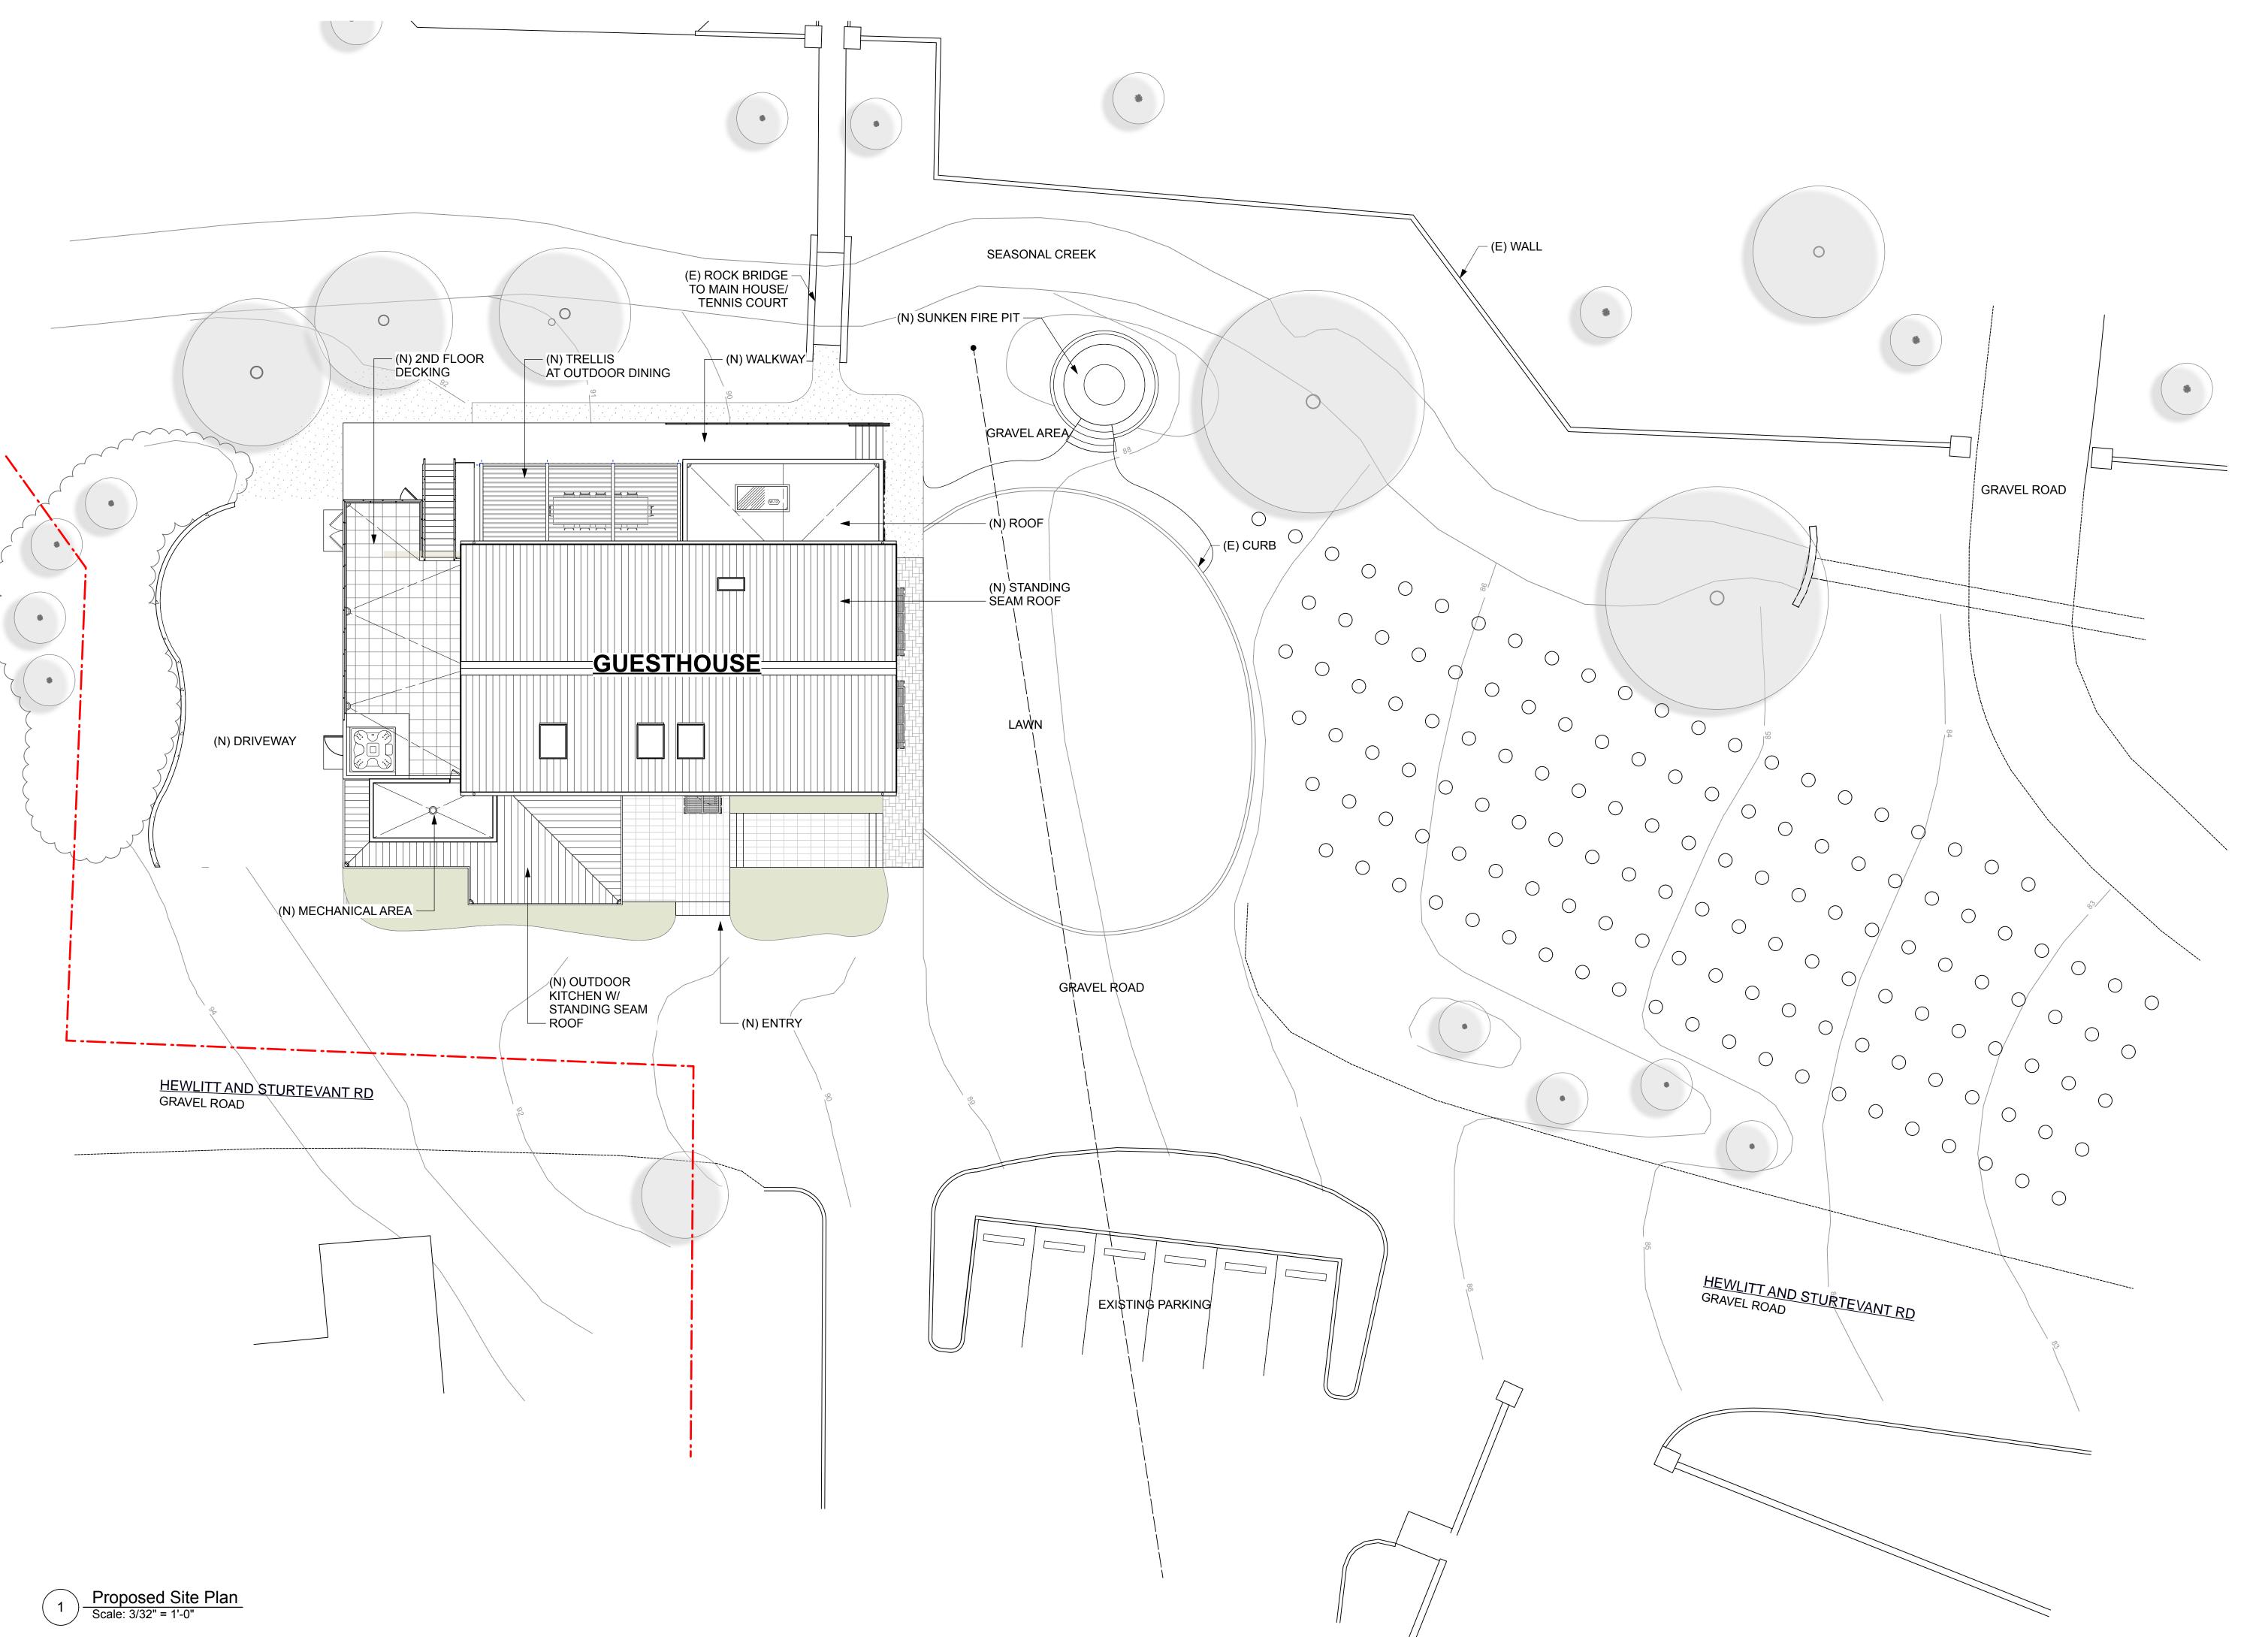



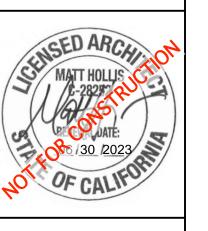


Guesthouse- Major Use Permit
Transient Habitation - Lodging (limited)
11704 Hewlitt & Sturtevant Rd
Hopland, CA 95449
APN: 048-040-08


PUBLISH Use Permit Submittal 12/19/22


This drawing is the property of MH Architects. Any unauthorized use in part or in whole without written permission is Date: Drawn by: Project No: Scale:

(P) Site Plan-Enlarged


SHEET NO:

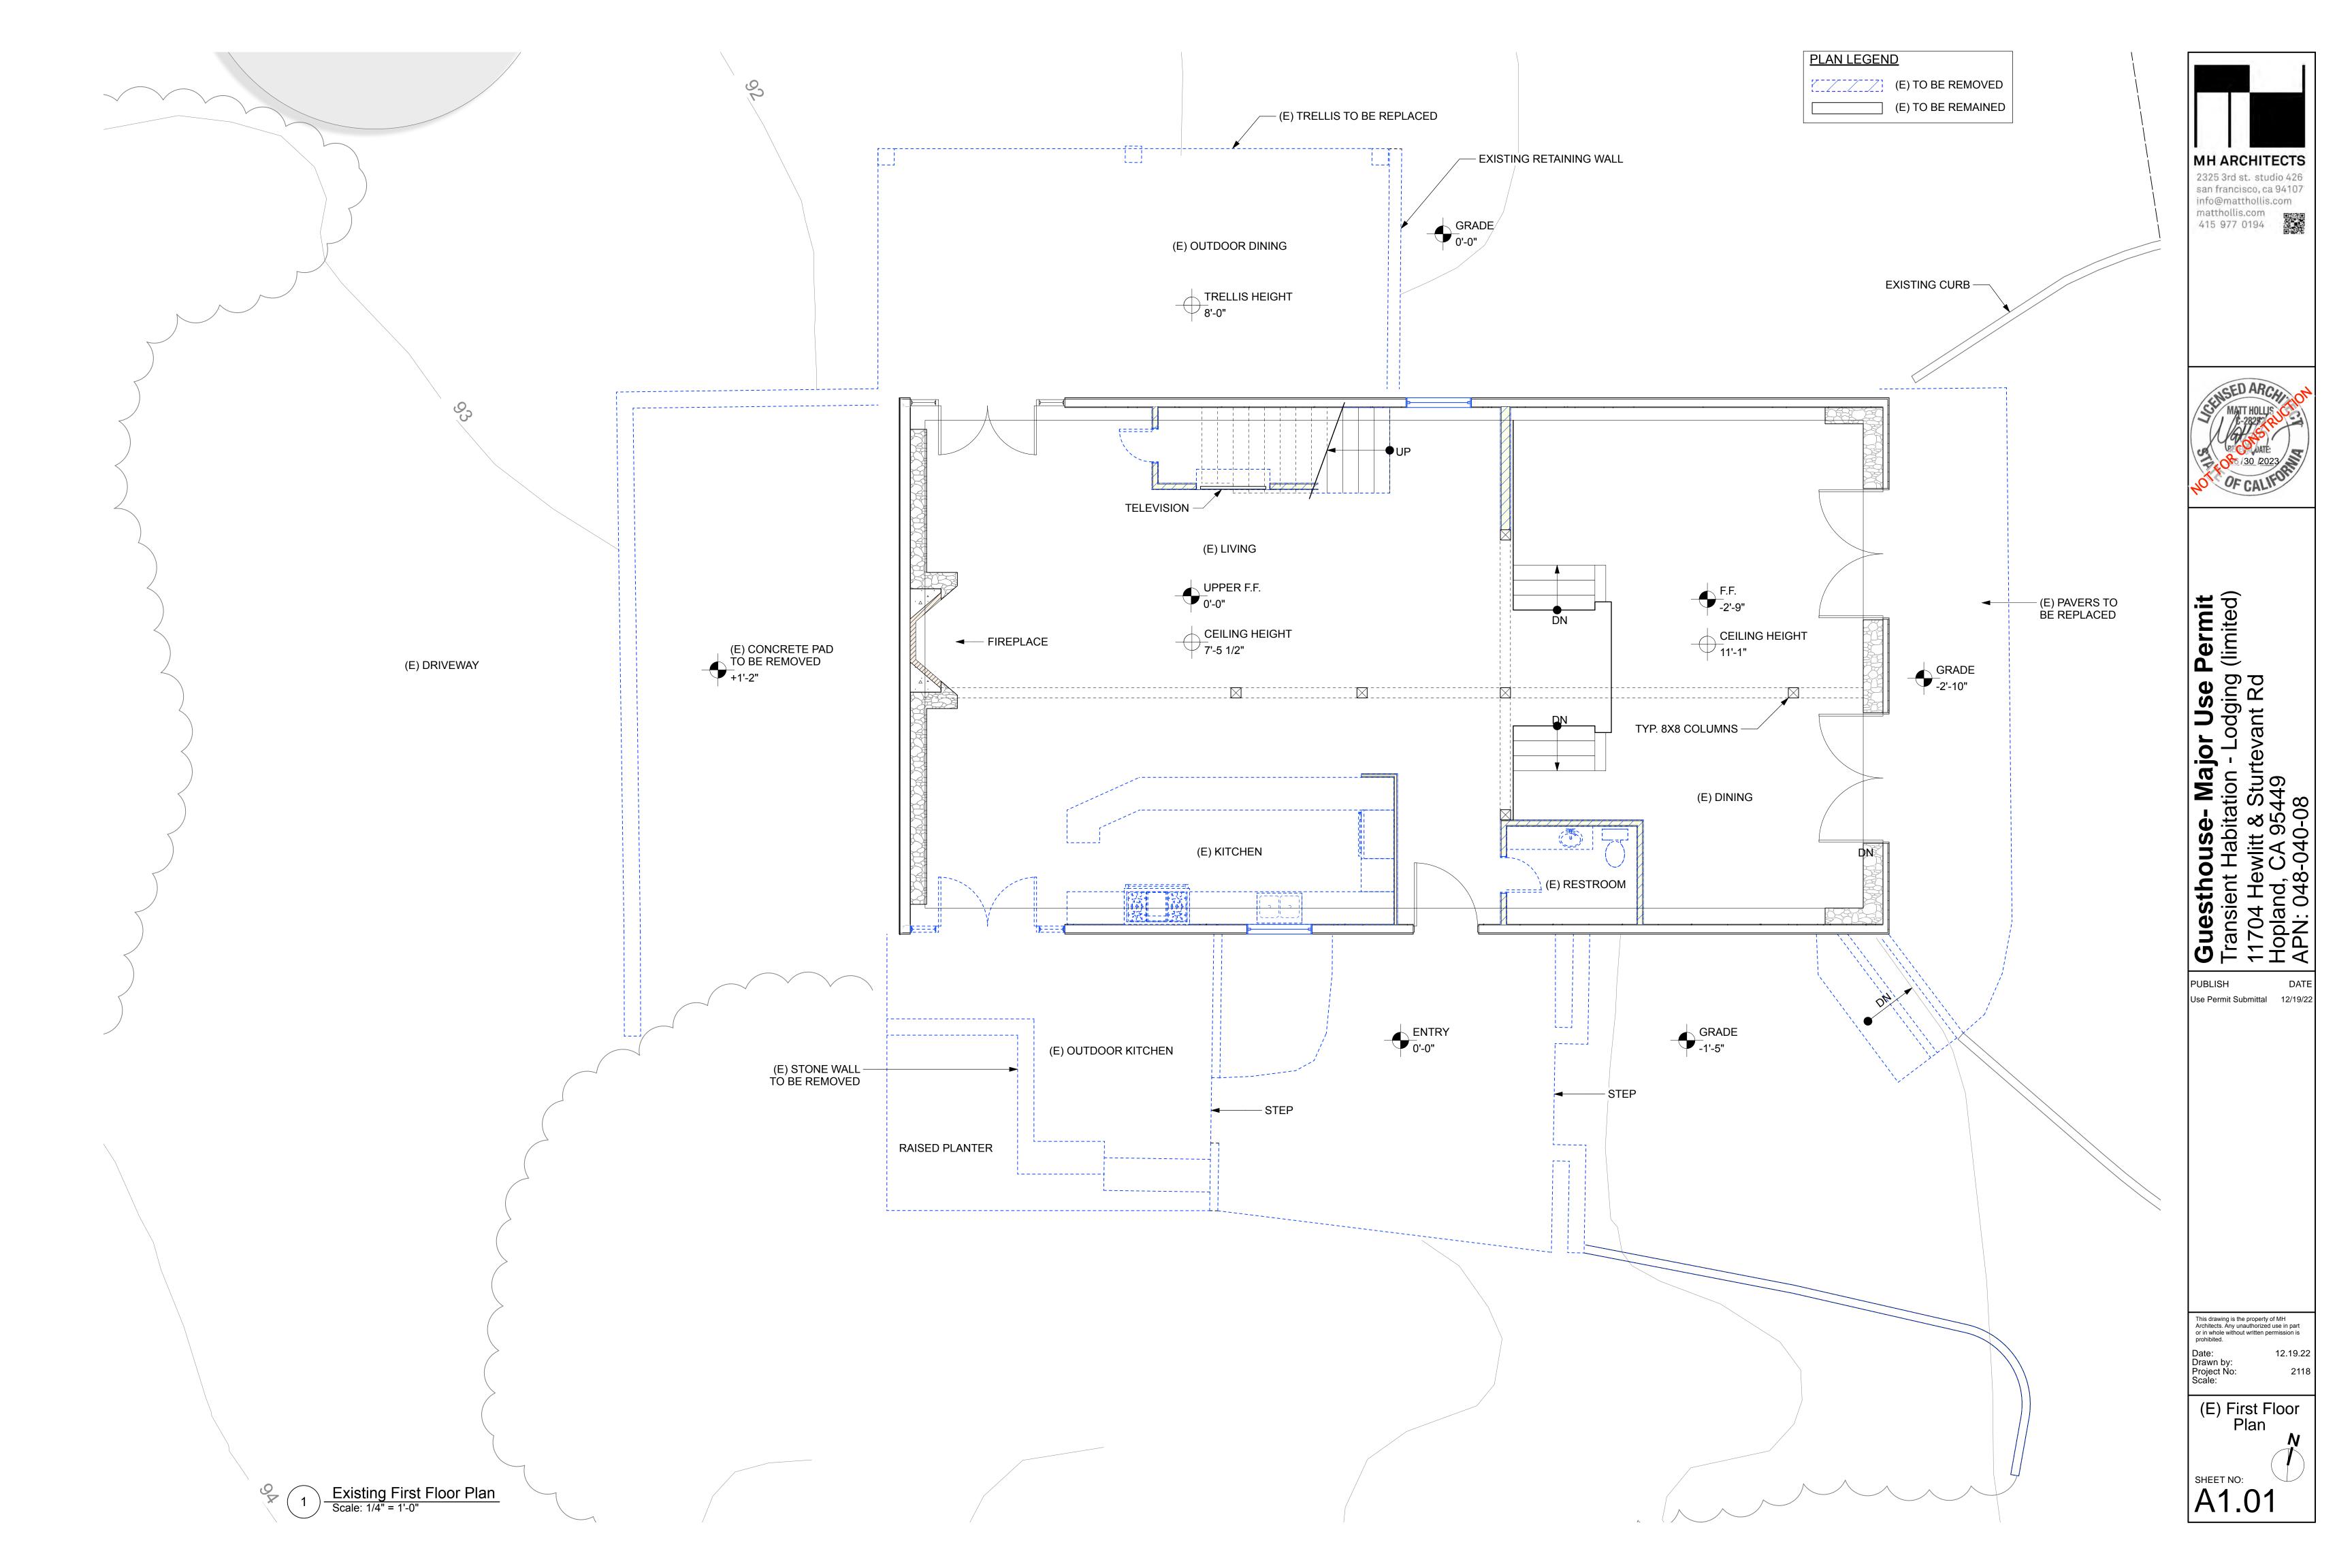


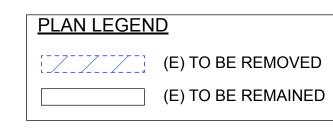

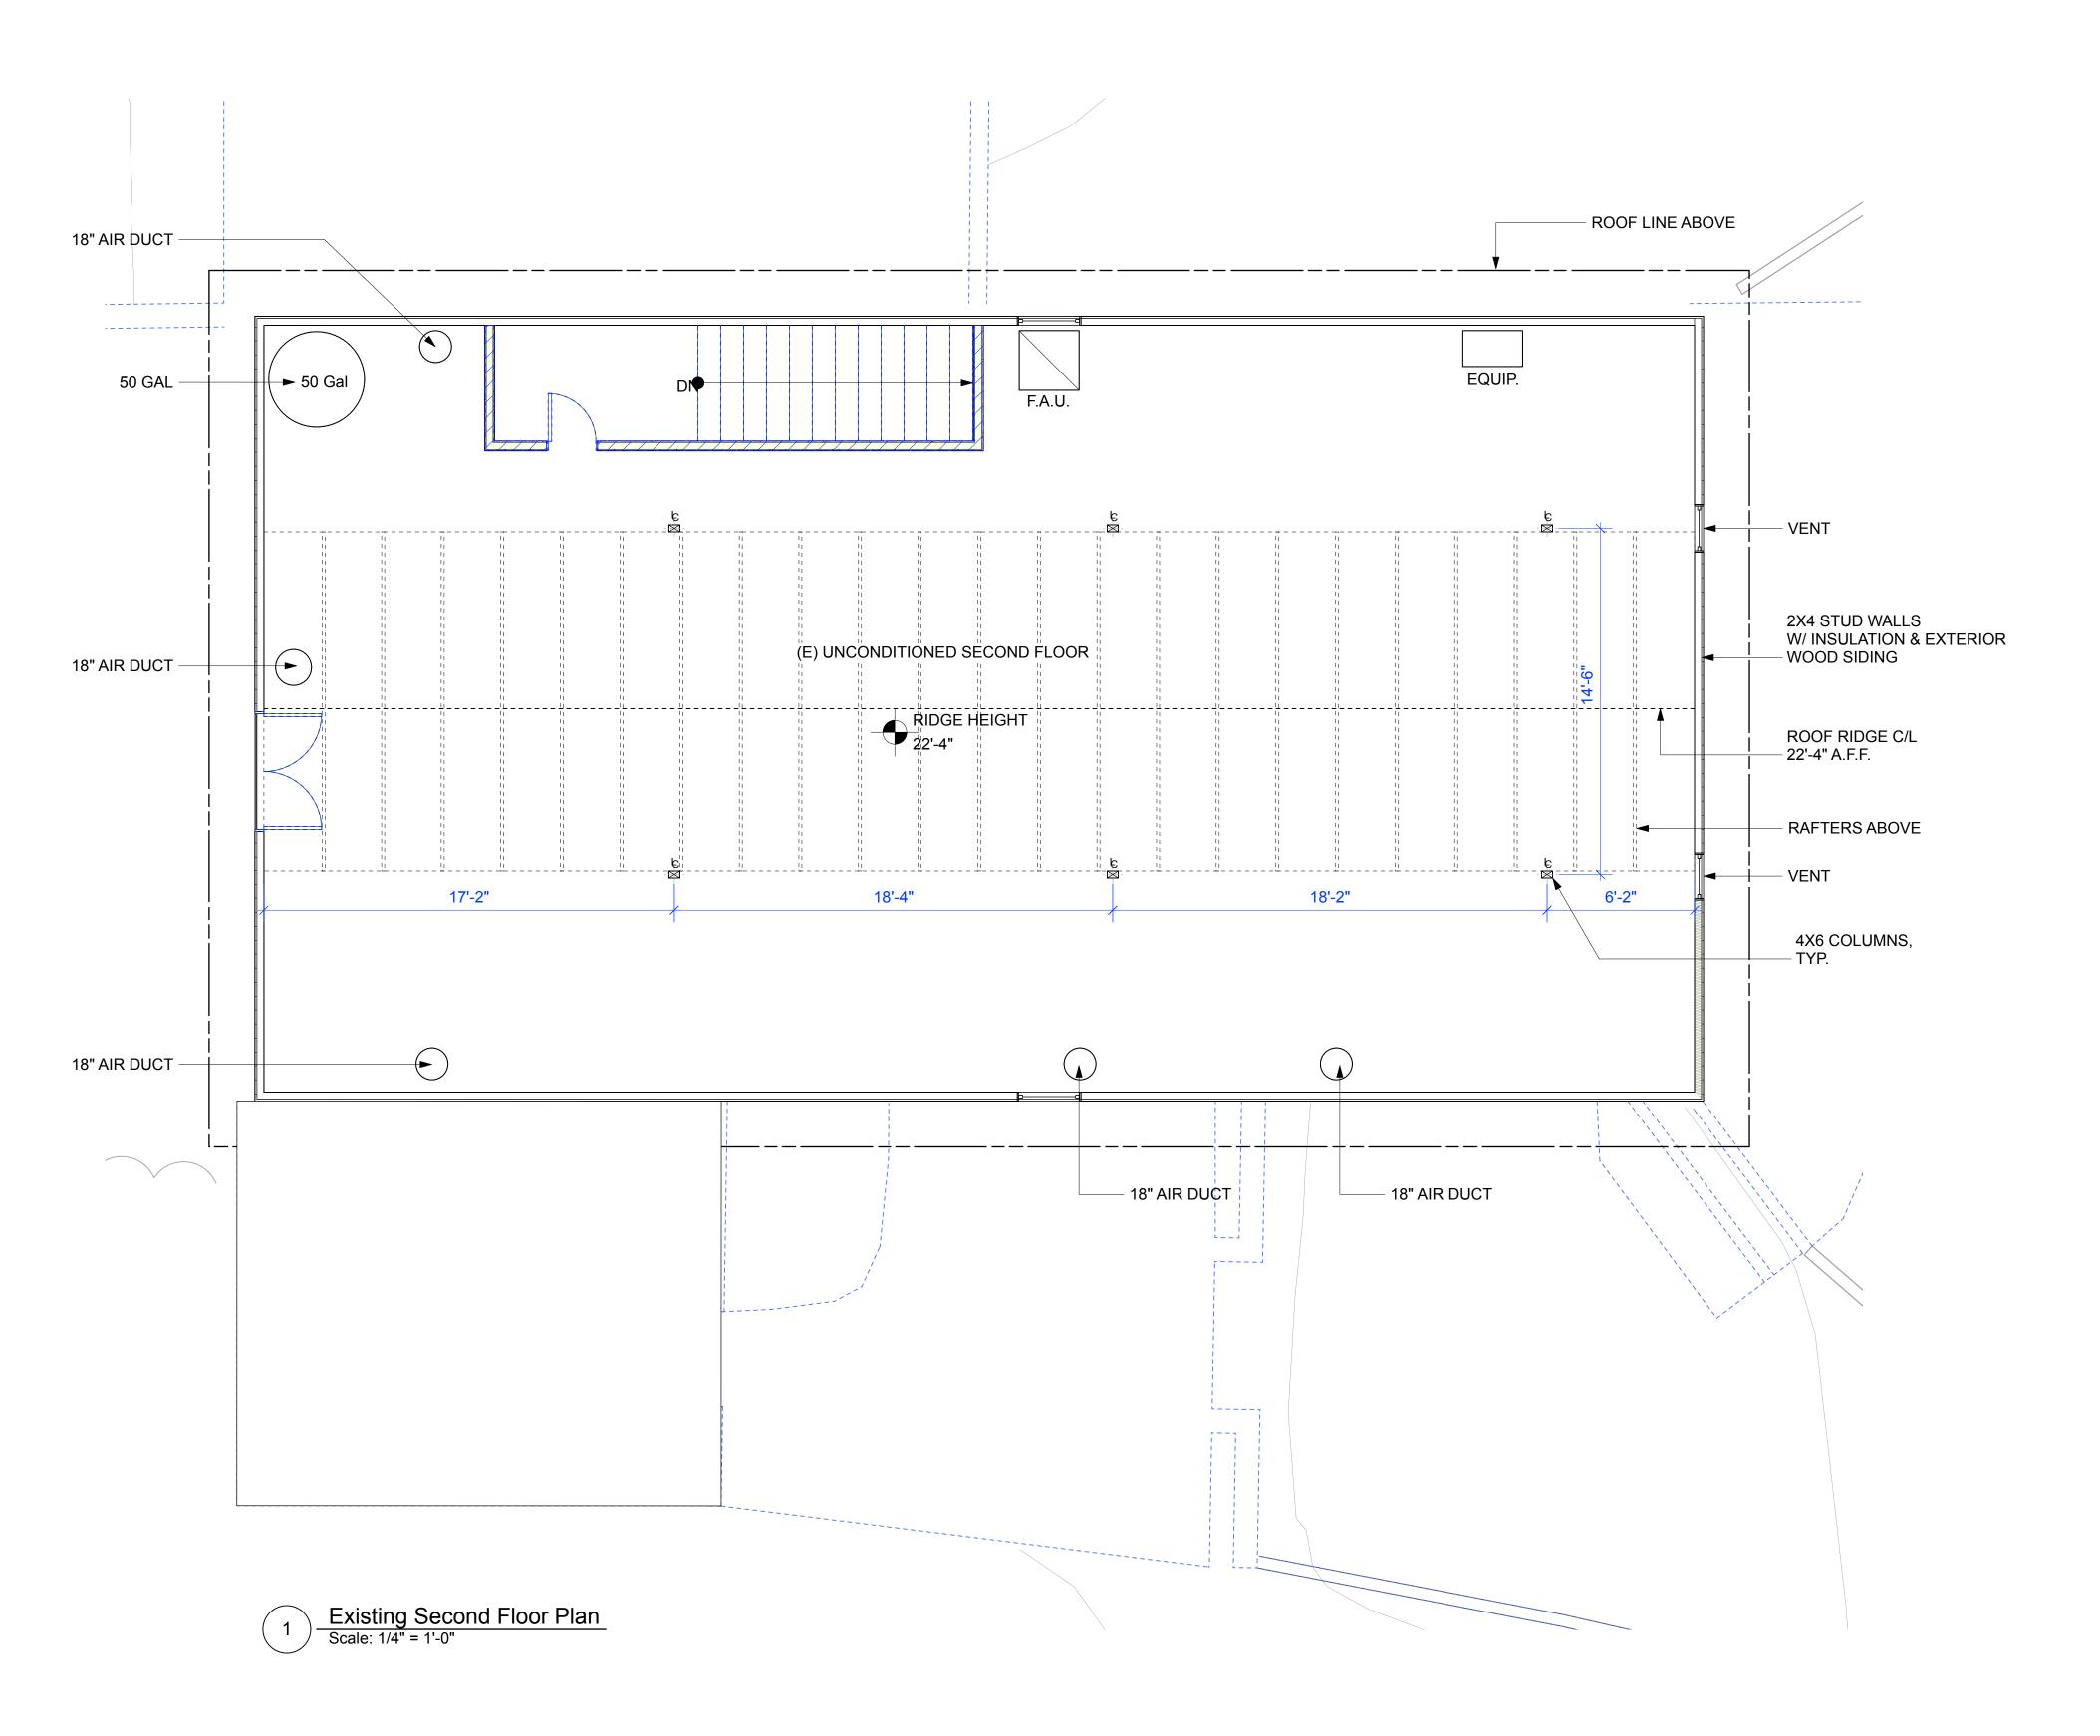



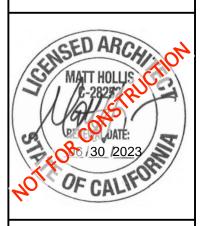

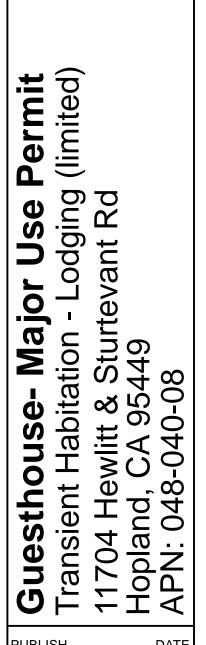


PUBLISH Use Permit Submittal 12/19/22

This drawing is the property of MH Architects. Any unauthorized use in part or in whole without written permission is prohibited. Date: Drawn by: Project No: Scale: 12.19.22 2118

(E) Second Floor Plan


A1.02

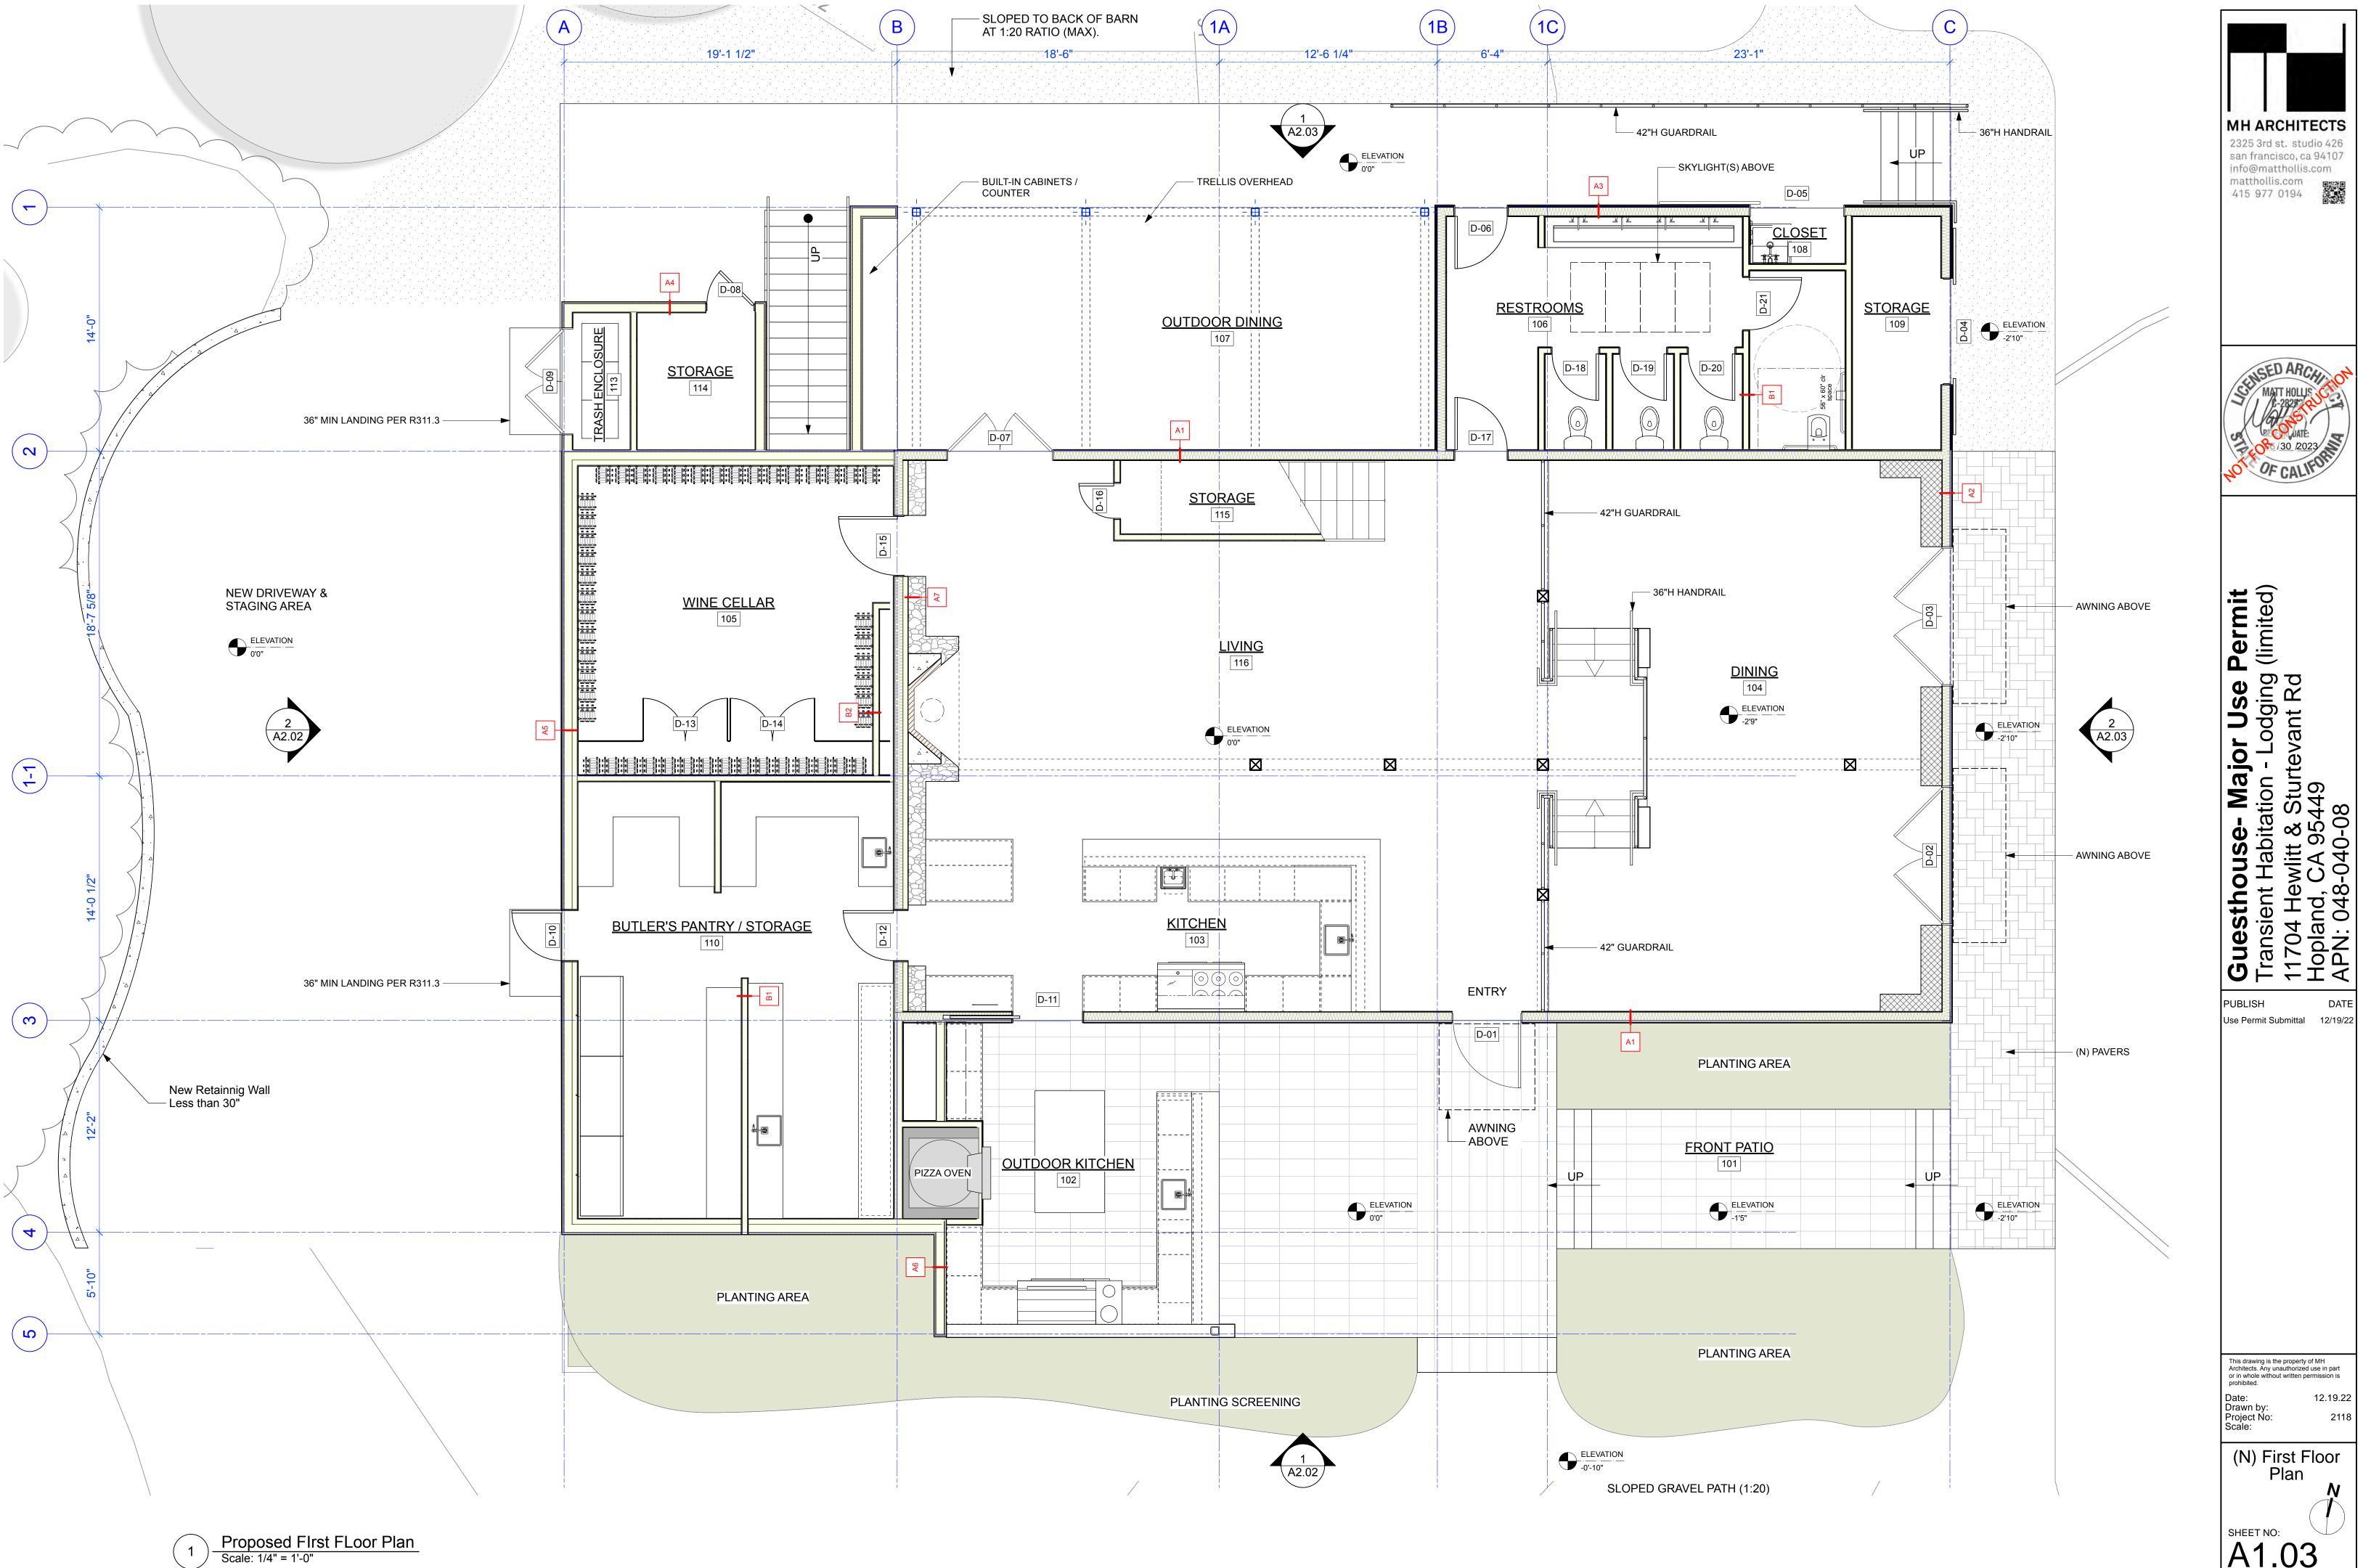

MH ARCHITECTS 2325 3rd st. studio 426 san francisco, ca 94107 info@matthollis.com matthollis.com 415 977 0194




Use Permit Submittal 12/19/22

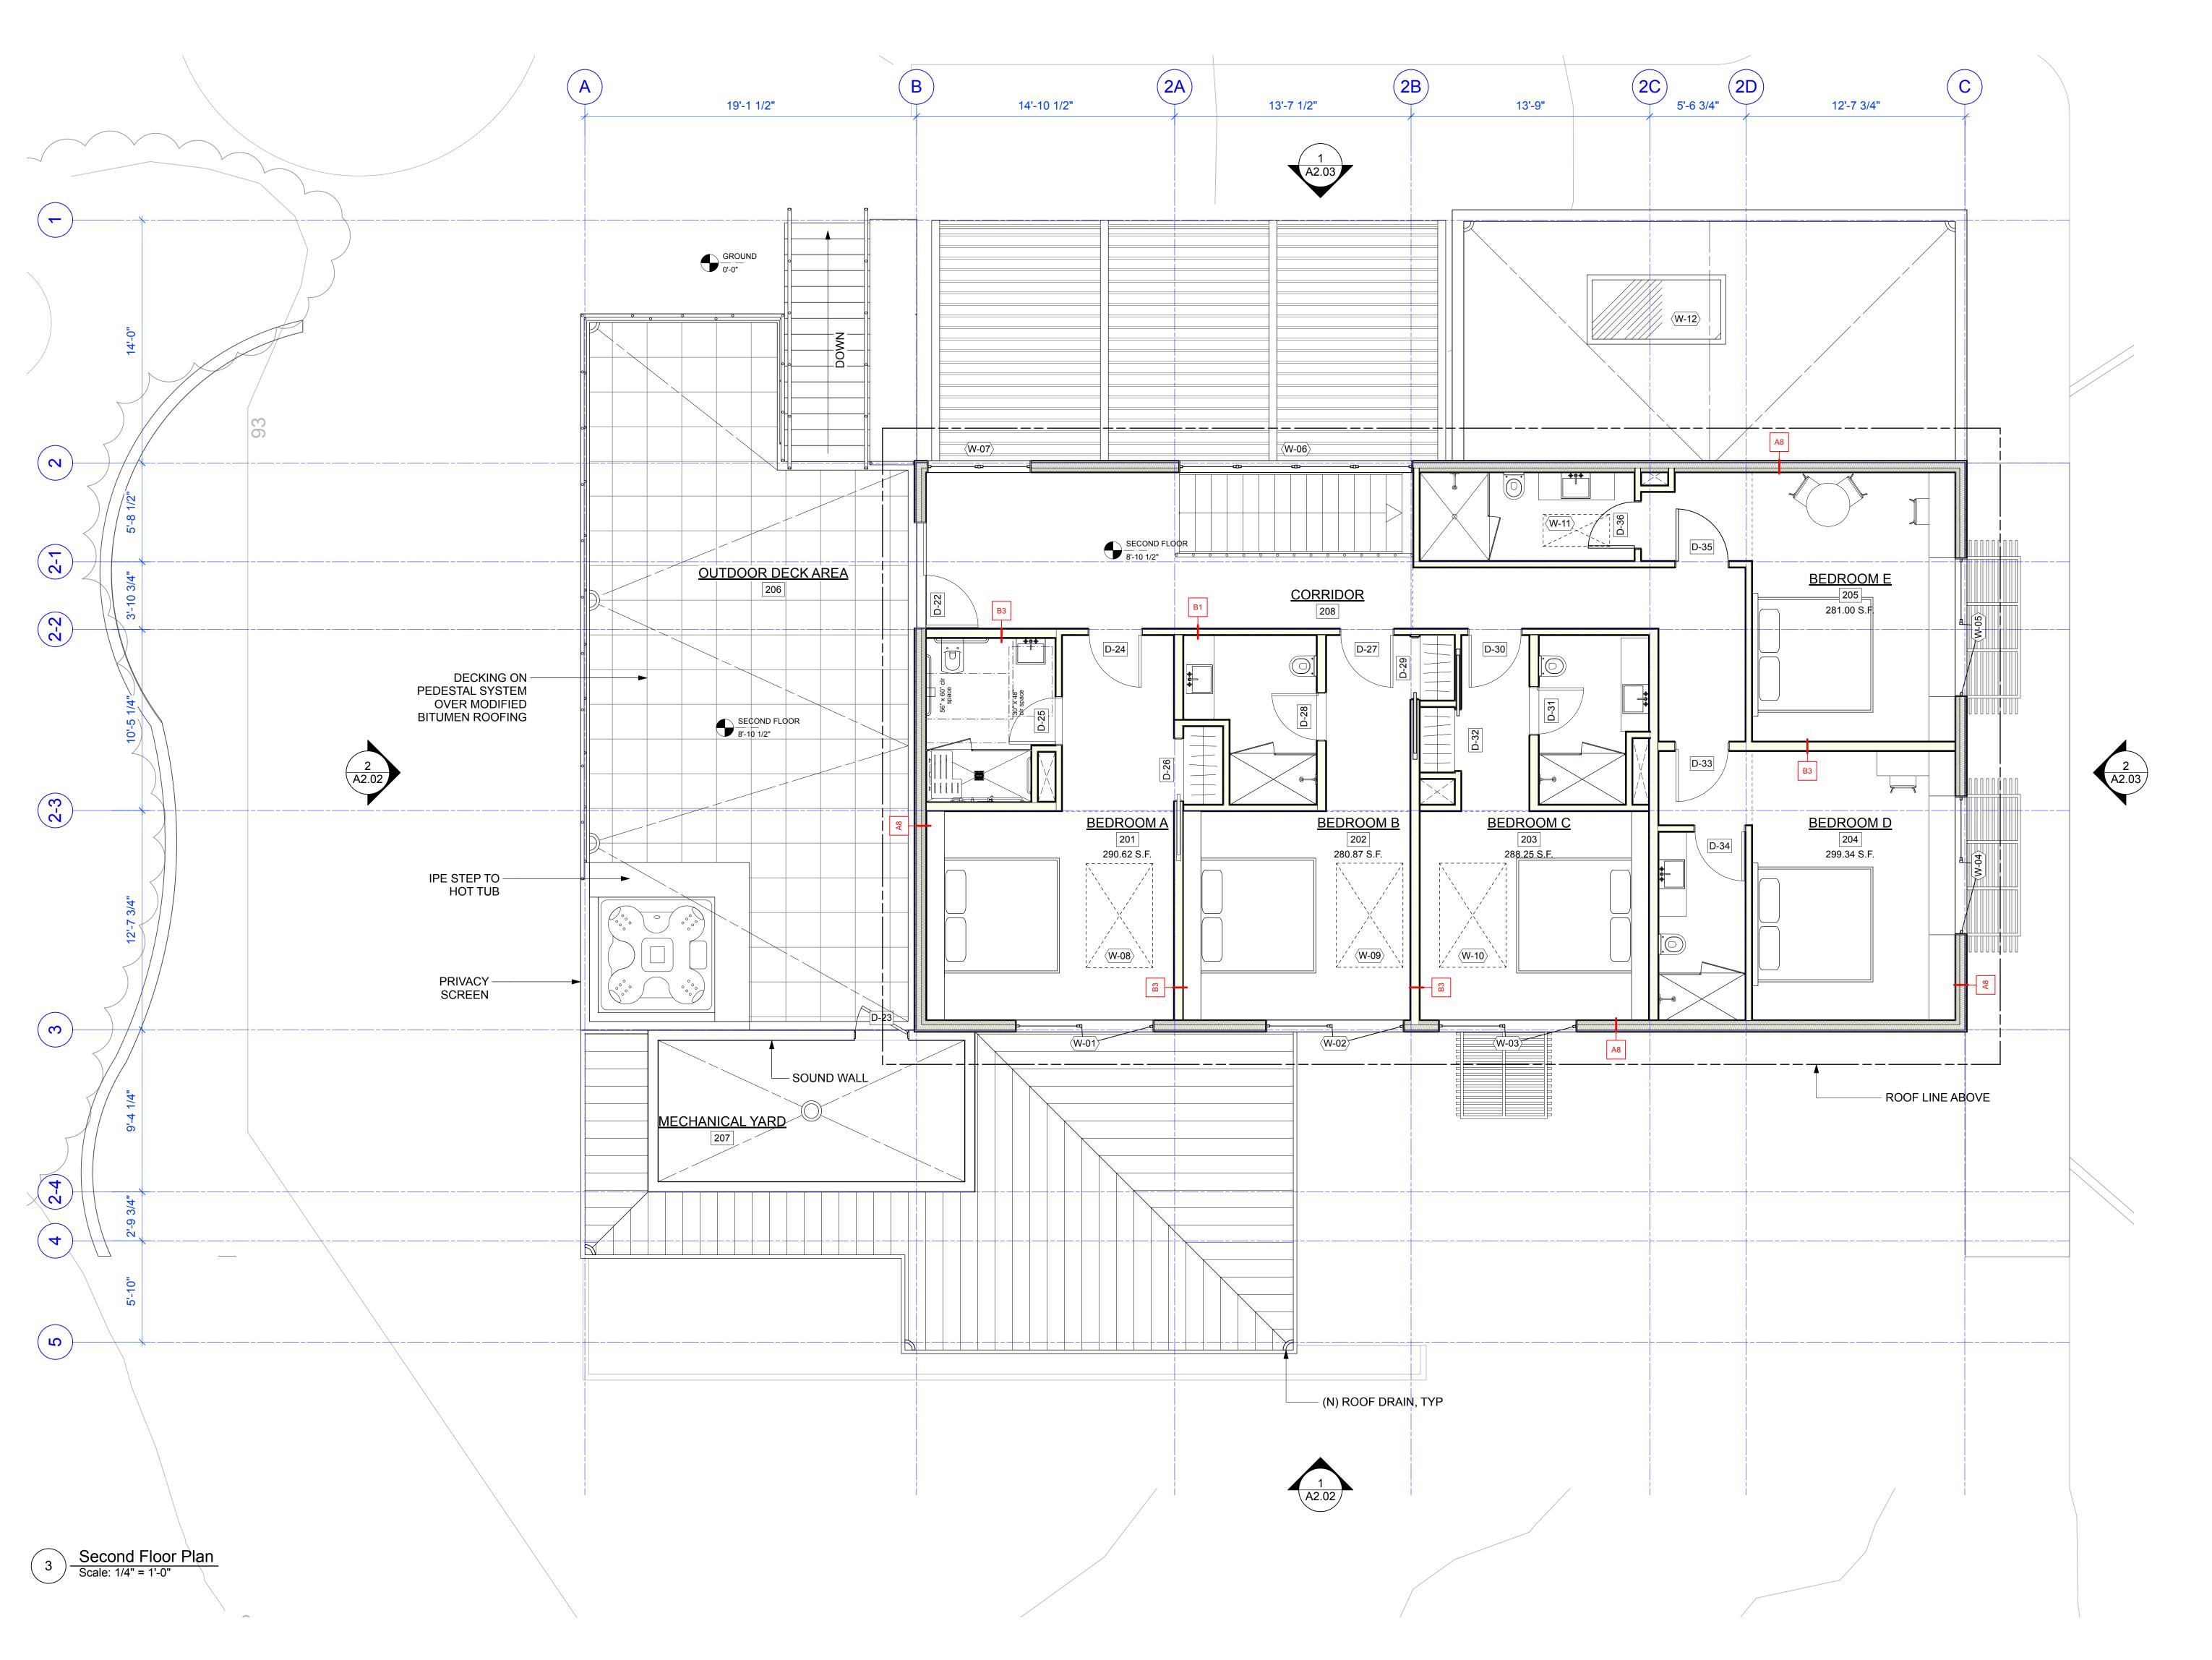





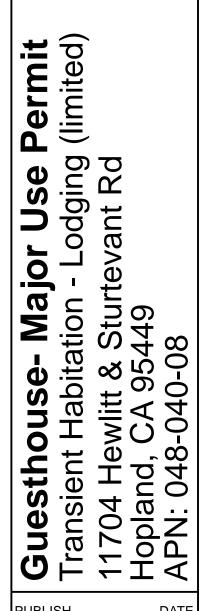


PUBLISH Use Permit Submittal 12/19/22

This drawing is the property of MH Architects. Any unauthorized use in part or in whole without written permission is prohibited. Date: Drawn by: Project No: Scale: 2118

(N) Second Floor Plan


A1.04

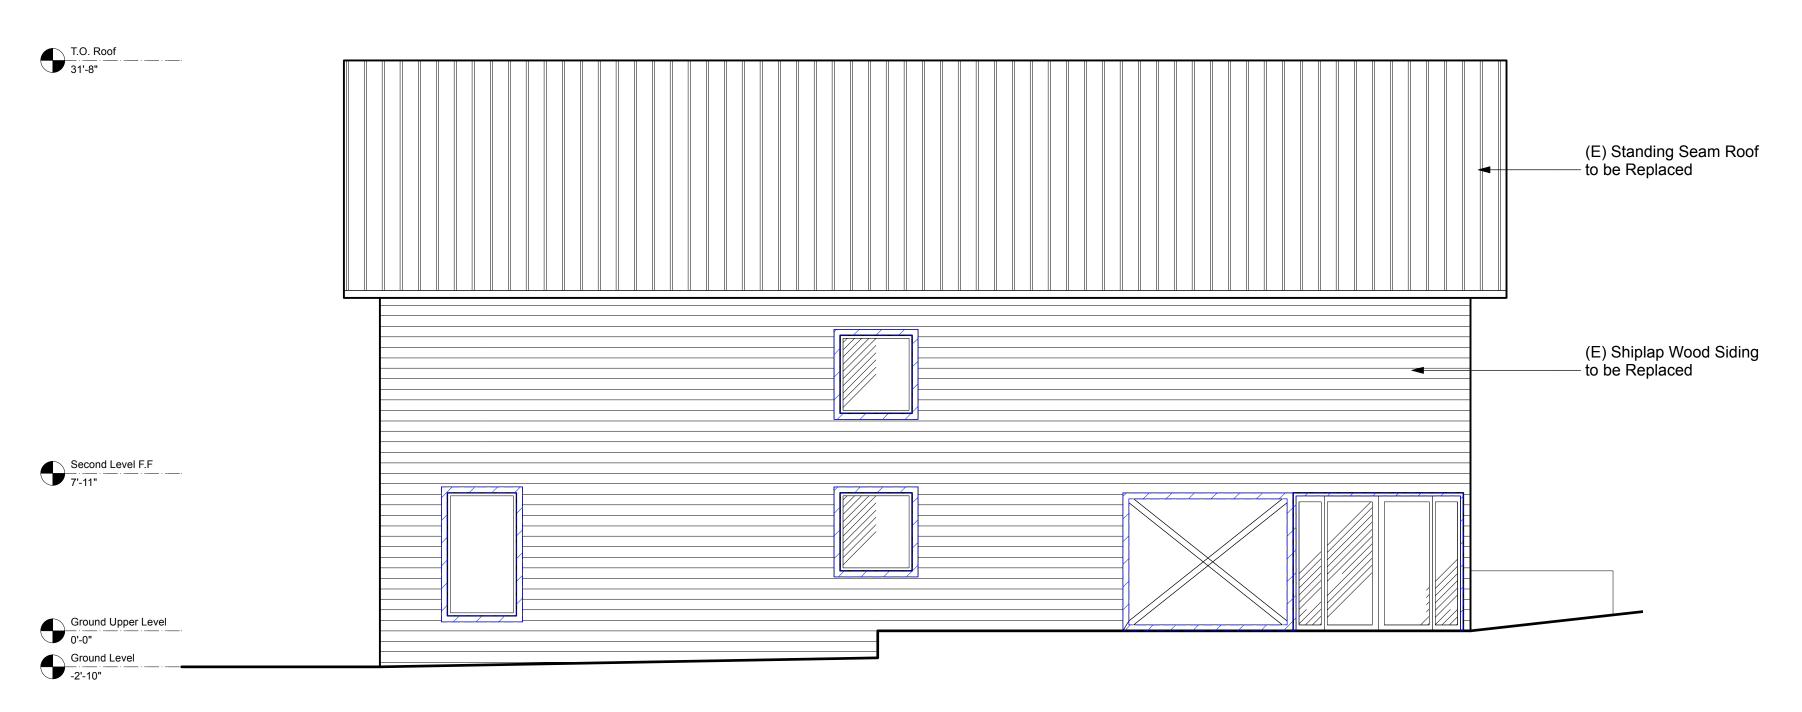


T.O. Roof 31'-8" 8.3 (E) Shiplap Wood Siding
— to be Replaced Second Level F.F
7'-11" Ground Level -2'-10"

NORTH ELEVATION
Scale: 3/16" = 1'-0"

1 EAST ELEVATION
Scale: 3/16" = 1'-0"

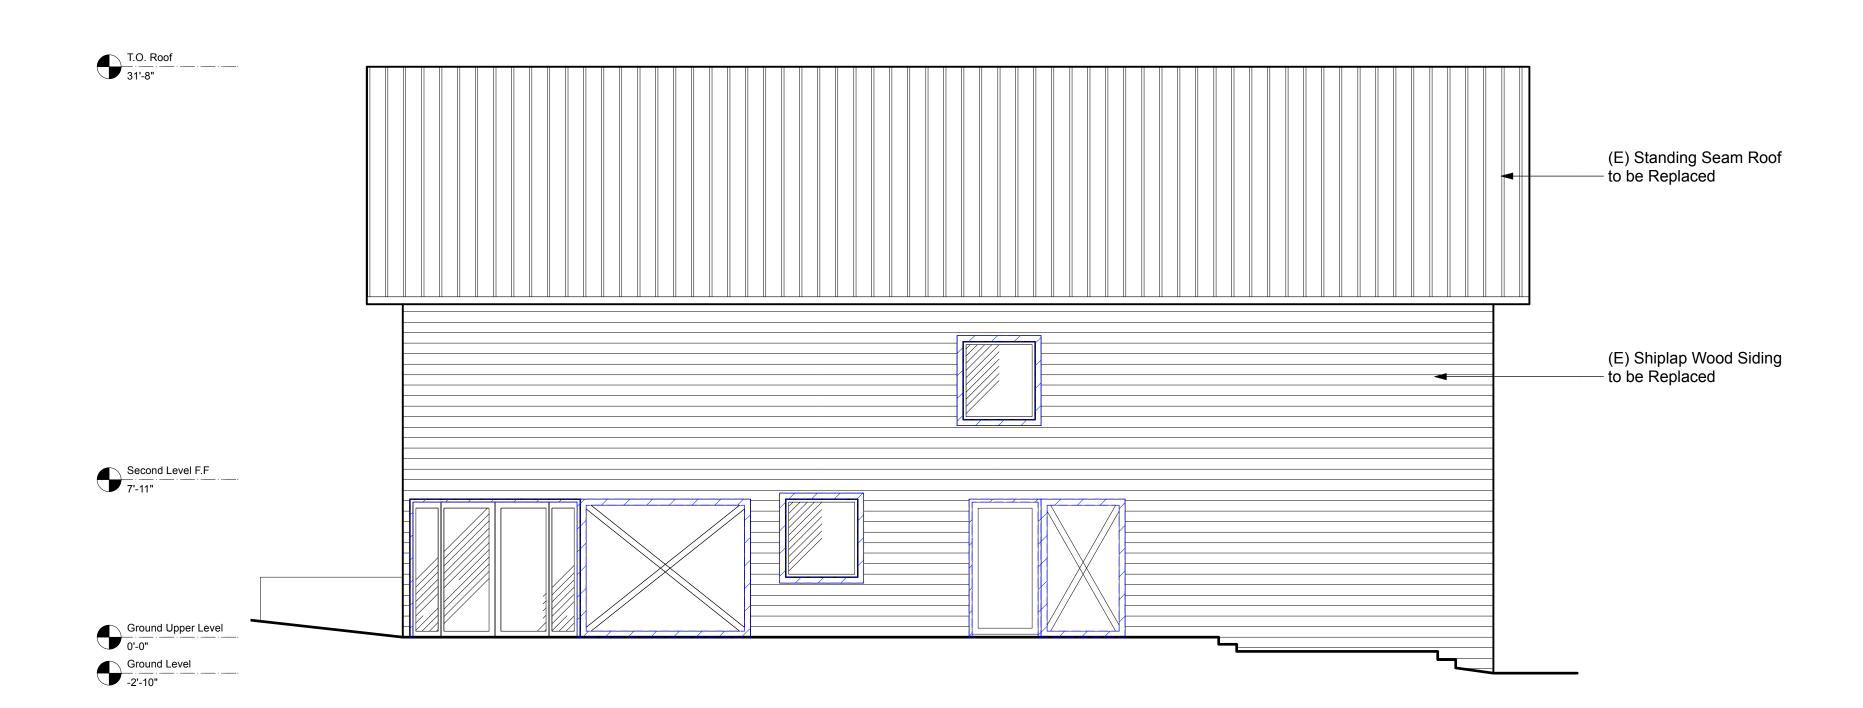

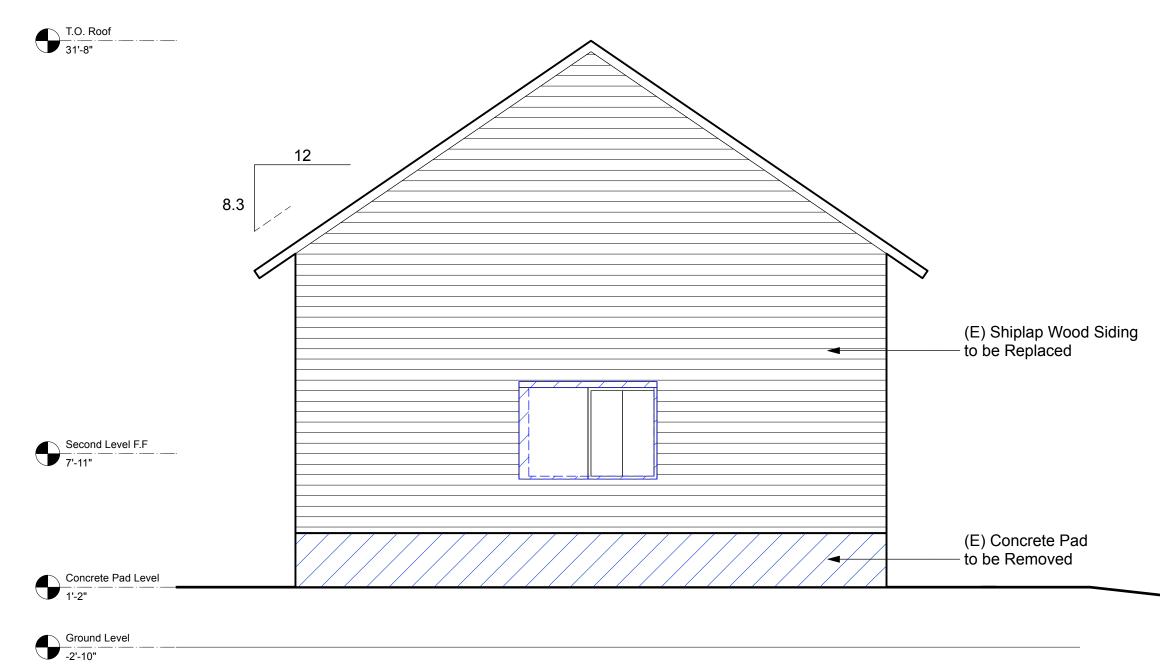

Scale: 3/16" = 1'-0"

3 WEST ELEVATION
Scale: 3/16" = 1'-0"





Guesthouse- Major Use Permit

Transient Habitation - Lodging (limited)

11704 Hewlitt & Sturtevant Rd

Hopland, CA 95449

APN: 048-040-08

PUBLISH Use Permit Submittal 12/19/22

This drawing is the property of MH Architects. Any unauthorized use in part or in whole without written permission is prohibited. Date: Drawn by: Project No: Scale: 12.19.22

2118

(E) Elevations

WUI Design Notes:

1 Roof Gutters: Per CRC 2019 Section R337.6
Roof gutters shall be provided with the means to prevent the accumulation of leaves and debris in the gutter.

2 Exterior Walls: Per CRC 2019 Section R337.7.3

The exterior wall covering or wall assembly shall be noncombustible or ignition-resistant material, a tested and approved wall assembly, or have one layer of 5/8" Type X gypsum sheathing applied and extend from the top of the foundation to the roof, and terminate at 2 inch nominal solid wood blocking between rafters at all roof overhands, or in the case of enclosed eaves, terminate at the enclosure.

(3) Open Roof Eaves: Per CRC 2019 Section R337.7.4

The exposed roof deck on the underside roof eaves shall consist of either noncombustible material, ignition-resistant material, one layer of 5/8" Type X gpysum sheathing applied behind an exterior covering on the underside exterior of the roof deck, or the exterior portion of a 1-hour fire resistive exterior wall assembly applied to the underside of the roof deck designed for exterior fire exposure including assembles using the gypsum panel and seheathing products in the Gypsum Association Fire Resistance Design Manual. With exceptions.

(4) Exterior Windows: Per CRC 2019 Section R337.8.21

Exterior glazed assemblies shall be constructred of multipane glazing w/ a min. of one tempered pane meeting the requirements of Section 2406 Safety Glazing, have a fire resistance rating of not less than 20 minutes, or meet SFM standards.

(5) Exterior Doors: Per CRC 2019 Section R337.8.3

The exterior surface or cladding of exterior doors shall be of noncombustible material, ignitition-resistant material, be of an assembly with a fire-resistance rating not less than 20 minutes, or have performance requirements as listed in code.

6 Deck-to-Wall Flashing: Per CRC 2019 Section R337.9.1

A minimum of a 6-inch metal flashing, applied vertically on the exterior of the wall, shall be installed at all the

7 Deck Walking Surface: Per CRC 2019 Section R337.9.4

deck-to-wall intersections.

The walking surface of decks, porches, balconies and stairs shall be of material that complies with the performance requirements stated in code, be of ignition-resistant material that complies with the performance requirements stated in code, or be exterior fire-retardant-treated-wood.







Guesthouse- Major Use PermitTransient Habitation - Lodging (limited)
11704 Hewlitt & Sturtevant Rd
Hopland, CA 95449
APN: 048-040-08

PUBLISH DATE
Use Permit Submittal 12/19/22

This drawing is the property of MH Architects. Any unauthorized use in part or in whole without written permission is prohibited.

Date: 12.19
Drawn by:
Project No: 2
Scale:

(P) South &
West

Elevations N
SHEET NO:

A2.02

WUI Design Notes:

1 Roof Gutters: Per CRC 2019 Section R337.6
Roof gutters shall be provided with the means to prevent the accumulation of leaves and debris in the gutter.

(2) Exterior Walls: Per CRC 2019 Section R337.7.3

The exterior wall covering or wall assembly shall be noncombustible or ignition-resistant material, a tested and approved wall assembly, or have one layer of 5/8" Type X gypsum sheathing applied and extend from the top of the foundation to the roof, and terminate at 2 inch nominal solid wood blocking between rafters at all roof overhands, or in the case of enclosed eaves, terminate at the enclosure.

③ Open Roof Eaves: Per CRC 2019 Section R337.7.4

The exposed roof deck on the underside roof eaves shall consist of either noncombustible material, ignition-resistant material, one layer of 5/8" Type X gpysum sheathing applied behind an exterior covering on the underside exterior of the roof deck, or the exterior portion of a 1-hour fire resistive exterior wall assembly applied to the underside of the roof deck designed for exterior fire exposure including assembles using the gypsum panel and seheathing products in the Gypsum Association Fire Resistance Design Manual. With exceptions.

(4) Exterior Windows: Per CRC 2019 Section R337.8.21

Exterior glazed assemblies shall be constructred of multipane glazing w/ a min. of one tempered pane meeting the requirements of Section 2406 Safety Glazing, have a fire resistance rating of not less than 20 minutes, or meet SFM standards.

(5) Exterior Doors: Per CRC 2019 Section R337.8.3

The exterior surface or cladding of exterior doors shall be of noncombustible material, ignitition-resistant material, be of an assembly with a fire-resistance rating not less than 20 minutes, or have performance requirements as listed in code.


6 Deck-to-Wall Flashing: Per CRC 2019 Section R337.9.1

A minimum of a 6-inch metal flashing, applied vertically on the exterior of the wall, shall be installed at all the deck-to-wall intersections.

7 Deck Walking Surface: Per CRC 2019 Section R337.9.4

The walking surface of decks, porches, balconies and stairs shall be of material that complies with the performance requirements stated in code, be of ignition-resistant material that complies with the performance requirements stated in code, or be exterior fire-retardant-treated-wood.



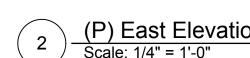






Guesthouse- Major Use Permit
Transient Habitation - Lodging (limited)
11704 Hewlitt & Sturtevant Rd
Hopland, CA 95449
APN: 048-040-08


This drawing is the property of MH
Architects. Any unauthorized use in part
or in whole without written permission is
prohibited.


Date: 12.19.2
Drawn by:
Project No: 211
Scale:


(P) North & East Elevations


SHEET NO: **A2.03**

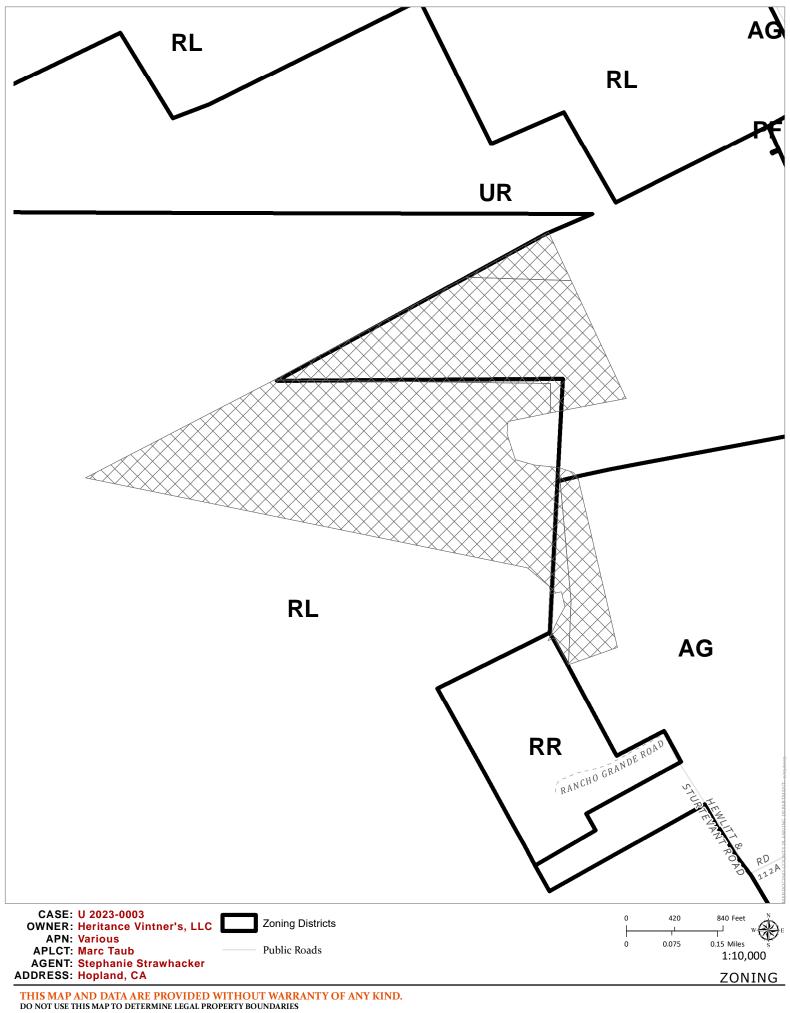


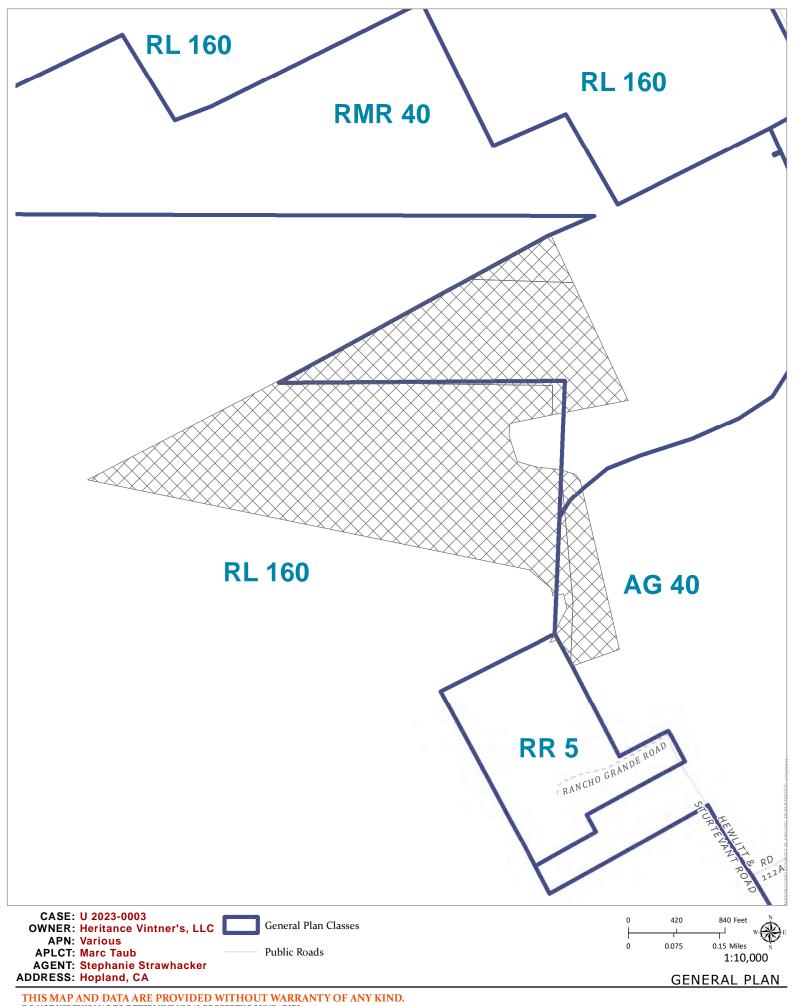


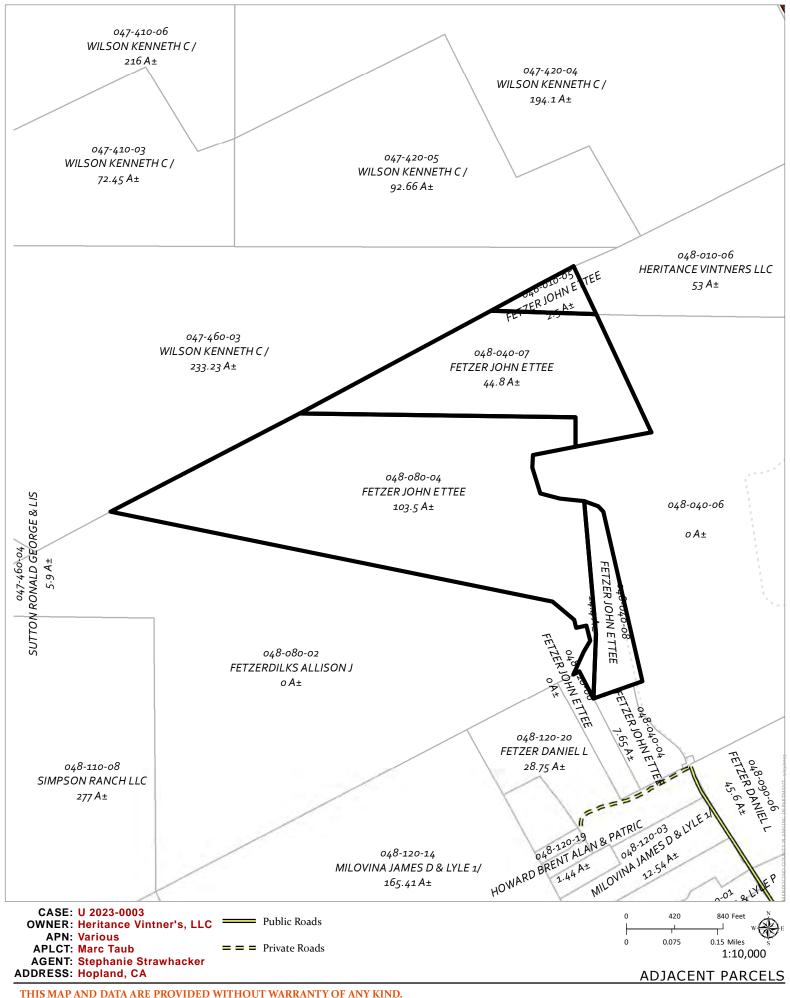


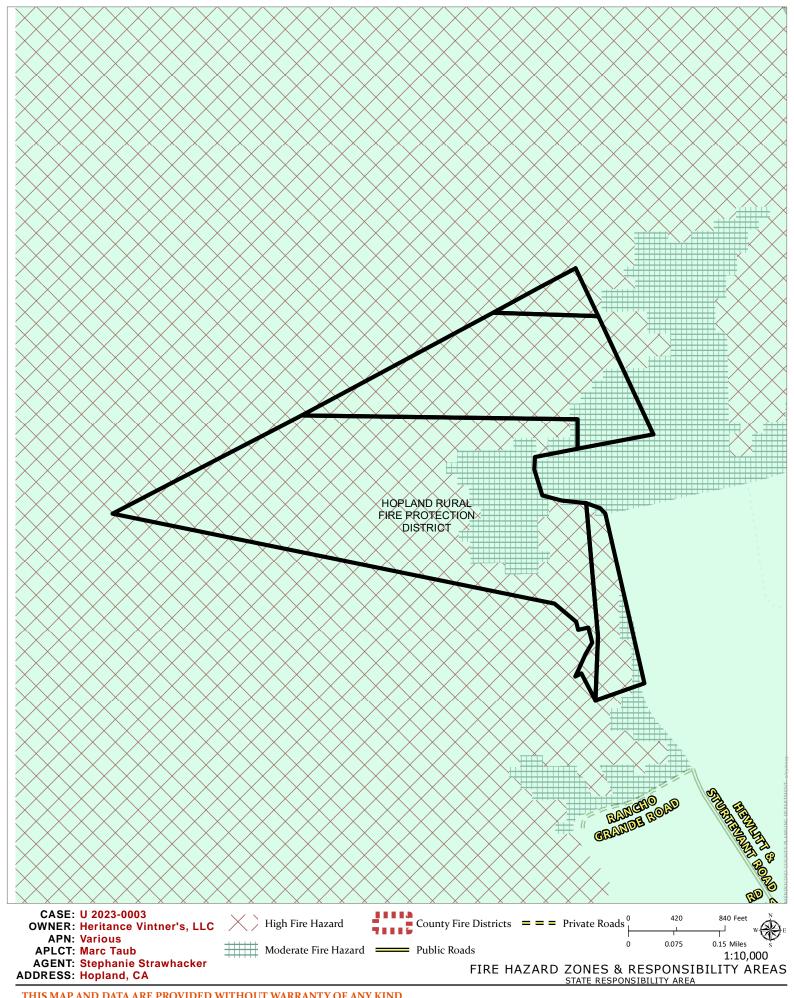

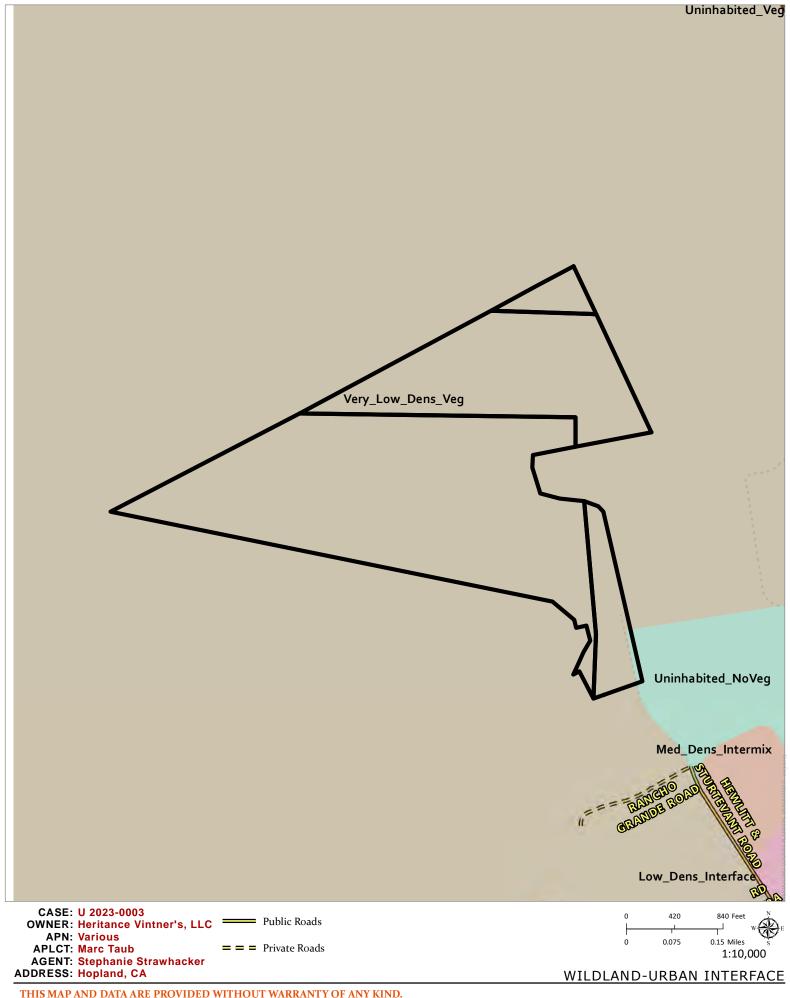


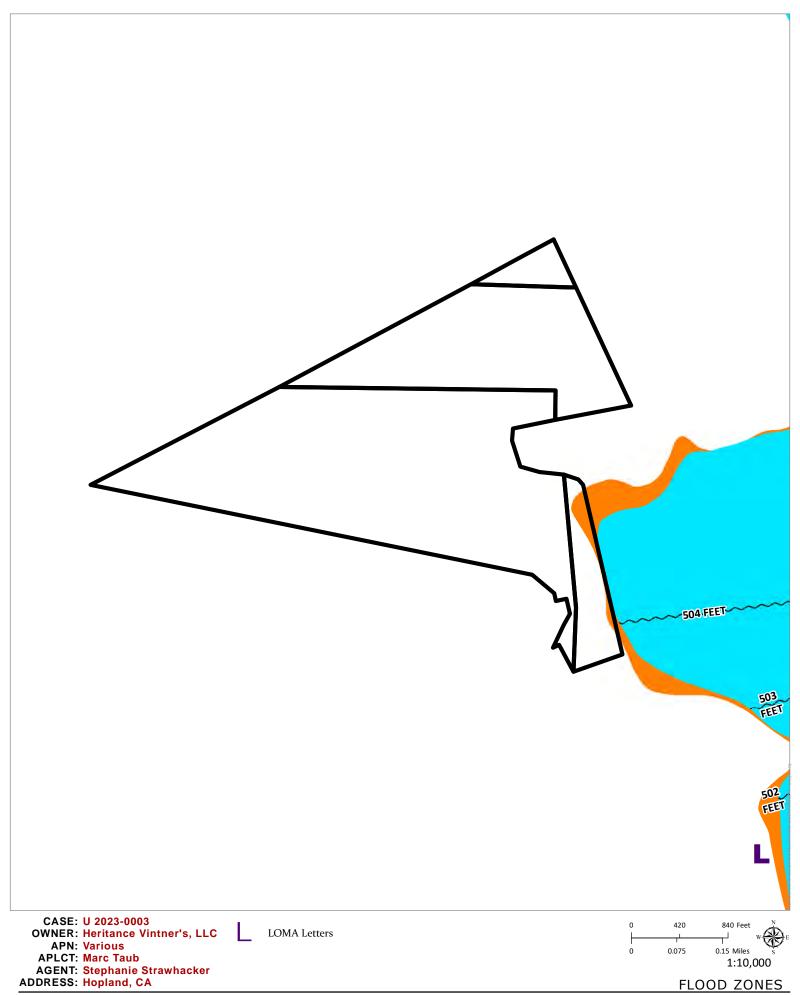

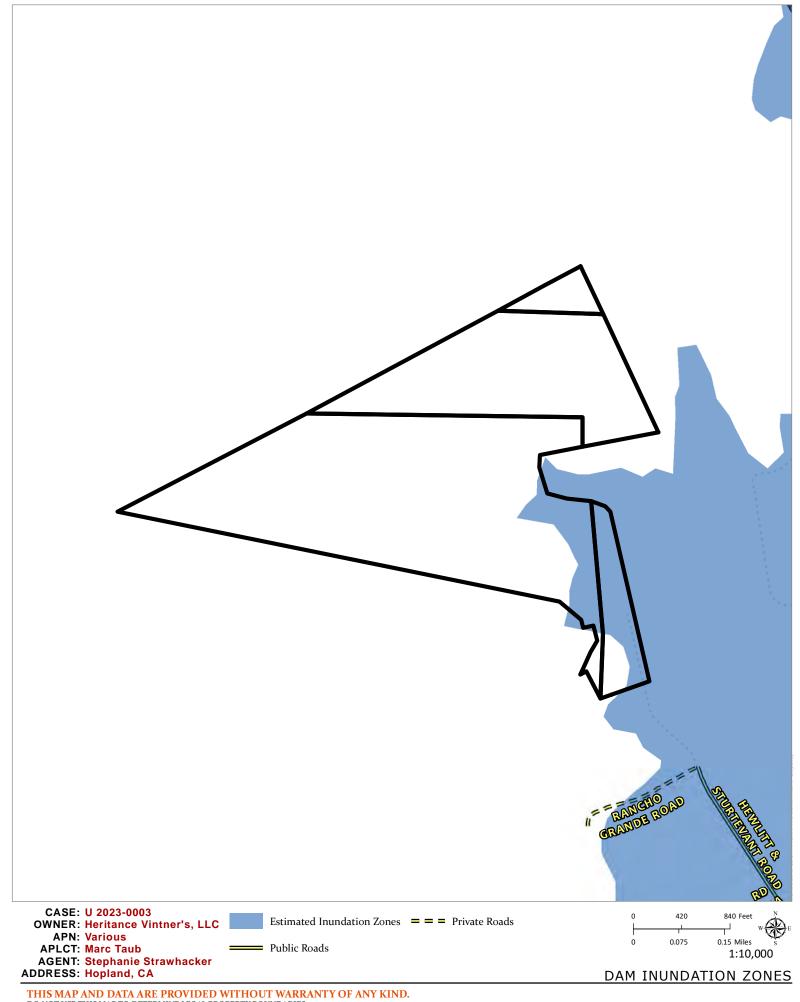


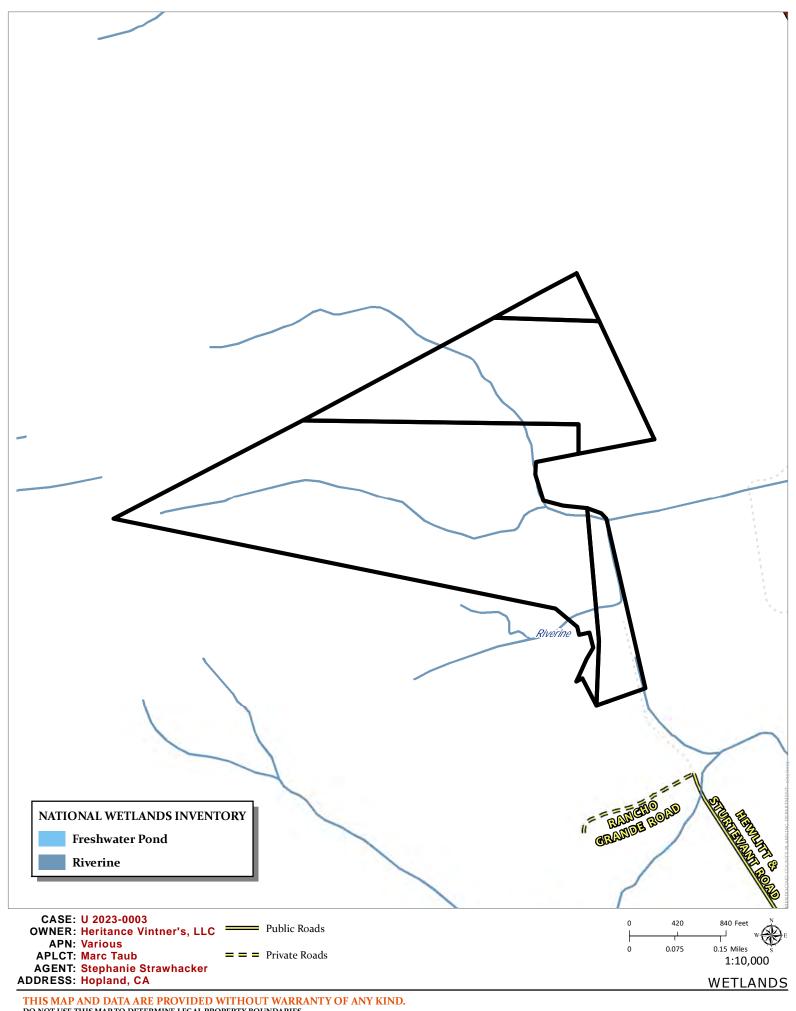





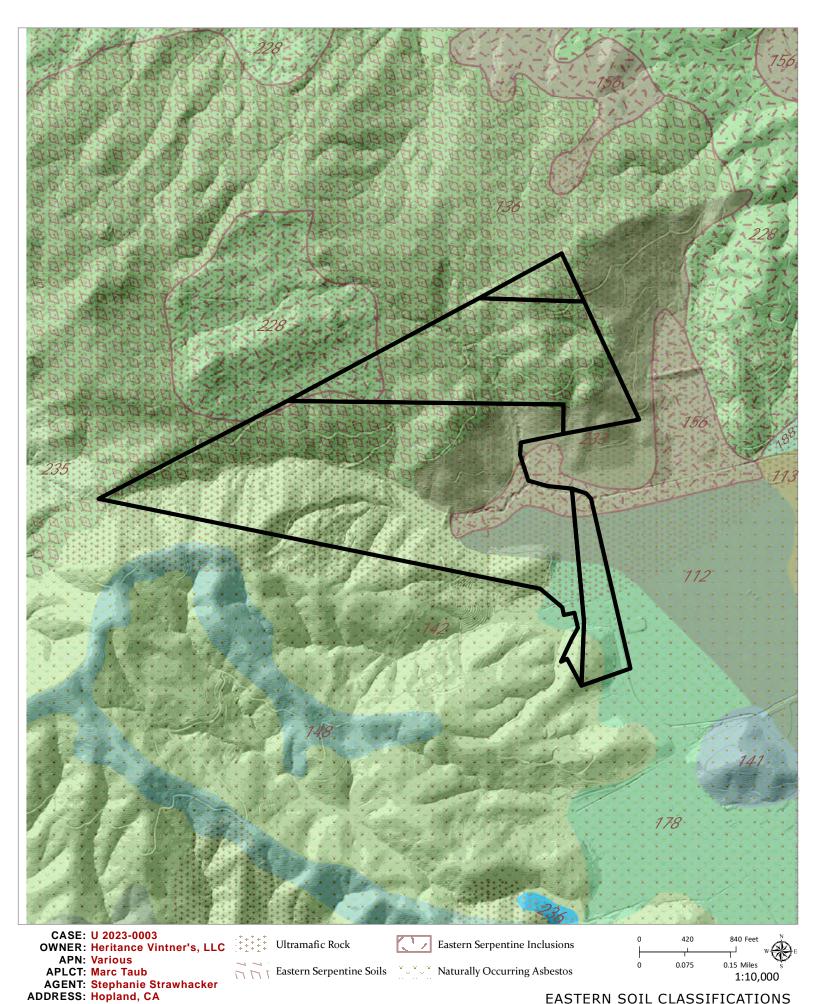


THIS MAP AND DATA ARE PROVIDED WITHOUT WARRANTY OF ANY KIND. DO NOT USE THIS MAP TO DETERMINE LEGAL PROPERTY BOUNDARIES

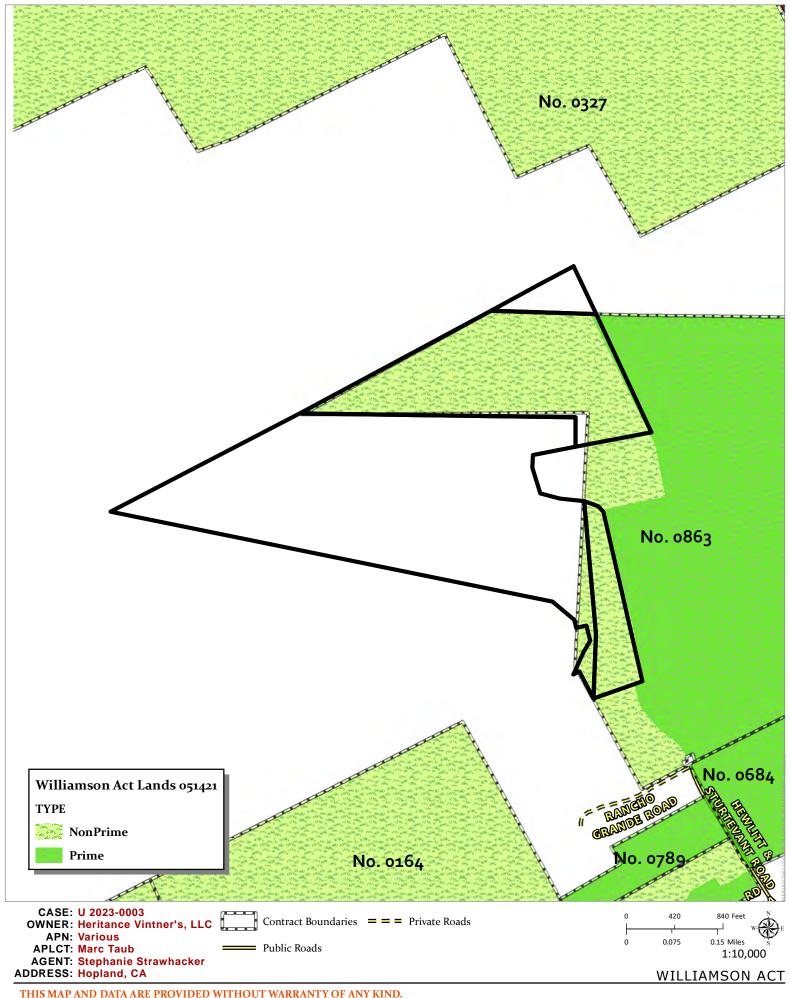

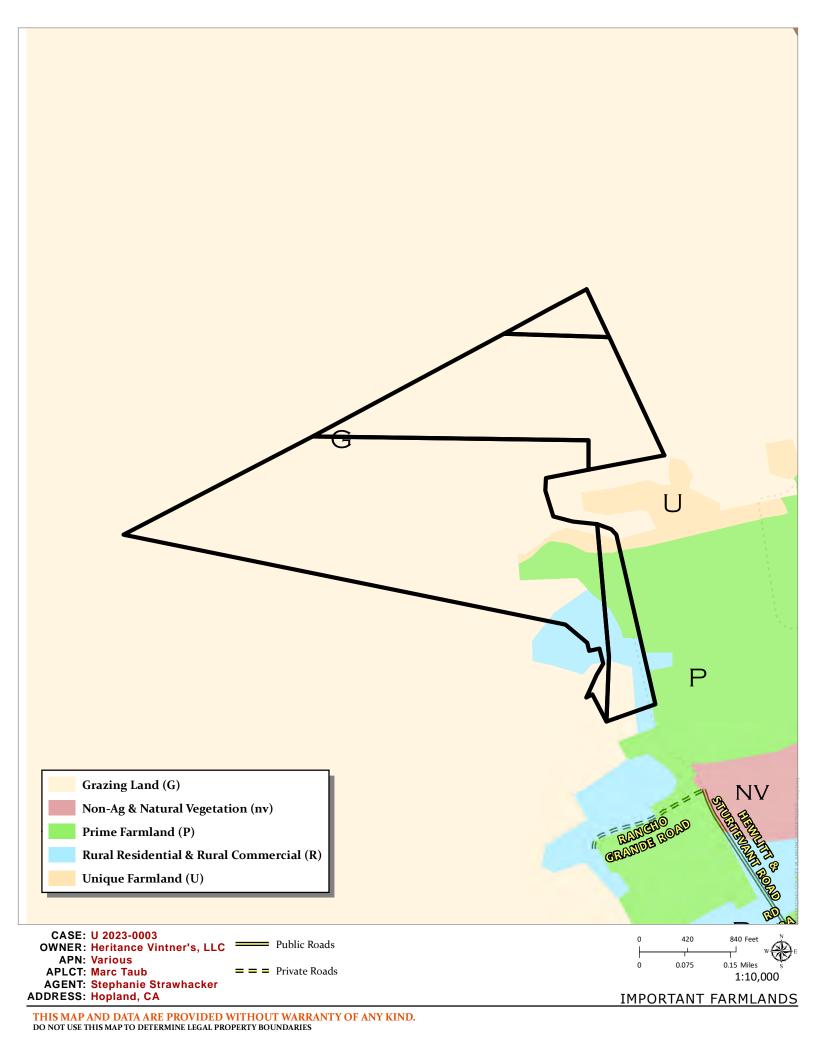

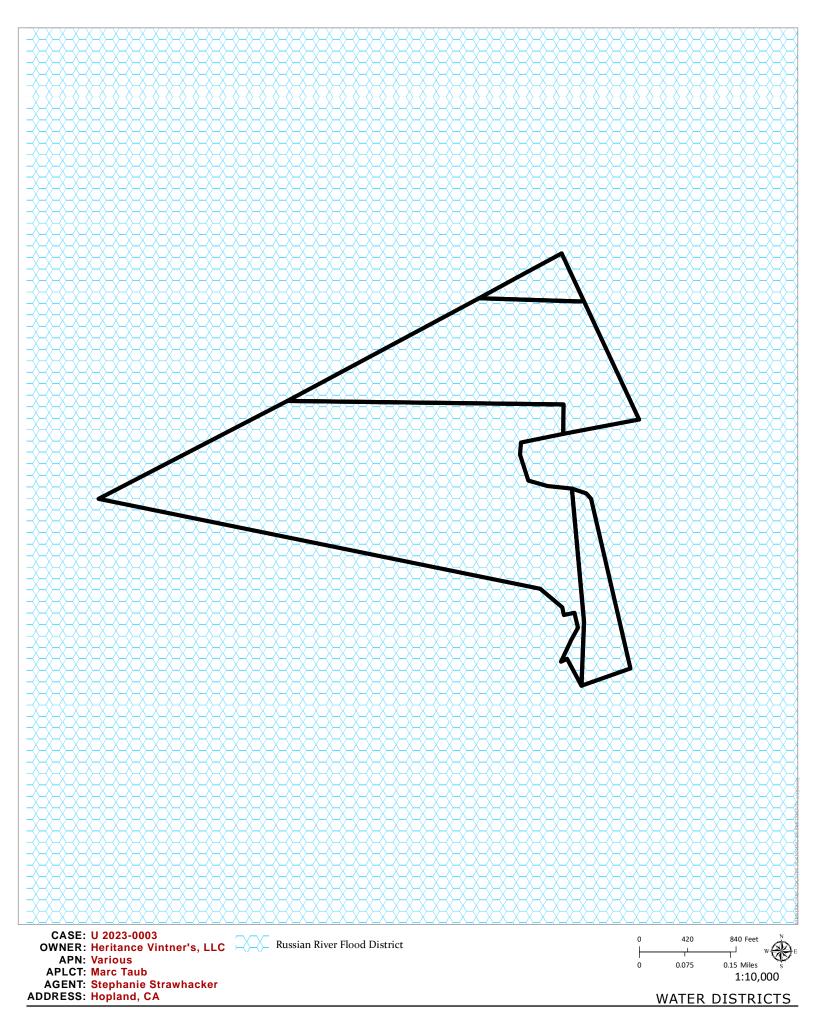

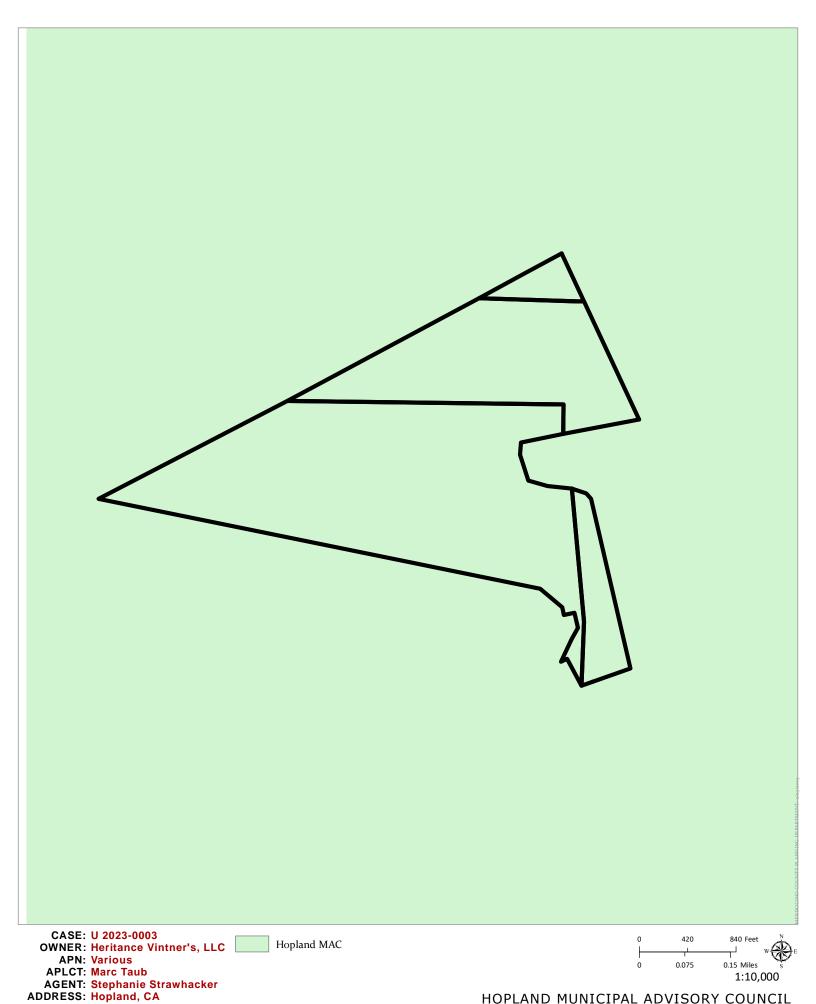

HOPLAND MUNICIPAL ADVISORY COUNCIL

