COUNTY OF MENDOCINO DEPARTMENT OF PLANNING AND BUILDING SERVICES

860 NORTH BUSH STREET · UKIAH · CALIFORNIA · 95482 120 WEST FIR STREET · FT. BRAGG · CALIFORNIA · 95437 JULIA KROG, DIRECTOR
TELEPHONE: 707-234-6650
FAX: 707-463-5709
FB PHONE: 707-964-5379
FB FAX: 707-961-2427
pbs@mendocinocounty.org/pbs
www.mendocinocounty.org/pbs

January 03, 2023

Department of Transportation Building Inspection - Ukiah Assessor Air Quality Management Cloverdale Rancheria Redwood Valley Rancheria Sherwood Valley Band of Pomo Indians Ukiah Valley Fire Department

Date __

CASE#: AP_2022-0047 **DATE FILED**: 11/3/2022

OWNER: KUKI AND LOVERS LANE PROPERTIE

APPLICANT: AT&T Mobility Services LLC

AGENT: Jaclyn Bellicitti

REQUEST: Administrative Permit to remove three existing antennas per sector for a total of nine removed, remove one existing RRU per sector for a total of three removed, remove one TMA per sector for a total of three removed, install four new antennas per sector for a total of twelve new antennas installed, install two new RRUs per sector for a total of six installed, install one new squid, install two new power trunks, install one new fiber trunk, install four new rectifiers, install two new circuit breakers and install two new BBUs in existing racks. No expansion of the ground lease area is proposed.

LOCATION: Approximately 0.1± miles north of Ukiah, lying on the north side of Kuki Lane (CR# 250A), approximately 300 feet West of its intersection with North State Street (CR# 104); located at 1460 Lover's Lane,

Ukiah; APN: 170-120-12.

Signature _

SUPERVISORIAL DISTRICT: 1

STAFF PLANNER: KEITH GRONENDYKE **RESPONSE DUE DATE:** January 17, 2023

PROJECT INFORMATION CAN BE FOUND AT:

www.mendocinocounty.org

Select "Government" from the drop-down; then locate Planning and Building Services/Public Agency Referrals.

Mendocino County Planning & Building Services is soliciting your input, which will be used in staff analysis and forwarded to the appropriate public hearing. You are invited to comment on any aspect of the proposed project(s). Please convey any requirements or conditions your agency requires for project compliance to the project coordinator at the above address, or submit your comments by email to pbs@mendocinocounty.org. Please note the case number and name of the project coordinator with all correspondence to this department.

We have reviewed the above application and recommend the following (please check one):
☐ No comment at this time.
Recommend conditional approval (attached).
Applicant to submit additional information (attach items needed, or contact the applicant directly, copying Planning and Building Services in any correspondence you may have with the applicant)
Recommend denial (Attach reasons for recommending denial).
Recommend preparation of an Environmental Impact Report (attach reasons why an EIR should be required).
Other comments (attach as necessary).
REVIEWED BY:

Department _

REPORT FOR: ADMINISTRATIVE PERMIT

OWNER: KUKI AND LOVERS LANE PROPERTIE

APPLICANT: AT&T MOBILITY LLC

AGENT: AT&T/JACLYN BELLICITTI

REQUEST: Administrative Permit to remove three existing antennas per sector for a total of nine removed,

remove one existing RRU per sector for a total of three removed, remove one TMA per sector for a total of three removed, install four new antennas per sector for a total of twelve new antennas installed, install two new RRUs per sector for a total of six installed, install one new squid, install two new power trunks, install one new fiber trunk, install four new rectifiers, install two new circuit breakers and install two new BBUs in existing racks. No expansion of the ground lease area is proposed.

LOCATION: Approximately 0.1± miles north of Ukiah, lying on the north side of Kuki Lane (CR# 250A),

approximately 300 feet West of its intersection with North State Street (CR# 104); located at 1460

Lover's Lane, Ukiah; APN: 170-120-12.

APN: 170-120-12

PARCEL SIZE: 84± Square Foot Facility on 4.32± Acre Parcel

GENERAL PLAN: Mixed Use (MU)

ZONING: General Commercial District (C2: 6K)

EXISTING USES: Mechanic shop, Restaurant and fueling facility

DISTRICT: Supervisorial District 1 (McGourty)

RELATED CASES:

Parcel Development

Boundary Line Adjustment #B 96-96 resulted in the current parcel configuration.

Use Permits

- Use Permit #U 3-2006 permitted Edge Wireless, now AT&T, to add three panel antennas and associated ground equipment to the 73-foot tall "76" gas station sign support structure.
- Use Permit Renewal #UR 2021-0002 renewed the original Use Permit (UM 3-2006/2011) for an additional ten years. This renewal will expire on May 19, 2031.
- Administrative Permits
 - Administrative Permit #AP2020-0047 permitted a backup generator to be installed at the base of the existing sign/cell tower.
 - Administrative Permit # AP 2020-0031 permitted a backup generator to be installed at the base of the existing sign/cell tower.
 - Administrative Permit #AP 2021-0012 permitted new antennas to replace existing ones.
- Modifications
 - Use Permit Modification #UM 3-2006/2009 was approved by the Planning Commission on August 20, 2009, permitting T-Mobile to add three panel antennas to the "76" gas station sign support structure.
 - Use Permit Modification #UM 3-2006/2011 was approved by the Planning Commission on May 19, 2011, allowing for the addition of three panel antennas to the existing sign structure.

	ADJACENT GENERAL	ADJACENT ZONING	ADJACENT LOT	ADJACENT USES
	<u>PLAN</u>		<u>SIZES</u>	
NORTH:	Mixed Use	Multiple-Family Residential	0.34± acre	Residential
EAST:	Mixed Use	General Commercial District	0.63± acre	Commercial
SOUTH:	Commercial	General Commercial District	0.21 & 0.45± acre	Commercial
WEST:	Mixed Use	Limited Industrial	1.51 & 0.72 & 1.47±	Mixed Use
			acre	

REFERRAL AGENCIES

LOCAL

☑ Air Quality Management District
 ☑ Building Division (Ukiah)
 ☑ Department of Transportation (DOT)

☑ Assessor☑ Ukiah Valley Fire Department

TRIBAL

□ Redwood Valley Rancheria

CASE: AP_2022-0047

□ Cloverdale Rancheria

ADDITIONAL INFORMATION: The subject telecommunications facility first functioned as a service sign for a gas station located on the subject property. On May 19, 2011 the Mendocino County Planning Commission approved UM_2011-0004 and established the sign as a telecommunications tower with an 84± square foot base station.

ENVIRONMENTAL DATA

1. MAC:

NA

2. FIRE HAZARD SEVERITY ZONE:

None

3. FIRE RESPONSIBILITY AREA:

Local responsibility area

4. FARMLAND CLASSIFICATION:

Urban

5. FLOOD ZONE CLASSIFICATION:

NO

6. COASTAL GROUNDWATER RESOURCE AREA:

NA

7. SOIL CLASSIFICATION:

Eastern soil types #210

8. PYGMY VEGETATION OR PYGMY CAPABLE

SOIL:

, Pygmy Soils Maps; GIS

No

9. WILLIAMSON ACT CONTRACT:

No

10. TIMBER PRODUCTION ZONE:

NO

11. WETLANDS CLASSIFICATION:

No

12. EARTHQUAKE FAULT ZONE:

No

13. AIRPORT LAND USE PLANNING AREA:

No

14. SUPERFUND/BROWNFIELD/HAZMAT SITE:

15. NATURAL DIVERSITY DATABASE:

No

16. STATE FOREST/PARK/RECREATION AREA

ADJACENT:

17. LANDSLIDE HAZARD:

-61: General Plan 4-44

No

18. WATER EFFICIENT LANDSCAPE REQUIRED:

No

19. WILD AND SCENIC RIVER:

20. SPECIFIC PLAN/SPECIAL PLAN AREA:

No

21. STATE CLEARINGHOUSE REQUIRED:

No

22. OAK WOODLAND AREA:

No

23. HARBOR DISTRICT:

NA



PLANNING & BUILDING SERVICES

CASE NO:	AP 2022-0047
DATE FILED:	11-3-22
FEE:	\$278600
RECEIPT NO:	
RECEIVED BY:	K-C7
	Office Use Only

APPLICATION FORM

APPLICANT:		
Name: AT&T Mobility Services LLC	Phone: 408	3-691-3113
Mailing Address:		
City:State/Zip:	_{Email:} jbe	ellicitti@j5ip.com
PROPERTY OWNER:		
_{Name:} Faizan Corp.	Phone: 40 8	3-691-3113
Mailing Address: 390 E Gobbi St		
City: Ukiah State/Zip: C	AEmail:	
AGENT:		
_{Name:} Jaclyn Bellicitti, J5, on behalf o	f AT&T Phone: 408	3-691-3113
Mailing Address: 23 Mauchly Ste		
City: Irvine State/Zip: C		ellicitti@j5ip.com
ASSESSOR'S PARCEL NUMBER/S: 170		
TYPE OF APPLICATION:		
 □ Administrative Permit □ Agricultural Preserve: New Contract □ Agricultural Preserve: Cancellation □ Agricultural Preserve: Rescind & ReEnter □ Airport Land Use □ Development Review □ Exception 	☐ General Plan Amendment ☐ Land Division — Minor ☐ Land Division — Major ☐ Land Division — Parcel ☐ Land Division — Re-Subdivision ☐ Modification of Conditions ☐ Reversion to Acreage	 ☐ Use Permit – Cottage ☐ Use Permit – Minor ☐ Use Permit – Major ☐ Use Permit – Modification ☐ Variance ☐ Other
☐ Flood Hazard Development Permit	☐ Rezoning	Mendocino County
certify that the information submitted with this appl	ication is true and accurate.	NOV 03 2022
	F	Planning & Building Services
Jaclyn Bellicitti 111	1/22	
investigate of Applicant / Applicant	Cinnat Co	Data

Signature of Applicant/Agent

Date

Signature of Owner

Date

SITE AND PROJECT DESCRIPTION QUESTIONNAIRE

The purpose of this questionnaire is to relate information concerning your application to the Department of Planning and Building Services and other agencies who will be reviewing your project proposal. Please remember that the clearer picture that you give us of your project and the site, the easier it will be to promptly process your application. Please answer all questions. Those questions which do not pertain to your project please indicate "Not applicable" or "N/A".

THE PROJECT

1. Describe your project. Include s	econdary improvemen	ts such as wells, septic	systems, grading	, vegetation removal	l, roads, etc.
Modification to an existing	unmanned AT&	T telecommunica	ntions facility,	consisting of th	e following:
Remove 3 existing anten	nas per sector (total 9), remove	1 existing Rf	RUS 11 B12 pe	er sector
(total 3), remove 1 existir	ng TMA per secto	or (total 3), insta	ll 4 new ante	nnas per secto	r (total 12),
install 1 new RRUS 4478	B B12A per secto	or (total 3), insta	II 1 new RRU	S 4415 B25 pe	er sector
(total 3), install 1 new DC	9 Squid, install	2 new #6 AWG	DC power tru	ınks, install 1 n	iew fiber
trunks, install 4 new recti	fiers in existing [DC power plant,	install 2 new	2P circuit brea	kers in AC
panel, install 1 new 6630	BBU in existing	rack, install 1 n	ew 6648 BBI	J in existing ra	ck
,					
2. Structures/Lot Coverage	NO. O	F UNITS		SQUARE FOOTAGE	
	EXISTING	PROPOSED	EXISTING	PROPOSED	TOTAL
☐ Single Family ☐ Mobile Home ☐ Duplex ☐ Multifamily ☐ Other: ☐ Other:			173.68	No Change	173.68
GRAND TOTAL (Equal to gross area	of Parcel): 173.68 s	sqft			

3. If the project is commercial, industrial or institutional, complete the following:	
Estimated No. of Employees per shift: Unmanned	
Estimated No. of shifts per day: N/A	
Type of loading facilities proposed: N/A	

Will the project be phased?		
☐ YES ☐ NO If yes, explain your plans	for phasing:	
Will vegetation be removed on areas other than	the building sites and roads	5?
☐ YES ■ NO If no, explain:		
	W. 118 - 211	
	tentially hazardous materia	ls such as toxic substances, flammables, or explosives
☐ YES		
How much off-street parking will be provided?	Number	Size
No. of covered spaces:		
No. of uncovered spaces:		
No. of standard spaces: No. of accessible spaces:		
Existing no. of spaces:		
Proposed additional spaces:	NIΛ	N/A
Total:	<u>N/A</u>	<u>N/A</u>
Is any road construction or grading planned? If y	es, grading and drainage pla	ans may be required.
		., steep, moderate slope, flat, etc.)
, parameter		
For grading or road construction, complete the fo	ollowing:	
Amount of cut: N/A	cubic yards	
Amount of fill: N/A		
Max. height of fill slope: N/A		
Max. height of cut slope: N/A		
a		
Amount of import/export: N/A		

10. Does the may be requ	project involve sand removal, mining or gravel extraction? If yes, detailed extraction, reclamation and monitoring plans red. ■ NO
☐ TE3	
11. Will the p	roposed development convert land currently or previously used for agriculture to another use? NO
12. Will the	evelopment provide public or private recreation opportunities? ■ NO If yes, explain how:
<u></u>	
-	
13. Is the pro	posed development visible from State Highway 1 or other scenic route? I NO
14. Is the pro	posed development visible from a park, beach or other recreational area?
15. Does the	development involve diking, filling, dredging or placing structures in open coastal water, wetlands, estuaries or lakes?
Diking:	☐ YES
Filling:	☐ YES XI NO
Dredging Structure	
If so who	: is the amount of material to be dredged/filled?: cubic yards
	of dredged material disposal site?:
	Army Corps of Engineers permit been applied for?
16. Will ther	be any exterior lighting? ■ NO If yes, describe below and identify the location of all exterior lighting on the plot and building plans.
	rill be supplied to the site as follows:
Electricit	: □ Utility Company (service exists to parcel) □ Utility Company (requires extension of service to site): feet miles □ On Site Generation – Specify:
Gas:	 ☐ Utility Company/Tank ☐ On Site Generation – Specify: ☐ None
Telephor	

24. Will any existing structure be demolished or removed? If yes, describe the type of development to be demolished or removed including the relocation site, if applicable. ☐ YES ■ NO N/A	ved,
□ YES □ NO N/A	
23. Are there existing structures on the property? If yes, describe below and identify the use of each structure on the plot plan tentative map if the proposal is for a subdivision.	or
22. Describe the location of the site in terms of readily identifiable landmarks: (e.g., mailboxes, mile posts, street intersections Enclosed area/under billboard next to the parking lot of Ukiah Truck Repair shop.	, etc.)
N/A	
21. List and describe any other related permits and other public approval required for this project, including those required by County departments, city, regional, State and Federal agencies:	other
20. Are there any associated projects and/or adjacent properties under your ownership? — YES — NO If yes, explain: (e.g., Assessor's Parcel Number, address, etc.)	
□ Spring □ Other (specify): N/A	
19. What will be the domestic water source: ☐ Community Water System (specify supplier): ☐ Well	
☐ Other (specify): N/A	
18. What will be the method of sewage disposal? Community Sewage System (specify supplier): Septic Tank	

25. What is the	maximun	n height of a	II structures	?					
Existing: N/		-							
Proposed: _		feet							
26. What is the	gross floo	or areas of al	ll structures,	including cov	vered parki	ing and accesso	ory buildings	?	
Existing: N/	4	square feet	t						
		square feet							
27. What is the	total lot a	area within p	property line	s?					
Total Lot Are	ea: <u>N/A</u>		□ acres □ sq	uare feet					
28. Briefly desc soil stability, pl be helpful: N/A									
29. Briefly desc Indicate the typ be helpful. Surrounded by bu	e of land	use (use cha	art below) an						
									
30. Indicate the									
				Commercial		Public Facility			
North:	X			☐ N 20					
East:				X					
South:				(X)					
West:		Ш	اسا		J	ш		П	

Indemnification And Hold Harmless

ORDINANCE NO. 3780, adopted by the Board of Supervisors on June 4, 1991, requires applicants for discretionary land use approvals, to sign the following Indemnification Agreement. Failure to sign this agreement will result in the application being considered incomplete and withheld from further processing.

Indemnification Agreement

As part of this application, applicant agrees to defend, indemnify, release and hold harmless the County of Mendocino, its agents, officers, attorneys, employees, boards and commissions, as more particularly set forth in Mendocino County Code Section 1.04.120, from any claim, action or proceeding brought against any of the foregoing individuals or entities, the purpose of which is to attack, set aside, void or annul the approval of this application or adoption of the environmental document which accompanies it. The indemnification shall include, but not be limited to, damages, costs, expenses, attorney fees or expert witness fees that may be asserted by any person or entity, including the applicant, arising out of or in connection with the approval of this application, whether or not there is concurrent, passive or active negligence on the part of the County, its agents, officers, attorneys, employees, boards and commissions.

Date	Applicant

COUNTY OF MENDOCINO

DEPARTMENT OF PLANNING & BUILDING SVCS.

860 NORTH BUSH STREET • UKIAH, CALIFORNIA 95482 120 WEST FIR STREET • FORT BRAGG, CALIFORNIA 95437 IGNACIO GONZALEZ, INTERIM DIRECTOR
JULIA ACKER-KROG, ASSISTANT DIRECTOR
PHONE: 707-234-6650

FAX: 707-463-5709
FB PHONE: 707-964-5379

11/1/22

FB Fax: 707-961-2427 pbs@mendocinocounty.org www.mendocinocounty.org/pbs

ACKNOWLEDGEMENT OF DEPOSIT/HOURLY FEE


By signing below, the applicant acknowledges that the staff at Planning and Building Services has discussed the potential for collection of a deposit fee for the projects listed below (as adopted by the Board of Supervisors Resolution No.'s 11-072, 16-150, 18-122 and 19-170)

- 1. Division of Land Project
- 2. General Plan Project
- 3. Coastal Project
- 4. Zoning Project
- 5. Administrative Project
- 6. Cannabis Project
- 7. Private Road Naming

Once an application has been submitted and the processing costs approach 80% of the application fee, additional staff processing time will be billed at \$90.00/hour. Staff will notify the applicant/owner that a deposit equal to 50% of the initial filing fee is required for further processing, and more than one deposit may be required depending on the complexity of the project and the staff time necessary to complete application processing.

I acknowledge that I was advised of the deposit fee for continued processing after the initial application fee has been expended.

clyn Bellicitti	11/1/22
Applicant Signature	Date
OFFICE USE ONLY:	
Project or Permit Number	

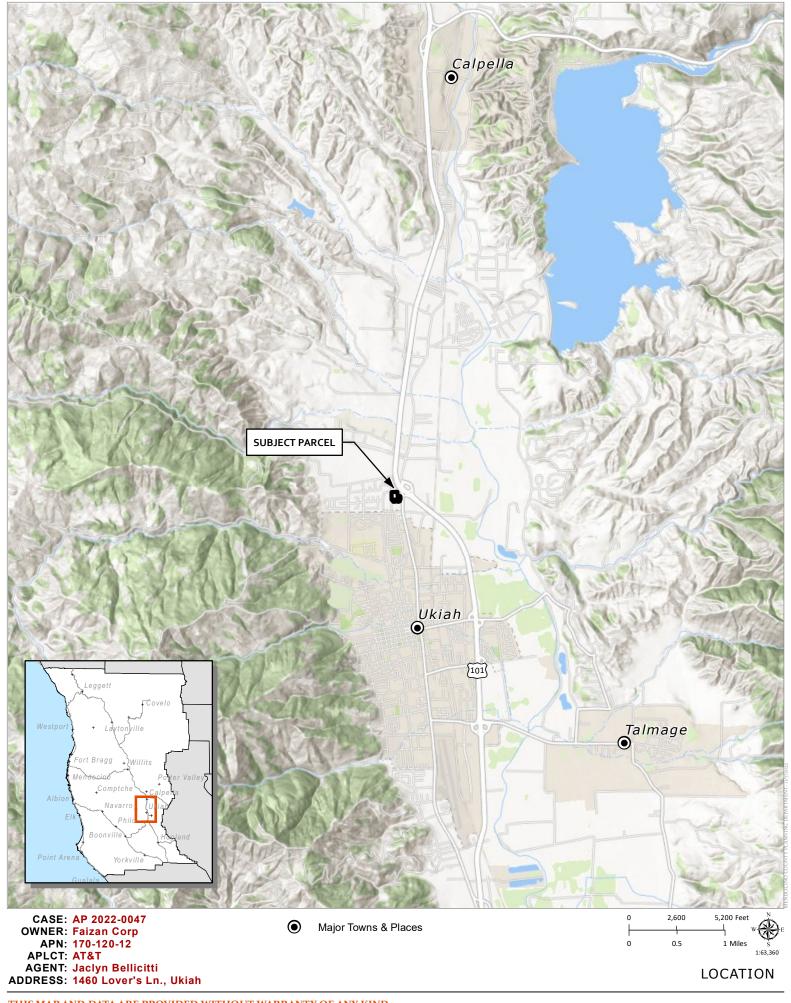



CODE COMPLIANCE

ALL WORK AND MATERIALS SHALL BE PERFORMED AND INSTALLED IN ACCORDANCE WITH THE CURRENT EDITIONS OF THE FOLLOWING CODES AS ADOPTED BY THE LOCAL GOVERNING AUTHORITIES. NOTHING IN THESE PLANS IS TO BE CONSTRUED TO PERMIT WORK NOT CONFORMING

CALIFORNIA BUILDING STANDARDS CODE: 2019 TRIENNIAL EDITION OF TITLE 24, WITH AN EFFECTIVE DATE OF JANUARY 1, 2020.
PART 1 - CALIFORNIA ADMINISTRATIVE CODE

PART 2 - CALIFORNIA BUILDING CODE, BASED ON THE 2018 INTERNATIONAL BUILDING CODE

PART 2.5 - CALIFORNIA RESIDENTIAL CODE, BASED ON THE 2018 INTERNATIONAL RESIDENTIAL CODE PART 3 - CALIFORNIA ELECTRICAL CODE, BASED ON THE 2017

NATIONAL ELECTRICAL CODE
PART 4 - CALIFORNIA MECHANICAL CODE, BASED ON THE 2018

UNIFORM MECHANICAL CODE PART 5 - CALIFORNIA PLUMBING CODE, BASED ON THE 2018 UNIFORM PLUMBING CODE

PART 6 - CALIFORNIA ENERGY CODE PART 7 - VACANT

PART 8 - CALIFORNIA HISTORICAL BUILDING CODE

PART 9 - CALIFORNIA FIRE CODE, BASED ON THE 2018 INTERNATIONAL

PART 10 - CALIFORNIA EXISTING BUILDING CODE, BASED ON THE 2018 INTERNATIONAL EXISTING BUILDING CODE
PART 11 - CALIFORNIA GREEN BUILDING STANDARDS CODE (ALSO

KNOWN AS CALGREEN) PART 12 - CALIFORNIA REFERENCED STANDARDS CODE

- ANSI/TIA-222 (REV H)
- 2018 NFPA 101, LIFE SAFETY CODE
- 2019 NFPA 72, NATIONAL FIRE ALARM AND SIGNALING CODE 2019 NFPA 13, STANDARD FOR THE INSTALLATION OF SPRINKLER

PROJECT TEAM

APPLICANT / LESSEE:

AT&T MOBILITY SERVICES, LLC 5001 EXECUTIVE PKWY CONTACT: DIANE DUSKIN Site Acquisition Manager FMAIL: dd231x@att.com CELL: (925) 277-6182

CONSTRUCTION MANAGER:

AT&T MOBILITY SERVICES LLC 5001 EXECUTIVE PKWY, SAN RAMON, CA 94583 CONTACT: DAVID KOCH Sr. Specialist-Tech EMAIL: dk5751@att.com CELL: (925) 353-0172

RF ENGINEER:

AT&T MOBILITY SERVICES, LLC 5001 EXECUTIVE PKWY, SAN RAMON, CA 94583 CONTACT: SAGAR BONDE RAN DESIGN & RF ENGINEER NCAL MARKET / AT&T MOBILITY PH: (323) 547-5845

LEASING & ZONING

J5 INFRASTRUCTURE PARTNERS 23 MAUCHLY, SUITE 110 IRVINE CA 92618 CONTACT: CHARLENE SCHLAGER EMAIL: cschlager@j5ip.com PH: (773) 732-5497

A&E MANAGER:

J5 INFRASTRUCTURE PARTNERS 23 MAUCHLY, SUITE 110 IRVINE, CA 92618 contact: JEFF CLARK ph: (949) 302-9801

SITE INFORMATION

FAIZAN CORP. 390 E GOBBI STREET UKIAH, CA 95482

JURISDICTION: MENDOCINO COUNTY A.P.N.: 170-120-12 CURRENT ZONING: LIMITED INDUSTRIAL EXISTING USE: MULTILISE MULTIUSE, COMMUNICATIONS FACILITY

PROPOSED USE LATITUDE (NAD 83):

LONGITUDE (NAD 83): -123.2129169°

123°12' 46.50084" W

ACCESSIBILITY REQUIREMENTS: FACILITY IS UNMANNED AND NOT FOR HUMAN HABITATION. ACCESSIBILITY IS NOT REQUIRED PER CBC2019, SECTION 11B-203,4 (LIMITED ACCESS SPACE)

39.1706111° 39° 10' 13.19996" N

POWER AGENCY

(800) 743-5000

TELEPHONE AGENCY:

RFDS VERSION: 2.00 DATE CREATED: 02/13/22



Planning & Building Services

LOCAL MAP

SITE NUMBER: CCI 00916

SITE NAME: UKIAH NORTH

SITE TYPE: BILLBOARD SIGN / OUTDOOR EQUIPMENT

1460 LOVERS LANE

ADDRESS: UKIAH, CA 95482

APPROVALS

THE FOLLOWING PARTIES HEREBY APPROVE AND ACCEPT THESE DOCUMENTS & AUTHORIZE THE SUBCONTRACTOR TO PROCEED WITH CONSTRUCTION DESCRIBED HEREIN. ALL DOCUMENTS ARE SUBJECT TO REVIEW BY LOCAL BUILDING DEPARTMENT & MAY IMPOSE CHANGES AND MODIFICATIONS.

DISCIPLINE:	SIGNATURE	DATE
RF ENGINEER:		
AT&T PM:		
CIVIL:		
A&E:		
SAQ PM:		
PROPERTY OWNER:		

PROJECT DESCRIPTION

MODIFICATION TO AN UNMANNED TELECOMMUNICATIONS FACILITY. CONSISTING OF THE FOLLOWING:

ANTENNA LOCATION:

- REMOVE (3) EXISTING ANTENNAS PER SECTOR (TOTAL-9)
- REMOVE (1) EXISTING RRUS 11 B12 PER SECTOR (TOTAL-3) REMOVE (1) EXISTING TMA PER SECTOR (TOTAL-3)
- INSTALL (4) NEW ANTENNAS PER SECTOR (TOTAL-12)
- INSTALL (1) NEW RRUS 4478 B12A PER SECTOR (TOTAL-3) INSTALL (1) NEW RRUS 4415 B25 PER SECTOR (TOTAL-3)
- INSTALL (1) NEW DC9 SQUID
- INSTALL (2) NEW #6 AWG DC POWER TRUNKS
- . INSTALL (1) NEW FIBER TRUNK

EQUIPMENT LOCATION:

- INSTALL (4) NEW RECTIFIERS IN EXISTING DC POWER PLANT
- INSTALL (2) NEW 2P CIRCUIT BREAKER IN AC PANEL
 INSTALL (1) NEW 6630 BBU IN EXISTING RACK
- INSTALL (1) NEW 6648 BBU IN EXISTING RACK

06/16/22 A 05/04/22 REV DATE DESCRIPTION Licensor RFV

SHEET INDEX



100% CD

100% CD

90% CD

PREPARED FOR

5001 EXECUTIVE PKWY

15 INFRASTRUCTURE

IRVINE, CALIFORNIA 92618

AT&T Site ID:

CCL00916

Vendor:

AT&T

It is a violation of law for any ersons, unless they are actin under the direction of a censed professional enginee to alter this document

sued For:

CCL00916

UKIAH NORTH

1460 LOVERS LANE UKIAH, CA 95482

TITLE SHEET

Sheet Number

T-1

GENERAL CONTRACTOR NOTES

VICINITY MAP

(e)

DO NOT SCALE DRAWINGS

USID: 99468

FA#: 10130027 5G NR 1SR CBAND

PTN#: 3701A154PB

5G NR 1SR CBAND

PTN#: 3701A15493 PACE#: MRSFR094841

TN#: 3701A13SB9 PACE#: MRSFR091534

PTN#: 3701A13SBV

PACE#: MRSFR091530

PACE#: MRSFR094611

4TXRX ANTENNA RETROFIT

BWE TOWER TOP RRH ADD

THESE PLANS ARE FORMATTED TO BE FULL SIZE AT 24" X 36". CONTRACTORS SHALL VERIFY ALL PLANS AND EXISTING DIMENSIONS AND CONDITIONS ON THE JOB SITE AND SHALL IMMEDIATELY NOTIFY THE ARCHITECT/ENGINEER IN WRITING OF ANY DISCREPANCIES BEFORE PROCEEDING WITH THE WORK OR MATERIAL ORDERS OR BE RESPONSIBLE FOR THE SAME

GENERAL NOTES

THE FACILITY IS UNMANNED AND NOT FOR HUMAN HABITATION. A TECHNICIAN WILL VISIT THE SITE AS REQUIRED FOR ROUTINE MAINTENANCE. THE PROJECT WILL NOT RESULT IN ANY SIGNIFICANT DISTURBANCE OR EFFECT ON DRAINAGE; NO SANITARY SEWER SERVICE, POTABLE WATER, OR trash disposal is required and no commercial signage is proposed.

STATEMENTS

STRUCTURAL ANALYSIS IS NOT WITHIN THE SCOPE OF WORK CONTAINED IN THIS DRAWINGS SET. FOR ANALYSIS OF EXISTING AND/OR PROPOSED COMPONENTS, REFER TO STRUCTURAL ANALYSIS PROVIDED UNDER SEPARATE COVER.

ANTENNA MOUNT ANALYSIS IS NOT WITHIN THE SCOPE OF WORK CONTAINED IN THIS DRAWING SET. FOR ANALYSIS OF MOUNT TO SUPPORT EXISTING AND/OR PROPOSED COMPONENTS. REFER TO ANTENNA MOUNT STRUCTURAL ANALYSIS PROVIDED UNDER SEPARATE COVER.

DIRECTIONS FROM AT&T OFFICE: 5001 EXECUTIVE PKWY, SAN RAMON CA 94583

- 1. TURN RIGHT ONTO EXECUTIVE PKWY
- 2. TURN LEFT ONTO CAMINO RAMON
- 3. USE THE LEFT TWO LANES TO TURN LEFT ONTO CROW CANYON ROAD
- 4. USE THE RIGHT TWO LANES TO MERGE ONTO 1-680 N VIA THE RAMP TO SACRAMENTO

DRIVING DIRECTIONS

- 5. MERGE ONTO I-680 N
- 6. TAKE EXIT 46A FOR SLATE ROUTE 24 TOWARD SAN FRANCISCO
- TAKE EXIT 2B TO MERGE ONTO 1-580 W TOWARD BERKELY/SACRAMENTO
- 8. TAKE EXIT 13B FOR I-580 TOWARD SAN RAFAEL/POINT RICHMOND
- 9. CONTINUE ONTO 1-580 W 10. MERGE ONTO US-101 N
- 11. CONTINUE ONTO US-101 N
- 12. TAKE EXIT 551 FOR N STATE STREET
- 13. TURN LEFT ONTO N STATE STREET
- 14. TURN RIGHT ONTO KUKU ANE 15. TURN RIGHT ONTO N LOVERS LANE
- 16. TURN LEFT ONTO FEED LOT LANE



TITLE SHEET GN-1 GENERAL NOTES SITE PLAN AND ENLARGED SITE PLAN A-2 EQUIPMENT PLANS EXISTING & PROPOSED ANTENNA PLANS A-3 A-3.1 PROPOSED RF SCHEDULE NORTH ELEVATIONS EAST ELEVATIONS D-1 DETAILS D-2 DETAILS_ G-1 GROUNDING PLANS & NOTES G-2 GROUNDING DETAILS SINGLE LINE DIAGRAM & AC PANEL SCHEDULE PLUMBING DIAGRAM EME-1 EME SIGNAGE LOCATION PLAN SITE SIGNAGE

GENERAL CONSTRUCTION NOTES:

- 1. PLANS ARE INTENDED TO BE DIAGRAMMATIC OUTLINE ONLY, UNLESS NOTED OTHERWISE. THE WORK SHALL INCLUDE FURNISHING MATERIALS, EQUIPMENT, APPURTENANCES AND LABOR NECESSARY TO COMPLETE ALL INSTALLATIONS AS INDICATED ON THE DRAWINGS.
- 2. THE CONTRACTOR SHALL OBTAIN, IN WRITING, AUTHORIZATION TO PROCEED BEFORE STARTING WORK ON ANY ITEM NOT CLEARLY DEFINED OR IDENTIFIED BY THE CONTRACT DOCUMENTS.
- 3. CONTRACTOR SHALL CONTACT USA (UNDERGROUND SERVICE ALERT) AT (800) 227-2600, FOR UTILITY LOCATIONS, 48 HOURS BEFORE PROCEEDING WITH ANY EXCAVATION, SITE WORK OR CONSTRUCTION.
- 4. THE CONTRACTOR SHALL INSTALL ALL EQUIPMENT AND MATERIALS IN ACCORDANCE WITH MANUFACTURER'S RECOMMENDATIONS UNLESS SPECIFICALLY INDICATED OTHERWISE, OR WHERE LOCAL CODES OR REGULATIONS TAKE PRECEDENCE.
- 5. ALL CONSTRUCTION SHALL BE IN ACCORDANCE WITH THE CBC / UBC'S REQUIREMENTS REGARDING EARTHQUAKE RESISTANCE, FOR, BUT NOT LIMITED TO,
 PIPING, LIGHT FIXTURES, CEILING GRID, INTERIOR PARTITIONS, AND MECHANICAL EQUIPMENT. ALL WORK MUST COMPLY WITH LOCAL EARTHQUAKE CODES
 AND REGULATIONS
- 6. REPRESENTATIONS OF TRUE NORTH, OTHER THAN THOSE FOUND ON THE PLOT OF SURVEY DRAWINGS, SHALL NOT BE USED TO IDENTIFY OR ESTABLISH BEARING OF TRUE NORTH AT THE SITE. THE CONTRACTOR SHALL RELY SOLELY ON THE PLOT OF SURVEY DRAWING AND ANY SURVEYOR'S MARKINGS AT THE SITE FOR THE ESTABLISHMENT OF TRUE NORTH, AND SHALL NOTIFY THE ARCHITECT / ENGINEER PRIOR TO PROCEEDING WITH THE WORK IF ANY DISCREPANCY IS FOUND BETWEEN THE VARIOUS ELEMENTS OF THE WORKING DRAWINGS AND THE TRUE NORTH ORIENTATION AS DEPICTED ON THE CIVIL SURVEY. THE CONTRACTOR SHALL ASSUME SOLE LIABILITY FOR ANY FAILURE TO NOTIFY THE ARCHITECT / ENGINEER.
- 7. THE BUILDING DEPARTMENT ISSUING THE PERMITS SHALL BE NOTIFIED AT LEAST TWO WORKING DAYS PRIOR TO THE COMMENCEMENT OF WORK, OR AS OTHERWISE STIPULATED BY THE CODE ENFORCEMENT OFFICIAL HAVING JURISDICTION.
- 8. DO NOT EXCAVATE OR DISTURB BEYOND THE PROPERTY LINES OR LEASE LINES, UNLESS OTHERWISE NOTED.
- 9. ALL EXISTING UTILITIES, FACILITIES, CONDITIONS, AND THEIR DIMENSIONS SHOWN ON THE PLAN HAVE BEEN PLOTTED FROM AVAILABLE RECORDS, THE
 ARCHITECT / ENGINEER AND THE OWNER ASSUME NO RESPONSIBILITY WHATSOEVER AS TO THE SUFFICIENCY OR THE ACCURACY OF THE INFORMATION
 SHOWN ON THE PLANS, OR THE MANNER OF THEIR REMOVAL OR ADJUSTMENT, CONTRACTORS SHALL BE RESPONSIBLE FOR DETERMINING EXACT LOCATION
 OF ALL EXISTING UTILITIES AND FACILITIES PRIOR TO START OF CONSTRUCTION, CONTRACTORS SHALL ALSO OBTAIN FROM EACH UTILITY COMPANY DETAILED
 INFORMATION RELATIVE TO WORKING SCHEDULES AND METHODS OF REMOVING OR ADJUSTING EXISTING UTILITIES.
- 10. CONTRACTOR SHALL VERIFY ALL EXISTING UTILITIES, BOTH HORIZONTAL AND VERTICALLY, PRIOR TO THE START OF CONSTRUCTION, ANY DISCREPANCIES OR DOUBTS AS TO THE INTERPRETATION OF PLANS SHOULD BE IMMEDIATELY REPORTED TO THE ARCHITECT / ENGINEER FOR RESOLUTION AND INSTRUCTION, AND NO FURTHER WORK SHALL BE PERFORMED UNTIL THE DISCREPANCY IS CHECKED AND CORRECTED BY THE ARCHITECT / ENGINEER. FAILURE TO SECURE SUCH INSTRUCTION MEANS CONTRACTOR WILL HAVE WORKED AT HIS/HER OWN RISK AND EXPENSE.
- 11. ALL NEW AND EXISTING UTILITY STRUCTURES ON SITE AND IN AREAS TO BE DISTURBED BY CONSTRUCTION SHALL BE ADJUSTED TO FINISH ELEVATIONS PRIOR TO FINAL INSPECTION OF WORK
- 12. ANY DRAIN AND/OR FIELD TILE ENCOUNTERED / DISTURBED DURING CONSTRUCTION SHALL BE RETURNED TO IT'S ORIGINAL CONDITION PRIOR TO COMPLETION OF WORK. SIZE, LOCATION AND TYPE OF ANY UNDERGROUND UTILITIES OR IMPROVEMENTS SHALL BE ACCURATELY NOTED AND PLACED ON "AS-BUILT" DRAWINGS BY GENERAL CONTRACTOR, AND ISSUED TO THE ARCHITECT / ENGINEER AT COMPLETION OF PROJECT.
- 13. ALL TEMPORARY EXCAVATIONS FOR THE INSTALLATION OF FOUNDATIONS, UTILITIES, ETC., SHALL BE PROPERLY LAID BACK OR BRACED IN ACCORDANCE WITH CORRECT OCCUPATIONAL SAFETY AND HEALTH ADMINISTRATION (OSHA) REQUIREMENTS.
- 14. INCLUDE MISC. ITEMS PER AT&T SPECIFICATIONS

APPLICABLE CODES, REGULATIONS AND STANDARDS:

- 1. SUBCONTRACTOR'S WORK SHALL COMPLY WITH ALL APPLICABLE NATIONAL, STATE, AND LOCAL CODES AS ADOPTED BY THE LOCAL AUTHORITY HAVING JURISDICTION (AHJ) FOR THE LOCATION.
- 2. THE EDITION OF THE AHJ ADOPTED CODES AND STANDARDS IN EFFECT ON THE DATE OF CONTRACT AWARD SHALL GOVERN THE DESIGN.
- 3. SUBCONTRACTOR'S WORK SHALL COMPLY WITH THE LATEST EDITION OF THE FOLLOWING STANDARDS:
- 3.1. AMERICAN CONCRETE INSTITUTE (ACI) 318, BUILDING CODE REQUIREMENTS FOR STRUCTURAL CONCRETE
- 3.2. AMERICAN INSTITUTE OF STEEL CONSTRUCTION (AISC), MANUAL OF STEEL CONSTRUCTION, ASD, FIFTEENTH EDITION
- 3.3. TELECOMMUNICATIONS INDUSTRY ASSOCIATION (TIA) 222-H, STRUCTURAL STANDARD FOR STRUCTURAL ANTENNA TOWER AND ANTENNA SUPPORTING STRUCTURES
- 3.4. INSTITUTE FOR ELECTRICAL AND ELECTRONICS ENGINEERS (IEEE) 81, GUIDE FOR MEASURING EARTH RESISTIVITY, GROUND IMPEDANCE, AND EARTH SURFACE POTENTIALS OF A GROUND SYSTEM IEEE 1100 (1999) RECOMMENDED PRACTICE FOR POWERING AND GROUNDING OF ELECTRICAL EQUIPMENT.
- 3.5. IEEE C62.41, RECOMMENDED PRACTICES ON SURGE VOLTAGES IN LOW VOLTAGE AC POWER CIRCUITS (FOR LOCATION CATEGORY "C3" AND "HIGH SYSTEM EXPOSURE")
- 3.6. TIA 607 COMMERCIAL BUILDING GROUNDING AND BONDING REQUIREMENTS FOR TELECOMMUNICATIONS TELCORDIA GR-63 NETWORK
- 3.7. EQUIPMENT-BUILDING SYSTEM (NEBS): PHYSICAL PROTECTION
- 3.8. TELCORDIA GR-347 CENTRAL OFFICE POWER WIRING
- 3.9. TELCORDIA GR-1275 GENERAL INSTALLATION REQUIREMENTS
- 3.10. TELCORDIA GR-1503 COAXIAL CABLE CONNECTIONS
- 3.11. ANY AND ALL OTHER LOCAL & STATE LAWS AND REGULATIONS
- 3.12. FOR ANY CONFLICTS BETWEEN SECTIONS OF LISTED CODES AND STANDARDS REGARDING MATERIAL, METHODS OF CONSTRUCTION, OR OTHER REQUIREMENTS.

 THE MOST RESTRICTIVE SHALL GOVERN. WHERE THERE IS CONFLICT BETWEEN A GENERAL REQUIREMENT AND A SPECIFIC REQUIREMENT, THE SPECIFIC REQUIREMENT SHALL GOVERN.

		ABB	REVIATIONS:
A.B.	ANCHOR BOLT	FDN.	FOUNDATION
ABV.	ABOVE	F.O.C.	FACE OF CONCRETE
ACCA	ANTENNA CABLE COVER ASSEMBLY	F.O.M.	FACE OF MASONRY
ADD'L	ADDITIONAL	F.O.S.	FACE OF STUD
A.F.F.	ABOVE FINISHED FLOOR	F.O.W.	FACE OF WALL
A.F.G.	ABOVE FINISHED GRADE	F.S.	
ALUM.	ALUMINUM	F.3. FT.(')	FINISH SURFACE
ALT.	ALTERNATE		FOOT (FEET)
ANT.	ANTENNA	FTG.	FOOTING
APPRX.	APPROXIMATE(LY)	G.	GROWTH (CABINET)
		GA.	GAUGE
ARCH.	ARCHITECT(URAL)	GI.	GALVANIZE(D)
AWG.	AMERICAN WIRE GAUGE	G.F.I.	GROUND FAULT CIRCUIT
BLDG.	BUILDING	INTERRUPTER	
BLK.	BLOCK	Glb. (Glu-lam)	GLUE LAMINATED BEAM
BLKG.	BLOCKING	GPS	Global positioning system
BM.	BEAM	GRND.	GROUND
B.N.	BOUNDARY NAILING	HDR.	HEADER
BTCW.	BARE TINNED COPPER WIRE	HGR.	HANGER
B.O.F.	BOTTOM OF FOOTING	HT.	HEIGHT
B/U	BACK-UP CABINET	ICGB.	ISOLATED COPPER GROUND BUS
CAB.	CABINET	IN. (")	INCH(ES)
CANT.	CANTILEVER(ED)	INT.	INTERIOR
C.I.P.	CAST IN PLACE	LB.(#)	POUND(S)
CLG.	CEILING	L.B.	LAG BOLTS
CLR.	CLEAR	L.F.	LINEAR FEET (FOOT)
COL.	COLUMN	L.	LONG(ITUDINAL)
CONC.	CONCRETE	MAS.	MASONRY
CONN.	CONNECTION(OR)	MAX.	MAXIMUM
CONST.	CONSTRUCTION	M.B.	MACHINE BOLT
CONT.	CONTINUOUS	MECH.	MECHANICAL
d	PENNY (NAILS)	MFR.	MANUFACTURER
DBL.	DOUBLE	MIN.	MINIMUM
DEPT.	DEPARTMENT	MISC.	MISCELLANEOUS
D.F.	DOUGLAS FIR	MTL.	METAL
DIA.	DIAMETER	(N)	NEW
DIAG.	DIAGONAL	NO.(#)	NUMBER
DIM.	DIMENSION	N.T.S.	NOT TO SCALE
DWG.	DRAWING(S)	O.C.	ON CENTER
DWL.	DOWEL(S)	OPNG.	OPENING
EA.	EACH	P P	PROPOSED
EL.	ELEVATION	P/C	PRECAST CONCRETE
ELEC.	ELECTRICAL	PCS	PERSONAL COMMUNICATION
ELEV.	ELEVATOR	rcs	
EMT.	ELECTRICAL METALLIC TUBING	PLY.	SERVICES
E.N.	EDGE NAIL	PLT. PPC	PLYWOOD
ENG.	ENGINEER		POWER PROTECTION CABINET
EQ.	EQUAL	PRC	PRIMARY RADIO CABINET
		P.S.F.	POUNDS PER SQUARE FOOT
EXP. EXST.(E)	EXPANSION	P.S.I.	POUNDS PER SQUARE INCH
	EXISTING	P.T.	PRESSURE TREATED
EXT.	EXTERIOR	PWR.	POWER (CABINET)
FAB.	FABRICATION(OR)	QTY.	QUANTITY
F.F.	FINISH FLOOR	RAD.(R)	RADIUS
F.G.	FINISH GRADE	REF.	REFERENCE
FIN.	FINISH(ED)	REINF.	REINFORCEMENT(ING)
FLR.	FLOOR	REQ'D/	REQUIRED

GSS. CH. IT. M. GS. D. L. RUC. MP. IK. N. O.C. O.P. O.S. P. G. L. N. D. L. N. D. D. L. T.	RIGID GALVANIZED STEE SCHEDULE SHEET SIMILAR SPECIFICATIONS SQUARE STAINLESS STEEL STANDARD STEEL STRUCTURAL TEMPORARY THICK (NESS) TOE NAIL TOP OF ANTENNA TOP OF FUNDATION TOP OF PLATE (PARAPET TOP OF STEEL TOP OF STEEL TOP OF WALL TYPICAL UNDER GROUND UNDERWRITERS LABORA UNLESS NOTED OTHERW VERIFY IN FIELD WIDE (WIDTH) WITH WOOD WEATHERPROOF WEIGHT CENTERLINE PLATE, PROPERTY LINE

PREPARED FOR



5001 EXECUTIVE PKWY, SAN RAMON CA 94583


Vendor:



23 MAUCHLY, SUITE 110 IRVINE, CALIFORNIA 92618

AT&T Site ID:

CCL00916

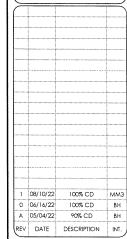



It is a violation of law for any persons, unless they are acting under the direction of a licensed professional engineer to alter this document

Issued For:

CCL00916

UKIAH NORTH

1460 LOVERS LANE UKIAH, CA 95482

Sheet Title:


GENERAL NOTES

Sheet Number:

GN-1

SYMBOLS LEGEND:

OFFICE

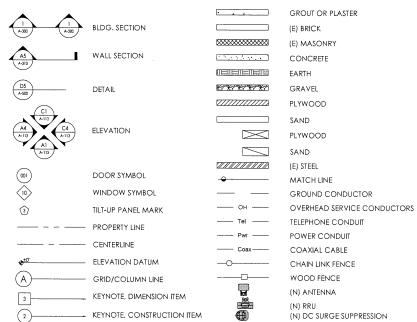


WALL TYPE MARK


ROOM NAME ROOM NUMBER (F) ANTENNA

(F) FQUIPMENT

(F) RRU

#

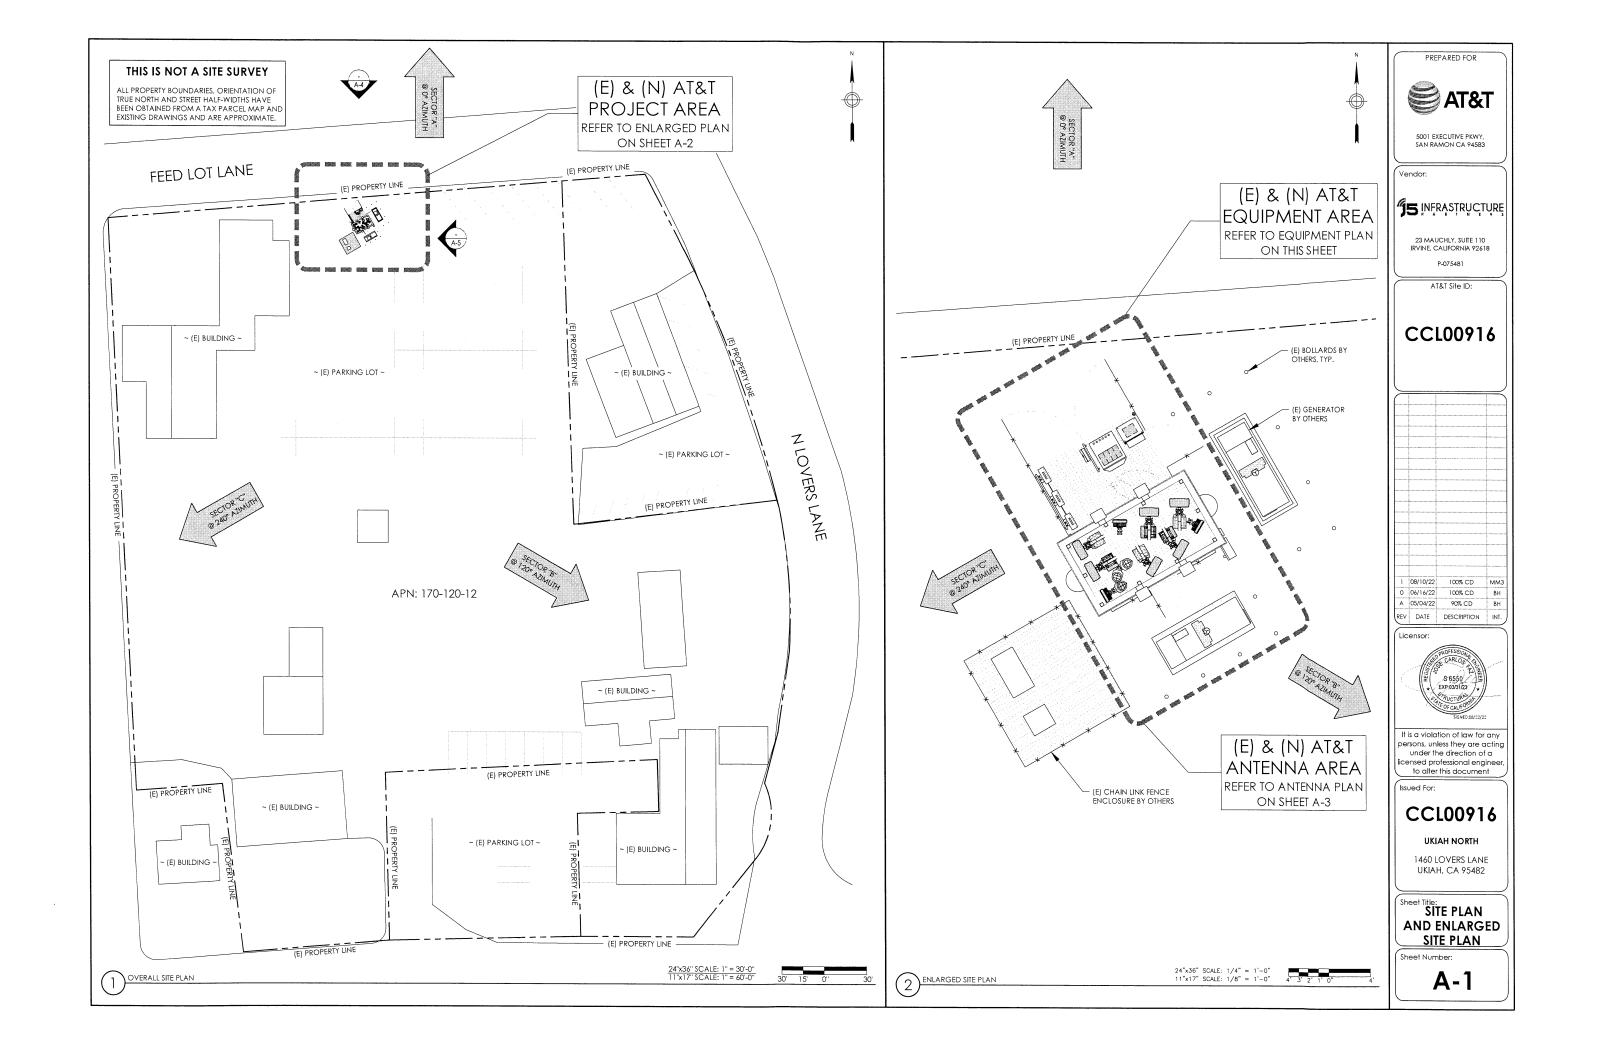

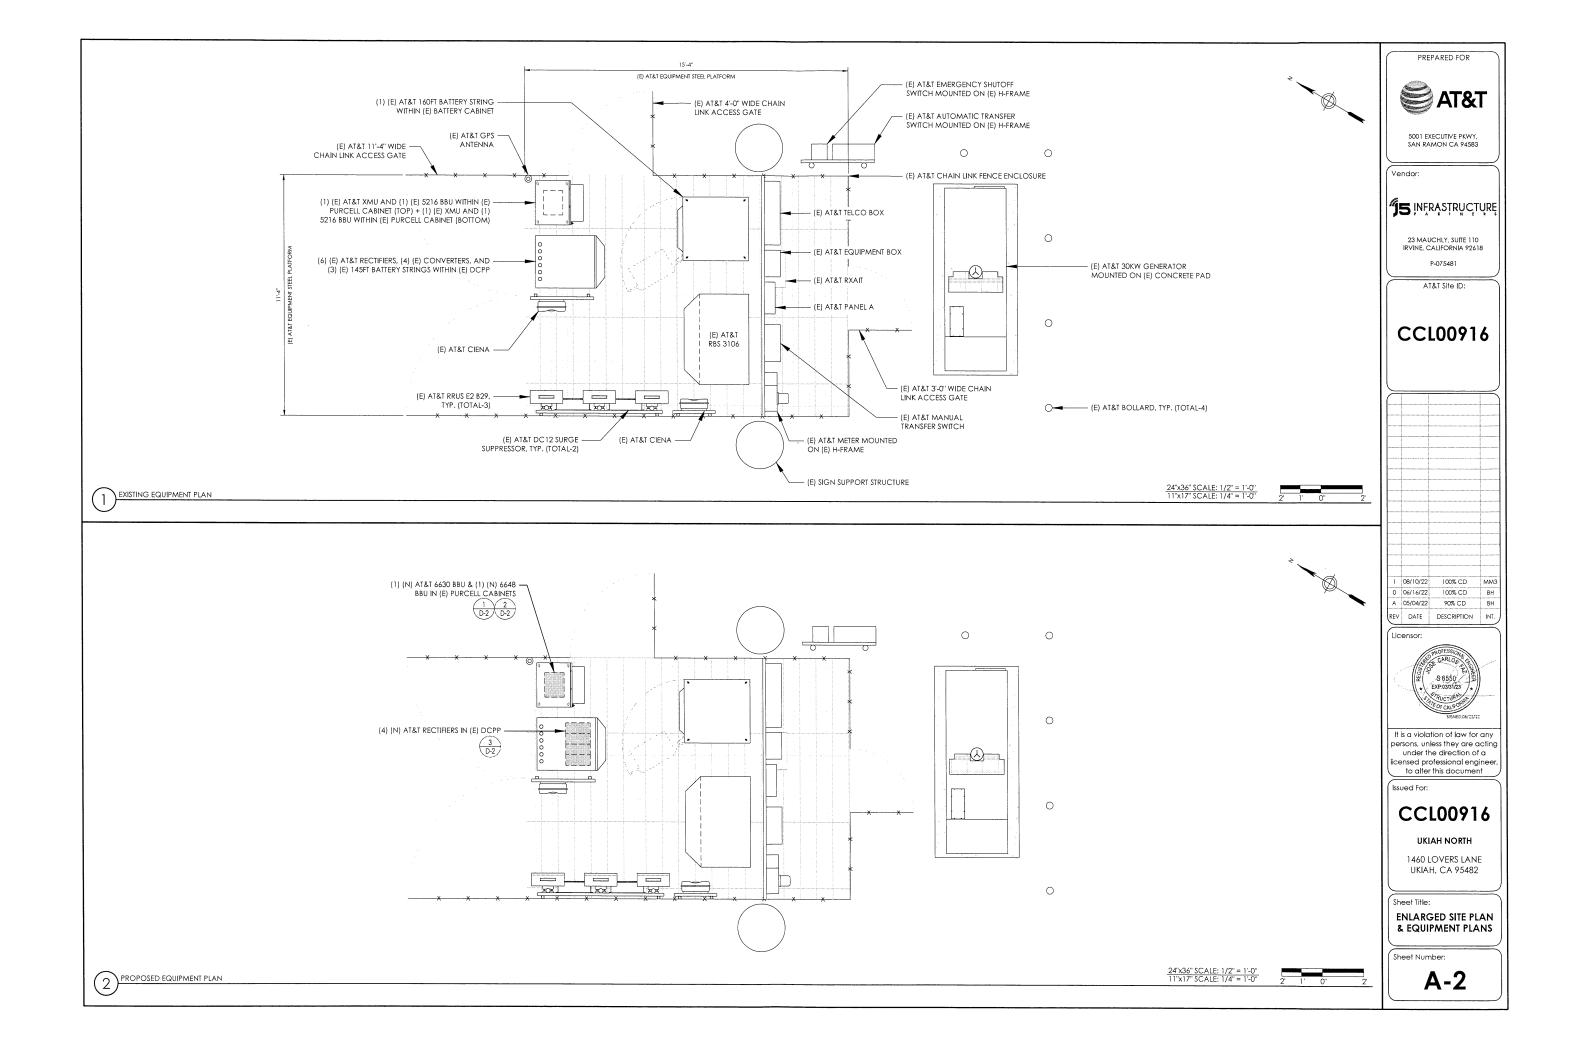



NOTES TO CONTRACTOR:

- CONTRACTOR IS TO REFER TO AT&T'S MOST CURRENT RADIO FREQUENCY DATA SHEET (RFDS) PRIOR TO CONSTRUCTION.

 CABLE LENGTHS WERE DETERMINED BASED ON VISUAL INSPECTION DURING SITE-WALK. CONTRACTOR TO VERIFY ACTUAL LENGTH DURING PRE-CONSTRUCTION WALK.

 CONTRACTOR TO VERIFY PORTS HAVE SUFFICIENT ROOM.

(E) ANTENNA AZIMUTHS ARE ESTIMATED AND ARE TO BE VERIFIED BY RF.

			Antenna				RRU, TMA	Additi	onal Ante	nna Inform	Line Information						
sition	Use Existing/	T	уре	Te	chnology	Existing	Azim				er/Fiber						
	Swap/New	Existing	Final	Existing	Final	Туре	Location	Туре	Location	Existing	Final	RAD C Existing		Existing		Existing	
						ALPHA						<u> </u>					
	SWAP	COMMSCOPE	QUINTEL	LTE 700 DE	LTE 700 DE	(1) RRUS E2 B29	воттом	(1) RRUS E2 B29	воттом	T T				1 '			
		SBJAH4-1D65B-DL	QD6616-7	LTE AWS	LTE AWS	(1) RRUS 4426 B66	ТОР	(1) RRUS 4426 B66	ТОР								
1				LTE WCS	LTE 1900	(1) RRUS 32 B30	ТОР	(1) RRUS 4415 B25	ТОР	0	0	67	67	1			
					LTE 700 FNET	(2,		(1) RRUS 4478 B14	ТОР		Ü	0,	07	'			
					LIE 700 HILL			(1) 1(103 4470 B14	101								
	SWAP	KATHREIN	QUINTEL	LTE 700 FNET	LTE 700 BC	(1) RRUS 4478 B14	ТОР	(1) RRUS 4478 B12A	ТОР					-			
	1	800-10965 K	QD6612-3D	UMTS 1900	LTE 1900	(1) KRY112 89/4	TOP	(1) RRUS 4415 B25	TOP								
		000 10303 K	QD0012-3D	010113 1300	LTE WCS	(1) KK1112 05/4	TOP	(1) RRUS 32 B30	TOP		0	C7	C7				
					LIE WC3			(1) KKUS 32 BSU	ТОР	0	0	67	67				
	SWAP	COMMSCOPE	AIR6419 B77G	LTE 700 BC	DOD	(1) RRUS 11 B12	ТОР	(INTEGRATED)	N/A					-			
		SBNHH-1D65B	AIR6449 B77D	LTE 1900	CBAND	(1) RRUS 4415 B25	TOP	(IIIIIIIIII)	1.7/					1			
		25,4,11, 15,035	(STACKED)	1500	CDINIO	(1) 11103 4413 B23	101				0	67	67				
			STACKED								U	07	67				
						BETA								-		KS	k (3) FIBER TRUNKS + (1) FIBER TRUNK
	SWAP	COMMSCOPE	QUINTEL	LTE 700 DE	LTE 700 DE	(1) RRUS E2 B29	воттом	(1) RRUS E2 B29	воттом					1		5	5 5
		SBJAH4-1D65B-DL	QD6616-7	LTE AWS	LTE AWS	(1) RRUS 4426 B66	TOP	(1) RRUS 4426 B66	ТОР							=	1 × 1
				LTE WCS	LTE 1900	(1) RRUS 32 B30	TOP	(1) RRUS 4415 B25	TOP	120	120	67	67	1		35,4	3ER BEF
				1.2	LTE 700 FNET	(1) 111(03/32/830	101	(1) RRUS 4478 B14	TOP	120	120	0/	07	1 ,,	10	=	
					E12 700 11421			(1) 11103 4478 B14	TOP					BLES	COAX CABLES	§ (3)	& (3) + (1)
	SWAP	KATHREIN	QUINTEL	LTE 700 FNET	LTE 700 BC	(1) RRUS 4478 B14	TOP	(1) RRUS 4478 B12A	TOP					1 5	(CA	KS 8	KS 8
		800-10965 K	QD6612-3D	UMTS 1900	LTE 1900	(1) KRY112 89/4	TOP	(1) RRUS 4415 B25	TOP					<u> </u>	X	N S	1 5 5
					LTE WCS			(1) RRUS 32 B30	TOP	120	120	67	67	8	8	H H	1 H
														(12) 7/8" COAX CABLES	(12) 7/8"	WER	WER
	SWAP	COMMSCOPE	AIR6419 B77G	LTE 700 BC	DOD	(1) RRUS 11 B12	ТОР	(INTEGRATED)	N/A					(12)	(12)	DC POWER TRUNKS & (3) FIBER TRUNKS	#8 AWG DC POWER TRUNKS & (
		SBNHH-1D65B	AIR6449 B77D	LTE 1900	CBAND	(1) RRUS 4415 B25	TOP										3 D
			(STACKED)							120	120	67	67			AWG	≥ ≥
																√ 8# (9)	#8 A
						GAMMA				1				_		9)	(6) #
	SWAP	COMMSCOPE	QUINTEL	LTE 700 DE	LTE 700 DE	(1) RRUS E2 B29	воттом	(1) RRUS E2 B29	воттом								
		SBJAH4-1D65B-DL	QD6616-7	LTE AWS	LTE AWS	(1) RRUS 4426 B66	TOP	(1) RRUS 4426 B66	TOP								
L				LTE WCS	LTE 1900	(1) RRUS 32 B30	TOP	(1) RRUS 4415 B25	TOP	240	240	67	67	1			
					LTE 700 FNET			(1) RRUS 4478 B14	TOP								
	1																
	SWAP	KATHREIN	QUINTEL	LTE 700 FNET	LTE 700 BC	(1) RRUS 4478 B14	ТОР	(1) RRUS 4478 B12A	ТОР					1			
	1	800-10965 K	QD6612-3D	UMTS 1900	LTE 1900	(1) KRY112 89/4	TOP	(1) RRUS 4415 B25	TOP								
2		250 10505 K	20012 30	0.00	LTE WCS	(1) ((1) 112 05)4	101	(1) RRUS 32 B30	TOP	240	240	67	67				
-					LIL WC3			(±) I(I(O3 32 B30	l or	240	240	0/	/ن				
	SWAP	COMMSCOPE	AIR6419 B77G	LTE 700 BC	DOD	(1) RRUS 11 B12	TOP	(INTEGRATED)	N/A					-			
		SBNHH-1D65B	AIR6449 B77D	LTE 1900	CBAND	(1) RRUS 4415 B25	ТОР	,						1			
3			(STACKED)	2.2.2500		(2) (113 523	1.0.			240	240	67	67				
5			(STACKED)							240	∠4 0	07	0/				

PREPARED FOR



5001 EXECUTIVE PKWY, SAN RAMON CA 94583

Vendor:

5 INFRASTRUCTURE

23 MAUCHLY, SUITE 110 IRVINE, CALIFORNIA 92618 P-075481

AT&T Site ID:

CCL00916

_							

		,,,,,,,,,,,,,,,,,,,,,,,,,,,,,,,,,,,,,,,					
1	08/10/22	100% CD	M				
0	06/16/22	100% CD	В				
Α	05/04/22	90% CD	В				
REV	DATE	DESCRIPTION	IN				





It is a violation of law for any persons, unless they are acting under the direction of a licensed professional engineer, to after this document

Issued For:

CCL00916

UKIAH NORTH


1460 LOVERS LANE UKIAH, CA 95482


PROPOSED RF SCHEDULE

Sheet Number:


A-3.1


PROPOSED RF SCHEDULE
N.T.S.

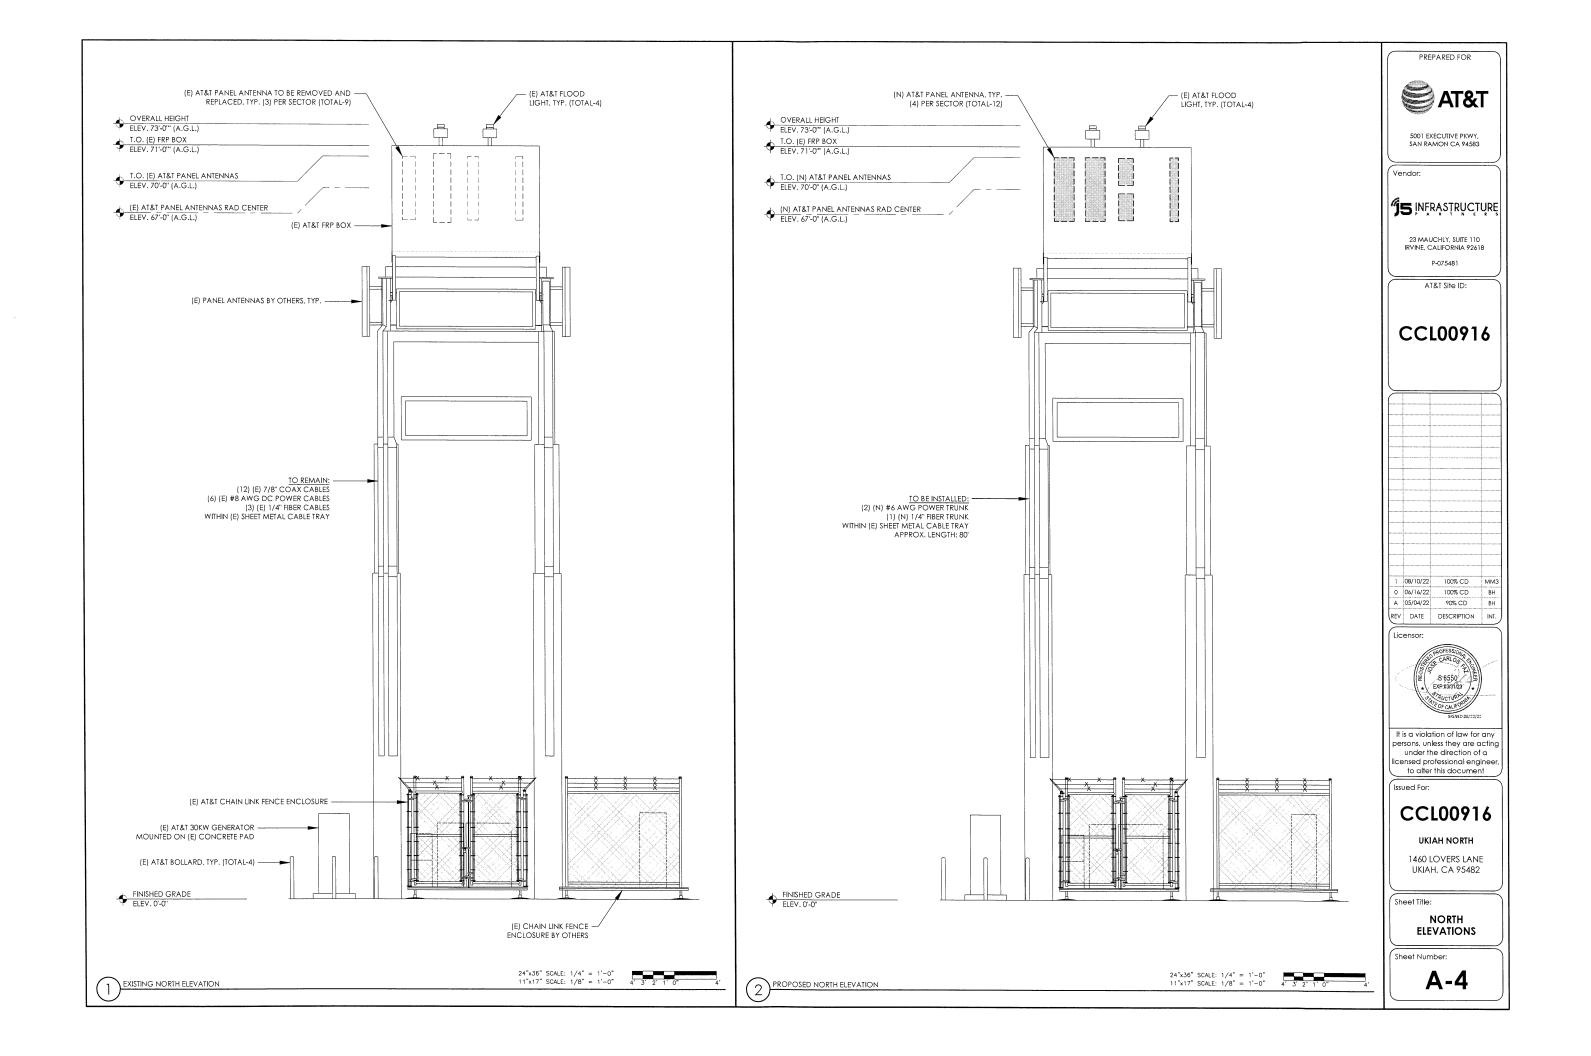

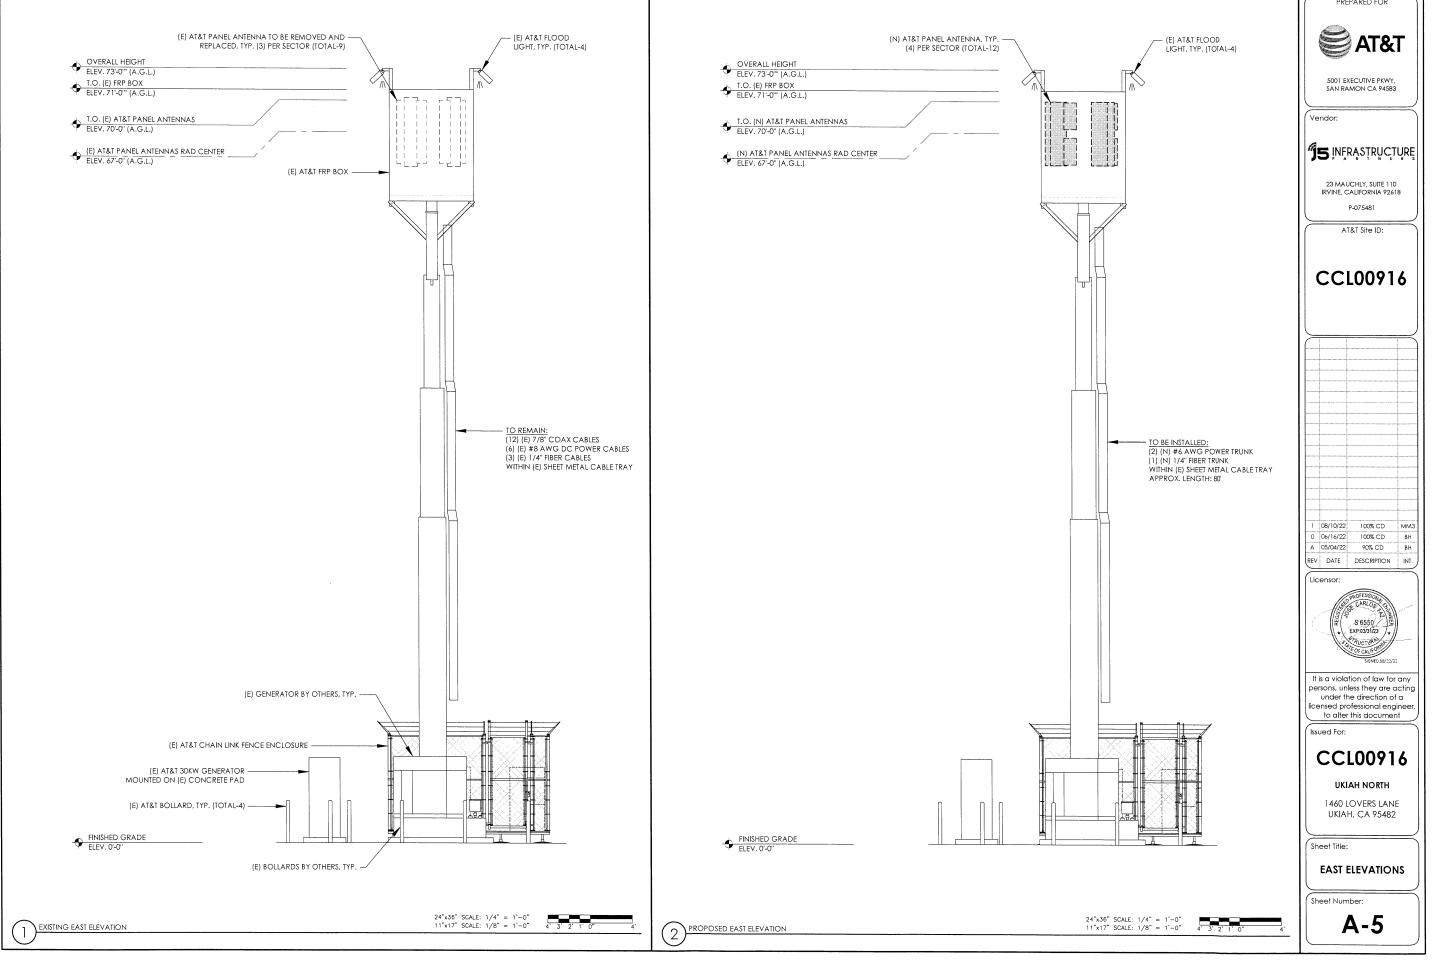

PREPARED FOR

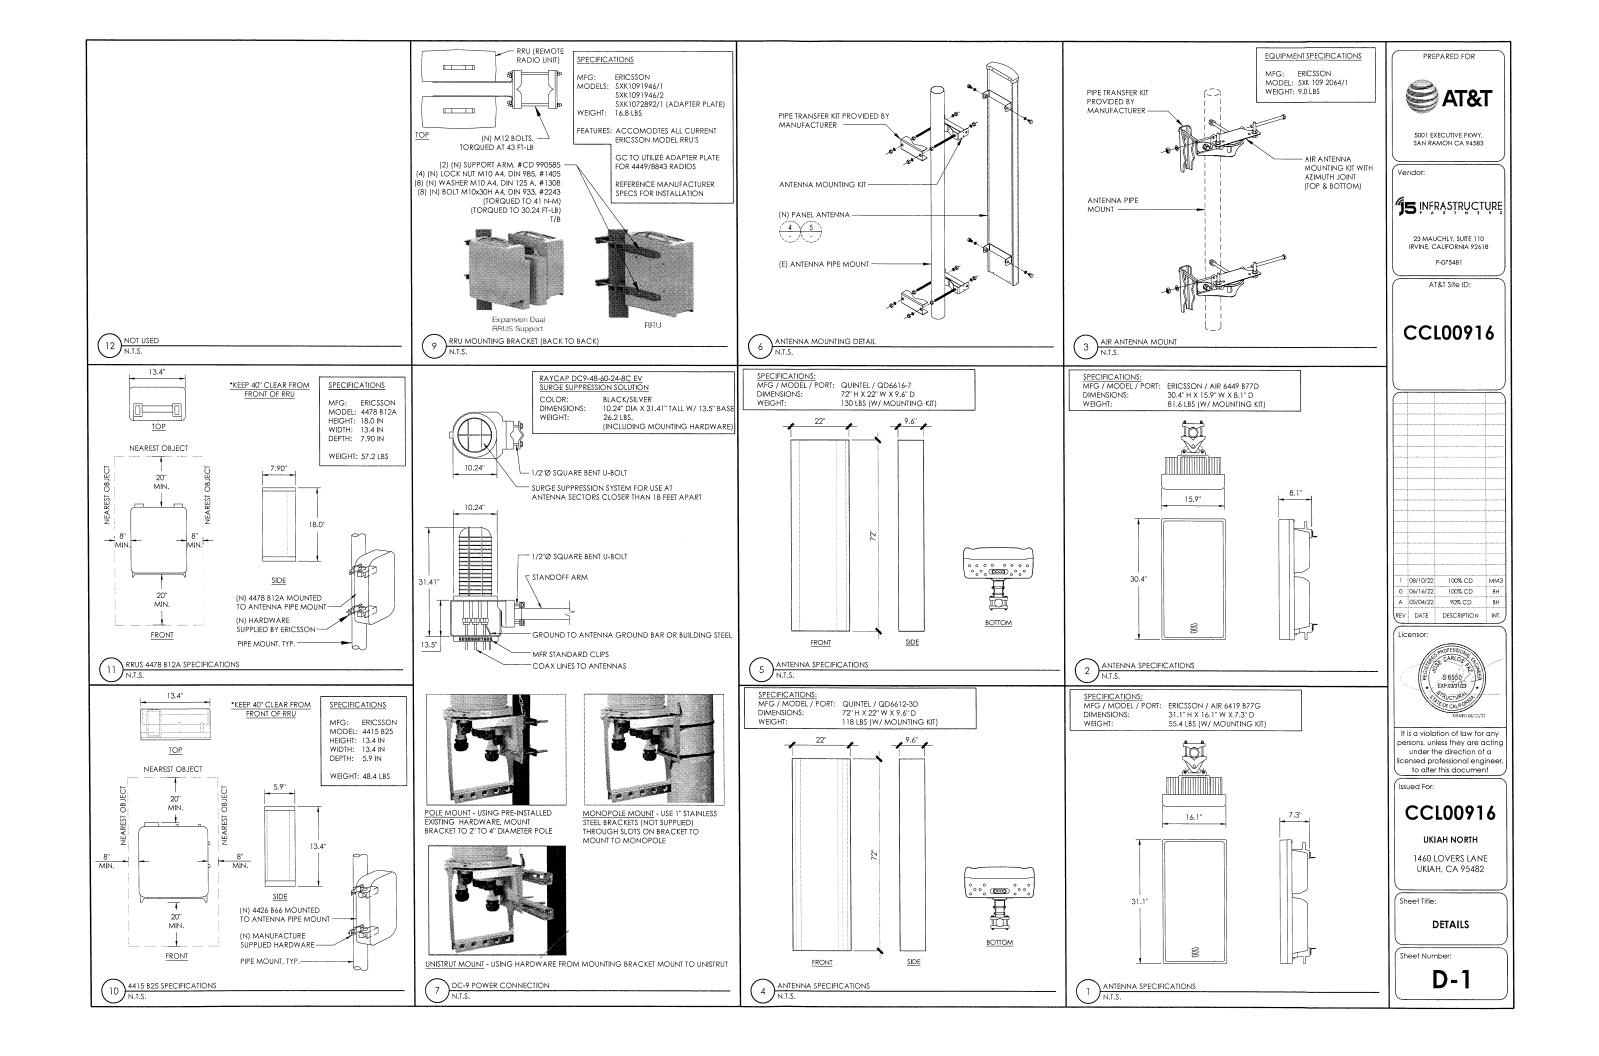

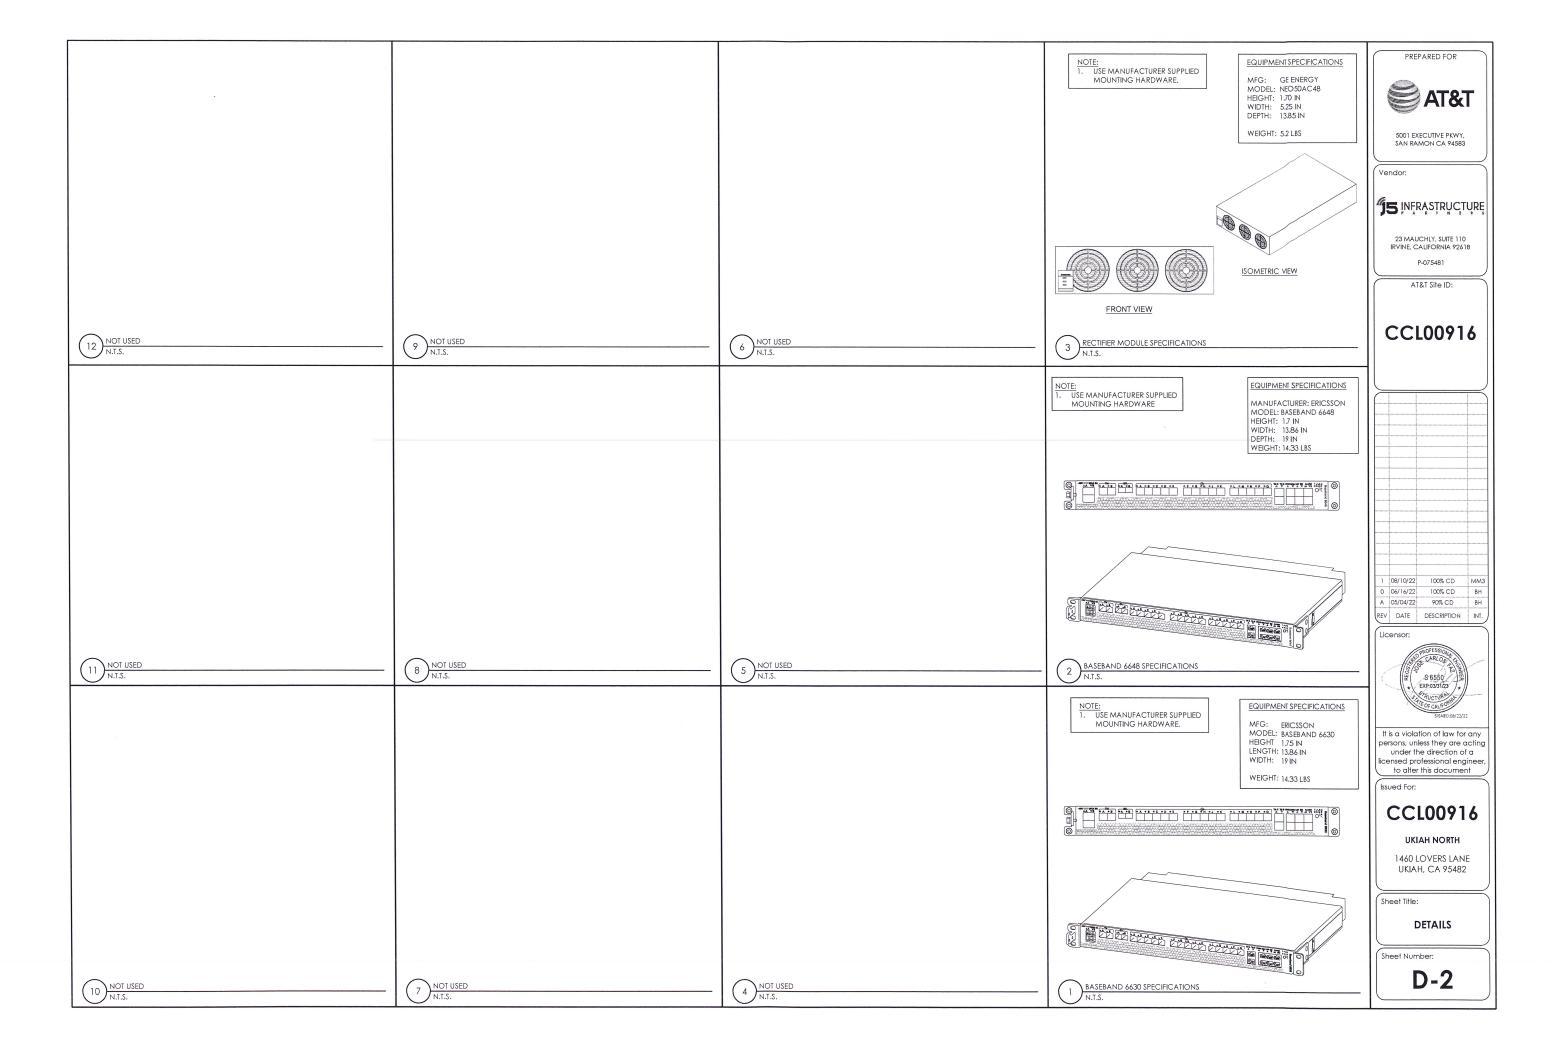


GROUNDING NOTES:

- 1. ALL DETAILS ARE SHOWN IN GENERAL TERMS, ACTUAL GROUNDING INSTALLATION REQUIREMENTS AND CONSTRUCTION ACCORDING TO SITE CONDITIONS.
- 2. ALL GROUNDING CONDUCTORS: #2 AWG SOLID BARE TINNED COPPER WIRE UNLESS OTHERWISE NOTED.
- 3. GROUND BAR LOCATED IN BASE OF EQUIPMENT WILL BE PROVIDED, FURNISHED AND INSTALLED BY THE VENDOR.
- 4. ALL BELOW GRADE CONNECTIONS: EXOTHERMIC WELD TYPE. ABOVE GRADE CONNECTIONS: EXOTHERMIC WELD TYPE
- 5. GROUND RING SHALL BE LOCATED A MINIMUM OF 24" BELOW
- 6. INSTALL GROUND CONDUCTORS AND GROUND ROD MINIMUM OF 1'-0" FROM EQUIPMENT CONCRETE SLAB, SPREAD FOOTING,
- 7. EXOTHERMIC WELD GROUND CONNECTION TO FENCE POST: TREAT WITH A COLD GALVANIZED SPRAY.
- 8. GROUND BARS:
 - A) EQUIPMENT GROUND BUS BAR (EGB) LOCATED AT THE BOTTOM OF ANTENNA POLE/MAST FOR MAKING GROUNDING JUMPER CONNECTIONS TO COAX FEEDER CABLES SHALL BE FURNISHED AND INSTALLED BY ELECTRICAL CONTRACTOR, JUMPERS (FURNISHED BY OWNERS) SHALL BE INSTALLED AND CONNECTED BY ELECTRICAL CONTRACTOR.
- 9. ALL GROUNDING INSTALLATIONS AND CONNECTIONS SHALL BE MADE BY ELECTRICAL CONTRACTOR
- 10. OBSERVE N.E.C. AND LOCAL UTILITY REQUIREMENTS FOR
- 11. GROUNDING ATTACHMENT TO TOWER SHALL BE AS PER MANUFACTURER'S RECOMMENDATIONS OR AT GROUNDING POINTS PROVIDED (2 MINIMUM).
- 12. IF EQUIPMENT IS IN A C.L. FENCE ENCLOSURE, GROUND ONLY CORNER POSTS AND SUPPORT POSTS OF GATE. IF CHAIN LINK LID IS USED, THEN GROUND LID ALSO.
- 13. GROUNDING AT PPC CABINET SHALL BE VERTICALLY INSTALLED.
- 14. ALL GROUNDING FOR ANTENNAS SHALL BE CONNECTED SO
- 15. ALL EMT RUNS SHALL BE GROUNDED AND HAVE A BUSHING, NO PVC ABOVE GROUND
- 16. USE SEPARATE HOLES FOR GROUNDING AT BUSS BAR. NO DOUBLE-UP" OF LUGS
- 17. POWER AND TELCO CABINETS SHALL BE GROUNDED (BONDED)
- 18. NO LB'S ALLOWED ON GROUNDING.


- 19. PROVIDE STAINLESS STEEL CLAMP AND BRASS TAGS ON COAX
- 20 ALL ELECTRICAL AND GROUNDING AT THE CELL SITE SHALL COMPLY WITH THE NATIONAL ELECTRICAL CODE (NEC.), NATIONAL FIRE PROTECTION ASSOCIATION (NFPA) 780 (LATEST EDITION), AND MANUFACTURER SPECIFICATION.
- 21 IF THE AC PANEL IN THE POWER CABINET IS WIRED AS SERVICE ENTRANCE, THE AC SERVICE GROUND CONDUCTOR SHALL BE CONNECTED TO GROUND ELECTRODE SYSTEM. WHEN THE AC PANEL IN THE POWER CABINET IS CONSIDERED A SUB-PANEL THE GROUND WIRE SHALL BE INSTALLED IN THE AC POWER CONDUIT. THE INSTALLATION SHALL BE PER LOCAL AND NATIONAL ELECTRIC CODE (NFPA-70).
- 22 EXOTHERMIC WELDING IS RECOMMENDED FOR GROUNDING CONNECTION WHERE PRACTICAL. OTHERWISE, THE CONNECTION SHALL BE MADE USING COMPRESSION TYPE-2 HOLES. LONG BARREL LUGS OR DOUBLE CRIMP CLAMP "C" CLAMP, THE COPPER CABLES SHALL BE COATED WITH ANTIOXIDANT (COPPER SHIELD) BEFORE MAKING THE CONNECTIONS. THE MANUFACTURER'S TORQUING RECOMMENDATIONS ON THE BOLT ASSEMBLY TO SECURE CONNECTIONS SHALL BE FOLLOWED
- 23 THE ANTENNA CABLES SHALL BE GROUNDED AT THE TOP AND BOTTOM OF THE VERTICAL RUN FOR LIGHTING PROTECTION. THE ANTENNA CABLE SHIELD SHALL BE BONDED TO A COPPER GROUND BUSS AT THE LOWER MOST POINT OF A VERTICAL RUN IUST BEFORE IT BEGINS TO BEND TOWARD THE HORIZONTAL PLANE, WIRE RUNS TO GROUND SHALL BE KEPT AS STRAIGHT AND SHORT AS POSSIBLE. ANTENNA CABLE SHIELD SHALL BE GROUNDED JUST REFORE ENTERING THE CELL CARINET, ANY ANTENNA CABLES OVER 200 FEET IN LENGTH SHALL ALSO BE EQUIPPED WITH ADDITIONAL GROUNDING AT MID-POINT.
- 24 ALL GROUNDING CONDUCTORS INSIDE THE BUILDING SHALL BE RUN IN CONDUIT RACEWAY SYSTEM, AND SHALL BE INSTALLED AS STRAIGHT AS PRACTICAL WITH MINOR BENDS TO AVOID OBSTRUCTIONS. THE BENDING RADIUS OF ANY #2 GROUNDING CONDUCTOR IS 8". PVC RACEWAY MAY BE FLEXIBLE OR RIGID PER THE FIELD CONDITIONS. GROUNDING CONDUCTORS SHALL NOT MAKE CONTACT WITH ANY METALLIC CONDUITS, SURFACES OR FOUIPMENT.
- 25 PROVIDE PVC SLEEVES WHERE GROUNDING CONDUCTORS PASS THROUGH THE BUILDING WALLS AND /OR CEILINGS.
- 26. INSTALL GROUND BUSHINGS ON ALL METALLIC CONDUITS AND BOND TO THE EQUIPMENT GROUND BUSS IN THE PANEL BOARD.
- 27 GROUND ANTENNA BASES, FRAMES, CABLE RACKS AND OTHER METALLIC COMPONENTS WITH #2 GROUNDING CONDUCTORS AND CONNECT TO INSULATED SURFACE MOUNTED GROUND BARS. CONNECTION DETAILS SHALL FOLLOW MANUFACTURER'S PECIFICATIONS FOR GROUNDING
- 28. ALL PROPOSED GROUNDING CONDUCTORS SHALL BE ROUTED AND CONNECTED TO THE MAIN GROUND BAR OR EXISTING

GROUNDING NOTES

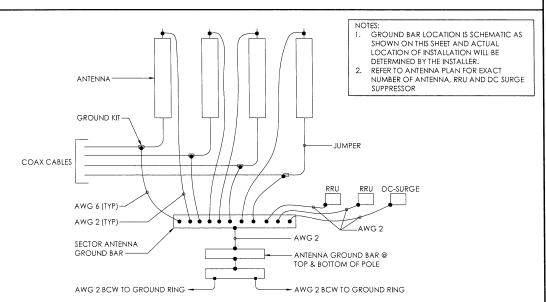

KEY NOTES:

- (E) ANTENNA GROUND BAR TO BE VERIFIED @ FIELD
- (N) AWG 2 INSULATED COPPER GROUND WIRE FROM (N) RRUS TO (E) ANTENNA GROUND BAR
- (N) AWG 6 INSULATED COPPER GROUND WIRE FROM (N) ANTENNA GROUND KIT TO (E) ANTENNA GROUND BAR
- I) AWG 2 INSULATED COPPER GROUND WIRE FROM (N) AIR ANTENNA GROUND KIT TO (E) ANTENNA GROUND BAR
- REFER TO TYP. ANTENNA GROUNDING DIAGRAM
- 2. (E) GROUND WIRES ARE NOT SHOWN FOR CLARITY

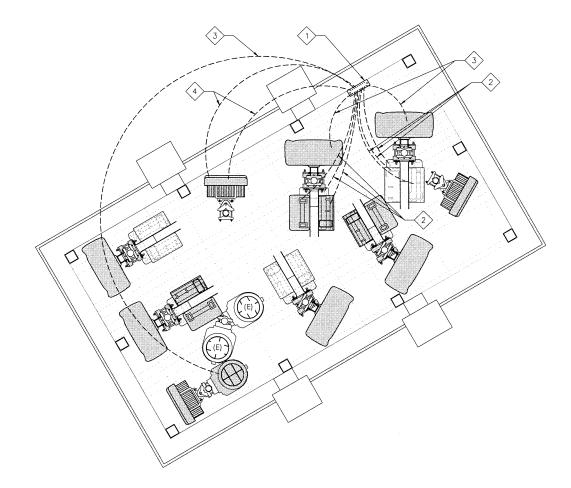

PREPARED FOR



5001 EXECUTIVE PKWY, SAN RAMON CA 94583



23 MAUCHLY, SUITE 110 IRVINE, CALIFORNIA 92618 P-075481

AT&T Site ID:

CCL00916

08/10/22 100% CD 06/16/22 100% CD 4 05/04/22 90% CD BH REV DATE DESCRIPTION INT



It is a violation of law for any persons, unless they are actin under the direction of a licensed professional engineer to alter this document

Issued For:

CCL00916

UKIAH NORTH

1460 LOVERS LANE UKIAH, CA 95482


Sheet Title:

GROUNDING **PLANS & NOTES**

Sheet Number

G-1


ANTENNA GROUNDING PLAN, TYP PER SECTOR

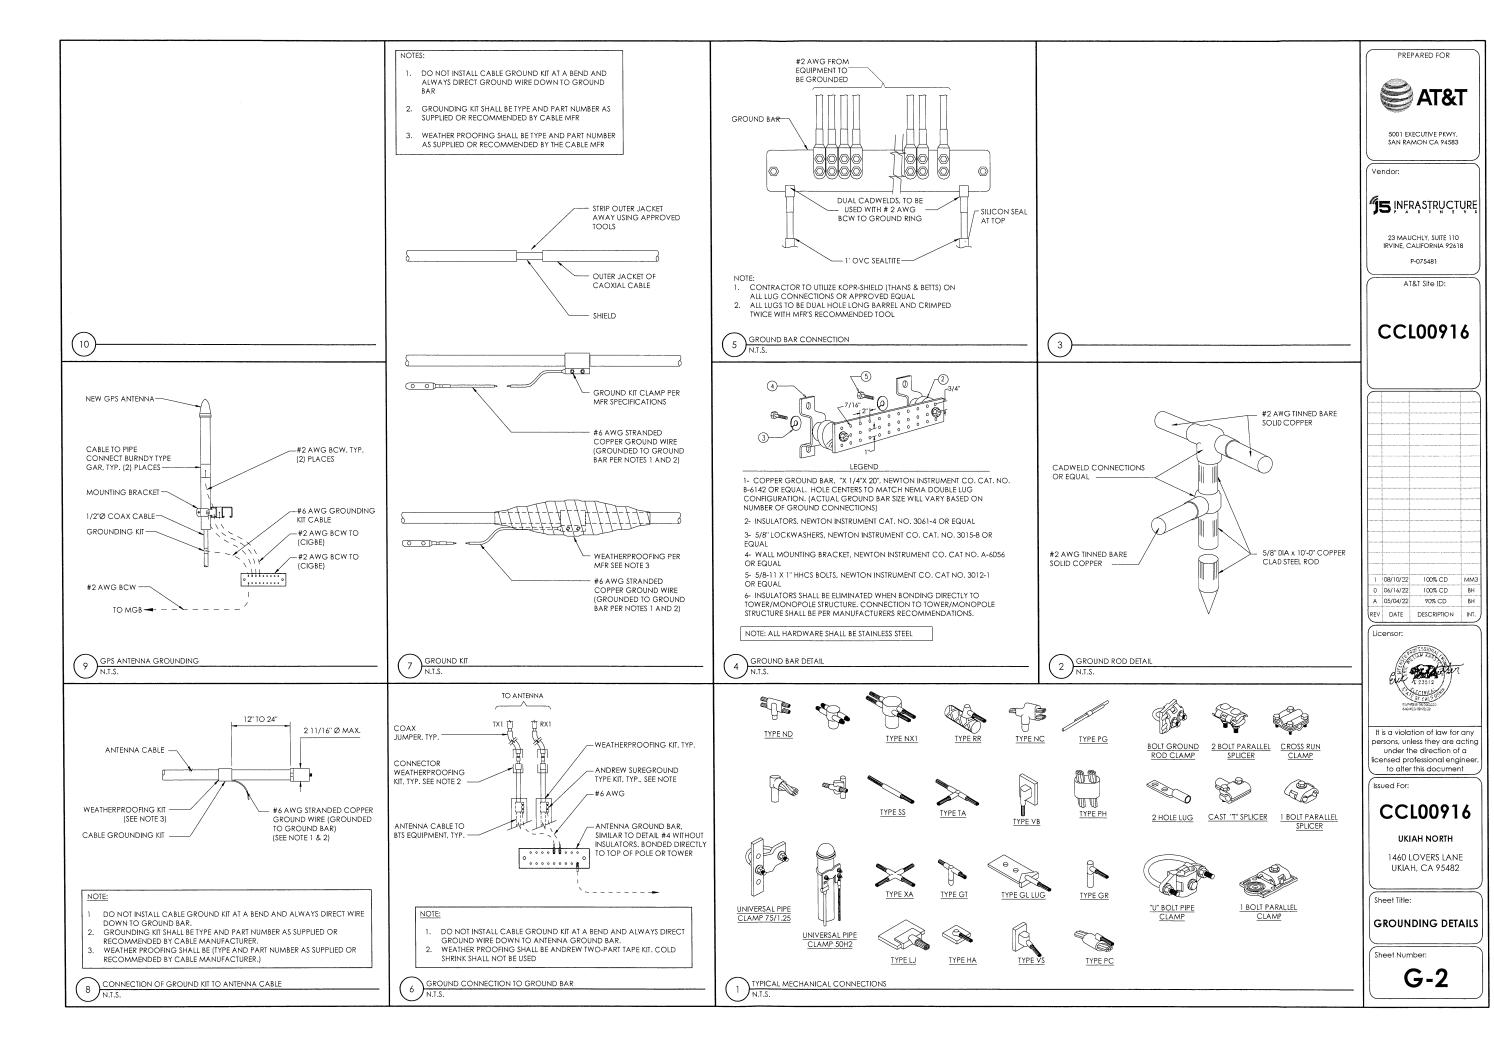

VOLTAG	GE: 120/	240V, 1-PHASE, 3W, 2	.00A,	42 KA	IC				-			MOUN	TING: SL	JRFACE
MAIN C	B: 2P/20	00A											N	EMA: 1
						P	ANEL	.'A'				LOCATION:	@ LEAS	E AREA
VOLT	AMPS		ш	~							ш		VOLT	AMPS
PHASE	PHASE	DESCRIPTION	POLE	BKR	CKT				CKT	BKR	POLE	DESCRIPTION	PHASE	PHASE
Α	В		1				Α	В			L		Α	В
		PBC 02(OFF)	1	20	1		•		2	20	1	GFCI	180	
		RBS 2106 (OFF)	2	50	3		\vdash	•	4	90	2	TVSS		
					5	-	•		6					
	1200	MCPA	1	20	7		\vdash	•	8	50	2	RBS 2106		4800
1650		RBA 72	2	40	9	\vdash	•	-	10				4800	
	1650				11		\vdash	•	12	50	2	RBS 2106		4800
1650		RBA 72	2	40	13	-	•		14				4800	
	1650				15	\vdash	+	•	16	30	1	UNMARKED		
1650		RBA 72	2	40	17	H	•	\vdash	18	20	1	UNMARKED		
	1650				19		\vdash	•	20	20	1	UNMARKED		
360		BATTERY CHARGER	1	20	21	-	•		22	20	1	BBU GFI	180	
	480	BLOCK HEATER	1	20	23	F	F	•	24	20	1	BBU HEAT CONTROL		200
					25	-	•		26					
					27	-	H	•	28					
					29	F	•	-	30					
5310	6630					٧	'A/LI	NE					9960	9800
PHASE A = 15270 VA										PHA:	SEB=	16430	VA	
CONNE	CTED LC	DAD:		3	31700	VA								
CONNE	CTED A	MPS:			132.1	Α.								

2 EXISTING AC PANEL SCHEDULE

MAIN C	:B: 2P/2	00A											N	EMA: :
						PA	NEL	'A'				LOCATION:		
VOLT			щ	~	-	ļ			-	~	щ		VOLT	
	PHASE	DESCRIPTION	POLE	BKR	CKT				CKT	BKR	POLE	DESCRIPTION	PHASE	PHAS
A	В					1	1	3					Α	В
		PBC 02 (OFF)	1	20	1	_			2	20	1	GFCI	180	
		RBS 2106 (OFF)	2	50	3		-		4	90	2	TVSS		
					5	-			6					
	1200	MCPA	1	20	7		_		8	50	2	RBS 2106		4800
1650		RBA 72	2	40	9	_	_		10				4800	
	1650				11		_		12	50	2	RBS 2106		4800
1650		RBA 72	2	40	13	-			14				4800	
	1650				15		-	-	16	30	1	UNMARKED		
1650		RBA 72	2	40	17	-	$\overline{}$		18	20	1	UNMARKED		
	1650				19		-	-	20	20	1	UNMARKED		
360		BATTERY CHARGER	1	20	21			-	22	20	1	BBU GFI	180	
	480	BLOCK HEATER	1	20	23		-	-	24	20	1	BBU HEAT CONTROL		200
1650		RBA 72	2	40	25	-	_		26	40	2	RBA 72	1650	
	1650				27		-	-	28					1650
					29	-	-		30					
6960	8280				*	V	A/LII	NE					11610	1145
PHASE A = 18570 VA										PHAS	SE B =	19730	VA	
CONNE	CTED LC	AD:		;	38300	VA								

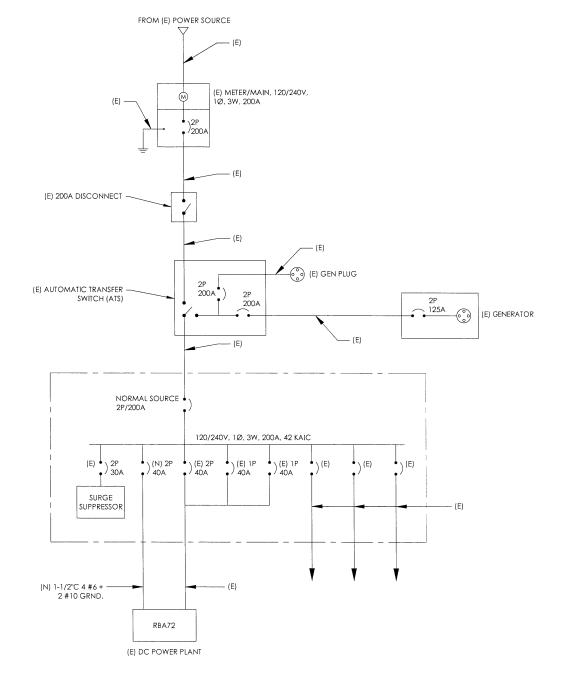

PREPARED FOR




5001 EXECUTIVE PKWY, SAN RAMON CA 94583

15 INFRASTRUCTURE

23 MAUCHLY, SUITE 110 IRVINE, CALIFORNIA 92618

AT&T Site ID:

CCL00916

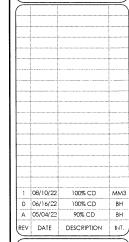

It is a violation of law for any persons, unless they are acting under the direction of a licensed professional engineer, to alter this document

CCL00916

UKIAH NORTH

1460 LOVERS LANE UKIAH, CA 95482

Sheet Title:
SINGLE LINE DIAGRAM & AC PANEL SCHEDULE


E-1

AC SINGLE LINE DIAGRAM

NOTES TO CONTRACTOR:

 CONTRACTOR IS TO REFER TO AT&T'S MOST CURRENT RADIO FREQUENCY DATA SHEET (RFDS) PRIOR TO CONSTRUCTION.



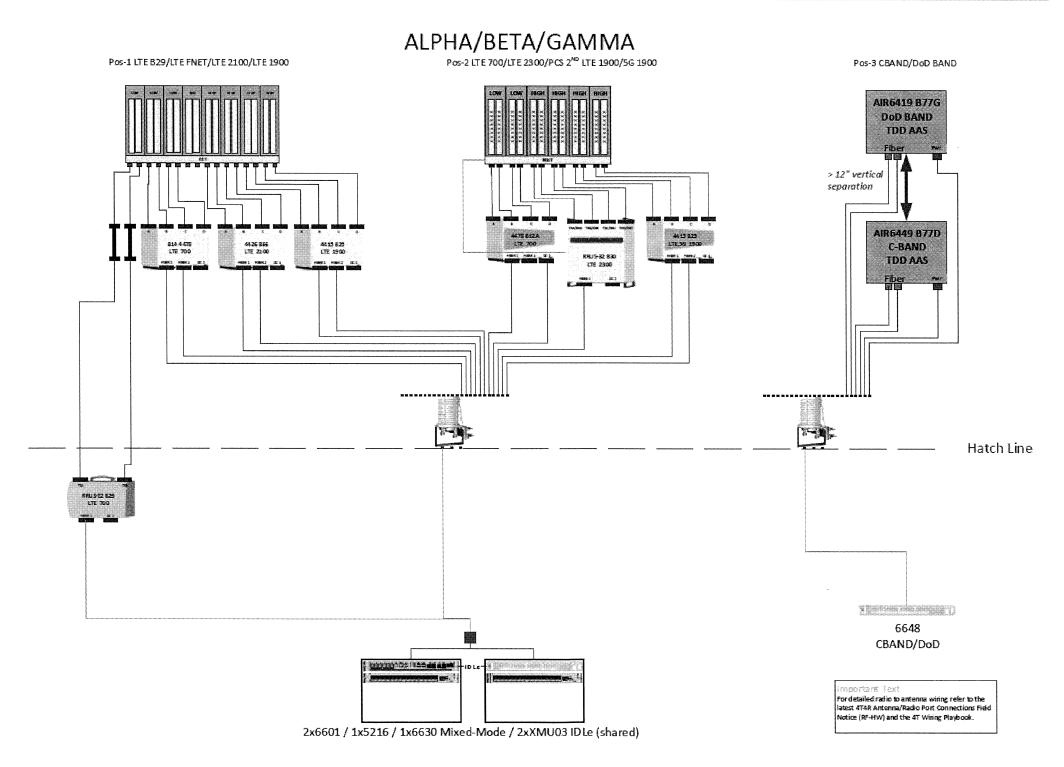

PREPARED FOR



5001 EXECUTIVE PKWY, SAN RAMON CA 94583

endor:



23 MAUCHLY, SUITE 110 IRVINE, CALIFORNIA 92618

AT&T Site ID:

CCL00916

1 08/10/22 100% CD MM3
0 06/16/22 100% CD BH
A 05/04/22 90% CD BH
REV DATE DESCRIPTION INT.

Licensor



It is a violation of law for any persons, unless they are acting under the direction of a licensed professional engineer, to alter this document

Issued For:

CCL00916

UKIAH NORTH

1460 LOVERS LANE UKIAH, CA 95482

Sheet Title

PLUMBING DIAGRAM

Sheet Numbe

RF-1

PLUMBING DIAGRAM

TON

I. RF SAFETY MEASURES COMPLETED PER EME REPORT COMPLETED ON


07/14/2022, BY "WATERFORD CONSULTANTS, LLC"
2. ANY OTHER RF REPORT IS FOR REFERENCE ONLY.


RECOMMENDATIONS:

AT&T MOBILITY ACCESS LOCATION:
CAUTION 2 SIGN REQUIRED ON THE BASE OF THE BILLBOARD AT THE ACCESS LOCATION.
MATERIALS:

(1) CAUTION 2 SIGN

WATERFORD CONSULTANTS, LLC RECOMMENDS POSTING RF ALERTING SIGNAGE WITH CONTACT INFORMATION (CAUTION 2) NEAR THE ANTENNAS AT THE PROPOSED MONOPOLE TO INFORM AUTHORIZED CLIMBERS OF POTENTIAL CONDITIONS NEAR THE ANTENNAS.

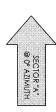

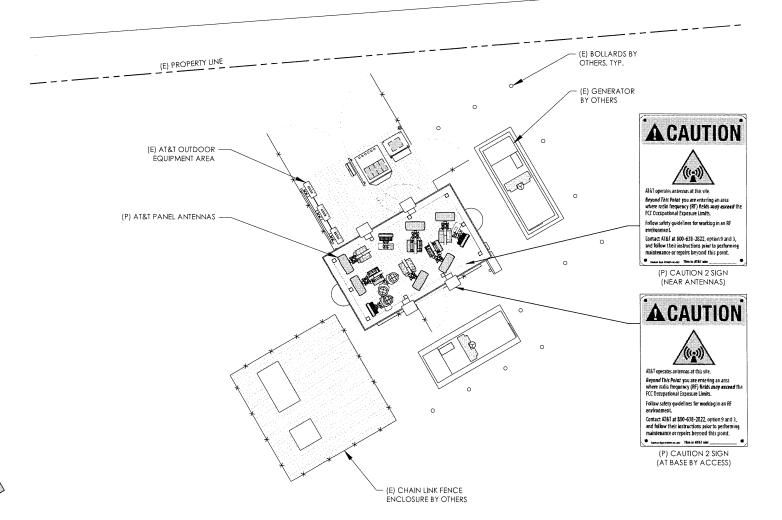



PREPARED FOR



5001 EXECUTIVE PKWY, SAN RAMON CA 94583

Vendor:



23 MAUCHLY, SUITE 110 IRVINE, CALIFORNIA 92618

AT&T Site ID:

CCL00916

1 08/10/22 100% CD MM:
0 06/16/22 100% CD BH
A 05/04/22 90% CD BH
REV DATE DESCRIPTION INT.

Licensor:



It is a violation of law for any persons, unless they are acting under the direction of a licensed professional engineer, to alter this document

Issued For:

CCL00916

UKIAH NORTH

1460 LOVERS LANE UKIAH, CA 95482

Sheet Title:

EME SIGNAGE LOCATION PLAN

Sheet Numbe

EME-1

1 EME SIGNAGE LOCATION PLAN

24"x36" SCALE: NTS 11"x17" SCALE: NTS



This Site Operated by:

AT&T MOBILITY

5001 EXECUTIVE PKWY SAN RAMON, CA 94583 IN CASE OF FIRE AND THE NEED FOR SHUTDOWN TO DEACTIVATE ANTENNAS CALL THE FOLLOWING NUMBER: For 24 Hour Emergency Contact and Access Please Call: (800)832-6662

Reference Site#:__CCL00916

Site Address: 1460 LOVERS LANE UKIAH, CA 95482

FENCED COMPOUND SIGNAGE



FENCED COMPOUND SIGNAGE



DOOR / EQUIPMENT SIGN






LEAD ACID BATTERIES DIESEL FUEL CORROSIVE LIQUIDS (ELECTROLYTE)
ENERGIZED ELECTRICAL CIRCUITS NO SMOKING **NO OPEN FLAMES** NO SMOKING

NEPA HAZARD SIGN - TYPICAL

DANGER

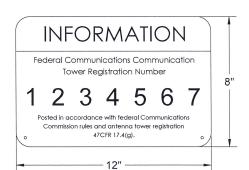

FCC ASR SIGNAG (6) N.T.S.

Property of AT&T **Authorized**

No Trespassing

In case of emergency, or prior to performing maintenance on this site, call _ and reference cell site number

Personnel Only

N.T.S.



Authorized Personnel Only

SHELTER / CABINET DOORS SIGNAGE

Property of AT&T

In case of emergency, or prior to performing maintenance on this site, call and reference cell site number

FABRICATION:

BACK W/ BLACK LETTERING

IN FRONT OF THE SIGN.

Caution Sign 2 (8" x 12") **ACAUTION**

NOTICE

Beyond This Point you are entering an area

where radio frequency (FF) fields may exceed the FCC General Population Exposure Limits.

Contact AT&T at 800-638-2822, uption 9 and 3

(8" x 12")

/(@))\

AT&T operates antennas at this situ

in The Striped Area you are entering an are where radio frequency (RF) helds may exce FCC Occupational Exposure Limits.

Follow safety guidelines for working in an RF

Contact AT&T at 800-638-2822, option 9 and 3,

and follow their instructions prior to performin maintenance or repairs within the striped area

Caution Sign 2A

(8" x 12")

and follow their instructions prior to perform maintenance or repairs above this point.



ACAUTION

/((<u>@</u>))\

Beyond This Point you are entering an area where radio frequency (FF) fields may exceed to FCC Occapational Exposure Limits.

Follow safety audelines for working in an IB

Contact AT&T at 800-638-2822, option 9 and 3.

and follow their instructions prior to performing maintenance or repairs beyond this point.

AT&T operates antennas at this site.

· this is Albit to

ladio frequency (RF) fields near some antenna may exceed the FCC Occupational Exposure Limits Centact AT&T at 800-638-2822, option 9 and 3, and follow their instructions prior to performing maintenance or repairs beyond this point. Personnel climbing this tower should be trained or working in RF environments and use a persona RF monitor if working near active antenna

> Caution Sign 28 Tower (8" x 12")

> > **AWARNING**

\((\frac{1}{2}))\

AT&T operates amennas at this site



Trilingual Notice Sign




s antennar at this site

Follow safety guidelines for working in an RF Contact ATE(at 800-639-2822, option 9 and 3, and follow their instructions prior to performing

Caution Sign 2C Parapet

Warning Sign #WA-1B-AL-128 Warning Sign #WA-2A-AL-128

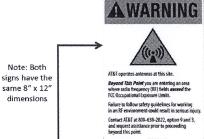

Shall be used when barriers are present or will be deployed around AT&T intennas - Warning 1B

CONTRACTOR SHALL INSTALL ALL INFORMATION SIGNAGE IN

ACCORDANCE W/ AT&T WIRELESS DOCUMENT #03-0074 RE EXPOSURE POLICY AND RF SAFETY COMPLIANCE PROGRAM, LATEST

SIGN 1 IS TO BE MADE ON THE 50 MIL ALUMINUM SHEETING (SIZE 8

INCHES BY 12 INCHES) W/ FOUR (4) 1 INCH MOUNTING HOLES, ONE

EACH CORNER OF THE SIGN FOR MOUNTING W/ HARDWARE W/ TIE

WRAPS. THE MAIN BACKGROUND COLOR IS TO BE WHITE FRONT &

THE INFORMATION BAND SHALL BE 1.2 INCH SOLID GREEN BAND W. 0.5 INCH HIGH BLACK LETTERING, THE BODY TEXT SHALL BE IN BLACK

LETTERING w/0.2 INCH HIGH LETTERS. THE REF LINE SHALL BE IN $\frac{1}{8}$ INCH

THE PLACEMENT OF TEXT SHALL BE DONE IN A MANNER THAT WILL

PERMIT EASY READING FROM A DISTANCE OF APPROXIMATELY 6 FEET

*SIGN I-1: ENTRANCE DOOR, SEE DETAIL 1A, THIS SHEET

Contact A161 at 800-636-2622, option 9 and 3, and follow their instructions prior to performin maintenance or repairs within the striped area. Shall be used in lieu of barriers along with striping when

REQUIRE HQ / MRFSE APPROVAL

OVER THE FACE OF THE SIGN. *SIGN 1-2: POLE, SEE DETAIL 1B, THIS SHEET

SIGN 2 MUST BE A NON METALLIC LABEL W/ AN ADHESIVE BACKING, THE LABEL SHALL BE MADE USING VINYL OR SIMILAR WEATHERPROOF MATERIAL. THE LABEL SHALL BE APPROXIMATELY 5X7 INCHES W/ A WHITE BACKGROUND AND BLACK LETTERING, THE GREEN BAND SHALL BE 1.375 INCH IN HEIGHT & THE LETTERING SHALL BE BLACK W/ 0.75 INCH HIGH LETTERS. THE TEXT LETTERING SHALL BE BLACK W/ 1 INCH HIGH LETTERS. UV PROTECTION SHALL BE PLACED OVER THE FRONT OF

ALL PAINT WILL BE BAKED W/ENAMEL W/ UV PROTECTIVE COATING

*SIGN 1-3: BACK OF ANTENNAS, SEE DETAIL 1C & 3, THIS SHEET

*SIGN 3 IS A 1 INCH X 2 INCH PANEL THAT CAN BE APPLIED TO THE BACK OR SIDE OF AN ANTENNA TO IDENTIFY IT AS AN AT&T ANTENNA.

*SIGN 1-4: SIDE OF ANTENNAS, SEE DETAIL 1D & 3, THIS SHEET

SIGN 4 IS MADE FROM TRANSPARENT MATERIAL 1-1/2 INCHES WIDE & 24 INCHES LONG. THE LETTERING IS TO BE BLACK w_2^1 INCH LETTERING IN A VERTICAL COLUMN. THE SPACING BETWEEN WORDS MUST BE SUCH THAT IT IS EASILY READ & FILLS THE LENGTH OF THE SIGN.

SIGNAGE AND STRIPING INFORMATION

THE FOLLOWING INFORMATION IS A GUIDFLINE W/ RESPECT TO PREVAILING STANDARDS LIMITING HUMAN EXPOSURE TO RADIO FREQUENCY ENERGY AND SHOULD BE USED AS SUCH. IF THE SITE'S EMF REPORT OR ANY LOCAL, STATE OR FEDERAL GUIDELINES OR REGULATIONS SHOULD BE IN CONFLICT W/ ANY PART OF THESE NOTES OR PLANS, THI MORE RESTRICTIVE GUIDELINE OR REGULATION SHALL BE FOLLOWED AND OVERRIDE THE LESSER.

IF THE PUBLIC LIMIT OF RF EXPOSURE ON THE SITE IS EXCEEDED AND THE AREA IS PUBLICLY ACCESSIBLE (e.g. ROOF ACCESS DOOR THAT CANNOT BE LOCKED, OR FIRE EGRESS) THEN BOTH BARRICADES AND STRIPING SHALL BE PLACED AROUND THE ANTENNAS, THE EXACT EXTENT OF THE BARRICADES AND STRIPING SHALL BE DETERMINED BY THE EMF REPORT, USE THE PLANS AS A GUIDELINE FOR PLACEMENT OF SUCH BARRICADES AND STRIPING

ALL TRANSMIT ANTENNAS REQUIRE A THREE LANGUAGE WARNING SIGN WRITTEN IN ENGLISH, SPANISH, AND CHINESE. THIS SIGN SHALL BE PROVIDED TO THE CONTRACTOR AND THE AT&T CONSTRUCTION PROJECT MANAGER AT THE TIME OF CONSTRUCTION. THE LARGER SIGN SHALL BE PLACED IN PLAIN SIGHT AT ALL ROOF ACCESS LOCATIONS AND ON ALL BARRICADES. THE SMALLER SIGN SHALL BE PLACED ON THE ANTENNA ENCLOSURES IN A MANNER THAT IS EASILY SEEN BY ANY CONVENTIONS. ALL SIGNS SHALL HAVE AT&T'S NAME AND THE COMPANY CONTACT INFORMATION (e.g. TELEPHONE NUMBER) TO ARRANGE FOR ACCESS TO THE RESTRICTED

BE PART OF THE CONTRACTORS CLOSE OUT PACKAGE & SHALL BE TURNED INTO THE AT&T CONSTRUCTION PACKAGE & SHALL BE TURNED INTO THE AT&T CONSTRUCTION PROJECT MANAGER AT THE END OF CONSTRUCTION

SAFFTY PAINT IN A CROSS-HATCH PATTERN AS DETAILED BY THE CONSTRUCTION DRAWINGS. ALL BARRICADES SHALL BE MADE OF AN REFRIENDLY MATERIAL SO AS NOT TO BLOCK OR INTERFERE W/ THE OPERATION OF THE ANTENNAS. BARRICADES SHALL BE PAINTED W/ FADE RESTRAINT YELLOW SAFETY PAINT, THE CONTRACTOR SHALL PROVIDE ALL RE FRIENDLY BARRICADES NEEDED, & SHALL PROVIDE THE AT&T CONSTRUCTION PROJECT MANAGER W/ A DETAILED SHOP DRAWING OF EACH BARRICADE UPON CONSTRUCTION COMPLETION.

PERSON ON THE ROOF, WARNING SIGNS SHALL COMPLY W/ ANSI C95.2 COLOR, SYMBOL, AND CONTENT AREAS. THIS TELEPHONE NUMBER SHALL BE PROVIDED TO THE CONTRACTOR BY THE AT&T CONSTRUCTION PROJECT MANAGER AT THE TIME OF CONSTRUCTION.
PHOTOS OF ALL STRIPING, BARRICADES & SIGNAGE SHALL

STRIPING SHALL BE DONE W/ FADE RESISTANT YELLOW

GENERAL NOTES

PREPARED FOR



5001 EXECUTIVE PKWY SAN RAMON CA 94583

Vendor:



23 MAUCHLY, SUITE 110 IRVINE, CALIFORNIA 92618

P-075481 AT&T Site ID:

CCL00916

100% CD 06/16/22 100% CD 05/04/22 90% CD REV DATE DESCRIPTION

Licensor



It is a violation of law for any persons, unless they are actin under the direction of a licensed professional engine

Issued For:

CCL00916

UKIAH NORTH

1460 LOVERS LANE UKIAH, CA 95482

SITE SIGNAGE

Sheet Numbe

SS-1

4

ALERTING & INFORMATION SIGNAGE

