# COUNTY OF MENDOCINO

### DEPARTMENT OF PLANNING AND BUILDING SERVICES

860 North Bush Street · Ukiah · California · 95482 120 West Fir Street · Ft. Bragg · California · 95437 TELEPHONE: 707-234-6650

FAX: 707-463-5709

FB PHONE: 707-964-5379

FB FAX: 707-961-2427

pbs@mendocinocounty.org

www.mendocinocounty.org/pbs

IGNACIO "NASH" GONZALEZ, INTERIM DIRECTOR

JULIA ACKER KROG, ASSISTANT DIRECTOR

#### August 2, 2021

Department of Transportation
Environmental Health - Ukiah/Fort Bragg
Building Inspection - Fort Bragg
Mendocino Land Trust
Assessor
Agriculture Commissioner
Air Quality Management
Archaeological Commission
Sonoma State University

Resource Lands Protection Committee
Native Plant Society
Caltrans
Department of Forestry/ CalFire
-Resource Management
-Land Use
Department of Fish and Wildlife
Coastal Commission
California Highway Patrol

RWQCB Sierra Club US Fish & Wildlife Service Cloverdale Rancheria Redwood Valley Rancheria Sherwood Valley Band of Pomo Indians Mendocino Transit Authority (MTA) County Addresser- Russ Ford Albion – Little River Fire District

**CASE#**: CDP\_2019-0024 **DATE FILED**: 7/1/2019

OWNER/ APPLICANT: California Department of Transportation (CALTRANS), District

**AGENT:** Frank Demling

**REQUEST:** A Standard Coastal Development Permit to widen existing lanes on Highway 1 within the project area to 12 feet, widen the existing shoulders in both directions to 4 feet, install a Midwest Guardrail System (MGS), improve the superelevation (rate, transition, and runoff), and remove trees. Work will also involve installing two new culverts, replacing four existing culverts, removing one culvert, extending one box culvert, installing five new drainage inlets (DIs), replacing three DIs, and removing 2 slot drains. In addition, Rock Slope Protection (RSP) will be placed at six outlet locations.

**LOCATION:** Within the Coastal Zone along Highway 1 just south of its intersection with Navarro Ridge Road

(County Road 518), between postmiles MEN-001-41.8 and -42.3. (No specific address given)

SUPERVISORIAL DISTRICT: 5 STAFF PLANNER: JULIA ACKER

**RESPONSE DUE DATE:** August 16, 2021

#### PROJECT INFORMATION CAN BE FOUND AT:

www.mendocinocounty.org

Select "Government" from the drop-down; then locate Planning and Building Services/Public Agency Referrals.

Mendocino County Planning & Building Services is soliciting your input, which will be used in staff analysis and forwarded to the appropriate public hearing. You are invited to comment on any aspect of the proposed project(s). Please convey any requirements or conditions your agency requires for project compliance to the project coordinator at the above address, or submit your comments by email to <a href="mailto:pbs@mendocinocounty.org">pbs@mendocinocounty.org</a>. Please note the case number and name of the project coordinator with all correspondence to this department.

We have reviewed the above application a	and recommend the following (please chec	k one):
☐ No comment at this time.		
☐ Recommend conditional approval (atta	ched).	
	ion (attach items needed, or contact the ap correspondence you may have with the app	
Recommend denial (Attach reasons fo	r recommending denial).	
☐ Recommend preparation of an Enviror	mental Impact Report (attach reasons why	an EIR should be required).
☐ Other comments (attach as necessary	).	
REVIEWED BY:		
Signature	Department	Date

CASE: CDP\_2019-0024

**OWNER:** Multiple (see attached)

**APPLICANT:** Caltrans

Frank Demling AGENT:

California Department of Transportation

1656 Union Street Eureka, CA 95501 707-445-6554

**REQUEST:** A Standard Coastal Development Permit to widen existing lanes on Highway 1 within the project area to 12 feet,

> widen the existing shoulders in both directions to 4 feet, install a Midwest Guardrail System (MGS), improve the superelevation (rate, transition, and runoff), and remove trees. Work will also involve installing two new culverts, replacing four existing culverts, removing one culvert, extending one box culvert, installing five new drainage inlets (DIs), replacing three DIs, and removing 2 slot drains. In addition, Rock Slope Protection (RSP) will be placed at six

outlet locations.

LOCATION: Within the Coastal Zone along Highway 1 just south of its intersection with Navarro Ridge Road (County Road 518),

between post-miles MEN-001-41.8 and -42.3. (No specific address given)

APN/S: Multiple – See attached parcel map

**PARCEL SIZE:** Variable (right-of-way)

GENERAL PLAN: RR5-PD / RMR40

**ZONING:** RR5:PD / RMR

EXISTING USES: Roadway (adjacent uses include agricultural and rural residential uses)

DISTRICT: District 5 (Williams)

RELATED CASES: CDP 2019-0034

	<b>ADJACENT GENERAL PLAN</b>	<b>ADJACENT ZONING</b>	ADJACENT LOT SIZES (ac)	<b>ADJACENT USES</b>
NORTH:	RR5-DL-PD	RR5:DL:PD	15.07 / 6	<b>Rural Residential</b>
EAST:	RR5-PD	RR5:PD	6.02, 6.02, 3.06, 3.04, 6.22,	Rural Residential
			6.04, 3.3, 3.29, 15.07,	
SOUTH:	RMR / RR5-PD	RMR / RR5:PD	38, 6.02	Rural Residential
WEST:	RMR	RMR	6, 13, 17.29, 38	Rural Residential / Public
				Access

#### **REFERRAL AGENCIES**

#### LOCAL

☑ Agricultural Commissioner ☑ Air Quality Management District ☐ Airport Land Use Commission 

☑ Assessor's Office

☑ Building Division (Fort Bragg)

□ County Addresser

☑ Department of Transportation (DOT)

☑ Environmental Health (EH) ☑ Albion-LR Fire District

☑ Mendocino Transit Authority (MTA)

☑ Resource Lands Protection Com.

☑ Mendocino Land Trust

**STATE** 

□ CALFIRE (Land Use)

 □ CALFIRE (Resource Management) □ California Coastal Commission ☑ California Dept. of Fish & Wildlife

☑ California Highway Patrol ☑ California Native Plant Society

☐ California State Clearinghouse

**⊠ CALTRANS** 

oxtimes Regional Water Quality Control Board

☑ Sierra Club **FEDERAL** 

**TRIBAL** 

 □ Cloverdale Rancheria ☑ Redwood Valley Rancheria

**DATE:** 7/30/2021

☑ Sherwood Valley Band of Pomo Indians

#### **ADDITIONAL INFORMATION:**

The application materials include several documents related to compliance with LCP ESHA requirements, including an ESHA Analysis, Natural Environment Study and ESHA Compliance Report. Caltrans filed a CEQA Notice of Exemption (SC #2019038511) as lead agency on this project for the purposes of environmental review.

**STAFF PLANNER: SCOTT PERKINS (CONTRACT)** 

JULIA KROG (ASSISTANT DIRECTOR PBS)

#### **ENVIRONMENTAL DATA**

1. MAC:

N/A

2. FIRE HAZARD SEVERITY ZONE:

Moderate and High FHSZs

3. FIRE RESPONSIBILITY AREA:

Albion-Little River FPD

4. FARMLAND CLASSIFICATION:

Rural Residential and Grazing

5. FLOOD ZONE CLASSIFICATION:

N/A

6. COASTAL GROUNDWATER RESOURCE AREA:

Critical Water Area

7. SOIL CLASSIFICATION:

Soil Classes 117 and 139. See enclosed Soil Classification Maps

8. PYGMY VEGETATION OR PYGMY CAPABLE SOIL:

N/A

9. WILLIAMSON ACT CONTRACT:

Adjacent and to the north of right-of-way

**10. TIMBER PRODUCTION ZONE:** 

N/A

11. WETLANDS CLASSIFICATION:

Yes—see enclosed Wetlands Maps

12. EARTHQUAKE FAULT ZONE:

N/A

13. AIRPORT LAND USE PLANNING AREA:

N/A

14. SUPERFUND/BROWNFIELD/HAZMAT SITE:

N/A

15. NATURAL DIVERSITY DATABASE:

See enclosed maps as applicable.

16. STATE FOREST/PARK/RECREATION AREA ADJACENT:

N/A

**17. LANDSLIDE HAZARD:** 

N/A—See enclosed Natural Hazards Maps

18. WATER EFFICIENT LANDSCAPE REQUIRED:

N/A

19. WILD AND SCENIC RIVER:

N/A

20. SPECIFIC PLAN/SPECIAL PLAN AREA:

N/A

21. STATE CLEARINGHOUSE REQUIRED:

No

22. OAK WOODLAND AREA:

N/A

23. HARBOR DISTRICT:

N/A

FOR PROJECTS WITHIN THE COASTAL ZONE ONLY

24. LCP LAND USE CLASSIFICATION:

Various

25. LCP LAND CAPABILITIES & NATURAL HAZARDS:

See enclosed maps

**26. LCP HABITATS & RESOURCES:** 

See enclosed maps

27. COASTAL COMMISSION APPEALABLE AREA:

Yes—see enclosed maps

28. CDP EXCLUSION ZONE:

No—see enclosed maps

29. HIGHLY SCENIC AREA:

Yes—see enclosed maps

**30. BIOLOGICAL RESOURCES & NATURAL AREAS:** 

Yes—see enclosed maps

31. BLUFFTOP GEOLOGY:

Non-blufftop

#### **DEPARTMENT OF TRANSPORTATION**

NORTH REGION ENVIRONMENTAL DISTRICT 1, PO BOX 3700 EUREKA, CA 95502-3700 PHONE (707) 441-4564 FAX (707) 441-5775 TTY 711



Making Conservation a California Way of Life.

June 26, 2019

County of Mendocino Department of Planning & Building Services Attn: Julia Acker-Krog 120 West Fir Street Fort Bragg, CA 95437

Dear Ms. Acker-Krog:

Enclosed is an application to Mendocino County Planning and Building for a Coastal Development Permit for the California Department of Transportation's Navarro Ridge Safety project. Per a conversation I had with Derek Larson on June 26, 2019, we have included only 2 complete application packets.

The California Department of Transportation (Caltrans) proposes to make safety improvements and perform drainage rehabilitation on ½ mile of State Route (SR)1 between post miles (PM) 41.8 and 42.3 in Mendocino County just south of Navarro Ridge Road. Caltrans is requesting a Coastal Development Permit from Mendocino County in order to proceed with the completion of this project.

Enclosed for your review are the following items:

- Application Form and Initial Site and Project Description Questionnaire (2 copies)
- Project Description Continuation Pages, including Vicinity Map & Site Plan (2 copies)
- Signed Certification and Site View Authorization Form (1 copy)
- Coastal Zone Development Form with Stamped, Legal Size Envelopes Addressed to Owners
- Signed Declaration of Posting with Pictures
- Signed Indemnification and Hold Harmless Form (1 copy)
- Natural Environment Study Addendum and Original (Appendix A), dated November 2018 and September 2017, respectively (2 copies)
- Environmentally Sensitive Habitat Area Assessment (Appendix B), dated June 20, 2019 (2 copies)
- Signed CEQA Categorical Exemption and NEPA Categorical Exclusion (Appendix C), dated March 2019 (2 copies)
- Stamped Notice of Exemption (Appendix C) dated March 2019 (2 copies)
- Filing Fee of \$6,286.55 for processing of the Coastal Development Permit

If you have any questions or need additional information, please contact me at (707)441-4564. Thank you for your continued assistance in expediting the permit for this project.

Sincerely,

Stephen Umbertis

Associate Environmental Planner

PLANNING & BUILDING SERV

# COUNTY OF MENDOCINO DEPT OF PLANNING AND BUILDING SERVICES

120 WEST FIR STREET FORT BRAGG, CA 95437 Telephone: 707-964-5379 FAX: 707-961-2427 pbs@co.mendocino.ca.us

www.co.mendocino.ca.us/planning



Case No(s) CDF No(s) Date Filed	CDP_2019-0024	
CDF No(s)		
Date Filed	July 1, 2019	
Fee		
Receipt No.		
Fee Receipt No. Received by		
	Office Use Only	

# COASTAL ZONE APPLICATION FORMECEIVED

— А	PPLICANT			JUL 0 1 2010
Name	Department of Trans	sportation, District 1		PLANNING & BUILDING
Mailing Address	1656 Union Street			PLANNING & BUILDING SI FORT BRAGG CA
City	Eureka	State CA	Zip Code 95501	Phone (707)441-5602
— PI	ROPERTY OWNER			<u> </u>
Name Mailing	Same as Applicant			
Address				
City	Same as Applicant	State Same as Applicant	Zip Code Same as Applicant	Phone Same as Applicant
City	Eureka	State CA	Zip Code 95501	Phone (707)445-6554
PAR	CEL SIZE Square feet		Zip Code 95501  RESS OF PROJEC	
PAR	CEL SIZE ———	STREET ADD		Т
PAR	RCEL SIZE Square feet	STREET ADD Highway 1 from	RESS OF PROJEC	Т
NA	CEL SIZE  Square feet Acres	STREET ADD Highway 1 from	RESS OF PROJEC	Т

# COASTAL ZONE - SITE AND PROJECT DESCRIPTION QUESTIONNAIRE

The purpose of this questionnaire is to relate information concerning your application to the Planning and Building Services Department and other agencies who will be reviewing your project proposal. Please remember that the clearer picture that your give us of your project and the site, the easier it will be to promptly process your application. Please answer all questions. Those questions which do not pertain to your project, please indicate "Not Applicable" or "N/A".

## THE PROJECT

1. Describe your project and include secondary improvements such as wells, septic systems, grading, vegetation removal, roads, etc.

Caltrans proposes to make safety improvements in order to reduce the number and severity of collisions by improving roadway geometry, increasing shoulder width in both the travel directions, installing rumble strips, and installing a Midwest Guardrail System. Work will also include installing four new culverts, replacing three existing culverts, installing nine new drainage inlets (DIs), removing nine DIs, and extending 5 culverts.

Widening the shoulders will involve the excavation of existing material on the east side of Hwy 1 and placement of a new structural section. A complete project description is attached to this application form, which includes the Vicinity Map and Site Plan for the project.

2.	If the project is <u>residential</u> , please comp	plete the following:	
	TYPE OF UNIT	NUMBER OF STRUCTURES	SQUARE FEET PER DWELLING UNIT
	Single Family	/A	z wzzawe erm
	Mobile Home	/A	
	Duplex N	/A	
	Multifamily N	/A	
	If Multifamily, number of dwelling uni		-
3.	If the project is <u>commercial</u> , <u>industrial</u> ,	or <u>institutional</u> , complete the following:	
	Total square footage of structures:	N/A	
	Estimated employees per shift:	N/A	
	Estimated shifts per day:	N/A	
	Type of loading facilities proposed:	N/A	
4.	Will the proposed project be phased?	☐ Yes ■ No	
	If Yes, explain your plans for phasing.		

5.	Are there existing structures on the propular of the propular yes, describe below and identify the unit of the propular of the		No e on the plot plan.	
6.	Will any existing structures be demolishe Will any existing structures be removed?		■ No	
	If yes to either question, describe the typ site, if applicable.	e of development t	to be demolished or remo	oved, including the relocation
7.	Project Height. Maximum height of stru	icture N/A	fee	et.
8.	Lot area (within property lines): N/A		square feet	acres
9.	Lot Coverage:			
	Building coverage N/A	STING square feet	NEW PROPOSE	
	Paved area N/A	square feet	square f	
	Landscaped area N/A	square feet	square f	eetsquare feet
	Unimproved area N/A	square feet	square f	eet square feet
			GRAND TOTAL:	square feet
10	2 2			Should equal gross area of parcel)
10.	Gross floor area: N/A	square tee	et (including covered par	rking and accessory buildings).
11.	Parking will be provided as follows:			
	Number of Spaces Existing N/	<u>A</u>	Proposed N/A	Total_N/A
	Number of covered spaces	N/A		ze
	Number of uncovered spaces	N/A		ze
	Number of standard spaces	N/A N/A	Si	ze
	Number of handicapped spaces	IN/A	S1	ze

	Utilities will be supplied to the site as f	ollows:	
	A. Electricity		
	Utility Company (service e	xists to the parcel).	
			o site: feet miles
	On Site generation, Specif	y:	
	None		
	B. Gas		
	Utility Company/Tank		
	On Site generation, Specification	y:	
	None		
	C. Telephone: Yes	■ No	
13.	Will there by any exterior lighting?	Yes	] No
			lighting on the plot plan and building plans.
1.4	Wilest will be the mostly of a Common dia	10	
14.	What will be the method of sewage dis	posai?	
	Community sewage system, specif	y supplier	
	Septic Tank		
	Other, specify N/A		
15.	What will be the domestic water source	e?	
		supplier	
	Well		
	☐ Spring		
	Other, specify N/A		
16	Is any grading or road construction pla	nned? Ves	□ No
16.	Is any grading or road construction pla	nned? Yes	□ No
16.	If yes, grading and drainage plans may	nned?  Yes be required. Also, de	No escribe the terrain to be traversed (e.g., steep, mo
16.	If yes, grading and drainage plans may slope, flat, etc.).	be required. Also, de	escribe the terrain to be traversed (e.g., steep, mo
16.	If yes, grading and drainage plans may slope, flat, etc.).  Rolling to moderately steep term	be required. Also, de	☐ No escribe the terrain to be traversed (e.g., steep, mo
16.	If yes, grading and drainage plans may slope, flat, etc.).	be required. Also, de	escribe the terrain to be traversed (e.g., steep, mo
16.	If yes, grading and drainage plans may slope, flat, etc.).  Rolling to moderately steep term	be required. Also, de	escribe the terrain to be traversed (e.g., steep, mo
16.	If yes, grading and drainage plans may slope, flat, etc.).  Rolling to moderately steep term	be required. Also, de	escribe the terrain to be traversed (e.g., steep, mo
16.	If yes, grading and drainage plans may slope, flat, etc.).  Rolling to moderately steep terr slopes, with some fill proposed.	be required. Also, de	escribe the terrain to be traversed (e.g., steep, mo
16.	If yes, grading and drainage plans may slope, flat, etc.).  Rolling to moderately steep term	be required. Also, de	escribe the terrain to be traversed (e.g., steep, mo
16.	If yes, grading and drainage plans may slope, flat, etc.).  Rolling to moderately steep terr slopes, with some fill proposed.	be required. Also, de	escribe the terrain to be traversed (e.g., steep, mo
16.	If yes, grading and drainage plans may slope, flat, etc.).  Rolling to moderately steep terr slopes, with some fill proposed.  For grading and road construction, com	be required. Also, devain. Road will be wide	escribe the terrain to be traversed (e.g., steep, mo
16.	If yes, grading and drainage plans may slope, flat, etc.).  Rolling to moderately steep terr slopes, with some fill proposed.  For grading and road construction, com  A. Amount of cut:	be required. Also, devain. Road will be wide applete the following:	escribe the terrain to be traversed (e.g., steep, movement to the east, mostly through additional  cubic yards
16.	If yes, grading and drainage plans may slope, flat, etc.).  Rolling to moderately steep term slopes, with some fill proposed.  For grading and road construction, com  A. Amount of cut:  B. Amount of fill:	be required. Also, detain. Road will be wide applete the following: $\frac{6766}{3462}$	escribe the terrain to be traversed (e.g., steep, more ened to the east, mostly through additional  cubic yards cubic yards
16.	If yes, grading and drainage plans may slope, flat, etc.).  Rolling to moderately steep term slopes, with some fill proposed.  For grading and road construction, com  A. Amount of cut: B. Amount of fill: C. Maximum height of fill slope:	be required. Also, devain. Road will be wide applete the following: $ \frac{6766}{3462} $ 20	escribe the terrain to be traversed (e.g., steep, more ened to the east, mostly through additional  cubic yards cubic yards feet

17.	Will vegetation be removed on areas other than the building sites and roads?  Yes  If yes, explain:
them a report.	ximately 65 trees (total) will be removed from locations on both sides of the existing road to amodate the proposed road widening. These trees are in questionable health, with a number of appearing dead. More detail is provided in the attached Project Description, NES, and ESHA. The trees are growing in a line along the shoulders of the road and do not constitute a stand that es essential habitat or that could be classified as an ESHA.
18.	Does the project involve sand removal, mining or gravel extraction? Yes  If yes, detailed extraction, reclamation and monitoring may be required.
19.	Will the proposed development convert land currently or previously used for agriculture to another use? Yes No If yes, how many acres will be converted? acres (An agricultural economic feasibility study may be required.)
20.	Will the development provide public or private recreational opportunities? ☐ Yes ■ No If yes, explain:
21.	Is the proposed development visible from:  A. State Highway 1 or other scenic route?  B. Park, beach or recreation area?  The proposed project would widen Hwy 1 at the stated location. The Mendocino Land  No Trust owns a public access area across SR  No 1 from the southern end of the project area.
22.	Will the project involve the use or disposal of potentially hazardous materials such as toxic substances, flammables, or explosives?    Yes No  If yes, explain:
23.	Does the development involve diking, filling, dredging or placing structures in open coastal waters, wetlands, estuaries or lakes?
	A. Diking Yes No B. Filling Yes No C. Dredging Yes No D. Placement of structures in open coastal waters, wetlands, estuaries or lakes Yes No Amount of material to be dredged or filled? cubic yards.  Location of dredged material disposal site:
	Has a U.S. Army Corps of Engineers permit been applied for?   Yes  No

#### COASTAL ZONE DEVELOPMENT

COMPLETE FOR PROJECTS LOCATED IN THE COASTAL ZONE ONLY

List all property owners within 300 feet, and occupants within 100 feet along with the corresponding Assessor's Parcel Number for each owner/occupant. **This form must be typed.** 

AP# 000-000-00 LASTNAME, FIRSTNAME STREET ADDRESS CITY, STATE ZIP	
123-320-05 Michael Garrison PO Box 727 Albion, CA, 95410	
123-320-003, 123-310-14, 123-310-13 Douglas and Stephanie Bliss PO Box 744 Albion, CA 95410	
123-310-02, 126-010-01 Mendocino Land Trust PO Box 1094 Mendocino, CA 95460	
123-310-06 Beverly Witchner PO Box 610 Albion, CA 95410	
126-010-03, 126-010-05 Van L Phillips PO Box 2370 Borrego Springs, CA 92004	
123-310-007 Robbie Robinson PO Box 846 Albion, CA 95410	
123-310-16 Frank and Beverly Engelhardt PO Box 851 Albion, CA 95410	
123-310-015 Gregory and Ramona Weil 442 Stilson Canyon Rd Chico, CA 95928	

# CERTIFICATION AND SITE VIEW AUTHORIZATION

1.	I hereby certify that I have read this completed application and that, to the best of my knowledge, the
	information in this application, and all attached appendices and exhibits, is complete and correct. I
	understand that the failure to provide any requested information or any misstatements submitted in
	support of the application shall be grounds for either refusing to accept this application, for denying
	the permit, for suspending or revoking a permit issued on the basis of such misrepresentations, or for seeking of such further relief as may seem proper to the County.
2.	I hereby grant permission for County Planning and Building Services staff and hearing bodies to enter
	upon and site view the premises for which this application is made in order to obtain information
	necessary for the preparation of required reports and render its decision

upon and site view the premises for which this application is made in or	0
necessary for the preparation of required reports and render its decision	
1/1/2	6/27/19
Owner/Authorized Agent	Date
NOTE: IF SIGNED BY AGENT, <u>OWNER</u> MUST SIGN BELOW.	
AUTHORIZATION OF AGENT	
I hereby authorize	to act as my
representative and to bind me in all matters concerning this application.	
Owner	Date

# MAIL DIRECTION

To facilitate proper handling of this application, please indicate the names and mailing addresses of individuals to whom you wish correspondence and/or staff reports mailed if different from those identified on Page One of the application form.

Name	Name	Name	
Mailing Address	Mailing Address	Mailing Address	

# **INDEMNIFICATION AND HOLD HARMLESS**

ORDINANCE NO. 3780, adopted by the Board of Supervisors on June 4, 1991, requires applicants for discretionary land use approvals, to sign the following Indemnification Agreement. Failure to sign this agreement will result in the application being considered incomplete and withheld from further processing.

#### INDEMNIFICATION AGREEMENT

As part of this application, applicant agrees to defend, indemnify, release and hold harmless the County of Mendocino, its agents, officers, attorneys, employees, boards and commissions, as more particularly set forth in Mendocino County Code Section 1.04.120, from any claim, action or proceeding brought against any of the foregoing individuals or entities, the purpose of which is to attack, set aside, void or annul the approval of this application or adoption of the environmental document which accompanies it. The indemnification shall include, but not be limited to, damages, costs, expenses, attorney fees or expert witness fees that may be asserted by any person or entity, including the applicant, arising out of or in connection with the approval of this application, whether or not there is concurrent, passive or active negligence on the part of the County, its agents, officers, attorneys, employees, boards and commissions.

Date: 6/27/19

Applicant

#### COMPLETE FOR PROJECTS LOCATED WITHIN THE COASTAL ZONE ONLY

#### DECLARATION OF POSTING

At the time the application is submitted for filing, the applicant must **Post**, at a conspicuous place, easily read by the public and as close as possible to the site of the proposed development, notice that an application for the proposed development has been submitted. Such notice shall contain a general description of the nature of the proposed development and shall be on the standard form provided in the application packet. If the applicant fails to post the completed notice form and sign the **Declaration of Posting**, the Department of Planning and Building Services cannot process the application.

completed notice form and sign the Declaration of Posting, the Department of Planning and Building Services cannot process the application.

As Proof of Posting, please sign and date this Declaration of Posting form when the site is posted; it serves as proof of posting. It should be returned to the Department of Planning and Building Services with the application.

Pursuant to the requirements of Section 20.532.025(H) of the Mendocino County Code, I hereby certify that on \_\_\_\_\_\_ (date of posting), I or my authorized representative posted the "NOTICE OF PENDING PERMIT" for application to obtain a Coastal Development Permit for the development of:

Caltrans is proposing to widen the travel lanes to 12 feet and shoulders to 4 feet, as well as improve 8 culverts and drainage inlets and outlets.

The project will require the removal of 65 small to medium trees lining both sides of the road.

(Description of development)

Located at:

Highway 1 at Navarro Ridge Road, Post Mile 41.8 - 42.3

(Address of development and Assessor's Parcel Number)

The public notice was posted at:

Albion Post Office, Albion Store, Elk Store,

(A conspicuous place, easily seen by the public and as close as possible to the site of proposed development)

Owner Authorized Representative

Date

(A copy of the notice which was posted shall be attached to this form).

**NOTE:** YOUR APPLICATION CANNOT BE PROCESSED UNTIL THIS "DECLARATION OF POSTING" IS SIGNED AND RETURNED TO PLANNING AND BUILDING SERVICES.

# NOTICE OF PENDING PERMIT

# A COASTAL PERMIT APPLICATION FOR DEVELOPMENT ON THIS SITE IS PENDING BEFORE THE COUNTY OF MENDOCINO

PROPOSED DEVELOPMENT: The proposed project would make safety improvements and perform drainage rehabilitation on State Route 1 (SR 1). The project is being proposed to reduce the number and severity of collisions by improving roadway geometry, increasing shoulder widths to current standards, and installing rumble strips and a Midwest Guardrail System (MGS). Shoulder widening and edgeline rumble strips are needed to provide a recovery area for errant vehicles and reduce the frequency of these types of accidents. The existing shoulders are 0 feet in width. Work would include widening both lanes to 12 feet, widening both road shoulders to 4 feet, and improving the super elevation of the road surface to current standards. There are 7 culverts within the project limits including one 6-foot box culvert. The proposed work includes installing four new culverts, replacing three existing culverts, installing nine new drainage inlets (DIs), removing nine existing DIs, and extending 5 culverts. An additional 2 feet of widening beyond the new inboard shoulder has been included in the project to provide space for a new inboard ditch to carry storm water to the replaced culverts in the project area.

**LOCATION:** State Route 1 between post miles (PM) 41.8 and 42.3 in Mendocino County, just south of Navarro Ridge Road

APPLICANT: California Department of Transportation, District 1, Eureka CA

**ASSESSOR PARCEL NUMBER(S):** 123-320-05, 123-320-003, 123-310-14, 123-310-13, 123-310-02, 126-010-01, 123-310-06, 126-010-03, 126-010-05, 123-310-007, 123-310-16, 123-310-015

#### DATE POSTED:

FOR FURTHER INFORMATION, PLEASE TELEPHONE OR WRITE TO:

COUNTY OF MENDOCINO PLANNING AND BUILDING SERVICES 860 NORTH BUSH STREET UKIAH, CA 95482

707-234-6650

## 01-0C550 Navarro Ridge Safety Improvement Project PM 41.8/42.3

### **Project Description**

The California Department of Transportation (Department) is proposing to improve the safety of State Route (SR) 1 from 1.5 miles north of the junction of SR 128 and SR 1 to 0.1 mile south of Navarro Ridge Road, in Mendocino County, near Albion.

Caltrans District 1 Traffic Safety Office initiated the subject project in response to a high incidence of run-off-road collisions. A subsequent review of the collision history indicated that shoulder widening would address the run-off-road collisions by providing recovery area when a vehicle is leaving the traveled way. The project also includes replacing the centerline rumble strip as an audible warning to vehicles when encroaching into opposing traffic.

This segment of highway has an actual Fatal collision rate of 18.6 times the Statewide Average (SWA) for similar facilities, an actual Fatal + Injury (F+I) collision rate of 2.0 times the SWA for similar facilities, and actual total collision rate of 1.5 times the SWA for similar facilities. During the most recent 3-year period for which the information is available (January 1, 2016 to December 31, 2018), 3 collisions were reported for the highway segment from PM 41.8 to PM 42.3. The predominant movement preceding collision was run-off-road. There is a need to reduce the frequency of run-off-road collisions within this highway segment

Within the project limits, the facility is a two-lane conventional highway on rolling terrain with 11.5 to 12-foot lanes and 0- to 1-foot shoulders. The posted speed limit is 55 miles per hour. The adjacent land uses are low-density residential and open space rangeland. The project location overlooks the Pacific Ocean, which lies approximately 1,000 feet to the west. A coastal access trail and a public parking area are present within the project limits. The driveway to the coastal access parking area managed by Mendocino Land Trust is across the highway from a private driveway.

There are eight culverts within the project limits, including one 6-foot box culvert at PM 41.79, previously used for livestock, that would be extended 10.5 feet to the west and 5.5 feet to the east to ensure it continues to function as a wildlife crossing following the proposed shoulder widening at this location. The wildlife crossing will be the pathway to the box culvert/wildlife crossing openings will be enhanced by clearing a small path in the coyote brush scrub upslope and downslope of the culvert and imitate the natural ground by placing native material along base of box culvert. A center-line rumble strip is present throughout this segment (i.e., SR 1 from PM 41.8 to PM 42.3).

Existing horizontal curves do not meet standard radii at several locations throughout the project limits. The project proposes to widen the existing lanes to 12 feet, widen the

existing shoulders in both directions to 4 feet, install a Midwest Guardrail System (MGS), improve the superelevation (rate, transition, and runoff), and remove trees. Work will also involve installing two new culverts, replacing four existing culverts, removing one culvert, extending one box culvert, installing five new drainage inlets (DIs), replacing three DIs, and removing 2 slot drains. In addition, Rock Slope Protection (RSP) will be placed at six outlet locations.

The construction of the new shoulders will involve the excavation of existing material and the placement of a new structural section. The structural section will consist of 1.30 feet of class 2 aggregate base, 0.40 foot of hot mix asphalt (type A), and 0.08 foot of bonded wearing course (BWC-G). The BWC-G layer will help seal longitudinal pavement joints and provide a good surface for receiving new striping. A layer of geosynthetic pavement interlayer (GPI) will be used at the pavement joint where the new structural section meets the existing pavement.

The new MGS installed from PM 42.11 to PM 42.30 will include both standard sections and 7-foot post segments in narrow roadway locations. Also, a new Omit One Post (MGS) will be installed from PM 41.78 to PM 41.80 to span the inlet and outlet of the 6-foot box culvert on both sides of SR 1. The MGS to be installed within the project limit will be treated with a light-brown stain to reduce glare and to blend the MGS into the visual character of the natural landscape.

Erosion has been occurring below the culvert outlet at PM 42.11. To prevent further erosion at this location, which could compromise the highway; the existing downdrain, which is failing, will be removed and replaced with a new downdrain and RSP. The existing culvert at this location, which is also failing, will be replaced.

The existing cut bank on the east side of SR 1 will be laid back to provide adequate space for the proposed widening. Final cut slopes will not be steeper than 1.1:1 and final fill slopes will not be steeper than 1.4:1. Cut slope heights will be a maximum of 52 feet and fill slope heights will be a maximum of 16 feet. Of the approximately 14,075 cubic yards of material removed from the cut banks, up to 3858 cubic yards would be used to provide fill for the structural section and shoulder extension on the west side of the road. Approximately 10,217 cubic yards of excess material would be hauled off site to an approved disposal site under the responsibility of the contractor. Below many of the existing cut slopes, an inboard ditch carries storm water between culvert inlets. An additional 2 feet of widening beyond the shoulder is included to provide space for this water. Temporary BMPs include silt fence, fiber rolls, temporary high-visibility fence (THVF), street sweeping, stabilized construction entrance and exits, temporary gravel bag berms, and concrete washouts. A complete Stormwater Pollution Prevention Plan (SWPPP) shall be prepared by the Contractor and shall be submitted to the Caltrans Resident Engineer (RE) for approval. The Disturbed Soil Area (DSA) for this project is estimated at 4.73 acres. The existing impervious area within the project construction limits is 1.68 acres, which consists of the existing paved roadway. After construction of the widened roadway surfaces, the post-project impervious area is proposed to be 2.16 acres. Net new impervious (NNI) area was calculated by taking the difference between

the post-project impervious area and the existing impervious area, which was calculated to be 0.48 acres. Replaced impervious surface (RIS) was calculated using MicroStation and typical-cross sections. These were used to find the difference between where existing roadway and proposed sections overlapped, and where these areas resulted in disturbance of subgrade. RIS was calculated to be 0.29 acres. New impervious surface (NIS) was calculated by taking the sum of the NNI and RIS and subtracting the excluded impervious area. The NIS was calculated to be 0.77 acres, which is less than the 1 acre increase that would require permanent BMP installation. New slopes will be stabilized and vegetated in accordance with plans approved by the District Landscape Architect. Final soil stabilization strategies include the use of 3 different types of erosion control, which consist of a combination of: compost, duff, hydraulic biotic growth medium, and a fiber reinforced matrix. Additional slope stabilization methods to be used include Rolled Erosion Control Product (RECP) netting, compost socks, duff berms, and fiber rolls. Existing vegetation will be preserved to the maximum extent practicable and in accordance with existing environmental permits and agreements. Environmentally Sensitive Areas (ESA) are delineated on the project plans with THVF. THVF fencing will be included in the contract plans to indicate areas that are off-limits to the contractor. Biofiltration strips have been proposed for treatment of the runoff on this project. The strips are proposed to be located adjacent to the roadway in order to flow through and treat as much runoff as possible before entering a water body.

61 trees in the clear recovery zone west of the highway and 5 trees on the east side will be removed.

The anticipated traffic control measures are reversing traffic control, moving lane closure, and shoulder closure. One-lane closure is permitted within the project limits. A minimum of 12 feet of paved roadway must be open for use by public traffic. Bicyclists will be accommodated through the work zone. Signage will be used to alert vehicle operators to the possible presence of bicyclists. The estimated maximum delay during one-way reversing traffic control will be 10 minutes. Access to side roads and residences will be maintained at all times.

#### INDEX OF PLANS

XX - XX

XX - XX

XX - XX

# STATE OF CALIFORNIA DEPARTMENT OF TRANSPORTATION

SHEET No.	DESCRIPTION
1	TITLE
X-X	TYPICAL CROSS SECTIONS
XX-XX	LAYOUTS
$\times \times - \times \times$	PROFILES AND SUPERELEVATION DIAGRAMS
XX-XX	CONSTRUCTION DETAILS
XX-XX	DRAINAGE PLANS, PROFILES, DETAILS AND QUANTITIES
$\times \times - \times \times$	UTILITY PLANS
XX	CONSTRUCTION AREA SIGNS
$\times \times - \times \times$	MOTORIST INFORMATION PLANS
XX-XX	STAGE CONSTRUCTION PLANS
$\times \times - \times \times$	TRAFFIC HANDLING PLANS AND QUANTITIES
XX-XX	PAVEMENT DELINEATION PLANS, DETAILS AND QUANTITIES

SIGN PLANS, DETAILS AND QUANTITIES

THE STANDARD PLANS LIST APPLICABLE TO THIS CONTRACT IS

INCLUDED IN THE NOTICE TO BIDDERS AND SPECIAL PROVISIONS BOOK.

SUMMARY OF QUANTITIES


VENDOR DRAWINGS


REVISED STANDARD PLANS

OJECT PLANS FOR CONSTRUCTION ON STATE HIGHWAY

IN MENDOCINO COUNTY NEAR ALBION FROM 1.5 MILES NORTH OF THE JUNCTION OF ROUTE 128 0.1 MILE SOUTH OF NAVARRO RIDGE ROAD

TO BE SUPPLEMENTED BY STANDARD PLANS DATED 2018

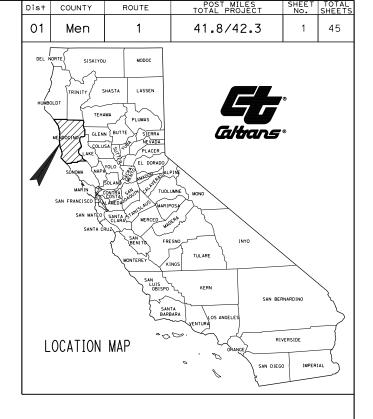

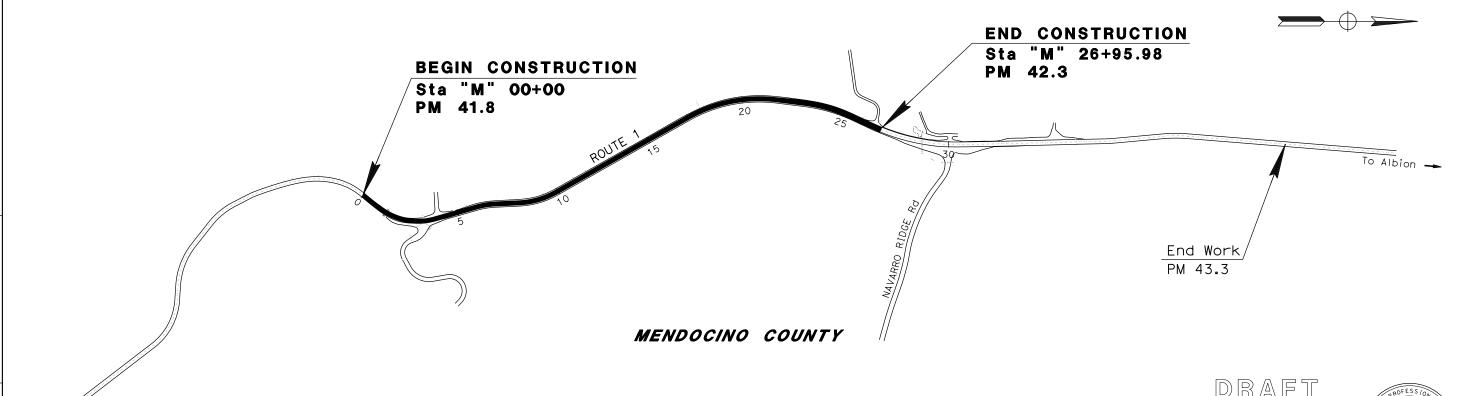

THE CONTRACTOR SHALL POSSESS THE CLASS (OR CLASSES) OF LICENSE AS SPECIFIED IN THE "NOTICE TO BIDDERS."

CONTRACT No. 01-0C5504 PROJECT ID 0112000300

THE STATE OF CALIFORNIA OR ITS
OFFICERS OR AGENTS SHALL NOT BE
RESPONSIBLE FOR THE ACCURACY OR
COMPLETENESS OF SCANNED COPIES OF THIS PLAN SHEET.

NO SCALE

JON MCKEAN

C 61308

BORDER LAST REVISED 8/1/2016 | CALTRANS WEB SITE IS: HTTP//WWW.DOT.CA.GOV/

Begin Work

PM 40.8

RELATIVE BORDER SCALE
IS IN INCHES


USERNAME => s148600 DGN FILE => 0112000300ab001.dgn


PROJECT ENGINEER


PLANS APPROVAL DATE


REGISTERED CIVIL ENGINEER

PRELIMINARY

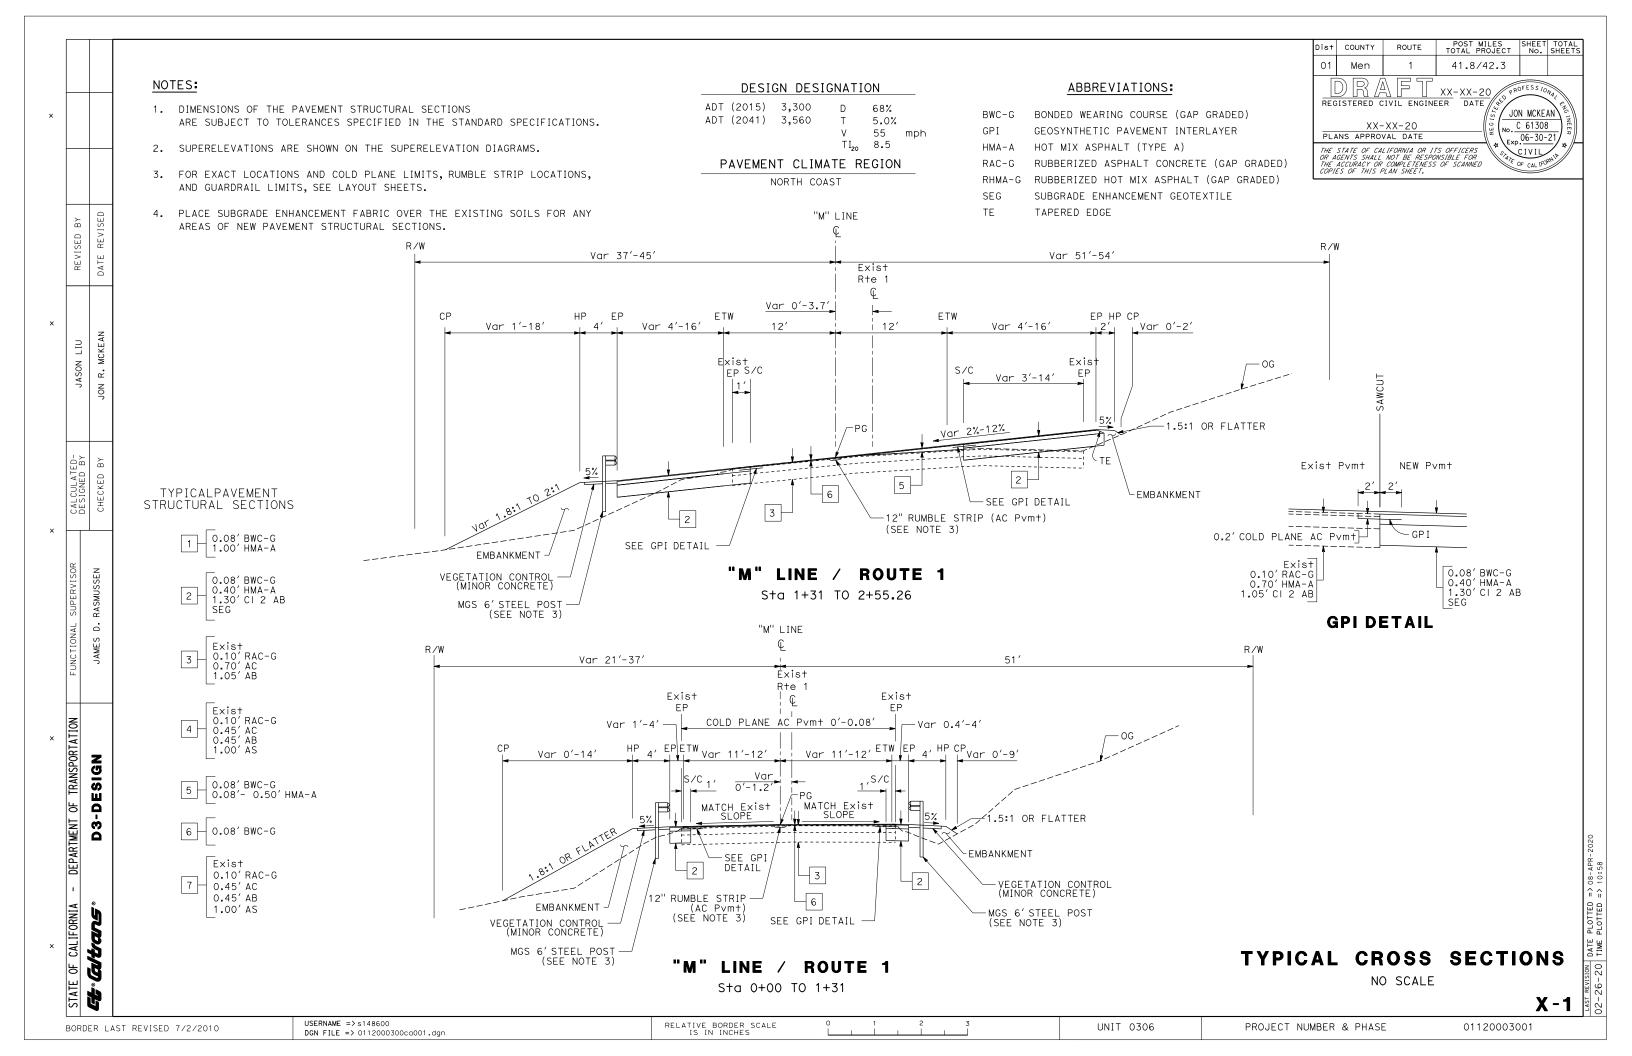

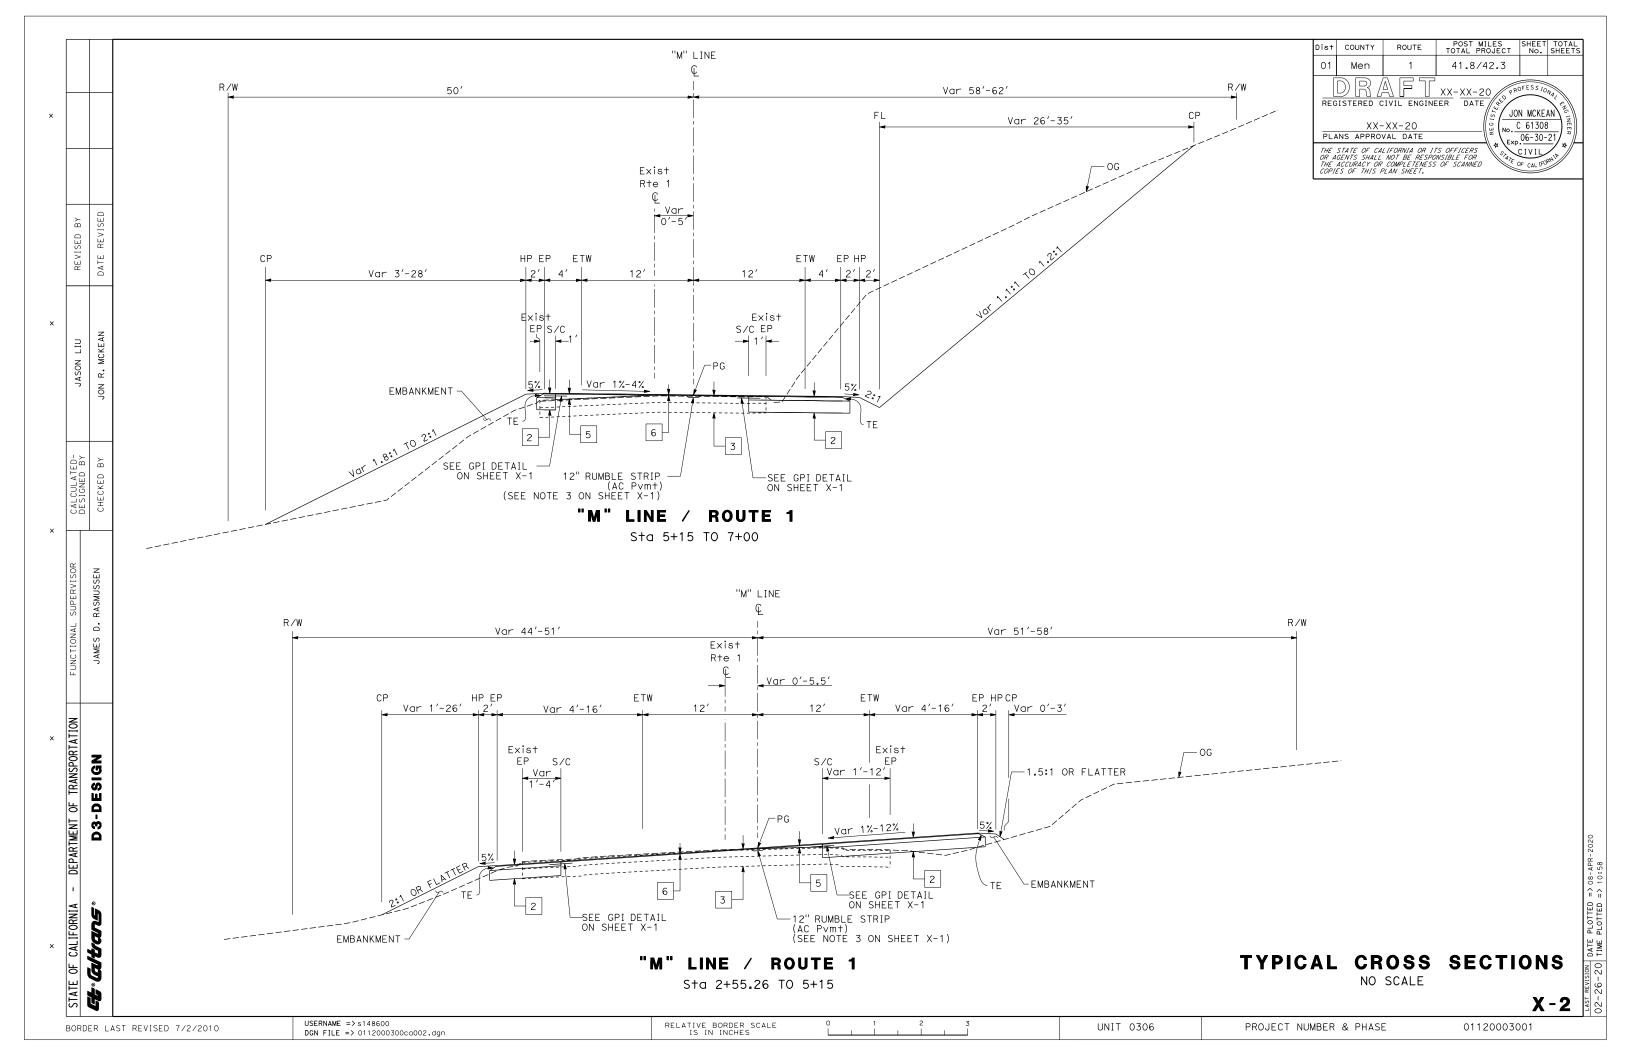

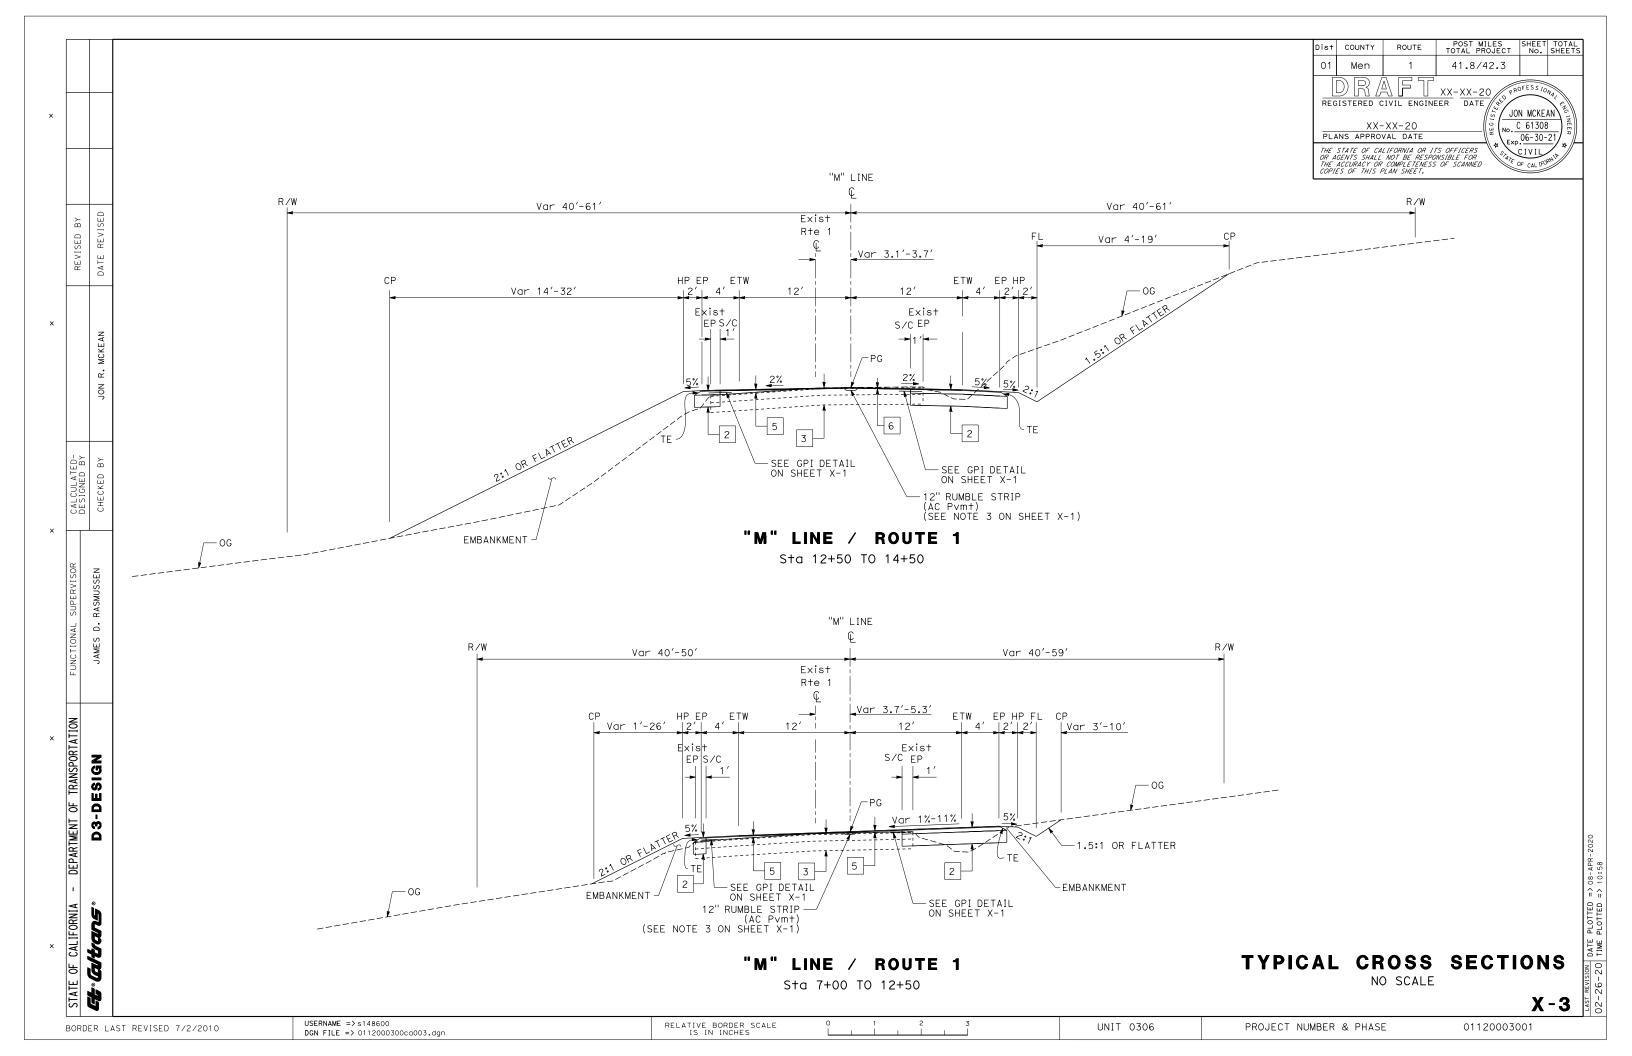

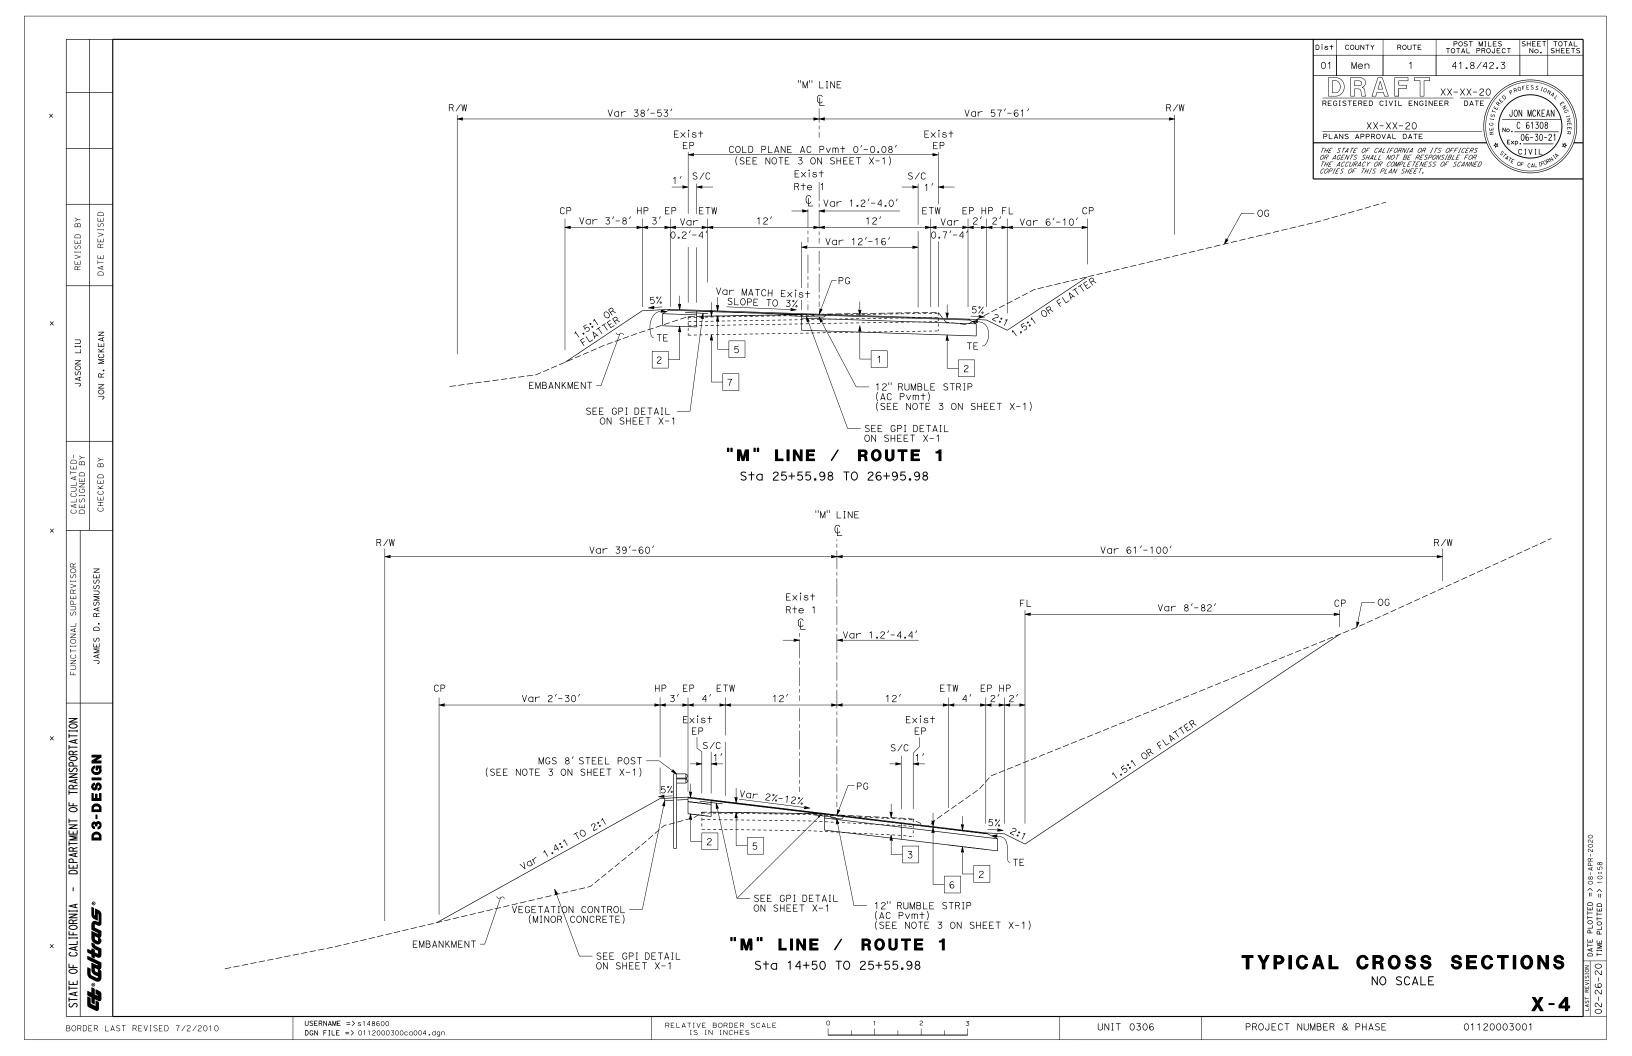

×	NOTES:  1. FOR COMPLETE PROJECT CONTROL DATA, SEE THE SURVEY RECORDS ON FILE IN THE SURVEYS DEPARTMENT AT THE DISTRICT OFFICE.  2. BASIS OF BEARINGS AND COORDINATES:	ABBREVIATIONS:  ALCAR - REBAR WITH ALUMINUM CAP  LEGEND:  DIST COUNTY ROUTE POST MILES SHEET TOTAL PROJECT No. SHEETS  O1 Men 1 41.8/42.3   DATE  PROFESSIONAL LAND SURVEYOR  DATE  LAND  PLANS APPROVAL DATE  THE STATE OF CALIFORNIA OR 1TS OFFICERS OR AGENTS SHALL NOT BE RESPONSIBLE FOR THE ACCURACY OR COMPLETENESS OF SCANNED  STATE OF CALIFORNIA OR 1TS OFFICERS OR AGENTS SHALL NOT BE RESPONSIBLE FOR THE ACCURACY OR COMPLETENESS OF SCANNED
REVISED BY DATE REVISED	THE BASIS OF BEARINGS FOR THIS SURVEY IS THE CALIFORNIA COORDINATE SYSTEM (CCS), ZONE 2, NAD 83 (1998) EPOCH 2004.69 AS DETERMINED LOCALLY BY A LINE BETWEEN STATION 4234 AND STATION 4182, BEING S 6°38′18″E, 2534.90 ft FROM GEODETIC SURVEY.  COORDINATES ARE SHOWN IN THE U.S. SURVEY FOOT ( 1200/3937 METER )	LEGEND:  2CM STATION  2CM STATION
	3. BASIS OF ELEVATIONS:  THIS PROJECT IS BASED ON THE NORTH AMERICAN VERTICAL DATUM OF 1988 (NAVD 88).  STATIONS AND RESPECTIVE ELEVATIONS CONSTRAINED TO ARE:	STATION OPDER MODITION STATION OPDER MODITION STATION OPDER MODITION OPPER MODITI
×	4196 ELEVATION = 218.25	DESIGNATION DESIGNATION         ORDER         NORTHING         EASTING         ELEVATION         DESCRIPTION           4234         THIRD         2205616.66         6060683.35         41.96         ALCAR STAMPED "1 42.34 2011"           4196         THIRD         2203780.39         6060892.86         218.25         ALCAR STAMPED "41.96 2016"           4182         THIRD         2330066.69         6159732.00         226.38         ALCAR STAMPED "41.82 2016"
FUNCTIONAL SUPERVISOR CALCULATED-DESIGNED BY CHECKED BY	BEGIN CONSTRUCTION Sta "M" 00+00 PM 41.8	END CONSTRUCTION Sta "M" 26+95.98 PM 42.3  End Work PM 43.3
× CALIFORNIA - DEPARTMENT OF TRANSPORTATION  ***********************************	MENDOCINO  Begin Work PM 40.8	
STATE OF CALIFORNI		PROJECT CONTROL  NO SCALE PC-1

RELATIVE BORDER SCALE IS IN INCHES


UNIT 0000


PROJECT NUMBER & PHASE

01120003001

USERNAME => s148600 DGN FILE => 0112000300dc001.dgn

BORDER LAST REVISED 7/2/2010

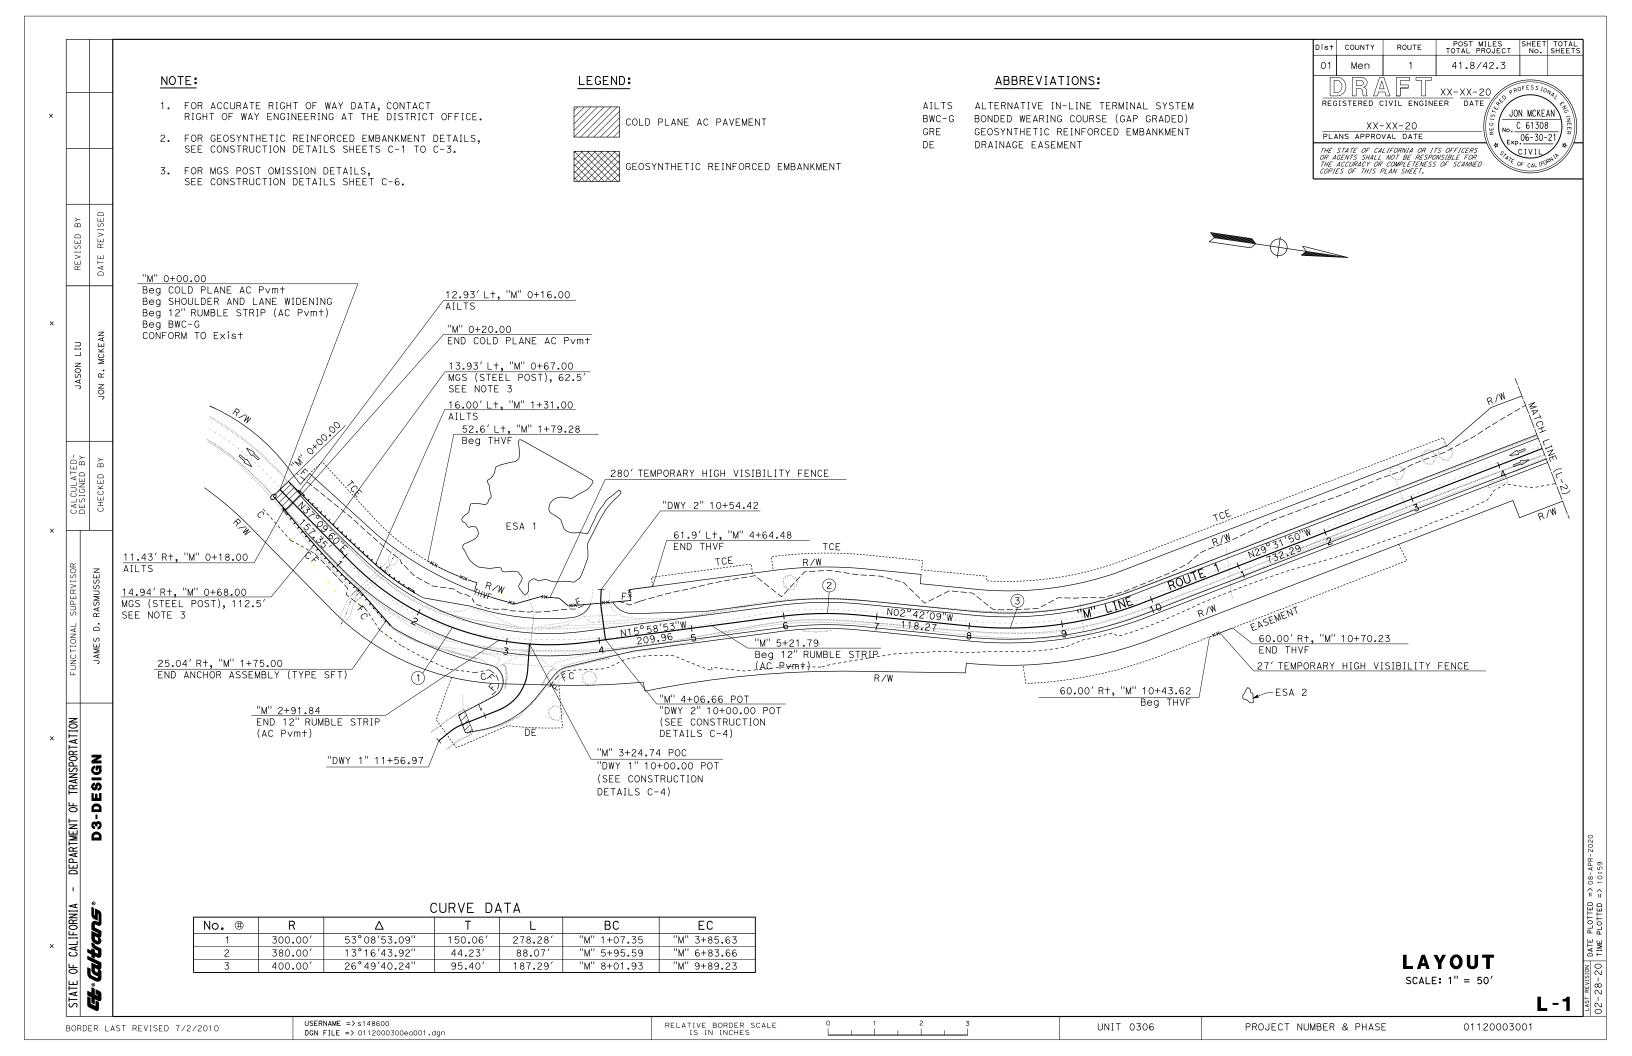

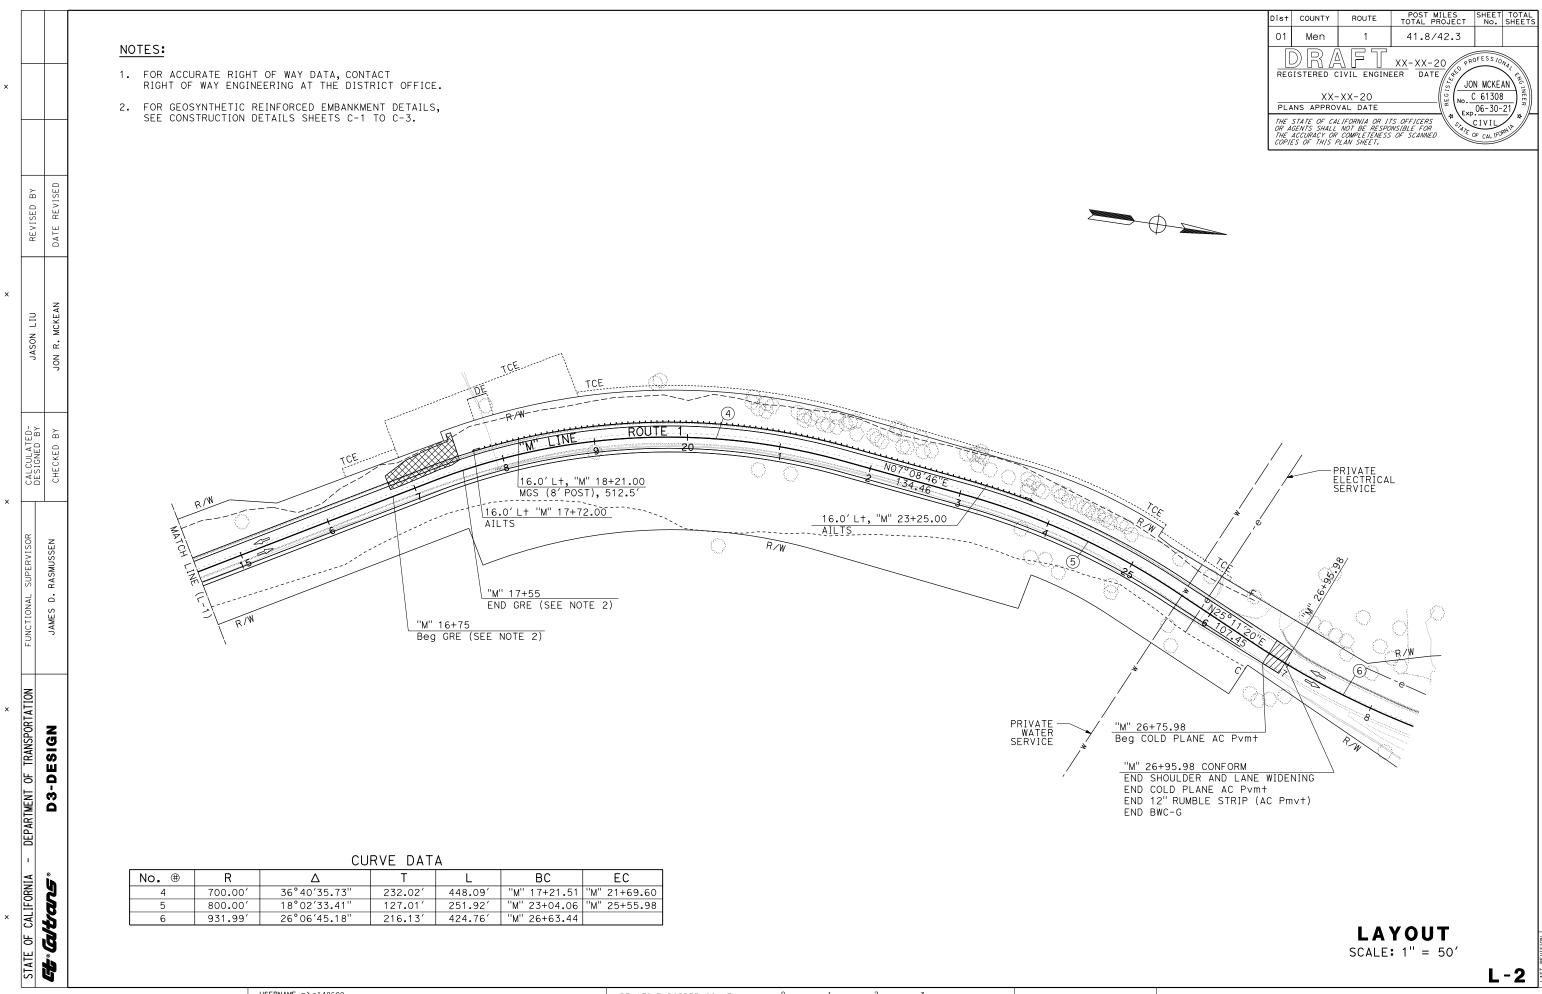


BORDER LAST REVISED 7/2/2010


USERNAME => \$148600
DON FILE => 0112000300ed002.dgn


RELATIVE BORDER SCALE 0 1 2 3
IS IN INCHES


UNIT 0306

PROJECT NUMBER & PHASE 01120003001

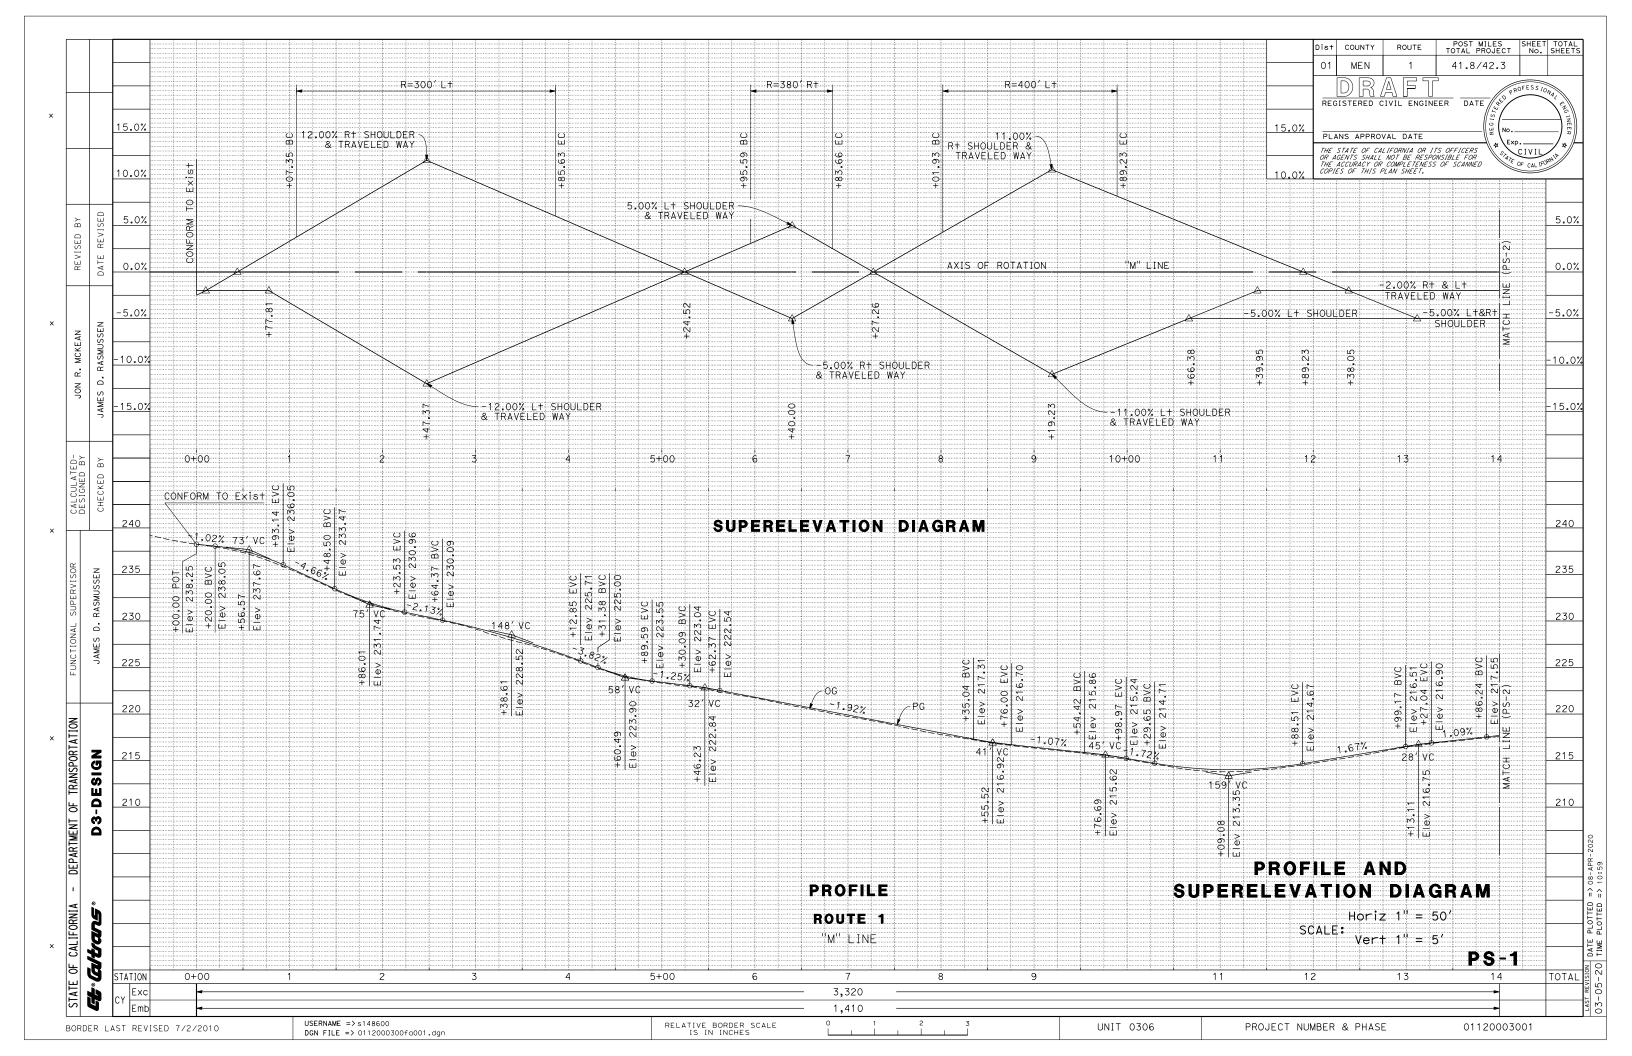

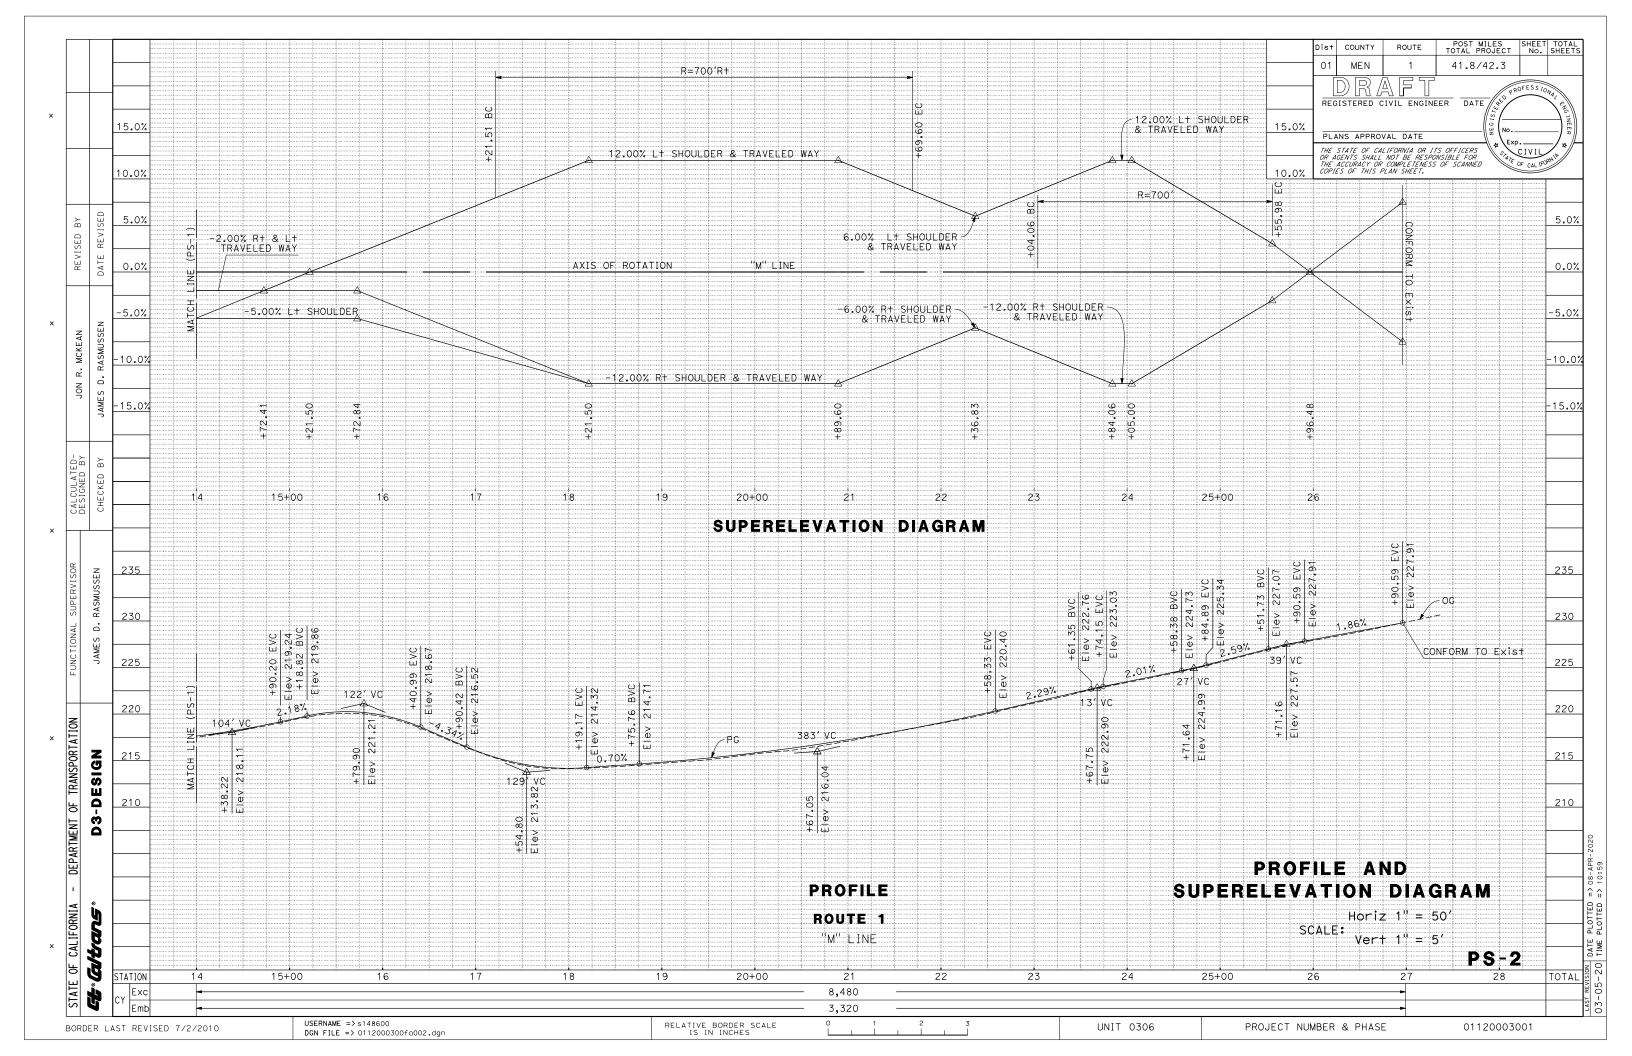

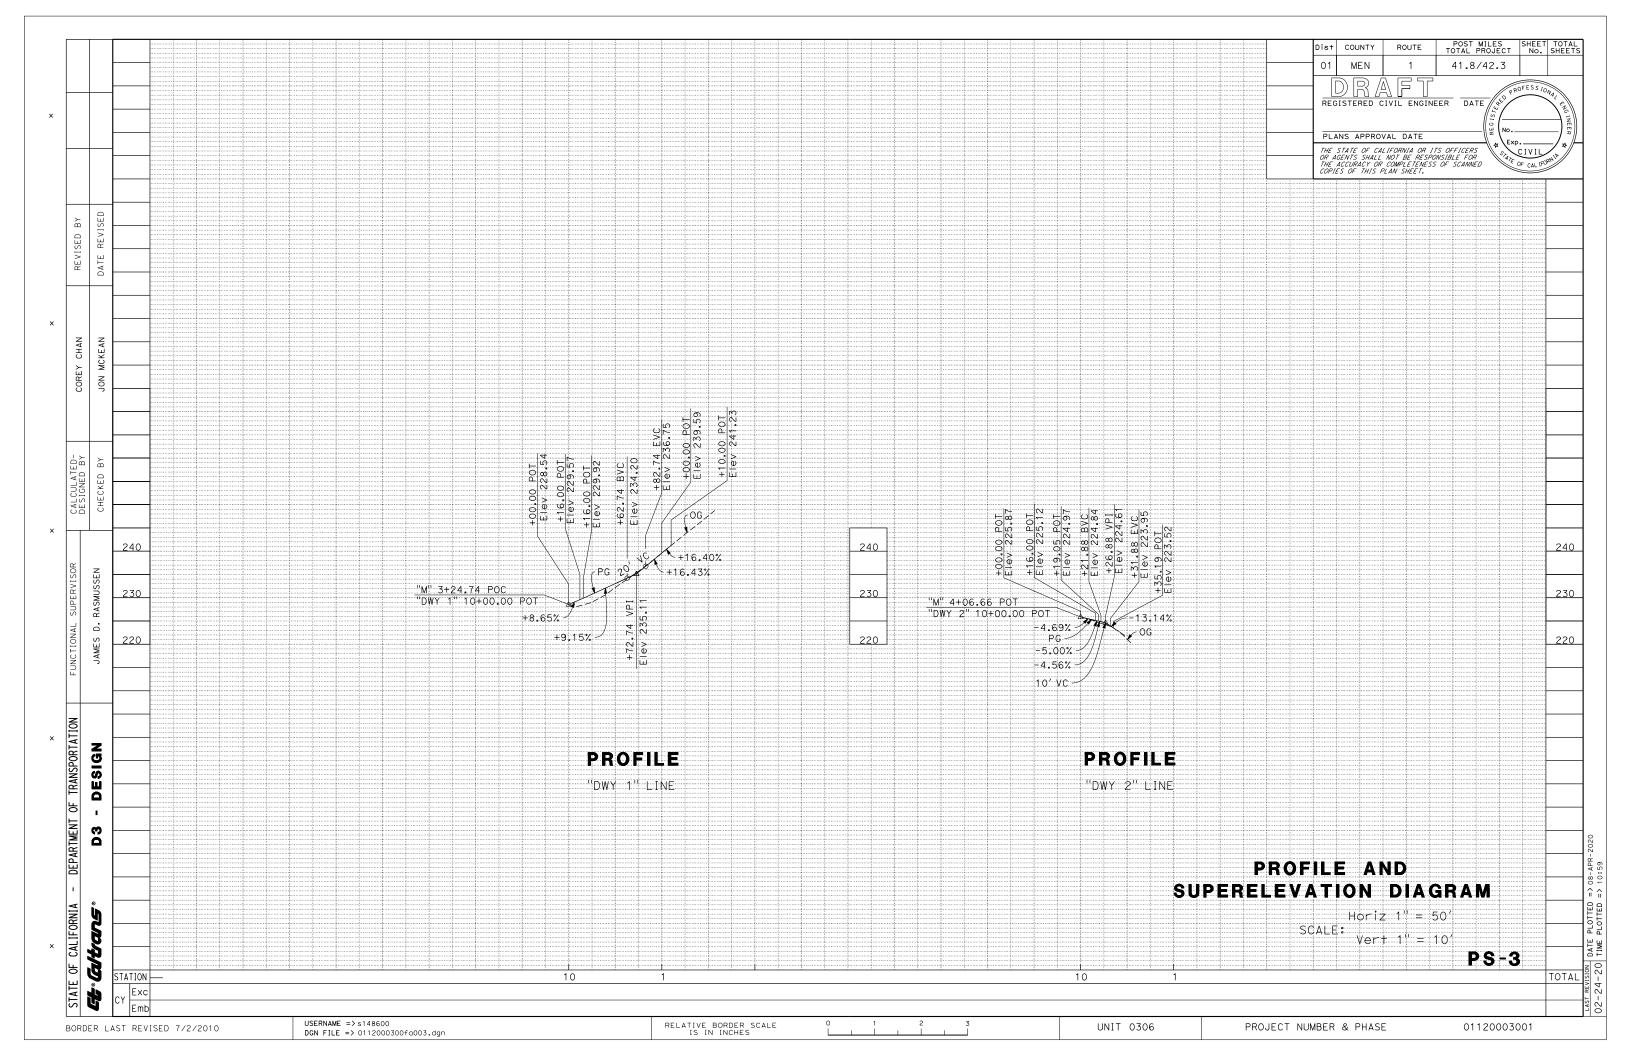

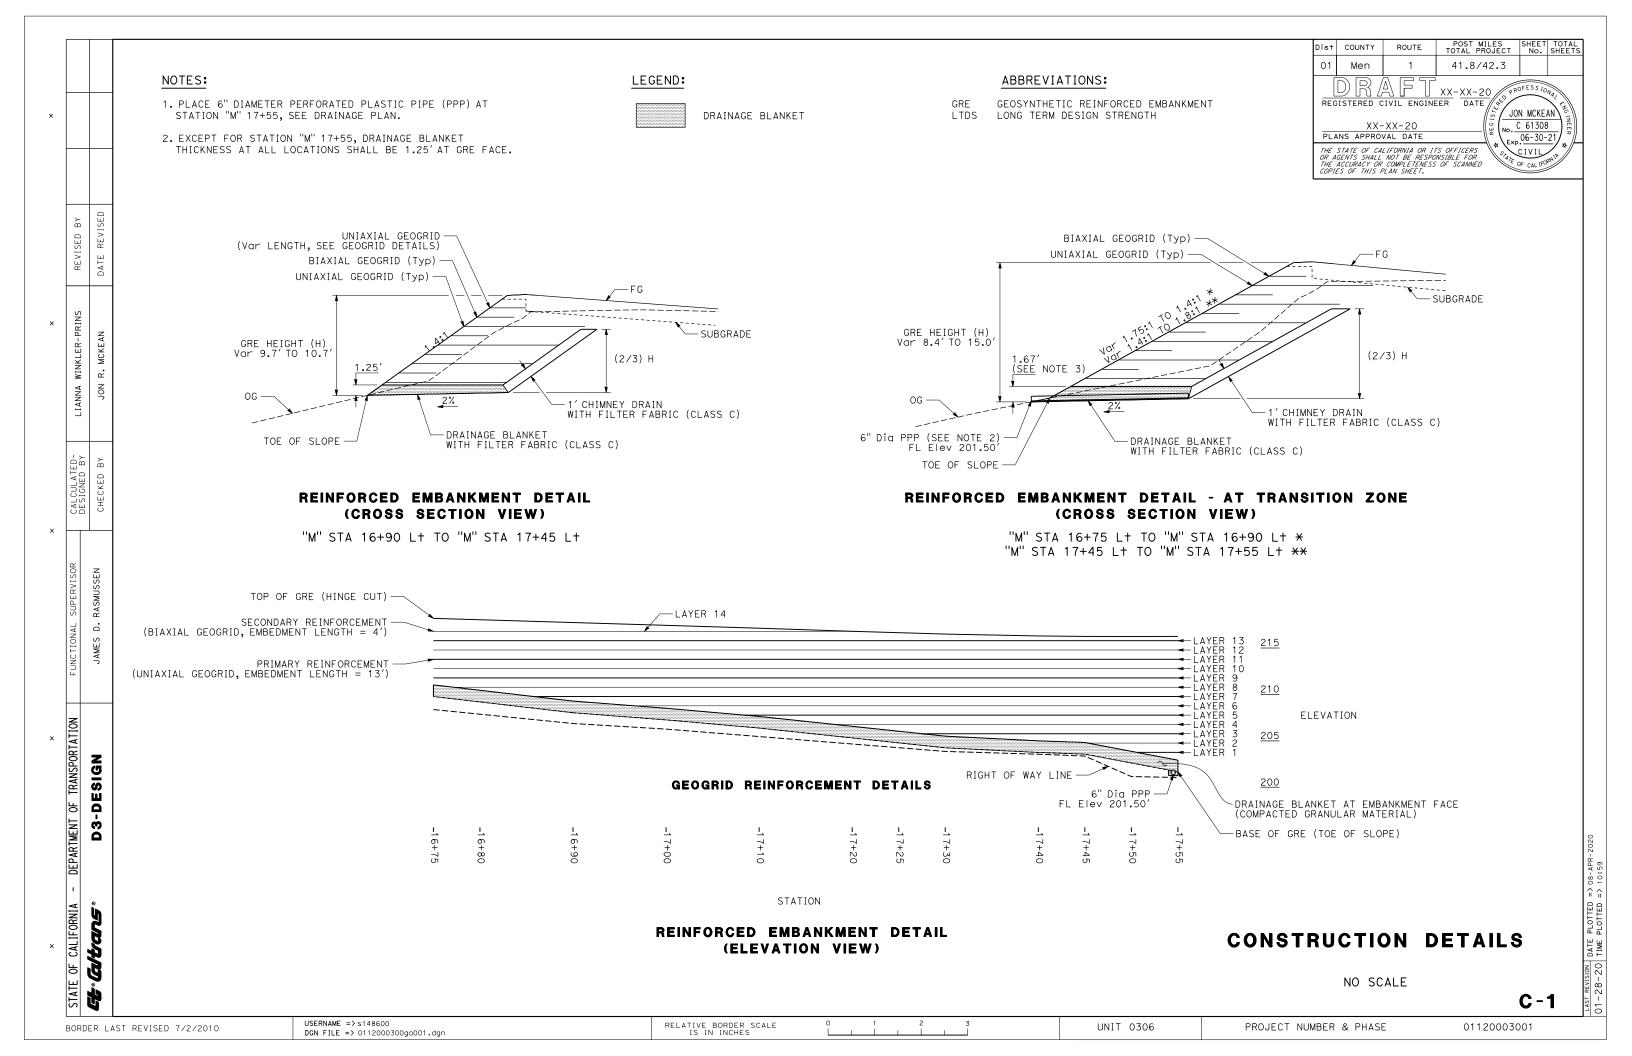

×	×		×	×		×
TATE OF CALIFORNIA -	- DEPARTMENT OF TRANSPORTATION	FUNCTIONAL SUPERVISOR	CALCULATED-	I TANNA WINKI FR-PRINS	REVISED BY	
			DESIGNED BY			
ं <b>र</b> ंपिरकाड <sup>ः</sup>	D3-DESIGN	JAMES D. RASMUSSEN	CHECKED BY	JON R. MCKEAN	DATE REVISED	
					-	

GEOGRID DETAILS
-----------------

STATION	LAYER No.	ELEVATION FROM TOE (FT)	REINFORCEMENT LENGTH (FT)	REINFORCEMENT TYPE
	9	2.0	13	А
	10	3.0	4	В
"M" 16+75	11	4.0	13	А
C1+01 M	12	5.0	4	В
	13	6.0	13	А
	14	7.0	4	В
	8	1.6	4	В
	9	2.6	13	Α
"M" 16+80	10	3.6	4	В
	11	4.6	13	А
	12	5.6	4	В
	13	6.6	13	А
	14	7.6	4	В
	7	1.7	13	А
	8	2.7	4	В
	9	3.7	13	А
"M" 16+90	10	4.7	4	В
W 18+90	11	5.7	13	А
	12	6.7	4	В
	13	7.7	9	А
	14	8.7	3	В
	6	1.5	4	В
	7	2.5	13	А
	8	3.5	4	В
	9	4.5	13	А
"M" 17+00	10	5.5	4	В
	11	6.5	13	А
	12	7.5	4	В
	13	8.5	4	А
	14	9.5	3	В

## GEOGRID TYPE AND STRENGTH

F	REINFORCEMENT TYPE	LTDS (LB/FT)
А	UNIAXIAL GEOGRID	1,300
В	BIAXIAL GEOGRID	

Dist	COUNTY	ROUTE	POST MILES TOTAL PROJECT	SHEET No.	TOTAL SHEETS
01	Men	1	41.8/42.3		
PL#	XX- ANS APPROV	LIFORNIA OR II	DATE SEER DATE SEER SEER SEER SEER SEER SEER SEER SE	N MCKEA C 61308 06-30-	AN CAO, INEER
THE		NOT BE RESPO COMPLETENESS PLAN SHEET.	OF SCANNED	OF CAL IFO	mit /

# GEOGRID DETAILS

STATION	LAYER No.	ELEVATION FROM TOE (FT)	REINFORCEMENT LENGTH (FT)	REINFORCEMENT TYPE
	5	1.4	13	А
	6	2.4	4	В
	7	3.4	13	А
	8	4.4	4	В
"M" 17+10	9	5.4	13	А
	10	6.4	4	В
	11	7.4	13	А
	12	8.4	4	В
	13	9.4	4	А
	4	1.5	4	В
	5	2.5	13	А
	6	3.5	4	В
	7	4.5	13	А
"M" 17+20	8	5.5	4	В
M 17+20	9	6.5	13	А
	10	7.5	4	В
	11	8.5	13	А
	12	9.5	4	В
	13	10.5	3	А

# **CONSTRUCTION DETAILS**

GEOGRID REINFORCEMENT DETAILS

NO SCALE

**C-2** 

USERNAME => s148600 DGN FILE => 0112000300ga002.dgn RELATIVE BORDER SCALE IS IN INCHES UNIT 0306 PROJECT NUMBER & PHASE 01120003001 BORDER LAST REVISED 7/2/2010

×	×	^	×	×		×	
CALIFORNIA -	DEPARTMENT OF TRANSPORTATION	FUNCTIONAL SUPERVISOR	CALCULATED-	NINA WINK -	REVISED BY		
			DESIGNED BY				
برماك	D3-DESIGN	JAMES D. RASMUSSEN	CHECKED BY	JON R. MCKEAN	DATE REVISED		
					-	-	

Dist	COUNTY	ROUTE	POST M: TOTAL PR		SHEET No.	TOTAL SHEETS	
01	Men	1	41.8/4	12.3			
		XX-20 VAL DATE	XX-XX-2 EER DATE	REG 1876 100 100 100 100 100 100 100 100 100 10	N MCKE/ C 61308 06-30-	ENG INEER	
THE STATE OF CALIFORNIA OR ITS OFFICERS OR AGENTS SHALL NOT BE RESPONSIBLE FOR THE ACCURACY OR COMPLETENESS OF SCANNED COPIES OF THIS FILM SHEET.							

## GEOGRID DETAILS

STATION	LAYER No.	ELEVATION FROM TOE (FT)	REINFORCEMENT LENGTH (FT)	REINFORCEMENT TYPE
	3	1.5	13	А
	4	2.5	4	В
	5	3.5	13	А
	6	4.5	4	В
	7	5.5	13	А
"M" 17+30	8	6.5	4	В
	9	7.5	13	А
	10	8.5	4	В
	11	9.5	13	А
"M" 17+40	12	10.5	4	В
	13	11.5	3	А
	3	2.0	13	А
	4	3.0	4	В
	5	4.0	13	А
	6	5.0	4	В
	7	6.0	13	А
	8	7.0	4	В
	9	8.0	13	А
	10	9.0	4	В
	11	10.0	13	А
	12	11.0	4	В
	3	2.2	13	А
	4	3.2	4	В
	5	4.2	13	А
	6	5.2	4	В
"M" 17+45	7	6.2	13	А
W 17+45	8	7.2	4	В
	9	8.2	13	А
	10	9.2	4	В
	11	10.2	13	А
	12	11.2	4	В

# GEOGRID DETAILS

STATION	LAYER No.	ELEVATION FROM TOE (FT)	REINFORCEMENT LENGTH (FT)	REINFORCEMENT TYPE
	2	2.1	4	В
	3	3.1	13	А
	4	4.1	4	В
	5	5.1	13	А
"M" 17+50	6	6.1	4	В
M 17+50	7	7.1	13	А
	8	8.1	4	В
	9	9.1	4	А
	10	10.1	4	В
	11	11.1	13	А
	12	12.1	4	В
	1	2.5	13	А
	2	3.5	4	В
	3	4.5	13	А
	4	5.5	4	В
	5	6.5	13	А
"N" 17155	6	7.5	4	В
"M" 17+55	7	8.5	13	А
	8	9.5	4	В
	9	10.5	13	А
	10	11.5	4	В
	11	12.5	13	А
	12	13.5	4	В


# CONSTRUCTION DETAILS


GEOGRID REINFORCEMENT DETAILS

NO SCALE


**C-3** 


USERNAME => s148600 DGN FILE => 0112000300ga003.dgn RELATIVE BORDER SCALE IS IN INCHES UNIT 0306 PROJECT NUMBER & PHASE 01120003001 BORDER LAST REVISED 7/2/2010

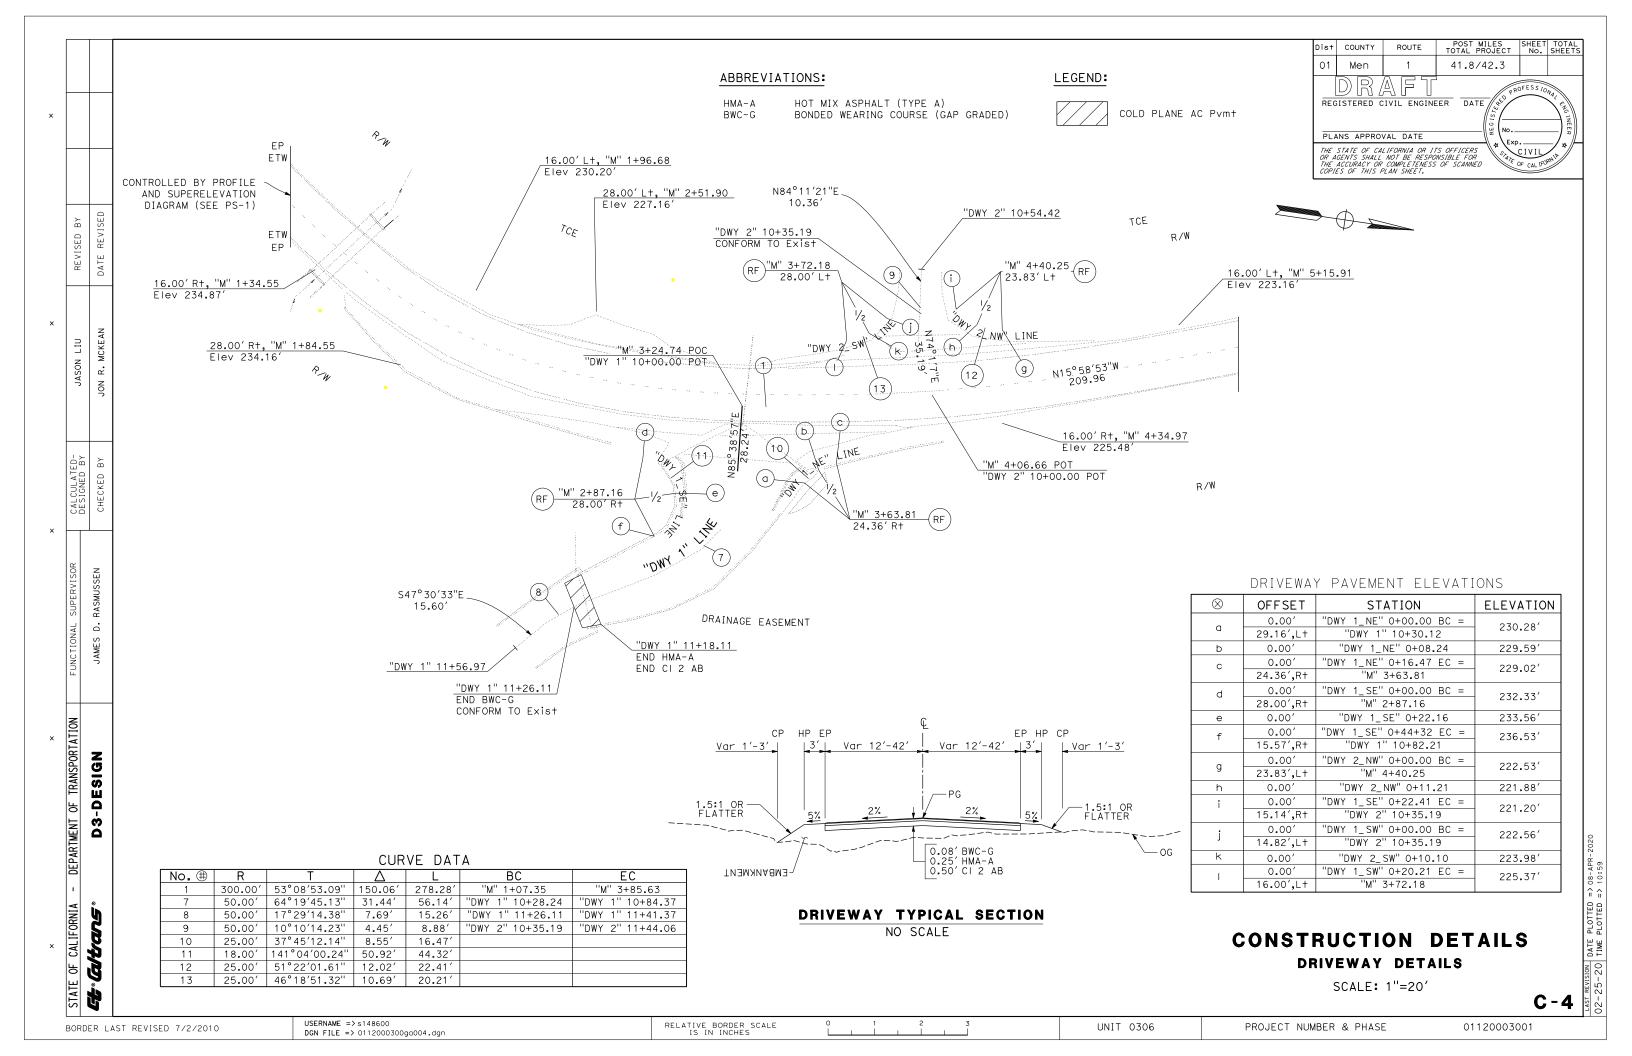

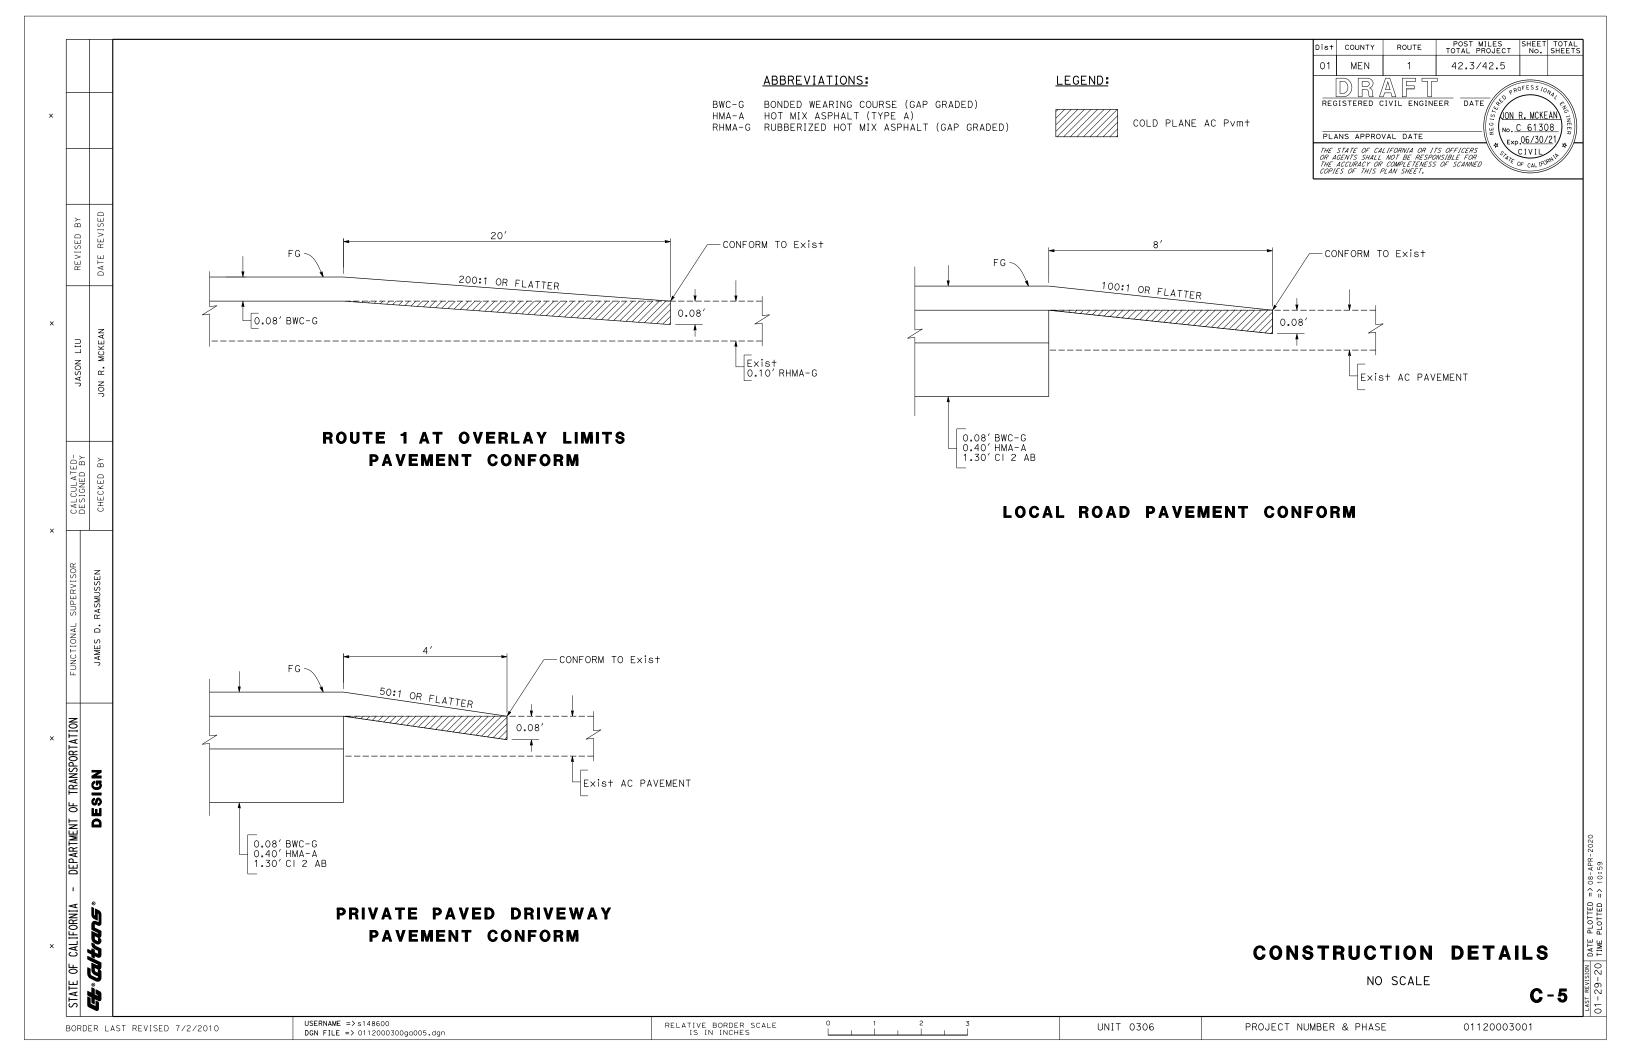

POST MILES SHEET TOTAL TOTAL PROJECT No. SHEETS Dist COUNTY ROUTE 01 41.8/42.3 Men REGISTERED CIVIL ENGINEER DATE PLANS APPROVAL DATE THE STATE OF CALIFORNIA OR ITS OFFICERS OR AGENTS SHALL NOT BE RESPONSIBLE FOR THE ACCURACY OR COMPLETENESS OF SCANNED COPIES OF THIS PLAN SHEET. CIVIL OF CAL IFOR

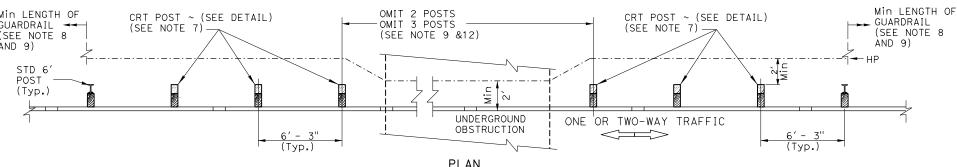

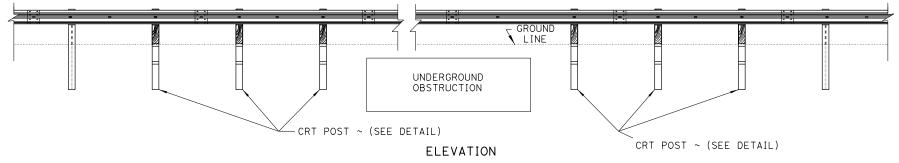

**CONSTRUCTION DETAILS** POST PLACEMENT OPTIONS

NO SCALE

**C-6** 

USERNAME => s148600 BORDER LAST REVISED 7/2/2010

DGN FILE => 0112000300ga006.dgn

UNIT 0000

PROJECT NUMBER & PHASE

0000000001

6"×8" - WOOD

POST

**CONTROLLED** 

RELEASE


**TERMINAL** 


(CRT)


POST DETAIL


(SEE NOTE 7)


RELATIVE BORDER SCALE IS IN INCHES

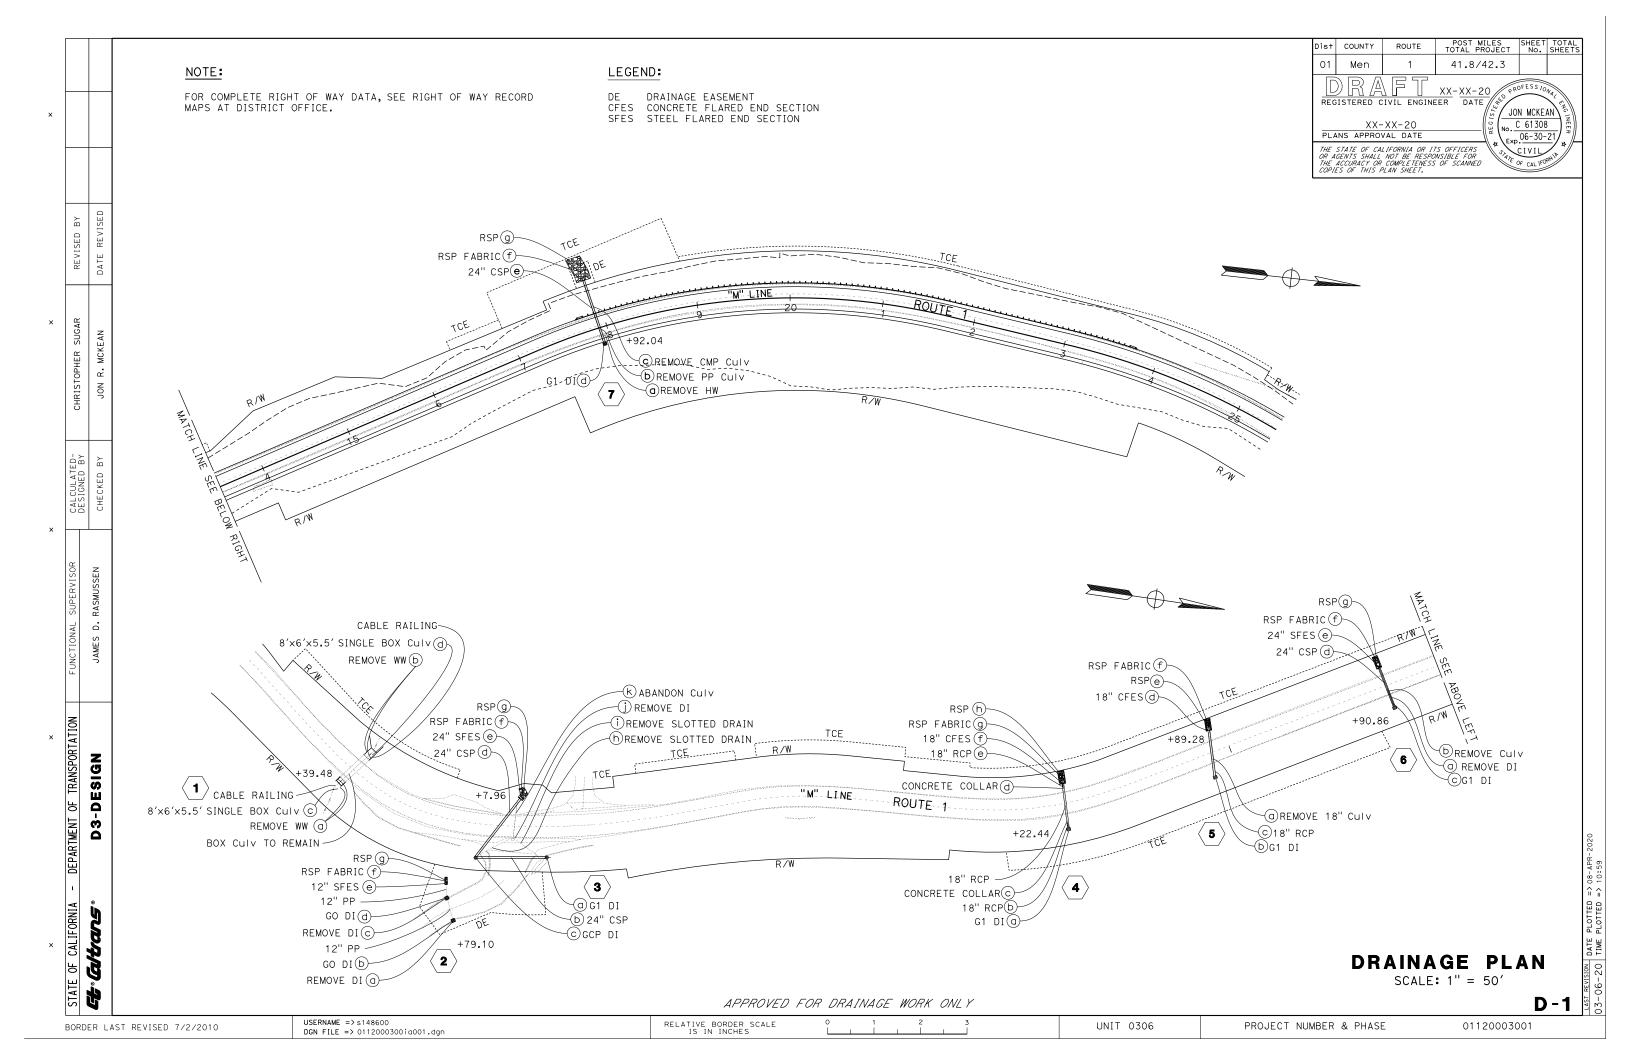

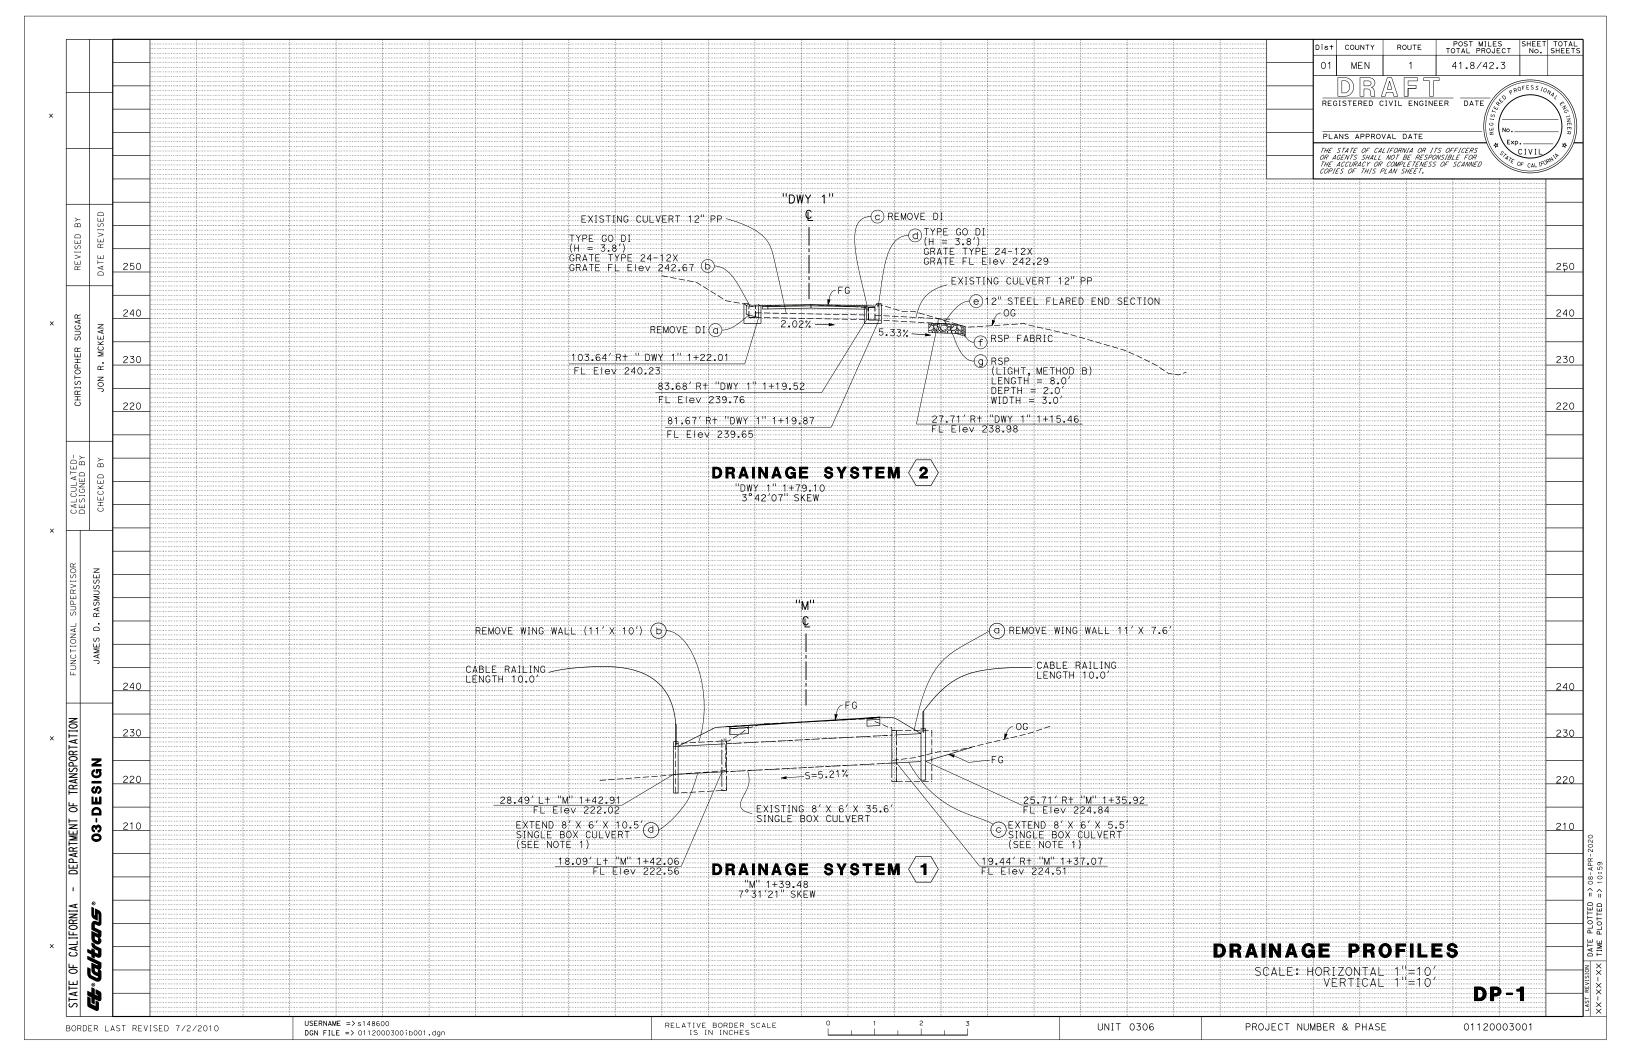

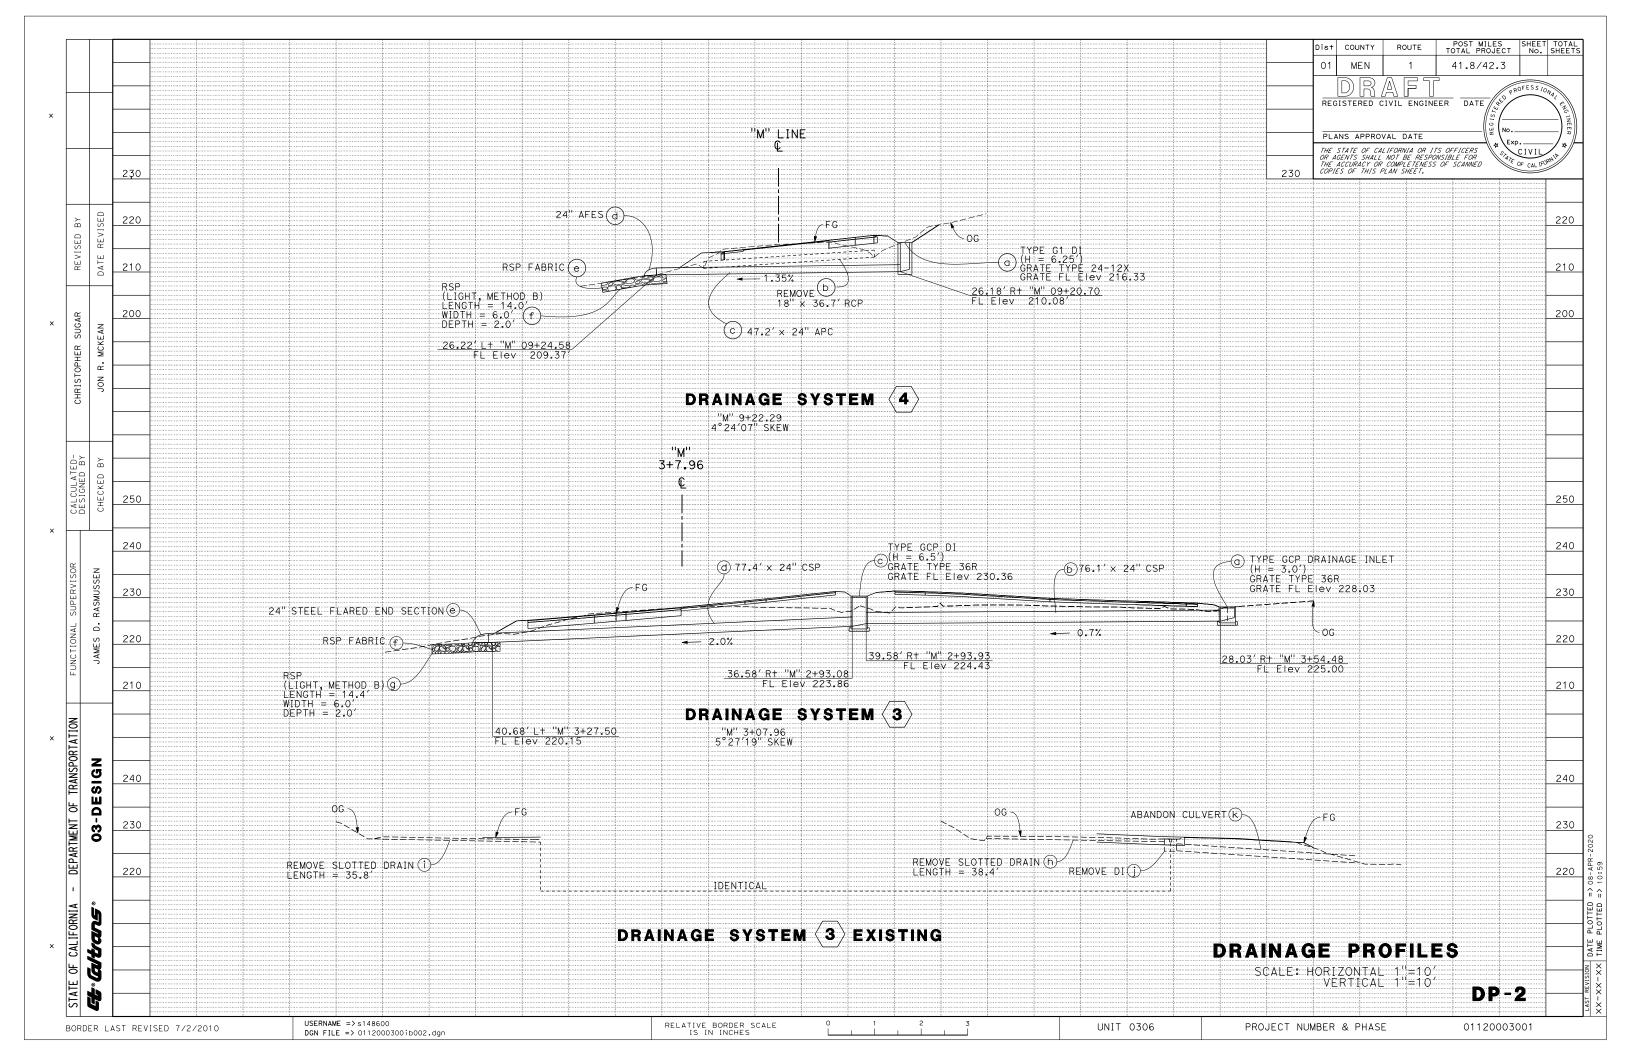

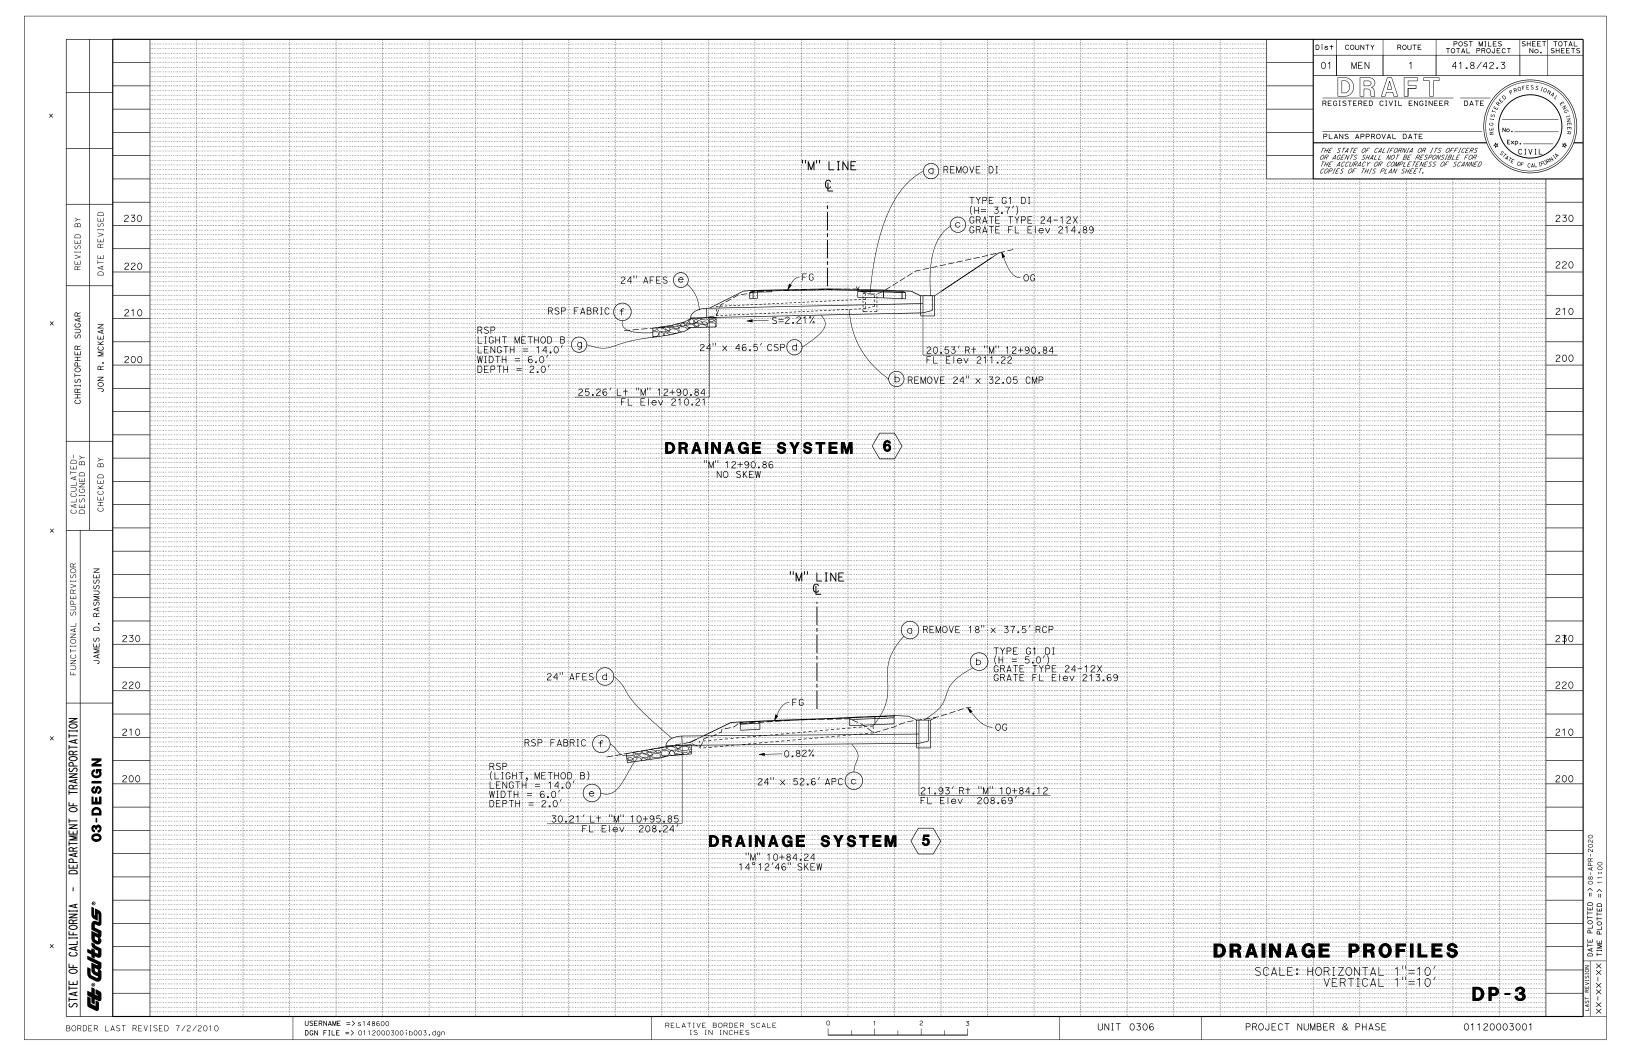

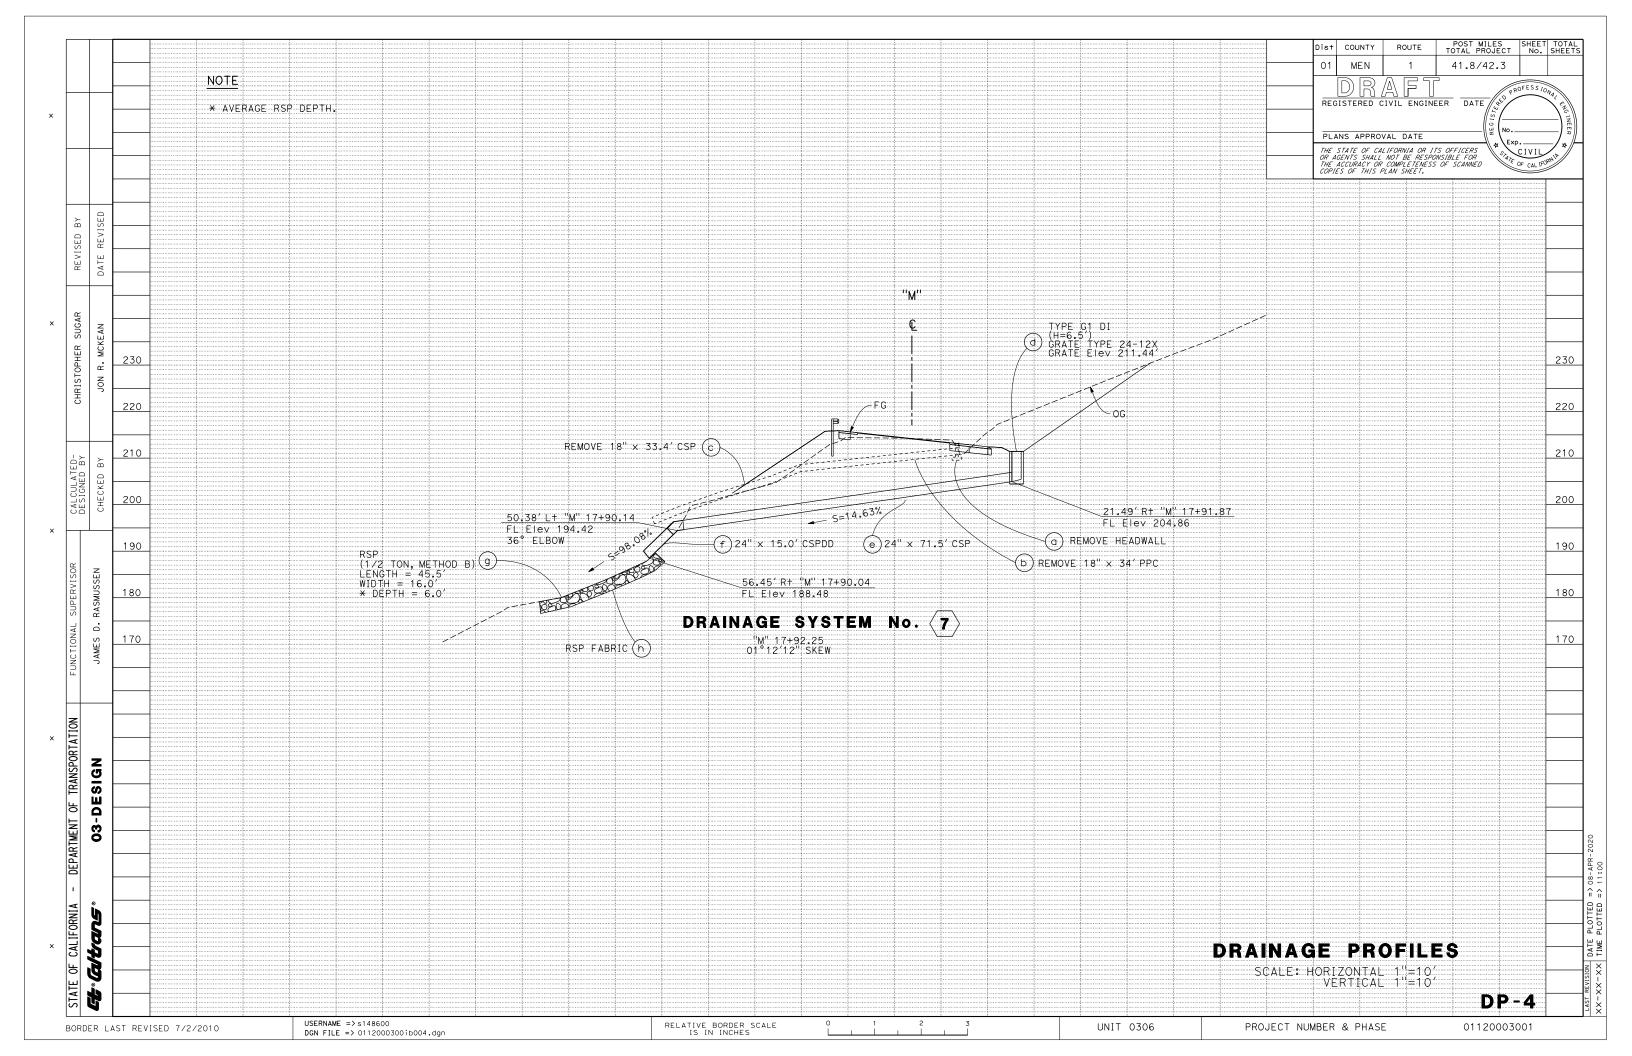

DIST COUNTY ROUTE POST MILES SHEET TOTAL PROJECT No. SHEETS


O3 Men 1 41.8/42.3

PLANS APPROVAL DATE

THE STATE OF CALIFORNIA OR ITS OFFICERS OR AGENTS SHALL NOT BE RESPONSIBLE FOR THE ACCURACY OR COMPLETENESS OF SCANNED COPIES OF THIS PLAN SHEET.

# ALTERNATIVE PIPE CULVERT (APC) AND FLARED END SECTION (AFES) ALLOWABLE PIPE MATERIAL AND PROTECTION


			TYPE	
w DRAINAGE SYSTEM No. ○	STATION	НОРЕ	CORRUGATED STEEL PIPE (0.109" THICK)	RCP
3	M 3+08	X	X	X
4	M 9+22	Х	Х	Х
5	M 10+84	Х	Х	Х
6	M 12+91	Х	Х	Х
7	M 17+92		Х	

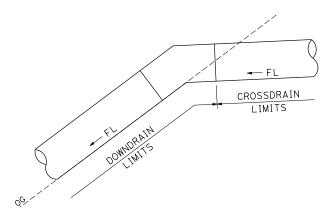

LIMITS OF MEASUREMENT FOR PAYMENT

#### MARKER (CULVERT)

DRAINAGE SYSTEM No.	PM	MARKER (CULVERT)
1	41.79	L+/R+
- '	41.19	LIZIVI
3	41.83	L+/R+
4	41.95	L+/R+
5	41.98	L+/R+
6	42.02	L+/R+
7	42.11	L+/R+

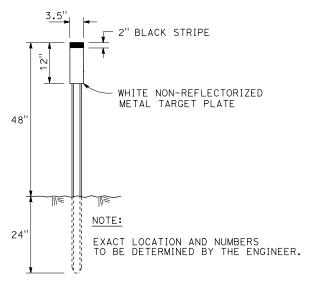

MARKER (CULVERT) DETAIL

# DRAINAGE DETAILS

**DD-1** 

003001

BORDER LAST REVISED 7/2/2010

CHRISTOPHER SUGAR

ο.

DEPARTMENT OF TRANSPORTATION

CALIFORNIA

능

Ge Caltans

03-DESIGN

USERNAME => s148600 DGN FILE => 0112000300ic001.dgn

RELATIVE BORDER SCALE
IS IN INCHES

1 2 3

UNIT 0306

PROJECT NUMBER & PHASE

<																DR	AINA	GE	QUA	NTIT	TIES						
				ET No.		0							CULVERT	SECTION	Q:	z	z	N FABRIC				AND STEEL	(N)	(N)			
	REVISED BY	DATE REVISED	SHEET No.	PROFILE SHEET	SYSTEM No.	UNIT	ULVERT	CULVERT	HEADWALL	INLET	SLOTTED DRAIN	WING WALL	ALTERNATIVE PIPE	FLARED END	ALTERNATIVE FLARED SECTION	ROCK SLOPE PROTECTION (LIGHT, METHOD B)	SLOPE PROTECTION TON, METHOD B)	E PROTECTION	STRUCTURAL CONCRETE, BOX CULVERT	STRUCTURAL CONCRETE, DRAINAGE INLET	REINFORCING STEEL	IRON	INLET	COVER	INLET MARKER	(CULVERT)	DESCRIPTION
×	PHER SUGAR	R. MCKEAN	DRAINAGE	DRAINAGE	DRAINAGE	DRAINAGE	ABANDON CULVERT	REMOVE	REMOVE	REMOVE	REMOVE	REMOVE	24"	12" STEEL	24" END		ROCK (1/2	ROCK SLOPE (CLASS 8)			BAR	MISCELLANEOUS	HEIGHT OF	MAXIMUM	DRAINGE	MARKER	
	CHRISTOPHER	JON R	1	1	1	а	ΕA	EΑ	EA	EA	EA	<b>EA</b>	LF	EA	EA	CY	CY	SQYD	CY	CY	LB	LB	LF	LF	EΑ	EA	
	5		'	<u>'</u>	'																						
		>				b						2							4.0		570			-			0/VC/VE E/ CINOLE POV 0 1
	CALCULATED- DESIGNED BY	ED BY				c d													4.8 9.2		578 1103			3.5		1	8'X6'X5.5' SINGLE BOX Culv 8'X6'X10.5' SINGLE BOX Culv
	ALCU	CHECKED																									
×			1	1	2	a				1																	
	æ	_				Ь				1										1.5		239	3.8		1		TYPE GO DI, GRATE TYPE 24-12X
	SUPERVISOR	RASMUSSEN				d														1.5		239	3.8		1		TYPE GO DI, GRATE TYPE 24-12X
		D. RA				е									1												
	TION,	JAMES				f g										1.8		14									
	FUNCTIONAL	A																									
			1	2	3	а														0.9		236	3.8		1		TYPE GCP DI, GRATE TYPE 36R
	NOI.					b							76.1											3.9			TVDF CCD DI
×	DEPARTMENT OF TRANSPORTATION	_				С														1.6		236	6.5		1	1	TYPE GCP DI, GRATE TYPE 36R
	NSP(	03-DESIGN				d							77.4		1									5.5		1	
	TR/	ES				e f									1			27								1	
	F	<u>-</u>				g										6.4											
	TWE	8				h					1																
	EPAR									1	'																
	-					k	1																				
	ΑIΛ	į,	SHF	ET :	LOT.		1	0	0	3	2	4	153.5	0	11	08.2	0	41	14.0	5.5	1681	950			4	4	
	CALIFORNIA	Ž		TAMPE									1 . 55.5			w.r		1 ''	1 . 7.0	. 3.3	1 .001	1 330	1		<u>' '</u>	<u>' '</u>	<u>I</u>
×	CAL	ltans		- NOT							1																

Dist	COUNTY	ROUTE	TOTAL PR		No.	SHEET
03	Men	1	41.8/4	12.3		
REG	DRZ BISTERED C	AFT	EER DATE	REGISTERE	OFESS 10	ANT ENG INEER
PLA	NS APPRO	/AL DATE	\	/\ _ \ _vo		1 1
OR A THE	GENTS SHALL	LIFORNIA OR II NOT BE RESPO COMPLETENESS PLAN SHEET.	WSIBLE FOR	// " /	CIVIL OF CAL 1FO	**************************************

DRAINAGE SYSTEM NO. DRAINAGE UNIT

STATION

"M" 1+39.48

"DWY 1" 1+79.10

"M" 03+07.95

DRAINAGE QUANTITIES

DQ-1

BORDER LAST REVISED 7/2/2010

USERNAME => \$148600
DGN FILE => 0 1 2 3
DGN FILE => 0112000300id001.dgn

RELATIVE BORDER SCALE 0 1 2 3
UNIT 0306
PROJECT NUMBER & PHASE 01120003001

DATE PLOTTED => 08-APR-2020

x		×	×		×	
- DEPARTMENT OF TRANSPORTATION	FUNCTIONAL SUPERVISOR	CALCULATED-	CHRISTOPHER SUGAR	REVISED BY		
		DESIGNED BY				
03-DESIGN	JAMES D. RASMUSSEN	CHECKED BY	JON R. MCKEAN	DATE REVISED		

#### DRAINAGE QUANTITIES

	T No.	$\bigcirc$	0							CULVERT	SECTION				FABRIC				) STEEL	(N)	(N)	*				
DKAINAGE SHEET NO.	DRAINAGE PROFILE SHEET	DRAINAGE SYSTEM No.	DRAINAGE UNIT	ABANDON CULVERT			REMOVE INLET	REMOVE SLOTTED DRAIN	REMOVE WING WALL	24" ALTERNATIVE PIPE	12" STEEL FLARED END	24" ALTERNATIVE FLARED END SECTION	ROCK SLOPE PROTECTION (LIGHT, METHOD B)	ROCK SLOPE PROTECTION (1/2 TON, METHOD B)	ROCK SLOPE PROTECTION (CLASS 8)	STRUCTURAL CONCRETE, BOX CULVERT	STRUCTURAL CONCRETE, DRAINAGE INLET	BAR REINFORCING STEEL	MISCELLANEOUS IRON AND	HEIGHT OF INLET	MAXIMUM COVER	DRAINGE	MARKER (CULVERT)	DESCRIPTION	STATION	DRAINAGE SYSTEM NO.
				ΕA	EΑ	EΑΙ	EΑ	ΕA	EΑ	LF	EA	EA	CY	CY	SQYD	CY	CY	LB	LB	LF	LF	EΑ	EA	TVDE 04 B1		+
1	2	4	а														1.7		239	6.3		1	1	TYPE G1 DI, GRATE TYPE 24-12X	"M" 9+22.29	4
			b							5.6											3.1					1
			c d																							
			е							5.1											1.7					
			f									1											1			$\perp$
_			g h										3.7		20											+
													J.1													+
	3	5	а		1																				"M" 10+84.24	
			Ь														1.3		239	5.0		1	1	TYPE G1 DI, GRATE TYPE 24-12X		
			С							52.6											4.6					
			d									1											1			$\perp$
			e f										3.7		20											-
	3	6	а				1																		"M" 12+90.86	
			b		1		-																	TVDE 04 DI		+
			С														1.1		239	3.7		1	1	TYPE G1 DI, GRATE TYPE 24-12X		
			d							46.5											3.5					$\perp$
$\dashv$			e f				-					1			27								1			+
			g										6.2													$\pm$
						1	$\Box$																			$\perp$
1E	ET T	OTA	L	0	2	0	1	0	0	109.8	0	3	13.6	0	67	0	4.1	0	717			3	6			

DRAINAGE QUANTITIES

ROUTE

DRAFT
REGISTERED CIVIL ENGINEER DATE

THE STATE OF CALIFORNIA OR ITS OFFICERS
OR AGENTS SHALL NOT BE RESPONSIBLE FOR
THE ACCURACY OR COMPLETENESS OF SCANNED
COPIES OF THIS PLAN SHEET.

41.8/42.3

Dist COUNTY 03

Men

PLANS APPROVAL DATE

**DQ-2** 

STATE OF CALIFORNIA USERNAME => s148600 DGN FILE => 0112000300id002.dgn RELATIVE BORDER SCALE
IS IN INCHES UNIT 0306 PROJECT NUMBER & PHASE 01120003001 BORDER LAST REVISED 7/2/2010

Dist	COUNTY	ROUTE	POST MILES TOTAL PROJECT	SHEET No.	TOTAL SHEETS
03	Men	1	41.8/42.3		
	ISTERED O	CIVIL ENGINE	DATE No.	DFESS 10	ENG INEER
OR A THE	GENTS SHALL	LIFORNIA OR II NOT BE RESPO COMPLETENESS PLAN SHEET.	TE OFFICERS \\"	CIVIL OF CAL 1FO	AMIL #

## DRAINAGE QUANTITIES

DRAINAGE SHEET NO.	DRAINAGE PROFILE SHEET NO.	DRAINAGE SYSTEM NO.	DRAINAGE UNIT	ABANDON CULVERT	REMOVE CULVERT		REMOVE INLET	REMOVE SLOTTED DRAIN	REMOVE WING WALL	24" ALTERNATIVE PIPE CULVERT	12" STEEL FLARED END SECTION	24" ALTERNATIVE FLARED END SECTION	ROCK SLOPE PROTECTION (LIGHT, METHOD B).	ROCK SLOPE PROTECTION (1/2 TON, METHOD B)	ROCK SLOPE PROTECTION FABRIC (CLASS 8)	STRUCTURAL CONCRETE, BOX CULVERT	STRUCTURAL CONCRETE, DRAINAGE INLET	BAR REINFORCING STEEL	MISCELLANEOUS IRON AND STEEL	HEIGHT OF INLET	MAXIMUM COVER Z	DRAINGE INLET MARKER *	MARKER (CULVERT)	DESCRIPTION	STATION	DRAINAGE SYSTEM NO.	DRAINAGE UNIT
								EA		LF	ΕA	EA	CY	CY CY	SQYD	CY	.SCY	LB	LB	王 LF	LF	EA				=	뤼
1	4	7	a	-		1		EA	LA						Jair										"M" 17+92.25	7	a
<u>'</u>	'	'	b		1																				W 11.32.23	+ '	Ы
			c		1																						c
			d														1.7		239	6.5		1	1	TYPE G1 DI, GRATE TYPE 24-12X			d
			е							68.9											12.0		1				е
			f												198												f
			g											161.8													g
																											Щ
	JB TO				2	1				68.9				161.8	198		1.7		239			1	2				
SHEET				1			3	2	4	153.5	1	1	8.2		41	14.1	5.5	1681	950			4	4				_
SHEET			IAL	1	2		1		<u> </u>	109.8		3	13.6	464.3	67	111	4.1	1.001	717			3	6				$\dashv$
	TOTA	٩L		1	4	1	4	2	4	332.2	1	4	21.7	161.8	306	14.1	11.3	1681	1906			8	12				

\* STAMPED CONCRETE IMPRINT (N) - NOT A SEPARATE BID ITEM

JON R. MCKEAN

JAMES D. RASMUSSEN

DEPARTMENT OF TRANSPORTATION 03-DESIGN

CALIFORNIA

# DRAINAGE QUANTITIES

DQ-3


USERNAME => s148600 DGN FILE => 0112000300id003.dgn RELATIVE BORDER SCALE
IS IN INCHES UNIT 0306 PROJECT NUMBER & PHASE 01120003001 BORDER LAST REVISED 7/2/2010

	Dist	COUNTY ROUTE	POST MILES TOTAL PROJECT	SHEET No. S	TOTAL
	01	Men 1	41.8/42.3		
NOTES:			XX-XX-20 0 PRO	OFESS 10N2	
1. EXACT SIGN LOCATION TO BE DETERMINED BY THE ENGINEER.	REG	GISTERED CIVIL ENGINE		N MCKEAN	7. E
	PLA	XX-XX-20 ANS APPROVAL DATE	No. C	C 61308 06-30-2	ī) Ē
	THE . OR A	STATE OF CALIFORNIA OR I	TS OFFICERS ONSIBLE FOR	CIVIL	*

## STATIONARY MOUNTED CONSTRUCTION AREA SIGNS

SIGN No.	SIGN DESIGNATION	PANEL SIZE	SIGN MESSAGE	NUMBER OF POSTS AND SIZE	NUMBER OF SIGNS (N)
A	C4O <ca></ca>	108" × 42"	TRAFFIC FINES DOUBLED IN CONSTRUCTION ZONES	2 - 6" × 6"	2
В	W20-1	36" × 36"	ROAD WORK AHEAD	1 - 4" × 6"	3
C	W8-7	36" × 36"	LOOSE GRAVEL	1 - 4" × 6"	2
D	W11-1 W16-1P	36" × 36" 24" × 30"	BICYCLE SYMBOL SHARE THE ROAD	1 - 6" × 6"	2
E	G20-2	36" × 18"	END ROAD WORK	1 - 4" × 4"	3

(N) - NOT A SEPARATE BID ITEM

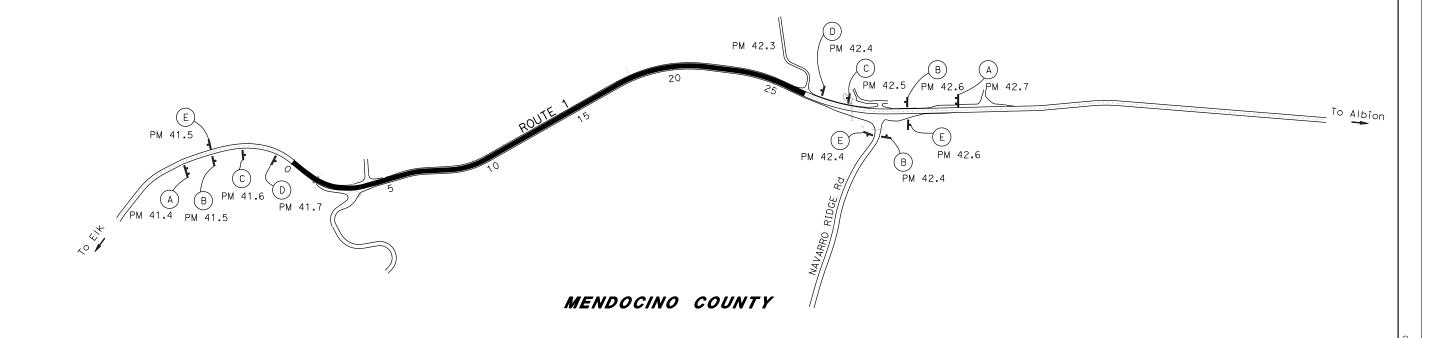

CONSTRUCTION AREA SIGNS


NO SCALE


THE STATE OF CALIFORNIA OR ITS OFFICERS OR AGENTS SHALL NOT BE RESPONSIBLE FOR THE ACCURACY OR COMPLETENESS OF SCANNED COPIES OF THIS PLAN SHEET.


CS-1


APPROVED FOR CONSTRUCTION AREA SIGN WORK ONLY


RELATIVE BORDER SCALE IS IN INCHES USERNAME => s148600 DGN FILE => 01120003001a001.dgn UNIT 0306 01120003001 PROJECT NUMBER & PHASE BORDER LAST REVISED 7/2/2010

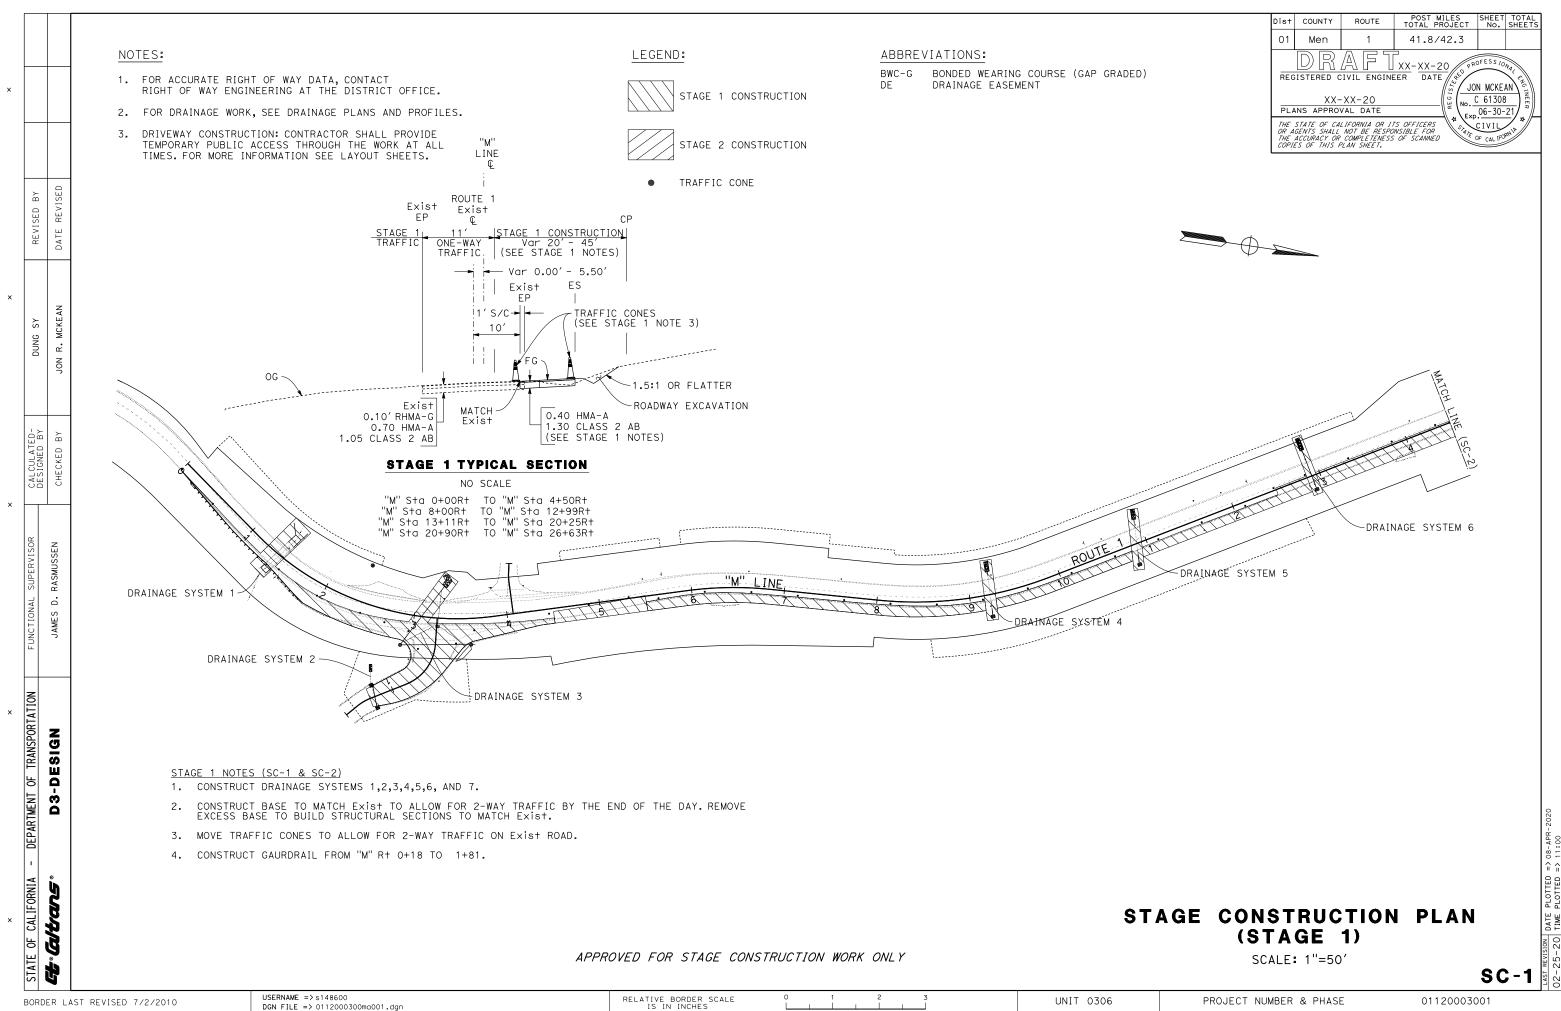


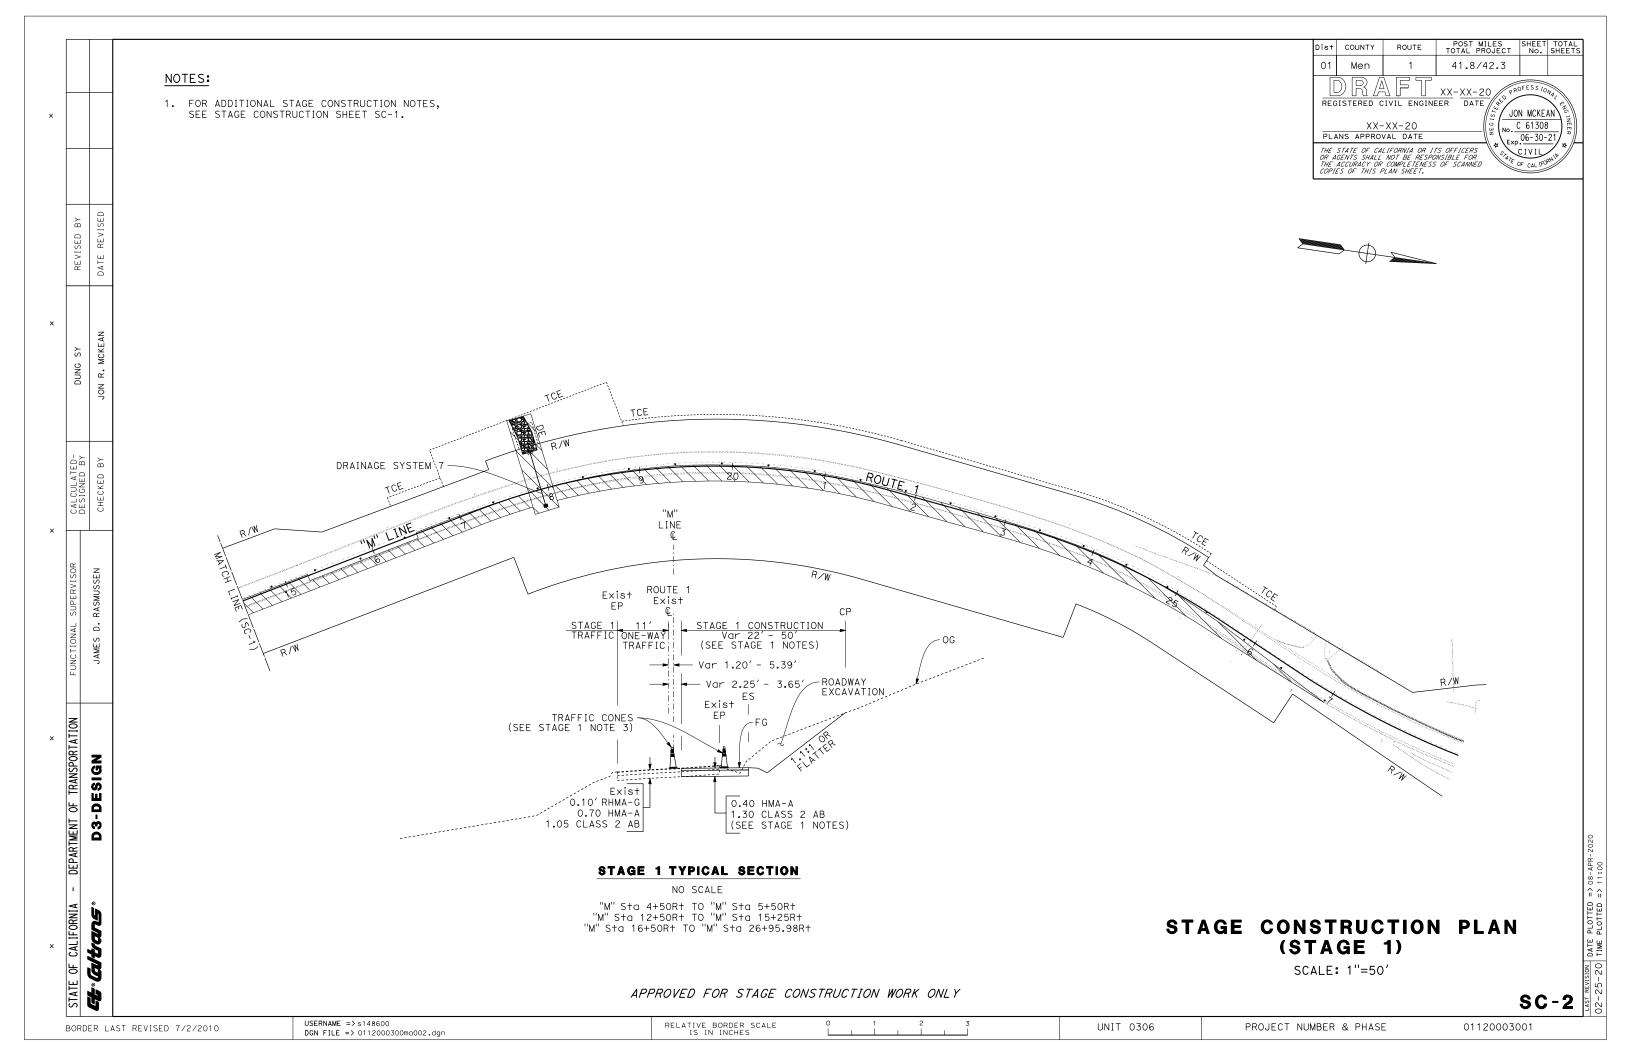


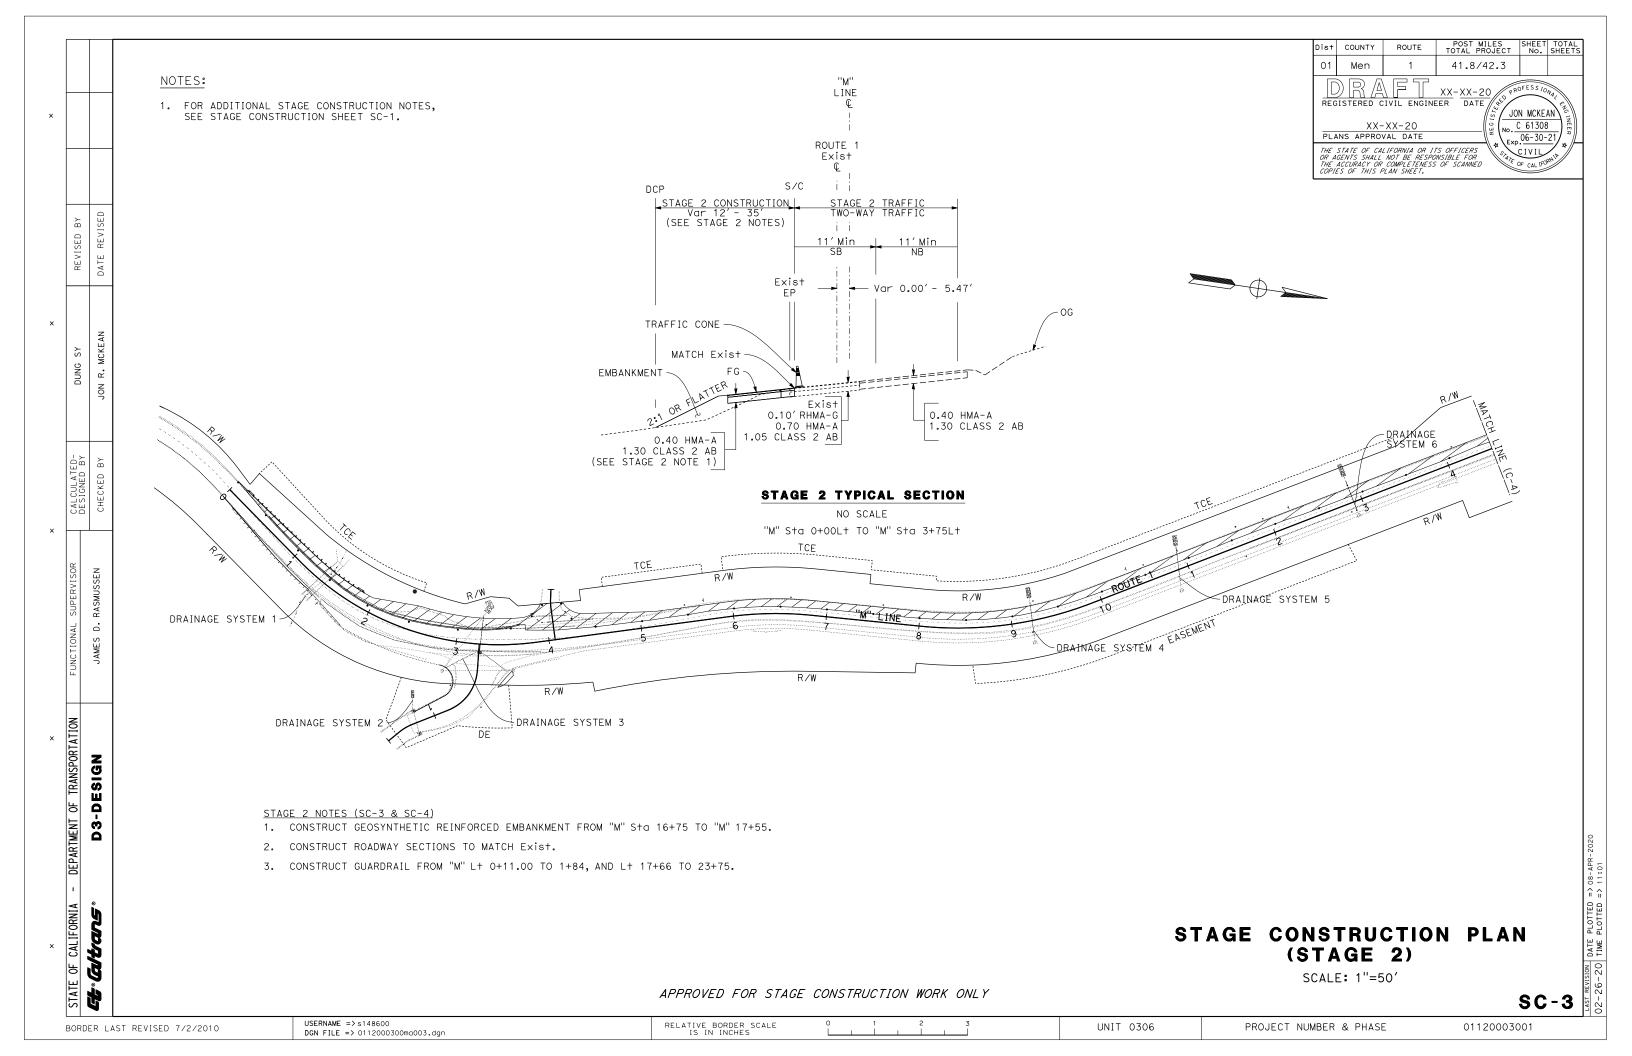

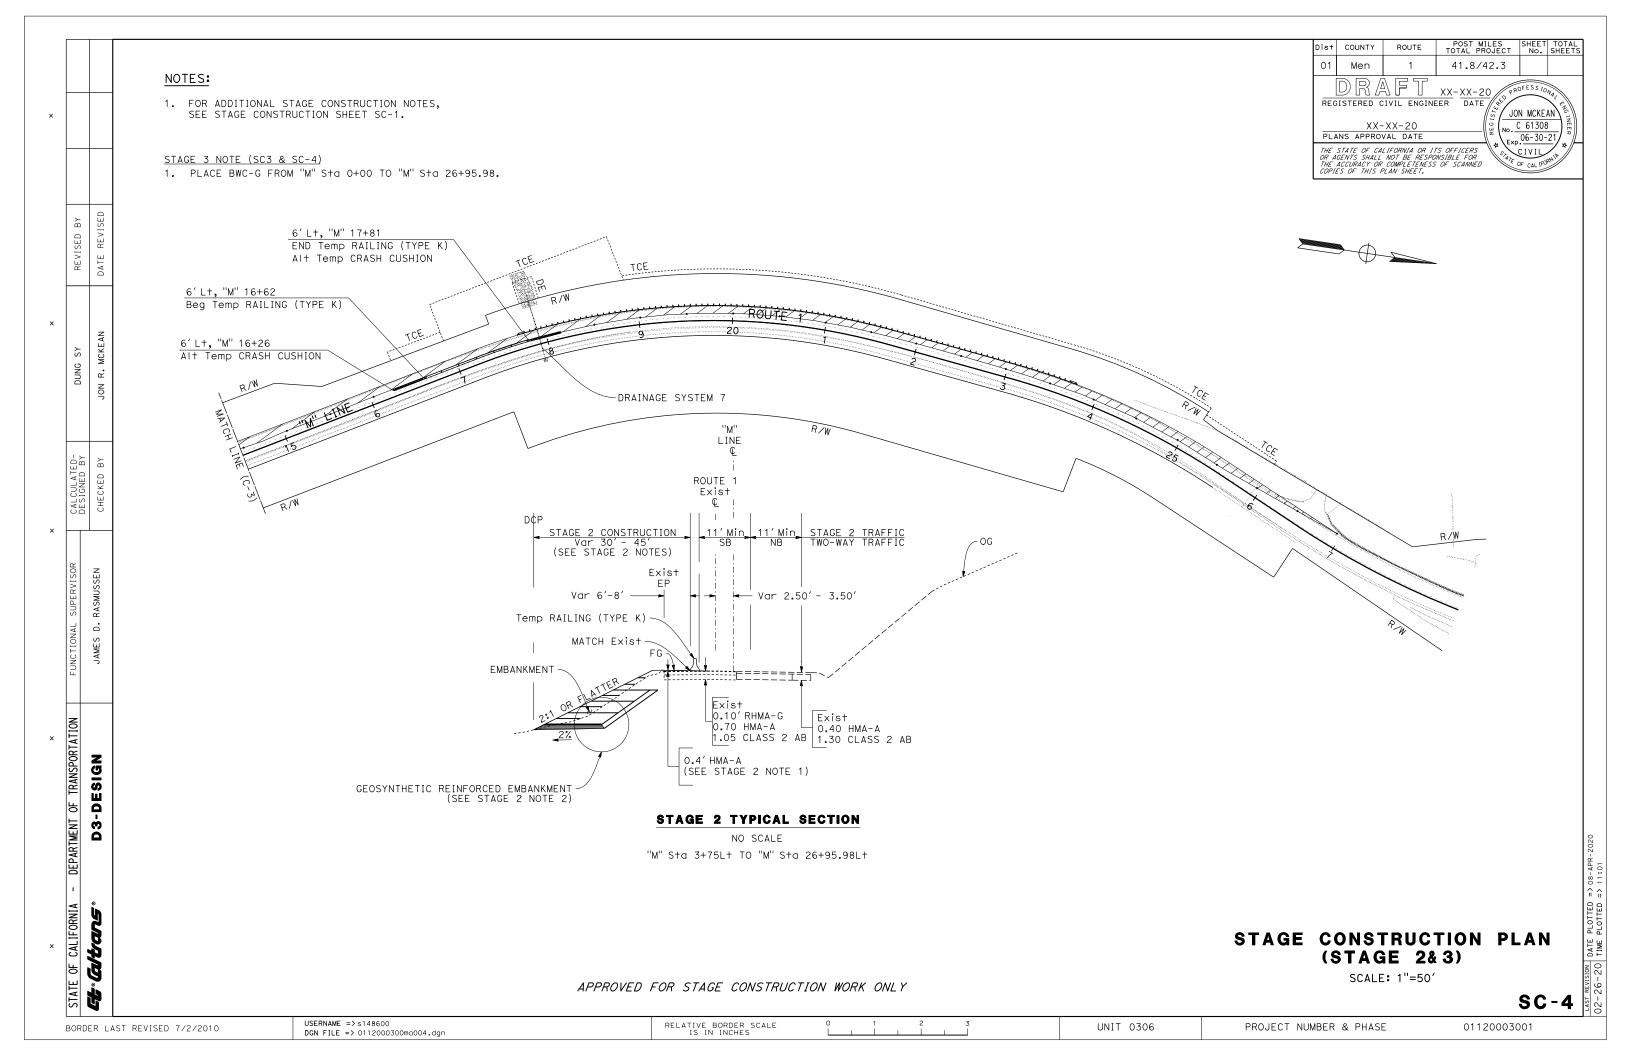

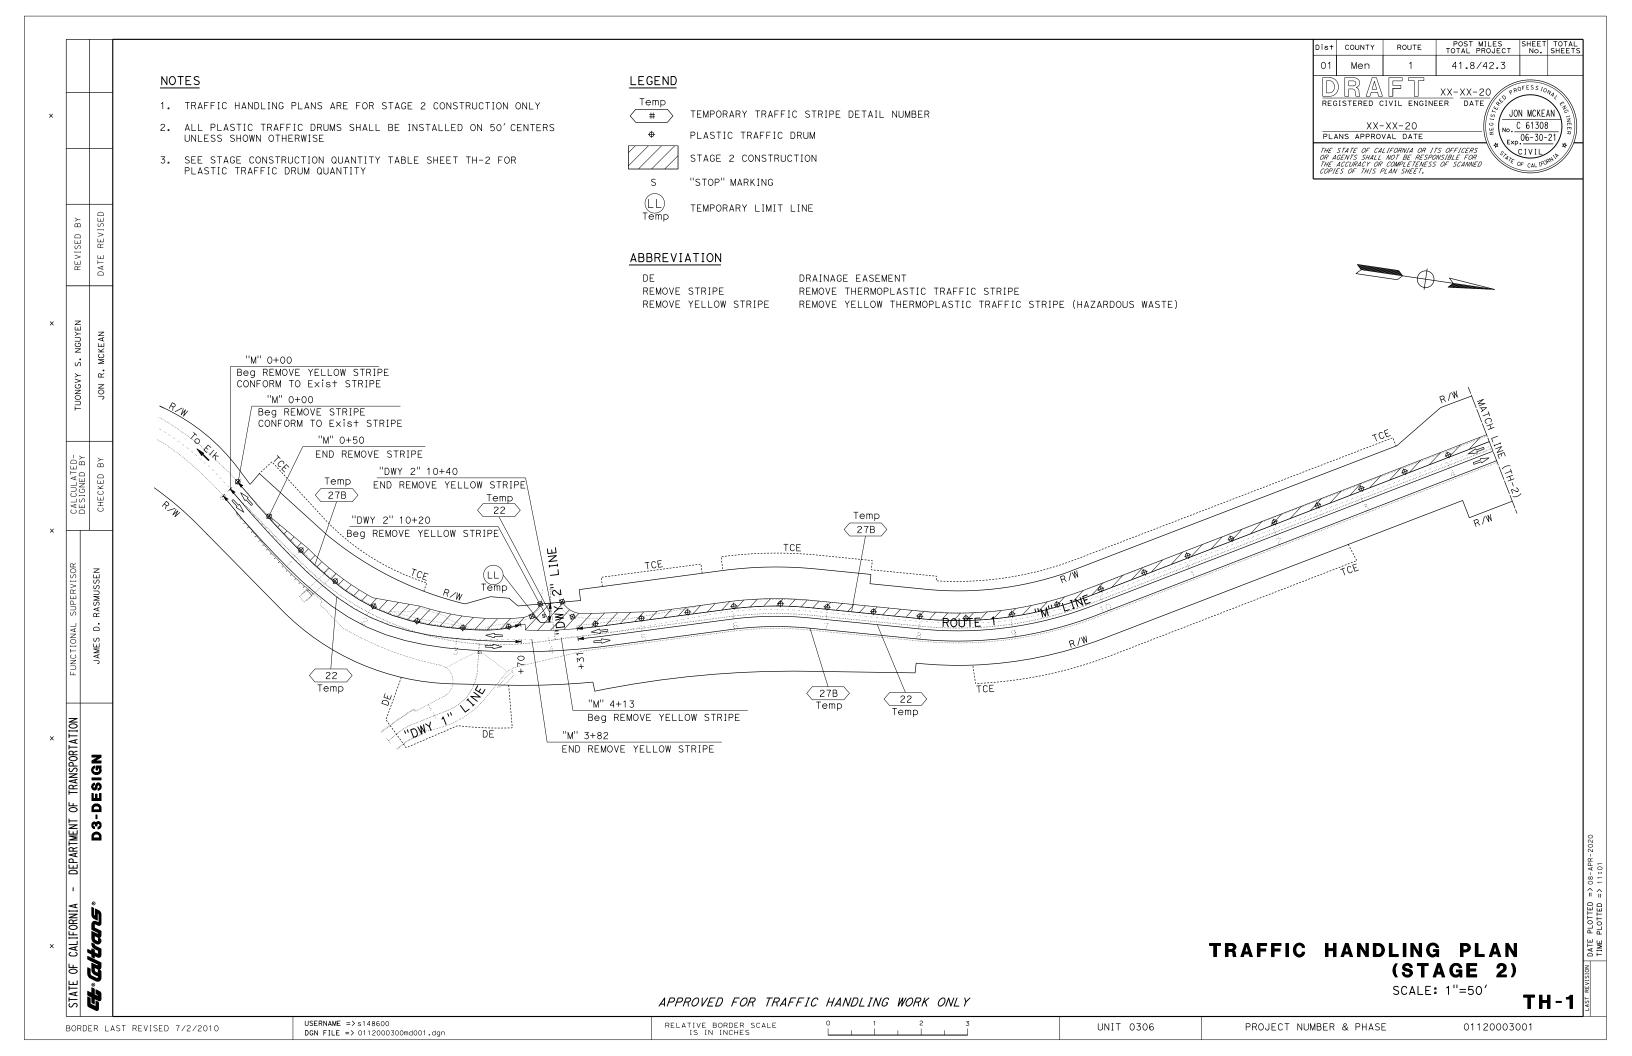

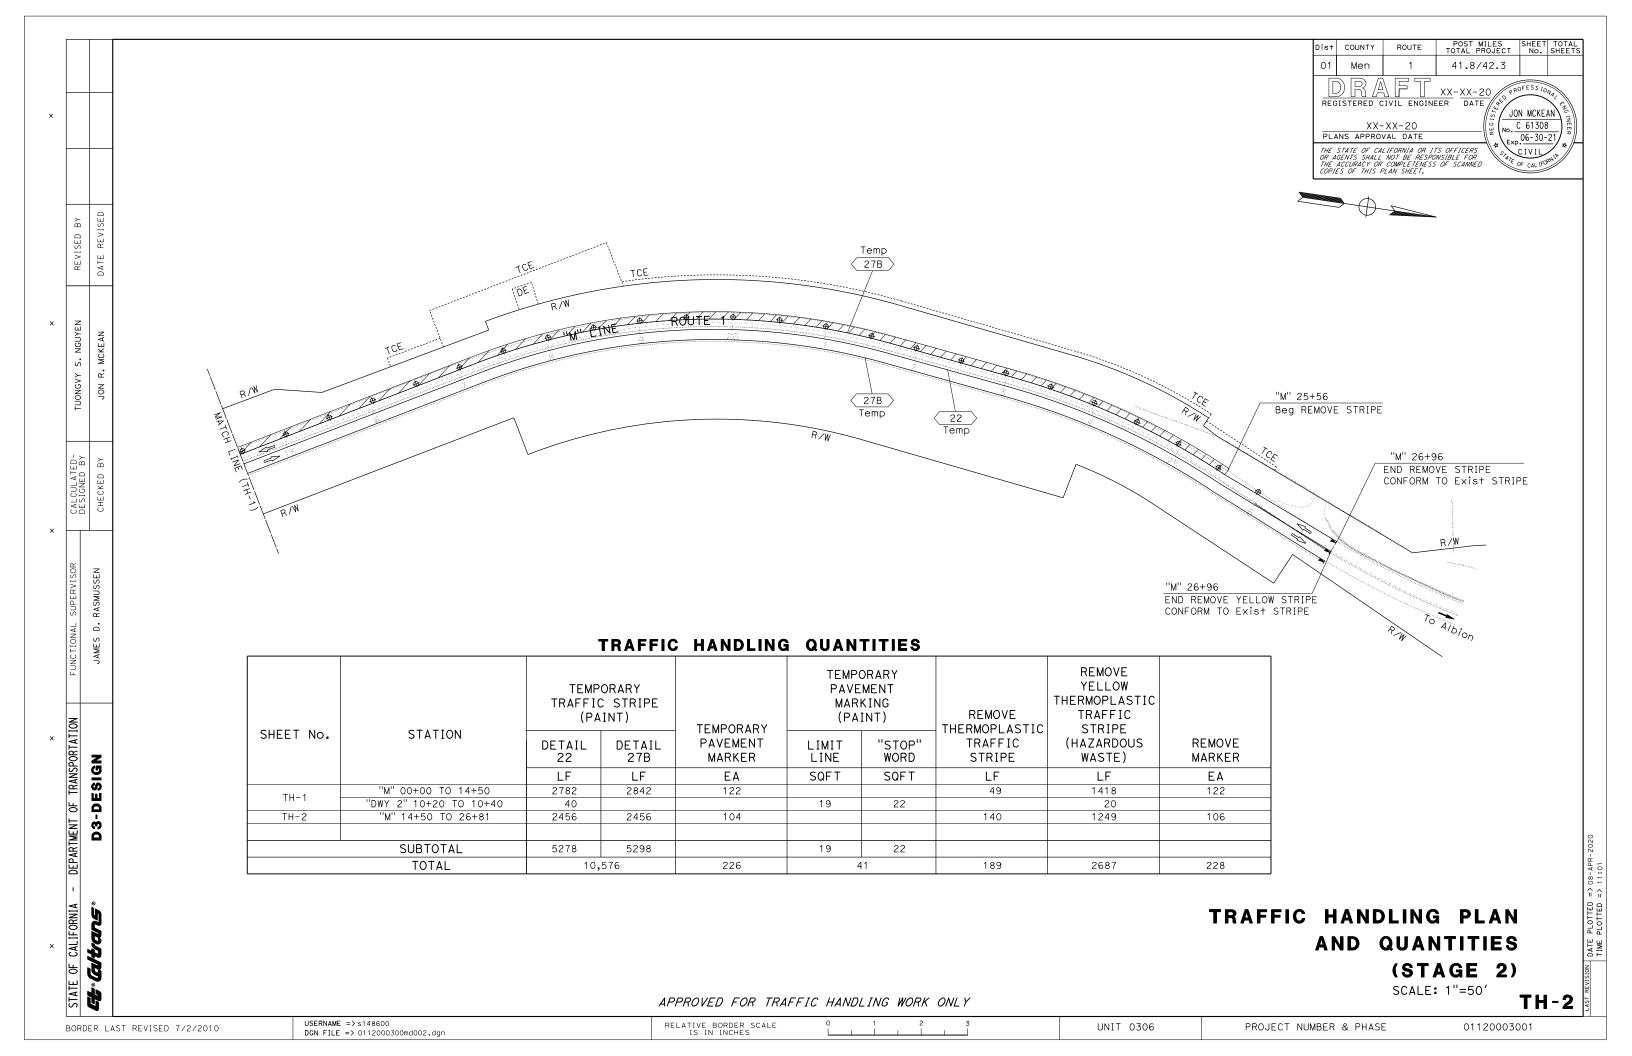

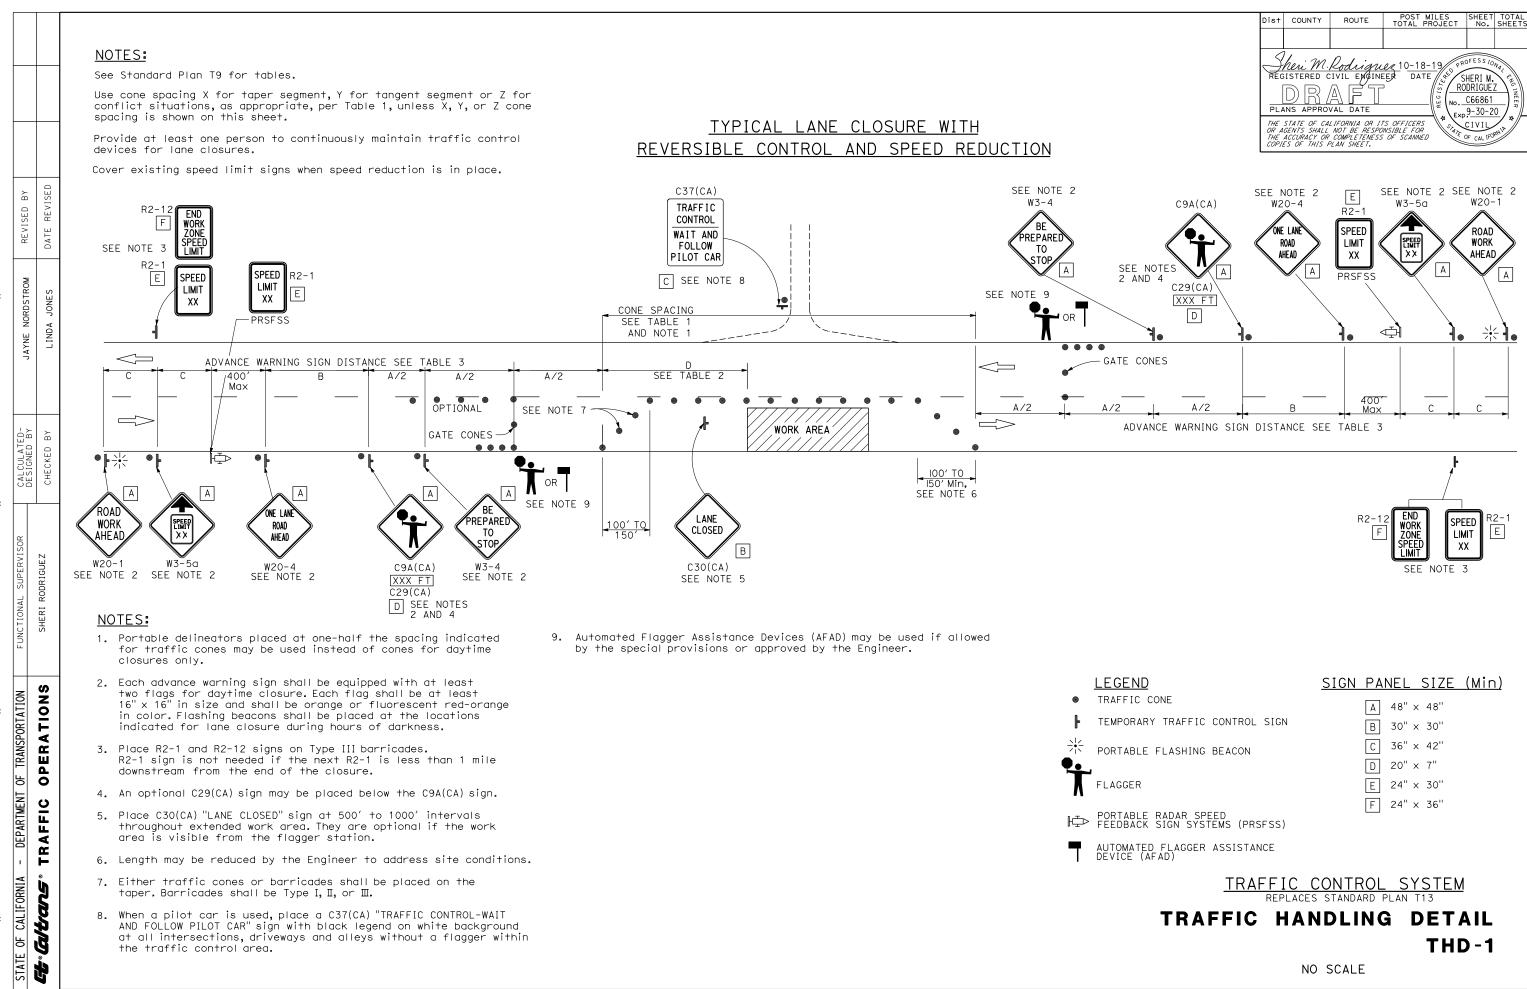


BORDER LAST REVISED 7/2/2010

USERNAME => \$148600
DON FILE => 0112000300me001.dgn

RELATIVE BORDER SCALE 0 1 2 3
UNIT 0306

PROJECT NUMBER & PHASE 01120003001

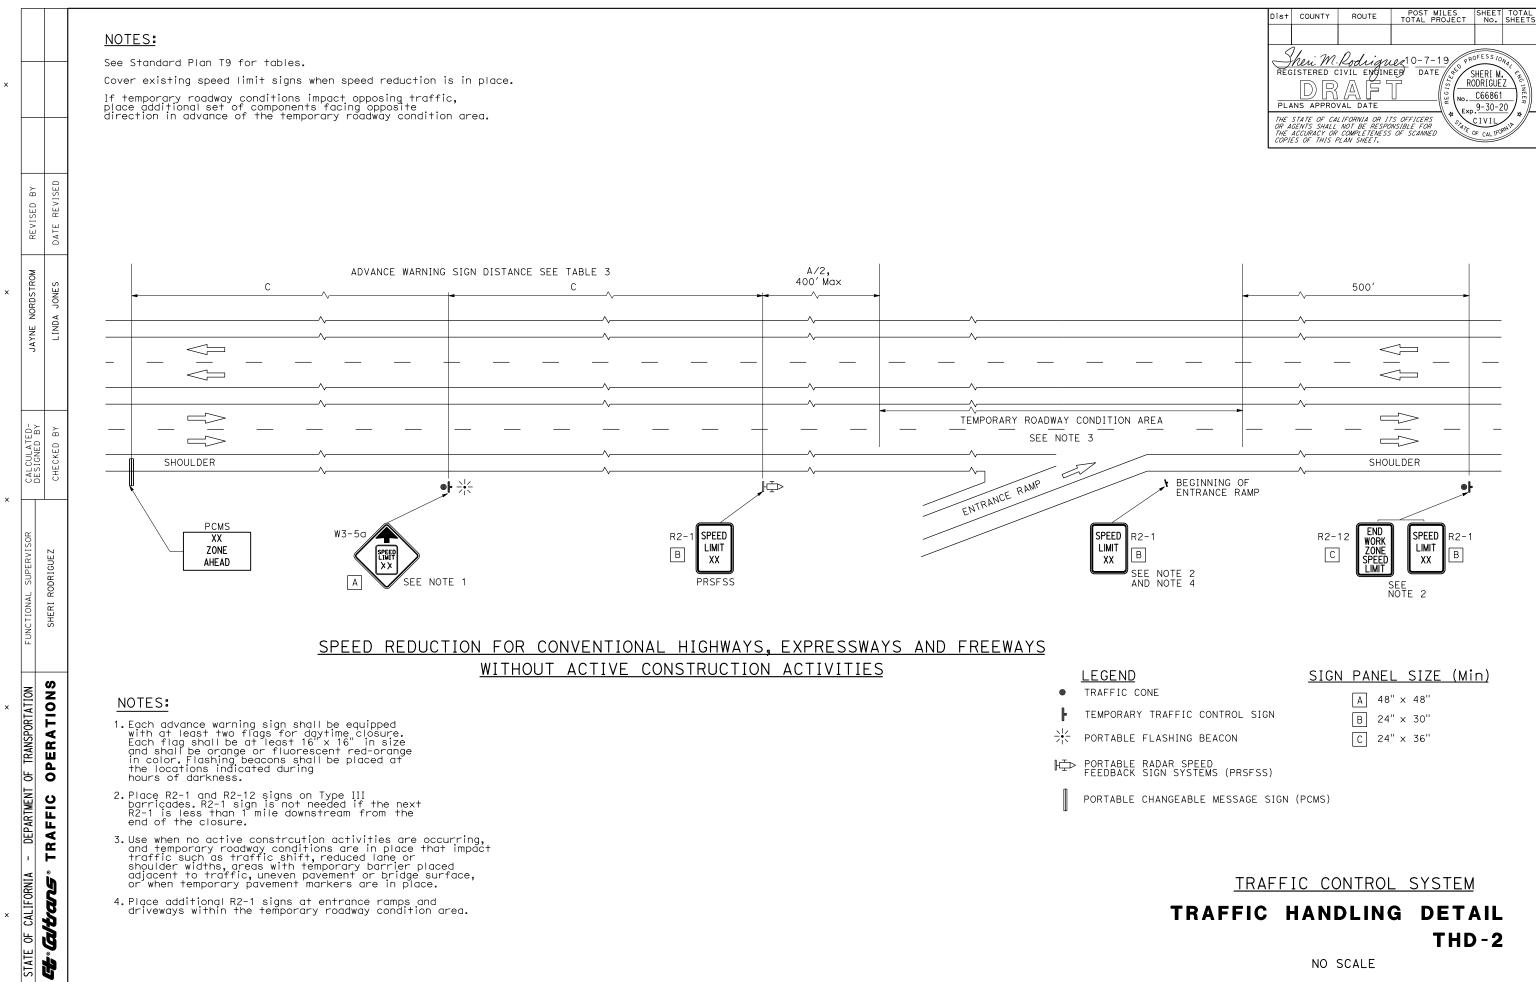

RELATIVE BORDER SCALE
IS IN INCHES

UNIT 0306


PROJECT NUMBER & PHASE

USERNAME => s148600 DGN FILE => 0112000300me002.dgn

BORDER LAST REVISED 7/2/2010

LAST REVISION DATE PL

STATE OF CALIFORNIA	APPE	ROVED FOR PAVEMENT DELINEATION AND SIGN WORK ONLY	PAVEMENT DELINEATION AND SIGN PLAN SCALE: 1" = 50'
IA - DEPARTMENT OF TRANSPORTATION  7* D3-DESIGN	1-7 SG28(L+) (CA) SG(CA)  1-7 SG28(L+) (CA)		
FUNCTIONAL SUPERVISOR JAMES D. RASMUSSEN	E 22	s=80'	s=80' E S=120' s=80'
CALCULATED- DESIGNED BY	W1-3 W13-1(30)	SG28(R+) (CA) SG (CA)	1-10 SG28(R+) (CA) SG (CA) 1-4 s=120' E
SVETLA MITOVA JON R. MCKEAN	+00 CONFORM TO  EXISTING STRIPING	1-9	SW48(30) (CA) SW48-2(2) (CA) SW48-2(2) (CA) SW48-2(2) (CA)
REVISED BY	4. DELINEATORS NEAR GUARDRAIL SHALL BE MOUNTED ON THE GUARDRAIL. 5. DELINEATOR SPACING 40' UNLESS OTHERWISE SHOWN.	DELINEATOR TYPE E  E  DELINEATOR TYPE F  F	
	2. SIGN POST LENGTHS ARE APROXIMATE. EXACT SIZE AND LENGTHS WILL BE DETERMINED BY THE ENGINEER.  3. ALL LANES ARE 12' WIDE UNLESS SHOWN OTHERWISE.	LL LIMIT LINE  S "STOP" PAVEMENT MARKING  S= DELINEATOR SPACING	PLANS APPROVAL DATE  THE STATE OF CALIFORNIA OR ITS OFFICERS OR AGENTS SHALL NOT BE RESPONSIBLE FOR THE ACCURACY OR COMPLETENESS OF SCANNED COPIES OF THIS PLAN SHEET.
	1. LOCATION OF ROADSIDE SIGNS ARE APROXIMATE. EXACT LOCATION AND POSITION OF SIGNS WILL BE DETERMINED BY THE ENGINEER.	REMOVE ROADSIGN SIGN  RESET ROADSIDE SIGN	REGISTERED CIVIL ENGINEER DATE
	NOTES:	LEGEND:	01 Men 1 41.8/42.3 DRAFT xx-xx-20 (**

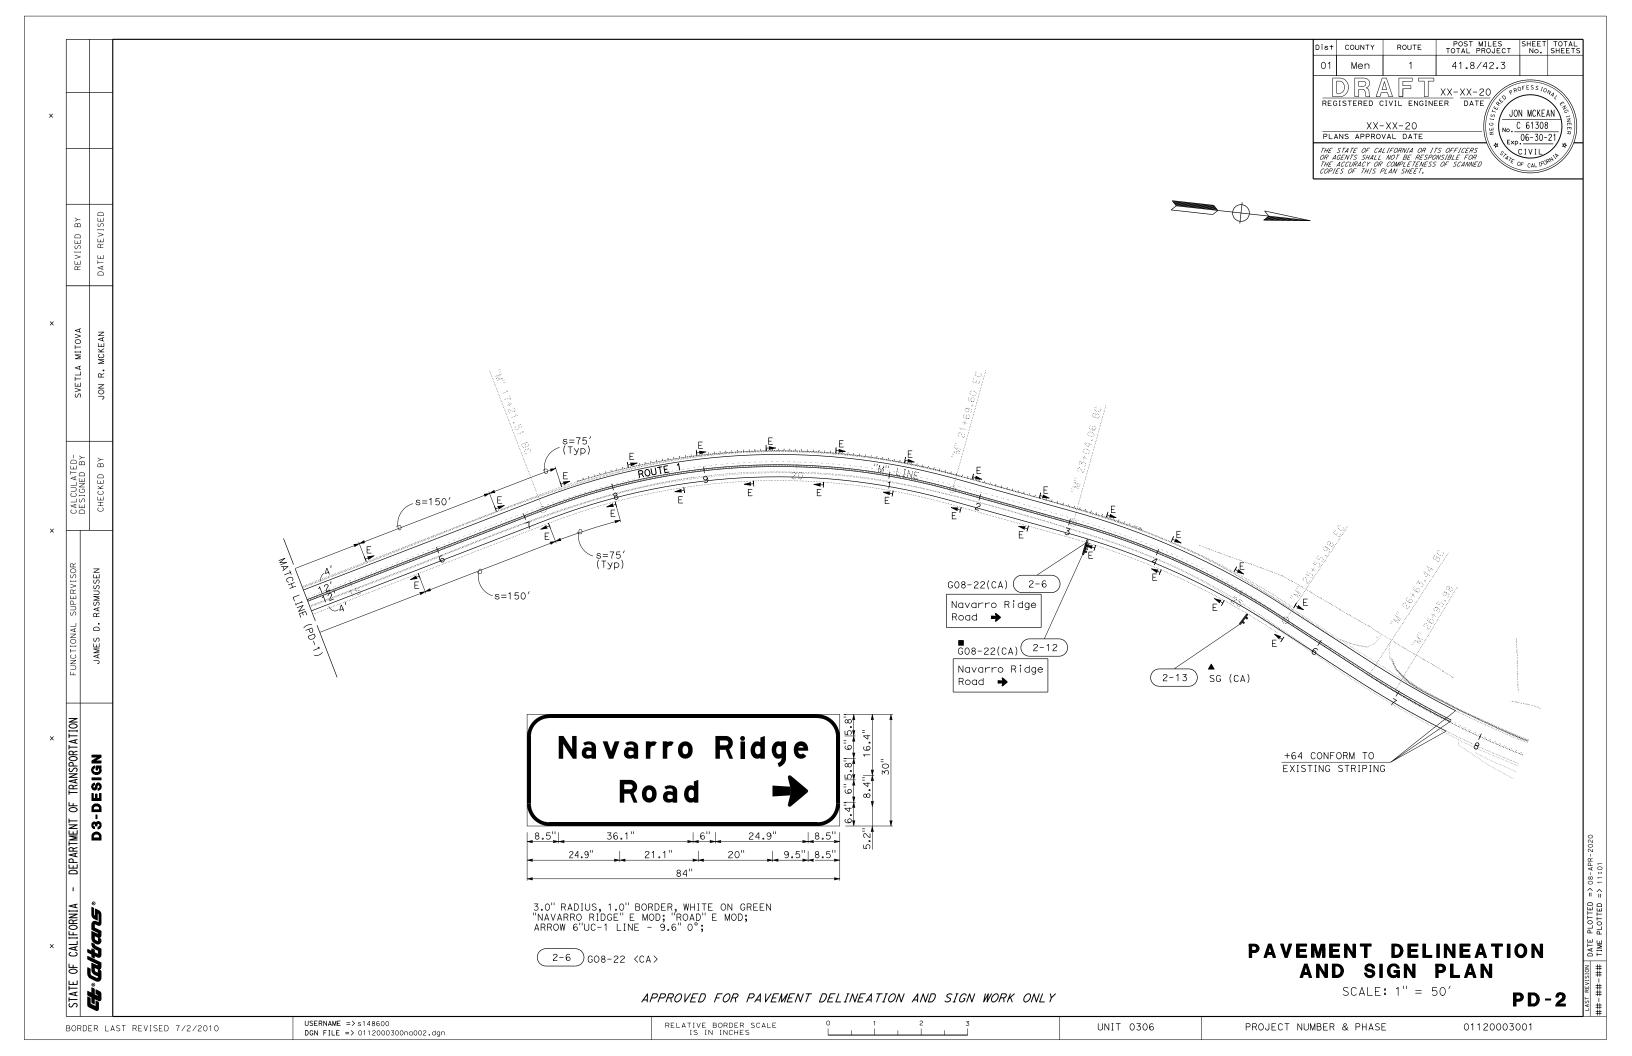

10		
10		
v	1 L	

1. THE COLOR OF THE MARKER BODY MUST BE THE SAME AS THE TRAFFIC LINE PLACED.

Dist	COUNTY	ROUTE	POST MILES TOTAL PROJECT	SHEET No.	TOTAL SHEETS
01	Men	1	41.8/42.3		
		XX-20 VAL DATE	DATE S	N MCKE C 61308 06-30-	AN LEER LINEER
OR A THE	GENTS SHALL	LIFORNIA OR II NOT BE RESPO COMPLETENESS VIAN SHFFT.		CIVIL OF CAL IFO	AMIL A

#### PAVEMENT DELINEATION QUANTITIES

SHEET No.	LOCATION	PAVEMENT MARKER (RETROFLECTIVE)		6" THERMOPLASTIC TRAFFIC STRIPE (ENHANCED WET NIGHT VISIBILITY)		THERMOPLASTIC PAVEMENT MARKING	(ENHANCED WET NIGHT VISIBILITY)	6" THERMOPLASTIC TRAFFIC STRIPE (EWNV) (BROKEN 12-3)	DELINEATOR	(CLASS 1)
		TYPE D	DETAIL 21	DETAIL 22	DETAIL 27B	STOP	LIMIT LINE	DETAIL 27C	TYPE E	TYPE F
		EA	LF	LF	LF	SQFT	SQFT	LF	EΑ	EA
PD-1	"M" 0+00 TO 14+50	122	35	1390	2827	22	26	74	42	6
PD-2	"M" 14+50 TO 26+96	118		1315	2629				27	
	TOTAL	240		8196		4	8	74	7	5

PAVEMENT DELINEATION QUANTITIES

PDQ-1

USERNAME => s148600 DGN FILE => 0112000300nc001.dgn BORDER LAST REVISED 7/2/2010

RELATIVE BORDER SCALE
IS IN INCHES

UNIT 0306

PROJECT NUMBER & PHASE

×	×		×	×		×	
E OF CALIFORNIA -	<ul> <li>DEPARTMENT OF TRANSPORTATION</li> </ul>	FUNCTIONAL SUPERVISOR	CALCULATED-	SVETLA MITOVA	REVISED BY		
;			DESIGNED BY				
; cutans	D3-DESIGN	JAMES D. RASMUSSEN	CHECKED BY	JON R. MCKEAN	DATE REVISED		
							Γ

NI	$\wedge$	т		S	
I٧	v	-	ᆫ	J	

- 1. EXACT LOCATION AND POSITION OF ROADSIDE SIGNS TO BE DETERMINED BY THE ENGINEER.
- 2. POST LENGTHS GIVEN ARE APPROXIMATE.
- 3. "C" DIM = VERTICAL CLEARANCE FROM EP TO BOTTOM OF SIGN PANEL.
- 4. ALL SIGN DESIGNATIONS SHOWN ARE FEDERAL UNLESS OTHERWISE INDICATED AS A CALIFORNIA <CA> SIGN DESIGNATION.

Dist	COUNTY	ROUTE	POST MILES TOTAL PROJECT	SHEET No.	TOTAL SHEETS
01	Men	1	41.8/42.3		
		XX-20 VAL DATE	EER DATE	N MCKE	AN SO INEER 21
OR A THE	GENTS SHALL	LIFORNIA OR 17 NOT BE RESPO COMPLETENESS PLAN SHEET.	TO OFFICERS \\ '\ \	CIVIL OF CAL IFO	/ ~// I

# **ROADSIDE SIGN QUANTITIES**

SIGN NUMBER	SIGN DESIGNATION	PANEL SIZE	"C" DIM IN FEET	POST SIZE	AND LENGTH	ROADSII	DE SIGN	RESET ROADSIDE SIGN	REMOVE ROADSIDE SIGN	TREATED WOOD WASTE
CUT No			L	4"×4"	4"×6"	ONE POST	TWO POST	(TWO POST)		
(SHT-No.)		INCHES		4 X4	4 80	EA	EA	EA	EA	LB
1 – 1	SG 28(L+) (CA) SG (CA)	30 × 30 30 × 12	4		15′	1				
1-2	R1-1	30 × 30	5	13′		1				
1-3	W1-3 W13-1(30)	36 × 36 30 × 30	4		14′	1				
1 – 4	SG 28(R+) (CA) SG (CA)	30 × 30 30 × 12	4		15′	1				
1-5	SW 48(30) (CA) SW 48-2(2) (CA)	48 × 36 48 × 12	4		15.5′	1				
2-6	G08-22(CA)	84 X 30	5		14'		1			
1 – 7	SG 28(L+) (CA) SG (CA)								1	86
1-8	R1-1								1	50
1-9	W1-3 W13-1(30)								1	80
1-10	SG 28(R+) (CA) SG (CA)								1	86
1-11	SW 48(30) (CA) SW 48-2(2) (CA)								1	89
2-12	G08-22(CA)								1	160
2-13	SG (CA)							1		
					TOTAL	5	1	1	6	551

SIGN QUANTITIES

SQ-1

USERNAME => s148600 DGN FILE => 0112000300od001.dgn RELATIVE BORDER SCALE
IS IN INCHES UNIT 0306 01120003001 PROJECT NUMBER & PHASE BORDER LAST REVISED 7/2/2010

OF CALIFORNIA - DEPARTMENT OF TRANSPORTATION         FUNCTIONAL SUPERVISOR         CALCULATED-DESIGNED BY         SVETLA MITOVA         REVISE           CALCALEGNED BY         D3-DESIGNED         D3-DESIGNED         BY         JON R. MCKEAN         DATE RI	×	×	^	×	×		×	
D3-DESIGN JAMES D. RASMUSSEN CHECKED BY JON R. MCKEAN		OF TRANSPORTATI		CALCULATED-	SVETLA MITOVA	REVISED BY		
D3-DESIGN JAMES D. RASMUSSEN CHECKED BY JON R. MCKEAN				DESIGNED BY				_
	dtans	D3-DESIGN	0	CHECKED BY	JON R. MCKEAN	DATE REVISED		
								_

Dist	COUNTY	ROUTE	POST MILES TOTAL PROJECT	SHEET No.	TOTAL SHEETS	
01	Men	1	41.8/42.3			
REG	DR/	FT IVIL ENGINE	ER DATE	ON MCKE	1.51	
PLA	XX-	XX-20 VAL DATE	No.	C 61308	21	
OR A THE	GENTS SHALL	LIFORNIA OR II NOT BE RESPO COMPLETENESS PLAN SHEET.	TO OCCIOENCE MA	CIVIL OF CAL IFO	ROULD #	

#### NOTES:

- 1. ALL SIGN DESIGNATIONS SHOWN ARE FEDERAL UNLESS OTHERWISE INDICATED AS A CALIFORNIA (CA) SIGN DESIGNATION.
- 2. ALL BLACK SIGN PANEL LEGEND SHEETING SHALL BE NON-REFLECTIVE.

<b>←</b> L→				
	Ď	L D	= =	LENGTH OF PANEL DEPTH OF PANEL

# ROADSIDE SIGN PANEL QUANTITIES

				S	BACKG	ROUND	LEGE	END	ΑΥ	ΛE		SH SINGLE	
		PANEL	PANEL	PANELS	O	CTIVE PE	9	CTIVE PE	IVE-OVERLAY (PREMIUM)	LECTIV TING E XI)	ALUM RETRORE	MINUM SIGN FLECTIVE (TYPE XI)	SHEETING
SIGN DESIGNATION	SIGN MESSAGE/DESCRIPTION	SIZE L × D	AREA	님	NI W	LECT	NI N	LE TYF	VE.	REF YPE	UNFR	RAMED	FRAMED
DESIGNATION				NUMBER	1 55	RETROREFI ASTM 1	SHEETING	RETROREFLECTIVE ASTM TYPE	PROTECTIVE FILM (PR	RETROREFLECTIVE SHEETING (TYPE XI)	0.063"	0.080"	0.080"
		INCHES	SQFT			~		<b>~</b>	<u>a</u>	SQFT	SQFT	SQFT	SQFT
R1-1	STOP	30	5.18	1	RED	XI	WHITE RED	IX	×	5.18	5.18		
W1-3	REVERSE TURN RT	36 X 36	9.00	1	YELLOW	XI	BLACK YELLOW	ΧI	X	9.00	9.00		
W13-1(30)	ADVISORY SPEED	30 X 30	6.25	1	YELLOW	ΧI	BLACK YELLOW	XI	X	6.25	6.25		
SW48(30) (CA)	TRACTOR-SEMIS OVER 30 FEET KINGPIN TO REAR AXLE NOT ADVISED	48 X 36	12.00	1	YELLOW	XI	BLACK YELLOW	XI	- X	12.00		12.00	
SW48-2(2) (CA)	NEXT 2 MILES	48 X 12	4.00	1	YELLOW	XI	BLACK		X	4.00		4.00	
5W46-2(2) (CA)	NEXT 2 MILES	40 X 12	4.00	'	TELLOW	×1	YELLOW	ΧI	] ^	4.00		4.00	
SG 28(R+) (CA)	COASTAL VIEW	30 X 30	6.25	1	BROWN	IX	WHITE BROWN	XI	- x	6.25	6.25		
SG (CA)	NO RVs	30 X 12	2.50	2	BROWN	IX	WHITE BROWN	XI	X	5.00	5.00		
SG 28(L+) (CA)	COASTAL VIEW	30 X 30	6.25	1	BROWN	XI	WHITE BROWN	IX	X	6.25	6.25		
G08-22(CA)	NAVARO RIDGE ROAD →	84 X 30	17.50	1	GREEN	XI	WHITE GREEN	IX	X	17.50			17.50
		•	•					Т	OTAL	71.43	37.93	16.00	17.50

SIGN QUANTITIES

SQ-2

USERNAME => s148600 DGN FILE => 0112000300od002.dgn RELATIVE BORDER SCALE
IS IN INCHES UNIT 0306 PROJECT NUMBER & PHASE 01120003001 BORDER LAST REVISED 7/2/2010

	×	×	•	×		×
ORNIA -	DEPARTMENT OF TRANSPORTATION	FUNCTIONAL SUPERVISOR	CALCULATED	SVETI A MITOVA	REVISED BY	
			DESIGNED BY			
ۇ	D3-DESIGN	JAMES D. RASMUSSEN	CHECKED BY	JON R. MCKEAN	DATE REVISED	
					-	

STAGE	L+/R+	STATION	TEMPORARY HIGH- VISIBILITY FENCE			
			LF			
1	R+	"M" 10+43.62 TO 10+64.90	81 ′			
2	L†	"M" 1+78.58 TO 4+50.80	569′			

Dist	COUNTY	ROUTE	POST M TOTAL PE	IILES ROJECT	SHEET No.	TOTAL SHEETS		
01	Men	1	41.8/	42.3				
		EIVIL ENGINE  -XX-20 VAL DATE	XX-XX-2 EER DATE	No. C	N MCKE/ 61308 06-30-	ENG INEER		
THE STATE OF CALIFORNIA OR ITS OFFICERS OR AGENTS SHALL NOT BE RESPONSIBLE FOR THE ACCURACY OR COMPLETENESS OF SCANNED COPIES OF THIS PLAN SHEET.								

# ROADWAY QUANTITIES SUMMARY TABLE

STAGE	LOCATION	ROADWAY EXCAVATION	EMBANKMENT ( N)	GEOSYNTHETIC REINFORCEMENT  EMBANKMENT	CLASS 1 PERMEABLE MATERTIAL ≺ (BLANKET)	റ CLASS 3 PERMEABLE MATERTIAL ≺ (BLANKET)	CLASS C FILTER FABRIC	GEOSYNTHETIC REINFORCEMENT	S SUBGRADE ENHANCEMENT GEOTEXTILE,	CLASS 2 AGGREGATE BASE	의 HOT MIX ASPHALT 얼 (TYPE A)	BONDED WEARING COURSE-	S GEOSYNTHETIC PAVEMENT INTERLAYER G (PAVING FABRIC)	Z TACK COAT	규 REMOVE ASPHALT CONCRETE DIKE	S COLD PLANE ASPHALT CONCRETE PAVEMENT	MIDWEST GUARDRAIL SYSTEM الله (STEEL POST)	MIDWEST GUARDRAIL SYSTEM (8' POST)	VEGETATION CONTROL (MINOR CONCRETE)	END ANCHOR ASSEMBLY(TYPE SFT)	m ALTERNATIVE IN-LINE	다 CABLE RAILING	d 12" RUMBLE STRIP → (ASPHALT CONCRETE PAVEMENT)
1		10,923	132				5415		2667	1166	753	. 511	1228	1.0	253	692	112.5		73.7	1	1		
2	"M" 0+00 TO 27+64	389	4290	650	70	95	990	700	773	354	837		1228	1.0		601	62.5	512.5	251.4		4	20	
3												510		3.2		369							26.5
	TOTAL	11,312	4422	650	70	95	990	700	3440	1520	1590	510	2457	5.2	253	1662	175.0	512.5	325.1	1	5	20	26.5

(N) - NOT A SEPARATE BID ITEM

#### TEMPORARY WATER POLLUTION CONTROL QUANTITIES

	TEMPORARY SILT FENCE	TEMPORARY REINFORCED SILT FENCE	TEMPORARY DRAINAGE INLET PROTECTION	TEMPORARY CHECK DAM	TEMPORARY FIBER ROLL	MOVE-IN/MOVE-OUT (TEMPORARY EROSION CONTROL)	TEMPORARY HYDRAULIC MULCH (BONDED FIBER MATRIX)	TEMPORARY CONSTRUCTION ENTRANCE	TEMPORARY TACKED STRAW	RAIN EVENT ACTION PLAN (REAP)	STORMWATER ANNUAL REPORT	STORMEWATER SAMPLING AND ANALYSIS DAY
	LF	LF	EA	LF	LF	EA	SQYD	EA	SQYD	EA	EA	EA
TOTAL	535	2660	8	70	5320	1	12,700	7	12,700	39	3	66

SUMMARY OF QUANTITIES

Q -1 | SQ -1

USERNAME => s148600 DGN FILE => 0112000300pa001.dgn RELATIVE BORDER SCALE IS IN INCHES UNIT 0306 BORDER LAST REVISED 7/2/2010

PROJECT NUMBER & PHASE

<u>EGEND:</u>	ABBRE V
---------------	---------

/IATIONS:

FIBER REINFORCED MATRIX

HYDRAULIC BIOTIC GROWTH MEDIUM

POST MILES SHEET TOTAL TOTAL PROJECT No. SHEETS Dist COUNTY ROUTE 41.8/42.3 Men M300 LICENSED LANDSCAPE ARCHITECT PLANS APPROVAL DATE Renewal Date THE STATE OF CALIFORNIA OR ITS OFFICERS OR AGENTS SHALL NOT BE RESPONSIBLE FOR THE ACCURACY OR COMPLETENESS OF SCANNED COPIES OF THIS PLAN SHEET.

EROSION CONTROL (TYPE 2), FOR >2:1

EROSION CONTROL (TYPE 1), FOR 2:1 OR FLATTER

\*\*\*\*\* FIBER ROLLS

CS COMPOST SOCK, AT TOE OF CUT SLOPE

DUFF BERM, AT TOE OF FILL SLOPE

#### **EROSION CONTROL (TYPE 1)**

SEQUENCE	ITEM	MATER	APPLICATION	
SEQUENCE	I I E IVI	DESCRIPTION TYPE		RATE
STEP 1	DUFF	DUFF		SPREAD TO A UNIFORM THICKNESS
	HYDRAULIC	SEED	SEED MIX	40 LB/AC
STEP 2	BIOTIC GROWTH MEDIUM	HBGM		1000 LB/ACRE
STEP 3	FIBER REINFORCED MATRIX	FRM		1500 LB/ACRE

# **EROSION CONTROL (TYPE 2)**

SEQUENCE	ITEM	MATER	APPLICATION	
SEQUENCE	I I CIVI	DESCRIPTION	TYPE	RATE
	HYDRAULIC	SEED	SEED MIX	40 LB/AC
STEP 1	BIOTIC GROWTH MEDIUM	HBGM		1000 LB/ACRE
STEP 2	FIBER REINFORCED MATRIX	FRM		1500 LB/ACRE

#### FIBER ROLLS

CEOUENCE	ITEM	MATER	REMARKS		
SEQUENCE	I I CIVI	DESCRIPTION	TYPE	NEWANKS	
INSTALL BEFORE EC (TYPE 1) AND EC (TYPE 2)	FIBER ROLLS	FIBER ROLL	10" TO 12" Dia	TYPE 1 INSTALLATION	

#### COMPOST SOCK

CEOUENCE	ITEM	MATER	REMARKS	
SEQUENCE	11 - 101	DESCRIPTION	TYPE	NEWARKS
INSTALL BEFORE EC (TYPE 1) AND EC (TYPE 2)	COMPOST SOCK	COMPOST FILLED BIODEGRADEABLE TUBE	8" Dia	INSTALL STAKE ADJACENT TO BOTTOM EDGE

#### **DUFF BERM**

CEOUENCE	ITEM	MATER	RIAL	APPLICATION	
SEQUENCE	I I E IVI	DESCRIPTION	TYPE	RATE	
INSTALL BEFORE EC (TYPE 1) AND EC (TYPE 2)	DUFF BERM	DUFF		0.037 CY/LF	

#### RECP (NETTING)

CEOUENCE	ITEM	MATER	RIAL	REMARKS		
SEQUENCE	11 - 101	DESCRIPTION TYPE		REMARKS		
INSTALL BEFORE EC (TYPE 1) AND EC (TYPE 2)	RECP (NETTING)	COIR NETTING	TYPE A	8-GAUGE, 8-INCH STEEL STAPLE		

#### SEED MIX

OLED WIX						
BOTANICAL NAME (COMMON NAME)	PERCENT GERMINATION (MINIMUM)	POUNDS PURE LIVE SEED PER ACRE (SLOPE MEASUREMENT)				
ACHILLEA MILLEFOLIUM (YARROW)	60	.5				
ARTEMISIA CALIFORNICA (COASTAL SAGEBRUSH)	20	1				
DESCHAMPSIA CESPITOSA (TUFTED HAIR GRASS)	50	10				
ERIOPHYLLUM STAECHADIFOLIUM (SEASIDE WOOLLY SUNFLOWER)	30	2				
FESTUCA MICROSTACHYS (SMALL FESCUE)	45	3				
FESTUCA RUBRA (RED FESCUE)	60	6				
LUPINUS BICOLOR (MINIATURE LUPINE)	60	5				
MIMULUS AURANTIACUS (STICKY MONKEY FLOWER)	30	.5				
STIPA PULCHRA (PURPLE NEEDLEGRASS)	60	12				

**EROSION CONTROL LEGEND** 


ECL-1


USERNAME => s148600 DGN FILE => 0112000300+c001.dgn BORDER LAST REVISED 7/2/2010

RELATIVE BORDER SCALE
IS IN INCHES

UNIT 0314

PROJECT NUMBER & PHASE

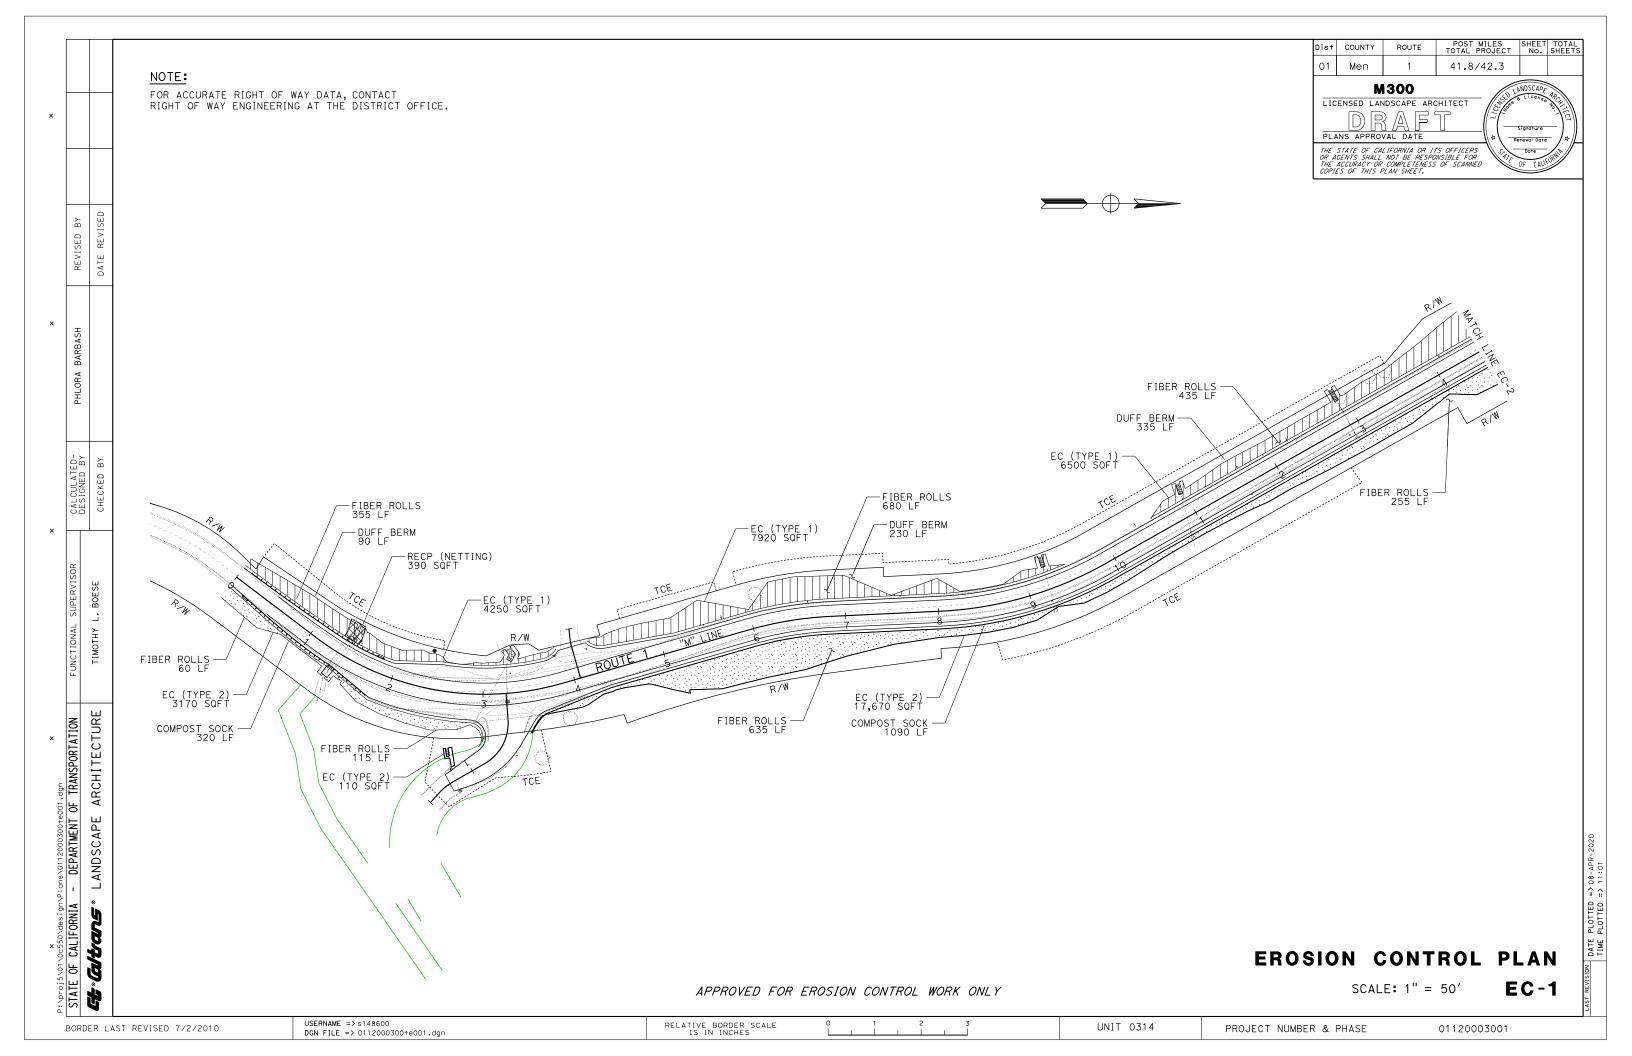

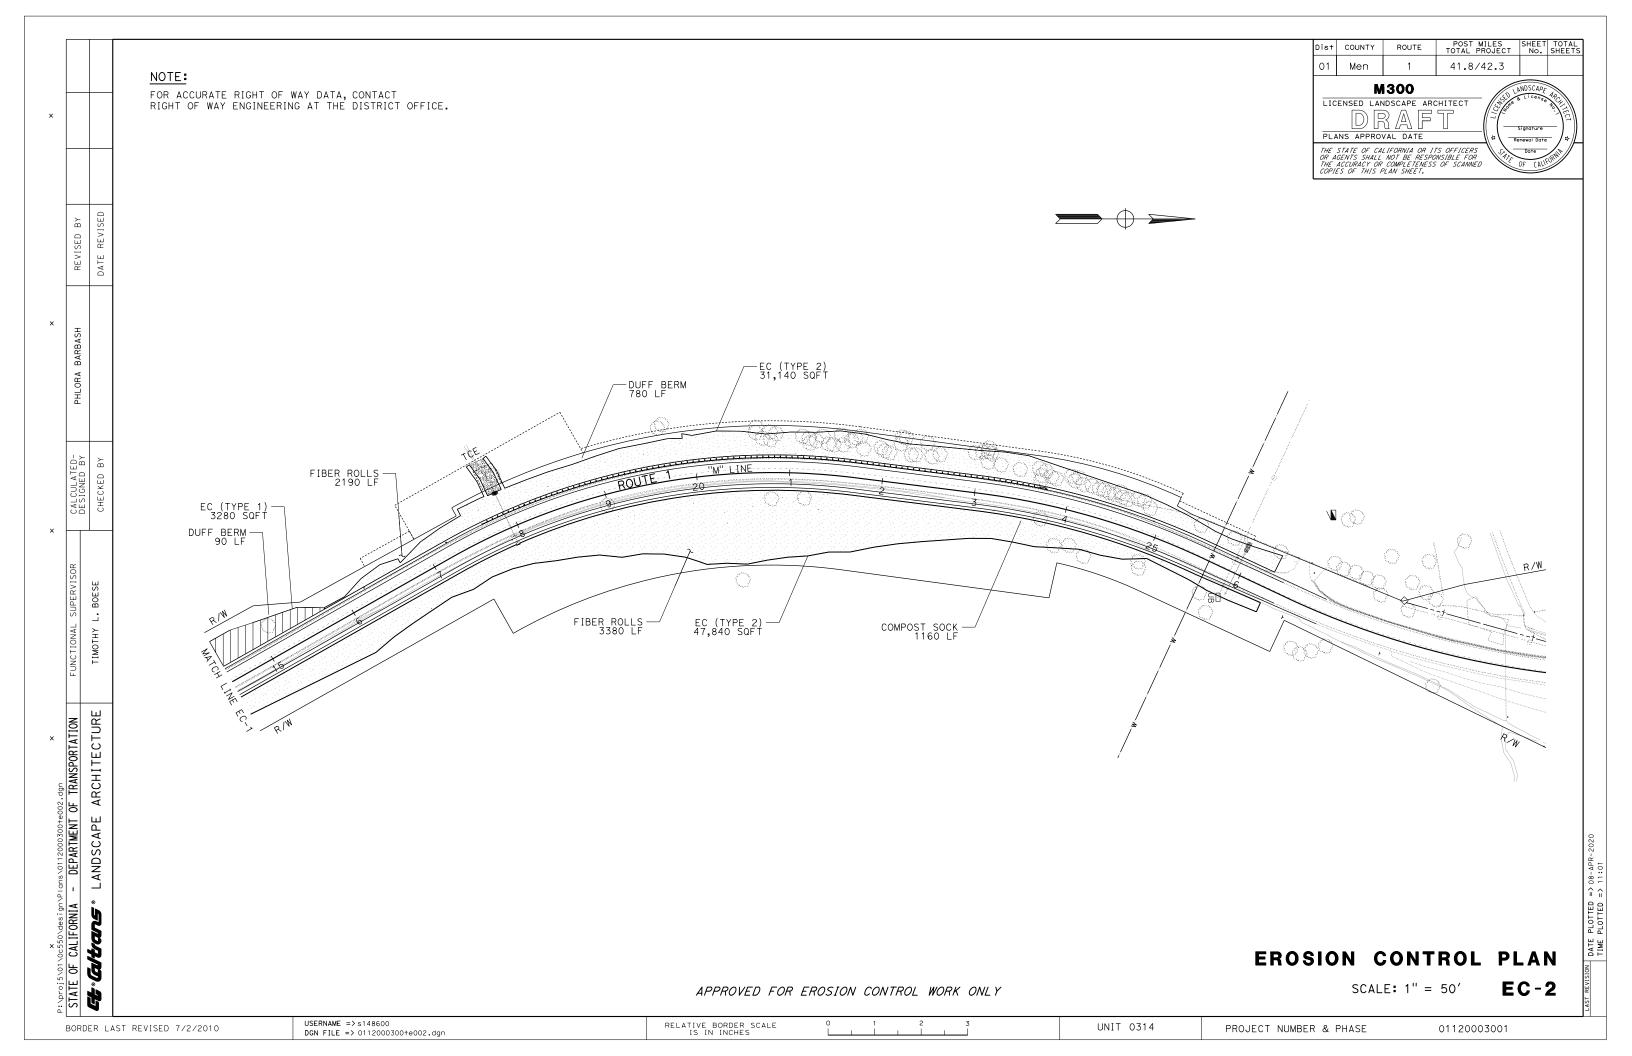


Dist	COUNTY	ROUTE	POST MILES TOTAL PROJECT	SHEET No.	TOTAL SHEETS			
01	Men	1	41.8/42.3					
	M	300		ANDSCAPE	\$ /			
LICENSED LANDSCAPE ARCHITECT								
PLA	INS APPROV	VAL DATE		Signature	- )* - )*			
OR A	GENTS SHALL	LIFORNIA OR II NOT BE RESPO COMPLETENESS PLAN SHEET.	TS OFFICERS SATE	OF (AL	$\mathcal{L}/\mathcal{I}$			

## **EROSION CONTROL QUANTITIES**

EC SHEET	DESCRIPTION	S FIBER REINFORCED	S HYDRAULIC BIOTIC	구 FIBER ROLLS	T COMPOST SOCK	귀 DUFF BERM	DUFF (SQFT)	RECP (NETTING)
	EC (TYPE 1)	18,670	18,670				18,670	
1	EC (TYPE 2)	20,950	20,950					
	RECP (NETTING)							390
	FIBER ROLL			2660				
	COMPOST SOCK				1410			
	DUFF BERM					655		
2	EC (TYPE 1)	3280	3280				3280	
	EC (TYPE 2)	78,980	78,980					
	FIBER ROLL			5570				
	COMPOST SOCK				1160			
	DUFF BERM					780		
TOTAL		121,880	121,880	8230	2570	1435	21,950	390

D MOVE-IN/MOVE-OUT (EROSION CONTROL)

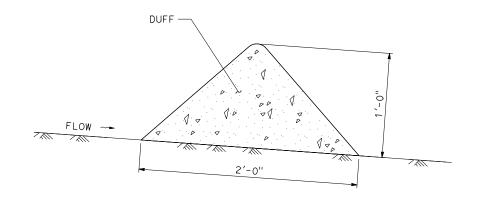

SECTION (Typ)

DUFF BERM

NO SCALE

EROSION CONTROL QUANTITIES ECQ-1

(ISION DATE PLOTTED => 08-APR. TIME PLOTTED => 11:01

BORDER LAST REVISED 7/2/2010 USERNAME => \$148600 DGN FILE => 0112000300+g001.dgn

PRINCE OF CALIFORNIA - DEPARTMENT OF TRANSPORTATION

STATE OF CALIFORNIA - DEPARTMENT OF TRANSPORTATION

GEVENITY OF TRANSPORTATION

RELATIVE BORDER SCALE
IS IN INCHES

2 3

UNIT 0314

PROJECT NUMBER & PHASE