

COUNTY OF MENDOCINO DEPARTMENT OF PLANNING AND BUILDING SERVICES

860 NORTH BUSH STREET · UKIAH · CALIFORNIA · 95482 120 WEST FIR STREET · FT. BRAGG · CALIFORNIA · 95437 BRENT SCHULTZ, DIRECTOR TELEPHONE: 707-234-6650 FAX: 707-463-5709 FB PHONE: 707-964-5379 FB FAX: 707-961-2427 pbs@mendocinocounty.org www.mendocinocounty.org/pbs

July 15, 2020

Environmental Health - Ukiah Building Inspection - Ukiah Assessor Air Quality Management CalFire - Prevention Cloverdale Rancheria Redwood Valley Rancheria Sherwood Valley Band of Pomo Indians Potter Valley Tribe

CASE#: AP_2020-0020 **DATE FILED**: 5/5/2020

OWNER: DYLAN O'FERRALL APPLICANT: VERIZON

AGENT: CROWN CASTLE, ANTHONY RHEE

REQUEST: Administrative Permit to add a 30 kW electricity generator with a 300 gallon belly tank that includes extended vents. The generator will be installed on a new 5 ft. by 10 ft. concrete pad within the existing wireless

communications lease area.

LOCATION: 1± miles northeast of Potter Valley town center, lying on the east side of Eel River Road (CR 240B), 0.6± miles north of its intersection with Main Street (CR 245) located at 12531 Eel River Road, Potter Valley

(APN: 175-010-10).

ENVIRONMENTAL DETERMINATION: Categorically Exempt

SUPERVISORIAL DISTRICT: 1

STAFF PLANNER: KEITH GRONENDYKE **RESPONSE DUE DATE:** July 29, 2020

PROJECT INFORMATION CAN BE FOUND AT:

https://www.mendocinocounty.org/government/planning-building-services/public-agency-referrals

Mendocino County Planning & Building Services is soliciting your input, which will be used in staff analysis and forwarded to the appropriate public hearing. You are invited to comment on any aspect of the proposed project(s). Please convey any requirements or conditions your agency requires for project compliance to the project coordinator at the above address, or submit your comments by email to pbs@mendocinocounty.org. Please note the case number and name of the project coordinator with all correspondence to this department.

| Ve have reviewed the above application and recommend the following (please check one): | | | | | | | |
|--|---|---|--|--|--|--|--|
| ☐ No comment at this time. | | | | | | | |
| Recommend conditional appro | Recommend conditional approval (attached). | | | | | | |
| | Applicant to submit additional information (attach items needed, or contact the applicant directly, copying Planning and Building Services in any correspondence you may have with the applicant) | | | | | | |
| Recommend denial (Attach rea | asons for recommending denial). | | | | | | |
| Recommend preparation of an | Environmental Impact Report (atta | ach reasons why an EIR should be required). | | | | | |
| Other comments (attach as necessary). | | | | | | | |
| | | | | | | | |
| | | | | | | | |
| REVIEWED BY: | | | | | | | |
| Signature | Department | Date | | | | | |

CASE: AP_2020-0020 (Verizon)

OWNER: **DYLAN O'FERRALL**

APPLICANT: VERIZON WIRELESS

CROWN CASTLE, ANTHONY RHEE AGENT:

REQUEST: Administrative Permit to add a 30 kW electricity generator with a 300 gallon belly tank that includes

extended vents. The generator will be installed on a new 5 ft. by 10 ft. concrete pad within the

existing wireless communications lease area

LOCATION: 1± miles northeast of Potter Valley town center, lying on the east side of Eel River Road (CR

240B), 0.6± miles north of its intersection with Main Street (CR 245) located at 12531 Eel River

Road, Potter Valley (APN: 175-010-10).

APN: 175-010-10

PARCEL SIZE: 40± Acres

GENERAL PLAN: Rangeland (RL 160)

Rangeland (RL 160) **ZONING:**

EXISTING USES: Cellular Antenna site

SUPERVISORAL

1st District (Brown) **DISTRICT:**

RELATED CASES: Use Permit Renewal, UR_2019-0004. Application to renew the original use permit that had expired;

approved. Administrative Permit, AP 2017-0097. Application to add new antennas to the existing tower; approved. Administrative Permit, AP_2016-0035. Application to add new antennas to the existing tower; approved. Administrative Permit, AP_2016-0020. Application to add an emergency electricity generator; approved. Administrative Permit, AP_2014-0034. Application to add three additional panel antennas to the existing tower; approved. Administrative Permit, AP_2014-0022. Application to add a microwave dish to the existing tower; approved. Use Permit Modification, UM_2009-0008. Application to add three new panel antennas and an additional microwave dish to the existing tower; approved. Use Permit, U_2006-0016. Application to construct a sixty-five foot

tall monopole; approved.

| | ADJACENT GENERAL PLAN | ADJACENT ZONING | ADJACENT LOT SIZES | ADJACENT USES |
|--------|--------------------------|----------------------|-----------------------|-----------------------|
| NORTH: | Range Lands (RL 160) | Range Lands (RL 160) | 40± Acres | Barn-Agricultural |
| EAST: | Range Lands (RL 160) | Range Lands (RL 160) | 80± Acres | Barn-Agricultural |
| SOUTH: | Agricultural (AG 40) | Agricultural (AG 40) | 43± Acres | SFD-Barn-Agricultural |
| WEST: | Range Lands (RL 160) | Range Lands (RL 160) | 6.5± Acres | Vacant |

REFERRAL AGENCIES

| L | O | C | F | ٩L | |
|---------------|---|---|---|----|--|
| $\overline{}$ | 7 | | | _ | |

Air Quality Management District

Assessor's Office **Building Division**

Environmental Health

<u>STATE</u>

CALFIRE (Land Use)

DATE: 7/7/2020

□ Potter Valley Tribe

TRIBAL

Cloverdale Rancheria

Redwood Valley Rancheria

STAFF PLANNER: KEITH GRONENDYKE

ENVIRONMENTAL DATA

2. FIRE HAZARD SEVERITY ZONE: High

3. FIRE RESPONSIBILITY AREA: Calfire

4. FARMLAND CLASSIFICATION: G

5. FLOOD ZONE CLASSIFICATION: N/A

6. COASTAL GROUNDWATER RESOURCE AREA:

N/A

7. SOIL CLASSIFICATION: Eastern Soils

8. PYGMY VEGETATION OR PYGMY CAPABLE

SOIL: N/A

1. MAC: N/A

9. WILLIAMSON ACT CONTRACT: Yes, non-prime

10. TIMBER PRODUCTION ZONE: No

11. WETLANDS CLASSIFICATION: N/A

12. EARTHQUAKE FAULT ZONE: No

13. AIRPORT LAND USE PLANNING AREA: No

14. SUPERFUND/BROWNFIELD/HAZMAT SITE: No

15. NATURAL DIVERSITY DATABASE: No

16. STATE FOREST/PARK/RECREATION AREA

ADJACENT: N/A

17. LANDSLIDE HAZARD: N/A

18. WATER EFFICIENT LANDSCAPE REQUIRED: No


19. WILD AND SCENIC RIVER: N/A

20. SPECIFIC PLAN/SPECIAL PLAN AREA: N/A

21. STATE CLEARINGHOUSE REQUIRED: No

22. OAK WOODLAND AREA: No

23. HARBOR DISTRICT: N/A

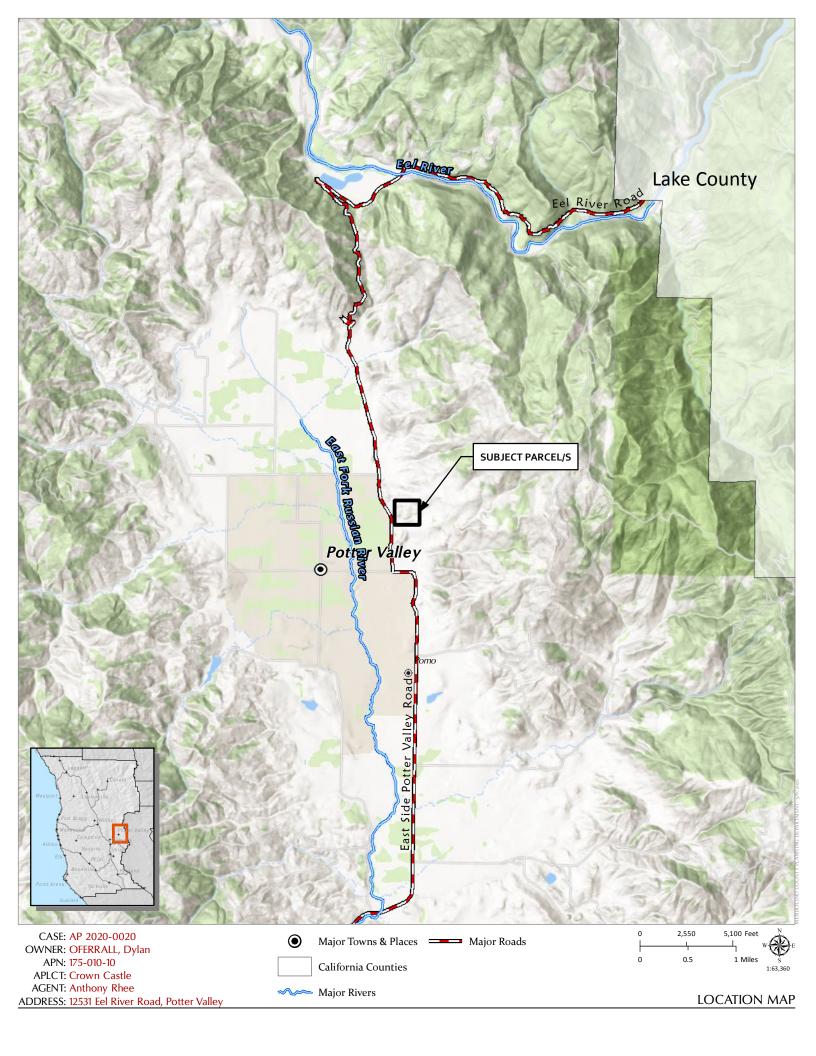



CASE: AP 2020-0020 OWNER: OFERRALL, Dylan APN: 175-010-10 APLCT: Crown Castle AGENT: Anthony Rhee ADDRESS: 12531 Eel River Road, Potter Valley

Wireless Sites



Planning and Building Services

| Case No: |
|--|
| CalFire No: Local Rosponse Agency - PV |
| Date Filed: 05-04-2020 |
| Fee: |
| Receipt No: PRI - |
| Received By: Jesse Davis |
| Office use only |

APPLICATION FORM

| | rizon (Project Contact: A own Castle; Agent of App | | th Phone: | 925-737-10 | 70 |
|--|---|---|---|---|------------------------|
| Mailing Address: 1 Park Pl | lace, Suite 300 Dublin CA 945 | 68 | | | |
| City: Dublin | State/Zi | o: CA | email: | anthony.rhee.contra | ctor@crowncastle.com |
| PROPERTY OW Name: | NER Dylan O'Ferrall | | Phone: | | |
| Mailing Address: 12531 Ee | el River Road, Pottery Valley (| CA 95469 | | | |
| City:Ukiah | State/Zi | o: CA | email: | | <u> </u> |
| AGENT Name: Antho | ony Rhee with Crowr | Castle | Phone: | 925-737-1070 | |
| | lace, Suite 300 Dublin CA 945 | 68 | | | |
| City:Dublin | State/Zi | o: CA | email: | anthony.rhee.conti | ractor@crowncastle.com |
| Parcel Size: | (Sq. feet/ | Acres) Address o | f Property: 12531 E | el River Road, Potter Val | ey CA 95469 |
| Assessor Parcel | Number(s): 175-010-10-0 | 0 | | | |
| TYPE OF APPLIC | CATION: | | | | |
| Administrative Agricultural Pr Airport Land U CDP- Admin CDP- Standar Certificate of C Development Exception | eserve Ise d Compliance | Flood Hazard General Plan A Land Division-N Land Division-P Land Division-P Land Division-P Modification of Reversion to Ad | Minor Major Parcel Resubdivision Conditions | ☐ Rezoning ☐ Use Permi ☐ Use Permi ☐ Use Permi ☐ Use Permi ☐ Variance ☐ Other | -Minor |
| l certify that the ii | nformation submitted wit | h this application | n is true and accu | rate. | |
| | 2.4 | | | r of Authorization orandum of Lease | |
| Anthony Rhee Signature of Applicar | Date: Eded 64:Ed 14:Ed:dE 61 66 | 9/2020 | Signature o | f Owner | Date |

SITE AND PROJECT DESCRIPTION QUESTIONNAIRE

The purpose of this questionnaire is to relate information concerning your application to the Department of Planning and Building Services and other agencies who will be reviewing your project proposal. Please remember that the clearer picture that you give us of your project and the site, the easier it will be to promptly process your application. Please answer all questions. Those questions which do not pertain to your project please indicate "Not applicable" or "N/A".

THE PROJECT

| 1. | Describe your project. Include secondary improvements such as wells, septic systems, grading, vegetation removal, roads, etc. | | | | | | | |
|-------------|---|--------------------|----------|----------|------------------------|-------------------|--|--|
| | Tower scope of work: Verizon to install generator and associated equipment. | | | | | | | |
| | Generator will be installed in existing footprint/compound. | | | | | | | |
| | Ref: BU 857683 APP 514421 | | | | | | | |
| | | | | | | | | |
| | | | | | | | | |
| | | | | · · · · | | | | |
| | | | | | | | | |
| | | | | | | | | |
| | | | | | | | | |
| | | | | | | | | |
| | | | | | | | | |
| | | 78 | p.com | | 141 | | | |
| | | | 611.4 | | | | | |
| 2. S | Structures/Lot Coverage | Number Existing | Proposed | Existing | Square Footag Proposed | e Total | | |
| | Single Family Mobile Home Duplex Multifamily Other: Unmanned Telecom Facility Other: | | | | | | | |
| Area L | Structures Paved Landscaped Area proved Area | | | | | | | |
| GRA | ND TOTAL (Equal to gross area | of Parcel) | | | | | | |

| 3. | If the project is commercial, industrial or institutional, complete the following: |
|----|---|
| | Estimated employees per shift: 0 |
| | Estimated shifts per day: 0 |
| | Type of loading facilities proposed: None |
| 4. | Will the proposed project be phased? ☐ Yes ■ No If yes, explain your plans for phasing: |
| | |
| | |
| 5. | Will vegetation be removed on areas other than the building sites and roads? ☐Yes ■No Explain: |
| | |
| | |
| 6. | Will the project involve the use or disposal of potentially hazardous materials such as toxic substances, flammables or explosives? No If yes, explain: |
| | Diesel generator; 300 Gal. See sheet E-4 for details. |
| | |
| | |
| 7. | How much off-street parking will be provided? N/A Unmanned telecomm facility Number Size |
| | Number of covered spaces |
| | Number of uncovered spaces Number of standard spaces |
| | Number of handicapped spaces |
| | Existing Number of Spaces Proposed Additional Spaces |
| | Total |
| 8. | Is any road construction or grading planned? |
| | |
| | |
| | |
| 9. | For grading or road construction, complete the following: |
| | A. Amount of cut cubic yards |
| | B. Amount of fill cubic yards C. Maximum height of fill slope feet |
| | C. Maximum height of fill slope feet D. Maximum height of cut slope feet |
| | E. Amount of import or export cubic yards |
| | F. Location of borrow or disposal site |
| | |

| 10. | Does the project involve sand removal, mining or gravel extraction? If yes, detailed extraction, reclamation and monitoring plans may be required? |
|-----|---|
| 11. | Will the proposed development convert land currently or previously used for agriculture to another use? ☐Yes ■No |
| | If yes, how many acres will be converted?acres. An agricultural economic feasibility study may be required. |
| 12. | Will the development provide public or private recreational opportunities? ☐Yes ☐No If yes, explain below: |
| | |
| | |
| 13. | Is the proposed development visible from State Highway 1 or other scenic route? Yes No 14. Is the proposed development visible from a park, beach or other recreational area? Yes No |
| 15. | Does the development involve diking, filling, dredging or placing structures in open coastal water, wetlands, estuaries or lakes? None |
| | Diking: |
| | If so, amount of material to be dredged or filled?cubic yards. |
| | Location of dredged material disposal site? Has a U.S. Army Corps of Engineers permit been applied for? □Yes ■No |
| 16. | Will there be any exterior lighting? Yes No If yes, describe below and identify the location of all exterior lighting on the plot plan and building plans. |
| 17. | Utilities will be supplied to the site as follows: A. Electricity: Utility Company (service exists to the parcel) Utility Company (requires extension of service to site:feetmiles) On Site Generation - Specify: Proposed scope of work is to provide on generation for back up. B. Gas: Utility Company/Tank On Site Generation - Specify: |
| | C. Telephone: Yes No |
| 18. | What will be the method of sewage disposal? N/A Community sewage system - Specify supplier Septic Tank Other - Specify: |
| 19. | What will be the domestic water source: N/A Community water system - Specify supplier Well Spring Other - Specify: |

| 20. | | ` ' | | properties under your | | | |
|-----|--|-------------------------------------|---|--|---|------------------------------------|--------------------|
| | ■Yes | ∐No | • • • • | | el Number, address, etc.) | | |
| | Adjacent property of | wned by same pr | roperty owner: APN: 1 | 75-060-03-00, 175-010-0 | 9-00 | | |
| | | | | | | | |
| | | | | | | - | |
| 21. | | • | · · | ner public approval rec and federal agencies: | quired for this project, incl | uding those rec | quired |
| | | | | | | | _ |
| 22. | Describe the local intersections, etc East of East Canal | .): | - | identifiable landmarks | s (e.g., mailboxes, mile po | osts, street | |
| | East of East Carlai | river and Manon | Gliaid Cellais. | | | | - |
| | | | | · | | | - |
| | | | | | | | |
| 23. | Are there existing If yes, describe to subdivision. | | | ■Yes □No structure on the plot | plan or tentative map if the | ne proposal is f | or a |
| | Existing cell tower | on site; scope of | work will pertain to the | cell tower only. | | | _ |
| | | | | | | | _ |
| | | | | | | | _ |
| 24. | | | demolished or remo elopment to be dem | | No ncluding the relocation sit | e, if applicable | |
| | | | | | | | _ |
| | | | | | | | _ |
| 25. | Project Height. I | Maximum heigh | t of existing structu | res_ ^{158'} feet. Maxim | um height of proposed st | ructures_158' | _feet. |
| 26. | | | | | d parking and accessory and accessory buildings) | | ss floor |
| 27. | Lot area (within i | oroperty lines):_ | 2304 | re feet □acres. | | | |
| 28. | | l stability, plant feel would be | s and animals, and helpful. | | nformation on existing str I or scenic aspects. Atta | | |
| | | | | | | | |
| | | | | | | | |
| 29. | Briefly describe taspects. Indicate that you feel wor | e the type of lai | properties, includir nd use (use chart b | ng information on plan pelow) and its general | ts, animals and any cultu intensity. Attach any pho | ral, historic or sotographs of the | scenic vicinity |
| | | | | | | | |
| 30. | Indicate the s | surrounding land | d uses: North | East | South | West | |
| | Vacant | | | | | | |
| | Residential Agric Commercial Indus | | | | | | |
| | Institutional Timbe | | | | | | |
| | Other | | | | | | |

verizon

VERIZON SITE NUMBER: 110914

VERIZON SITE NAME:

SITE TYPE: **MONOPOLE**

TOWER HEIGHT:

BUSINESS UNIT #:

CA371 - POTTER VALLEY SITE ADDRESS:

COUNTY:

JURISDICTION: **VERIZON N/A**

857683

LOCATION MAP

GET ON CA-99 S IN TULARE COUNTY FROM CA-43 S AND CA-198 E FOR 17.9 MI, FOLLOW CA-99 S AND CA-58 E TO CA-202 W/CA-58B/TUCKER RD IN

KERN COUNTY. TAKE EXIT 148 FROM CA-58 E FOR 111 MI, CONTINUE ON CA-202 W/W VALLEY BLVD. TAKE BEAR VALLEY RD AND DEERTRAIL DR

12531 EEL RIVER ROAD POTTER VALLEY, CA 95469

MENDOCINO

MENDOCINO COUNTY



VERIZON SITE NUMBER: 110914

BU #: **857683 CA371 - POTTER VALLEY**

12531 EEL RIVER ROAD POTTER VALLEY, CA 95469

EXISTING 65'-0" MONOPOLE

| ISSUED FOR: | | | | | | |
|-------------|----------|------|----------------|---------|--|--|
| REV | DATE | DRWN | DESCRIPTION | DES./QA | | |
| Α | 03/17/20 | AK | PRELIMINARY | CW | | |
| 0 | 04/09/20 | AK | SUBMITTAL CD'S | CW | | |
| | | | | | | |

IT IS A VIOLATION OF LAW FOR ANY PERSON INLESS THEY ARE ACTING UNDER THE DIRECTION

SHEET NUMBER



SITE INFORMATION

SITE NAME SITE ADDRESS:

LATITUDE:

LONGITUDE:

CA371 - POTTER VALLEY 12531 EEL RIVER ROAD POTTER VALLEY, CA 95469

MAP/PARCEL#: AREA OF CONSTRUCTION:

175-010-10-00 EXISTING 39° 19' 52.90" N 123° 5' 53.20" W NAD83

LAT/LONG TYPE CURRENT ZONING: JURISDICTION:

RL (RANGELAND) MENDOCINO COUNTY

OCCUPANCY CLASSIFICATION: U

TYPE OF CONSTRUCTION: A.D.A. COMPLIANCE:

FACILITY IS UNMANNED AND NOT FOR HUMAN HABITATION

PROPERTY OWNER:

5820 STONERIDGE MALL ROAD, SUITE 300

PLEASANTON, CA 94588

TOWER OWNER:

CROWN CASTLE 2000 CORPORATE DRIVE CANONSBURG, PA 15317

APPLICANT/CARRIER:

VERIZON

126 W. GEMINI DRIVE TEMPE, AZ 85283

ELECTRIC PROVIDER:

CROWN CASTLE USA INC. APPLICATION ID:

514421

PACIFIC GAS & ELECTRIC

TELCO PROVIDER:

FIBER APP

INSTALL (6) BOLLARDS

PROJECT TEAM

TELCYTE A&E FIRM:

TELCYTE INFRASTRUCTURE SERVICES 3450 N HIGLEY RD - SUITE 102 MESA AZ 85215 CWOLFE@TELCYTE.COM

CROWN CASTLE USA INC. DISTRICT CONTACTS:

1 PARK PLACE, SUITE 300 DUBLIN, CA 94568

SHANNA PYKA - PROJECT MANAGER

GARY HORACE - CONSTRUCTION MANAGER

VERIZON CONTACTS: WENDY SCHWIMER - PROJECT MANAGER

LORRAINE DAVIES - REAL ESTATE SPECIALIST MARCI BRAWLEY - CONSTRUCTION MANAGER

DRAWING INDEX

65'-0"

| SHEET DESCRIPTION |
|-------------------------------|
| TITLE SHEET |
| GENERAL NOTES |
| OVERALL SITE PLAN |
| SITE PLAN |
| EXISTING AND FINAL ELEVATIONS |
| DETAILS |
| DETAILS - |
| DETAILS |
| DETAILS |
| DETAILS |
| |
| |
| |
| |

ALL DRAWINGS CONTAINED HEREIN ARE FORMATTED FOR 22X34. CONTRACTOR SHALL VERIFY ALL PLANS AND EXISTING DIMENSIONS ND CONDITIONS ON THE IOB SITE AND SHALL IMMEDIATELY NOTIFY THE ENGINEER IN WRITING OF ANY DISCREPANCIES BEFORE PROCEEDING WITH THE WORK OR BE RESPONSIBLE FOR SAME

PROJECT DESCRIPTION

THE PURPOSE OF THIS PROJECT IS TO PROPOSE AN ANTENNA MODIFICATION ON AN EXISTING WIRELESS SITE.

• INSTALL (1) VERIZON GENERATOR W/ ASSOCIATED EQUIPMENT

DESIGN PACKAGE BASED ON APPLICATION REVISION: 0

APPROVALS

THE FOLLOWING PARTIES HEREBY APPROVE AND ACCEPT THESE DOCUMENTS AND AUTHORIZE THE CONTRACTOR TO PROCEED WITH THE CONSTRUCTION DESCRIBED HEREIN. ALL CONSTRUCTION DOCUMENTS ARE SUBJECT TO REVIEW BY THE LOCAL BUILDING DEPARTMENT AND ANY CHANGES AND MODIFICATIONS THEY MAY

PRINT NAME SIGNATURE DATE

| | THE THEFT | STOTATION | DATE |
|------------------------|-----------|-----------|------|
| INTERNAL REVIEW | | | |
| CONSTRUCTION SIGNATURE | <u> </u> | | |
| RF SIGNATURE | | | |
| REAL ESTATE SIGNATURE | | | |

APPLICABLE CODES/REFERENCE **DOCUMENTS**

ALL WORK SHALL BE PERFORMED AND MATERIALS INSTALLED IN ACCORDANCE WITH THE CURRENT EDITIONS OF THE FOLLOWING CODES AS ADOPTED BY THE LOCAL GOVERNING AUTHORITIES. NOTHING IN THESE PLANS IS TO BE CONSTRUED TO PERMIT WORK NO CONFORMING TO THESE CODES:

CODE TYPE

TO SURREY WAY IN BEAR VALLEY SPRINGS

2019 CALIFORNIA BUILDING CODE/2018 IBC MECHANICAL 2019 CALIFORNIA BUILDING CODE/ 2018 UMC ELECTRICAL 2019 CALIFORNIA ELECTRICAL CODE/ 2017 NEC

DRIVING DIRECTIONS FROM VERIZON LOCAL OFFICE (4502 10TH AVE HANFORD, CA 93230)

REFERENCE DOCUMENTS: STRUCTURAL ANALYSIS: BY OTHERS

MOUNT ANALYSIS: BY OTHERS



CALL CALIFORNIA ONE CALL (800) 227-2600 CALL 3 WORKING DAYS

SITE PHOTO:

NO SCALE

SITE WORK GENERAL NOTES:

- 1. THE SUBCONTRACTOR SHALL CONTACT UTILITY LOCATING SERVICES PRIOR TO THE START OF CONSTRUCTION.
- 2. ALL EXISTING ACTIVE SEWER, WATER, GAS, ELECTRIC AND OTHER UTILITIES WHERE ALL EXISTING ACTIVE SEWER, WATER, GAS, ELECTRIC AND OTHER UTILITIES WHERE ENCOUNTERED IN THE WORK, SHALL BE PROTECTED AT ALL TIMES AND WHERE REQUIRED FOR THE PROPER EXECUTION OF THE WORK, SHALL BE RELOCATED AS DIRECTED BY CONTRACTOR. EXTREME CAUTION SHOULD BE USED BY THE SUBCONTRACTOR WHEN EXCAVATING OR DRILLING PIERS AROUND OR NEAR UTILITIES, SUBCONTRACTOR SHALL PROVIDE SAFETY TRAINING FOR THE WORKING CREW, THIS WILL INCLUDE BUT NOT BE LIMITED TO A) FALL PROTECTION B) CONFINED SPACE C) ELECTRICAL SAFETY D) TRENCHING AND EXCAVATION.
- 3. ALL SITE WORK TO COMPLY WITH QAS-STD-10068 "INSTALLATION STANDARDS FOR CONSTRUCTION ACTIVITIES ON CROWN CASTLE TOWER SITE" AND LATEST VERSION OF TIA 1019 "STANDARD FOR INSTALLATION, ALTERATION, AND MAINTENANCE OF ANTENNA SUPPORTING STRUCTURES AND ANTENNAS."
- ALL SITE WORK SHALL BE AS INDICATED ON THE STAMPED CONSTRUCTION DRAWINGS AND PROJECT SPECIFICATIONS.
- IF NECESSARY, RUBBISH, STUMPS, DEBRIS, STICKS, STONES AND OTHER REFUSE SHALL BE REMOVED FROM THE SITE AND DISPOSED OF LEGALLY.
- 6. ALL EXISTING INACTIVE SEWER, WATER, GAS, ELECTRIC AND OTHER UTILITIES, WHICH INTERFERE WITH THE EXECUTION OF THE WORK, SHALL BE REMOVED AND/OR CAPPED, PLUGGED OR OTHERWISE DISCONTINUED AT POINTS WHICH WILL NOT INTERFERE WITH THE EXECUTION OF THE WORK, SUBJECT TO THE APPROVAL OF CONTRACTOR, OWNER AND/OR
- 7. THE SUBCONTRACTOR SHALL PROVIDE SITE SIGNAGE IN ACCORDANCE WITH THE TECHNICAL
- THE SITE SHALL BE GRADED TO CAUSE SURFACE WATER TO FLOW AWAY FROM THE BTS EQUIPMENT AND TOWER AREAS.
- NO FILL OR EMBANKMENT MATERIAL SHALL BE PLACED ON FROZEN GROUND. FROZEN MATERIALS, SNOW OR ICE SHALL NOT BE PLACED IN ANY FILL OR EMBANKMENT.
- 10. THE SUB GRADE SHALL BE COMPACTED AND BROUGHT TO A SMOOTH UNIFORM GRADE PRIOR TO FINISHED SURFACE APPLICATION.
- 11. THE AREAS OF THE OWNERS PROPERTY DISTURBED BY THE WORK AND NOT COVERED BY THE TOWER, EQUIPMENT OR DRIVEWAY, SHALL BE GRADED TO A UNIFORM SLOPE, AND STABILIZED TO PREVENT EROSION AS SPECIFIED ON THE PROJECT SPECIFICATIONS.
- 12. SUBCONTRACTOR SHALL MINIMIZE DISTURBANCE TO EXISTING SITE DURING CONSTRUCTION EROSION CONTROL MEASURES, IF REQUIRED DURING CONSTRUCTION, SHALL BE IN CONFORMANCE WITH THE LOCAL GUIDELINES FOR EROSION AND SEDIMENT CONTROL.
- 13 NOTICE TO PROCEED- NO WORK TO COMMENCE PRIOR TO COMPANY'S WRITTEN NOTICE TO PROCEED AND THE ISSUANCE OF A PURCHASE ORDER.
- 14. ALL CONSTRUCTION MEANS AND METHODS; INCLUDING BUT NOT LIMITED TO, ERECTION PLANS, RIGGING PLANS, CLIMBING PLANS, AND RESCUE PLANS SHALL BE THE RESPONSIBILITY OF THE GENERAL CONTRACTOR RESPONSIBLE FOR THE EXECUTION OF THE WORK CONTAINED HEREIN AND SHALL MEET ANSI/TIA 1019 (LATEST EDITION), OSHA, AND GENERAL INDUSTRY STANDARDS. ALL RIGGING PLANS SHALL ADHERE TO ANSI/TIA-1019 (LATEST EDITION) INCLUDING THE REQUIRED INVOLVEMENT OF A QUALIFIED ENGINEER FOR CLASS IV CONSTRUCTION.

STRUCTURAL STEEL NOTES:

- ALL STEEL WORK SHALL BE PAINTED IN ACCORDANCE WITH THE PROJECT SPECIFICATIONS AND IN ACCORDANCE WITH ASTM A36 UNLESS OTHERWISE NOTED.
- 2. BOLTED CONNECTIONS SHALL BE ASTM A325 BEARING TYPE (3/4%) CONNECTIONS AND SHALL HAVE MINIMUM OF TWO BOLTS UNLESS NOTED OTHERWISE.
- 3. NON-STRUCTURAL CONNECTIONS FOR STEEL GRATING MAY USE 5/8"Ø ASTM A3D7 BOLTS UNLESS NOTED OTHERWISE
- 4. INSTALLATION OF CONCRETE EXPANSION/WEDGE ANCHOR, SHALL BE PER MANUFACTURER'S RECOMMENDED PROCEDURE. THE ANCHOR BOLT, DOWEL OR ROD SHALL CONFORM TO MANUFACTURER'S RECOMMENDATION FOR EMBEDMENT DEPTH OR AS SHOWN ON THE DRAWINGS. NO REBAR SHALL BE CUT WITHOUT PRIOR CONTRACTOR APPROVAL WHEN DRILLING HOLES IN CONCRETE. SPECIAL INSPECTIONS, REQUIRED GOVERNING CODES, SHALL BE PERFORMED IN ORDER TO MAINTAIN MANUFACTURER'S MAXIMUM ALLOWABLE LOADS.

CONCRETE AND REINFORCING STEEL NOTES:

- ALL CONCRETE WORK SHALL BE IN ACCORDANCE WITH THE ACI 301, ACI 318, ACI 336, ASTM A184, ASTM A185 AND THE DESIGN AND CONSTRUCTION SPECIFICATION FOR CAST—IN-PLACE CONCRETE.
- ALL CONCRETE SHALL HAVE A MINIMUM COMPRESSIVE STRENGTH OF 3000 PSI AT 28 DAYS, UNLESS NOTED OTHERWISE. SLAB FOUNDATION DESIGN ASSUMING ALLOWABLE SOIL BEARING PRESSURE OF 2000 PSF.
- 3. REINFORCING STEEL SHALL CONFORM TO ASTM A615, GRADE 60, DEFORMED UNLESS NOTED OTHERWISE. WELDED WIRE FABRIC UNLESS NOTED STEEL WIRE FABRIC UNLESS NOTED OTHERWISE. SPLICES SHALL BE CLASS "B" AND ALL HOOKS SHALL BE STANDARD, UNO.
- 4. THE FOLLOWING MINIMUM CONCRETE COVER SHALL BE PROVIDED FOR REINFORCING STEEL UNLESS SHOWN OTHERWISE ON DRAWINGS:

CONCRETE CAST AGAINST FARTH. CONCRETE EXPOSED TO EARTH OR WEATHER GROUND: SLAB AND WALLS

BEAMS AND COLUMNS...... 1 1/2 IN.

5. A CHAMFER 3/4" SHALL BE PROVIDED AT ALL EXPOSED EDGES OF CONCRETE, UNLESS NOTED OTHERWISE. IN ACCORDANCE WITH ACI 301 SECTION 4.2.4

MASONRY NOTES:

- HOLLOW CONCRETE MASONRY UNITS SHALL MEET A.S.T.M. SPECIFICATION C90, GRADE N. TYPE 1. THE SPECIFIED DESIGN COMPRESSIVE STRENGTH OF CONCRETE MASONRY
- MORTAR SHALL MEET THE PROPERTY SPECIFICATION OF A.S.T.M. C270 TYP. " MORTAR AND SHALL HAVE A MINIMUM COMPRESSIVE STRENGTH OF 2000 PSI.
- GROUT SHALL MEET A.S.T.M. SPECIFICATION C475 AND HAVE A MINIMUM 28 DAY COMPRESSIVE STRENGTH OF 2000 PSI.
- 4. CONCRETE MASONRY SHALL BE LAID IN RUNNING (COMMON) BOND.
- 5. WALL SHALL RECEIVE TEMPORARY BRACING. TEMPORARY BRACING SHALL NOT BE REMOVED UNTIL GROUT IS FULLY CURED.

GENERAL NOTES:

1. FOR THE PURPOSE OF CONSTRUCTION DRAWING, THE FOLLOWING DEFINITIONS SHALL APPLY: SUBCONTRACTOR - GENERAL CONTRACTOR (CONSTRUCTION)

CARRIER- VERIZON
TOWER OWNER- CROWN CASTLE

ORIGINAL EQUIPMENT MANUFACTURER

- PRIOR TO THE SUBMISSION OF BIDS, THE BIDDING SUBCONTRACTOR SHALL VISIT THE CELL SITE TO FAMILIARIZE WITH THE EXISTING CONDITIONS AND TO CONFIRM THAT THE WORK CAN BE ACCOMPLISHED AS SHOWN ON THE CONSTRUCTION DRAWINGS. ANY DISCREPANCY FOUND SHALL BE BROUGHT TO THE ATTENTION OF CONTRACTOR AND CROWN CASTLE.
- 3. ALL MATERIALS FURNISHED AND INSTALLED SHALL BE IN STRICT ACCORDANCE WITH ALL APPLICABLE CODES, REGULATIONS AND ORDINANCES. SUBCONTRACTOR SHALL ISSUE ALL APPROPRIATE NOTICES AND COMPLY WITH ALL LAWS, ORDINANCES, RULES, REGULATIONS AND LAWFUL ORDERS OF ANY PUBLIC AUTHORITY REGARDING THE PERFORMANCE OF THE WORK, ALL WORK CARRIED DUT SHALL COMPLY WITH ALL APPLICABLE MUNICIPAL AND UTILITY COMPANY SPECIFICATIONS AND LOCAL JURISDICTIONAL CODES, ORDINANCES AND APPLICABLE MUNICIPAL TABLES. APPLICABLE REGULATIONS
- 4. DRAWINGS PROVIDED HERE ARE NOT TO SCALE AND ARE INTENDED TO SHOW OUTLINE
- UNLESS NOTED OTHERWISE, THE WORK SHALL INCLUDE FURNISHING MATERIALS, EQUIPMENT, APPURTENANCES AND LABOR NECESSARY TO COMPLETE ALL INSTALLATIONS AS INDICATED
- LIST" SUPPLIED WITH THE BID PACKAGE IDENTIFIES ITEMS THAT WILL BE SUPPLIED BY CONTRACTOR. ITEMS NOT INCLUDED IN THE BILL OF MATERIALS AND KITTING LIST SHALL BE SUPPLIED BY THE SUBCONTRACTOR.
- THE SUBCONTRACTOR SHALL INSTALL ALL EQUIPMENT AND MATERIALS IN ACCORDANCE WITH MANUFACTURER'S RECOMMENDATIONS UNLESS SPECIFICALLY STATED OTHERWISE.
- IF THE SPECIFIED EQUIPMENT CAN NOT BE INSTALLED AS SHOWN ON THESE DRAWINGS, THE SUBCONTRACTOR SHALL PROPOSE AN ALTERNATIVE INSTALLATION FOR APPROVAL BY THE CONTRACTOR AND CROWN CASTLE PRIOR TO PROCEEDING WITH ANY SUCH CHANGE OF INSTALLATION.
- SUBCONTRACTOR SHALL DETERMINE ACTUAL ROUTING OF CONDUIT, POWER AND T1 CABLES, GROUNDING CABLES AS SHOWN ON THE POWER, GROUNDING AND TELCO PLAN DRAWINGS.
- 10. THE SUBCONTRACTOR SHALL PROTECT EXISTING IMPROVEMENTS, PAVEMENTS, CURBS LANDSCAPING AND STRUCTURES. ANY DAMAGED PART SHALL BE REPAIRED AT SUBCONTRACTOR'S EXPENSE TO THE SATISFACTION OF OWNER.
- 11. SUBCONTRACTOR SHALL LEGALLY AND PROPERLY DISPOSE OF ALL SCRAP MATERIALS SUCH AS COAXIAL CABLES AND OTHER ITEMS REMOVED FROM THE EXISTING FACILITY. ANTENNAS REMOVED SHALL BE RETURNED TO THE OWNER'S DESIGNATED LOCATION.
- 12. SUBCONTRACTOR SHALL LEAVE PREMISES IN CLEAN CONDITION. TRASH AND DEBRIS SHOULD BE REMOVED FROM SITE ON A DAILY BASIS

SYMBOLS

-S/G- SOLID GROUND BUS BAR

SOLID NEUTRAL BUS BAR

SUPPLEMENTAL GROUND CONDUCTOR

2-POLE THERMAL-MAGNETIC CIRCUIT BREAKER

SINGLE-POLE THERMAL-MAGNETIC CIRCUIT BREAKER

ABBREVIATIONS AND SYMBOLS:

ABBREVIATIONS:

ABOVE GRADE LEVEL BASE TRANSCEIVER STATION

REFERENCE RADIO FREQUENCY

TO BE DETERMINED TO BE RESOLVED REQ EGR REQUIRED EQUIPMENT GROUND RING

AMERICAN WIRE GAUGE AMERICAN WIRE GAUGE
MASTER GROUND BAR
EQUIPMENT GROUND
BARE COPPER WIRE
SMART INTEGRATED ACCESS DEVICE
GENERATOR
INTERIOR GROUND RING (HALO)
RADIO BASE STATION MGB

□P DISCONNECT SWITCH M METER

 \otimes

FXOTHERMIC WELD (CADWELD) (UNLESS OTHERWISE NOTED)

CHEMICAL GROUND ROD

TEST WELL

MECHANICAL CONNECTION

GROUNDING WIRE

ELECTRICAL INSTALLATION NOTES

- ALL ELECTRICAL WORK SHALL BE PERFORMED IN ACCORDANCE WITH THE PROJECT SPECIFICATIONS, NEC AND ALL APPLICABLE FEDERAL, STATE, AND LOCAL CODES/ORDINANCES.
- CONDUIT ROUTINGS ARE SCHEMATIC. SUBCONTRACTOR SHALL INSTALL CONDUITS SO THAT ACCESS TO EQUIPMENT IS NOT BLOCKED AND TRIP HAZARDS ARE ELIMINATED.
- 3. WIRING, RACEWAY AND SUPPORT METHODS AND MATERIALS SHALL COMPLY WITH THE REQUIREMENTS OF THE NEC. HILTI EPOXY ANCHORS ARE REQUIRED BY CROWN CASTLE.
- 4. ALL CIRCUITS SHALL BE SEGREGATED AND MAINTAIN MINIMUM CABLE SEPARATION AS
- 5. CABLES SHALL NOT BE ROUTED THROUGH LADDER-STYLE CABLE TRAY RUNGS.
- EACH END OF EVERY POWER, POWER PHASE CONDUCTOR (I.E., HOTS), GROUNDING AND T1 CONDUCTOR AND CABLE SHALL BE LABELED WITH COLOR-CODED INSULATION OR ELECTRICAL TAPE (3M BRAND, 1/2" PLASTIC ELECTRICAL TAPE WITH UV PROTECTION,
- ALL ELECTRICAL COMPONENTS SHALL BE CLEARLY LABELED WITH PLASTIC TAPE PER COLOR SCHEDULE. ALL EQUIPMENT SHALL BE LABELED WITH THEIR VOLTAGE RATING, PHASE CONFIGURATION, WIRE CONFIGURATION, POWER OR AMPACITY RATING AND BRANCH CIRCUIT ID NUMBERS (I.E. PANEL BOARD AND CIRCUIT ID'S).
- PANEL BOARDS (ID NUMBERS) AND INTERNAL CIRCUIT BREAKERS (CIRCUIT ID NUMBERS) SHALL BE CLEARLY LABELED WITH PLASTIC LABELS.
- ALL TIE WRAPS SHALL BE CUT FLUSH WITH APPROVED CUTTING TOOL TO REMOVE SHARP EDGES.
- 10. POWER, CONTROL AND EQUIPMENT GROUND WIRING IN TUBING OR CONDUIT SHALL BE SINGLE CONDUCTOR (#14 AWG OR LARGER), 600 V, OIL RESISTANT THHN OR THWN-2, CLASS B STRANDED COPPER CABLE RATED FOR 90' C (WET & DRY) OPERATION LISTED OR LABELED FOR THE LOCATION AND RACEWAY SYSTEM USED UNLESS OTHERWISE
- 11. SUPPLEMENTAL EQUIPMENT GROUND WIRING LOCATED INDOORS SHALL BE SINGLE CONDUCTOR (#6 AWG OR LARGER), 600V, OIL RESISTANT THHIN OR THWN-2 GREEN INSULATION CLASS B STRANDED COPPER CABLE RATED FOR 90° C (WET AND DRY) OPERATION LISTED OR LABELED FOR THE LOCATION AND RACEWAY SYSTEM USED UNLESS OTHERWISE SPECIFIED
- 12 POWER AND CONTROL WIRING, NOT IN TUBING OR CONDUIT, SHALL BE MULTI-CONDUCTOR, TYPE TC CABLE (#14 AWG OR LARGER), 600 V, OIL RESISTANT THHN OR THWN-2, CLASS B STRANDED COPPER CABLE RATED FOR 90°C (WET AND DRY) OPERATION WITH OUTER JACKET LISTED OR LABELED FOR THE LOCATION USED UNLESS OTHERWISE SPECIFIED.
- 13. ALL POWER AND GROUNDING CONNECTIONS SHALL BE CRIMP—STYLE, COMPRESSION WIRE LUGS AND WIRE NUTS BY THOMAS AND BETTS (OR EQUAL). LUGS AND WIRE NUTS SHALL BE RATED FOR OPERATION AT NO LESS THAN 75°C (90°C IF
- 14. RACEWAY AND CABLE TRAY SHALL BE LISTED OR LABELED FOR ELECTRICAL USE IN ACCORDANCE WITH NEMA, UL, ANSI/IEEE AND NEC.
- 15. ELECTRICAL METALLIC TUBING (EMT) OR RIGID NONMETALLIC CONDUIT (I.E. RIGID PVC SCHEDULE 40 OR RIGID PVC SCHEDULE 80 FOR LOCATIONS SUBJECT TO PHYSICAL DAMAGE) SHALL BE USED FOR EXPOSED INDOOR LOCATIONS.
- 16. ELECTRICAL METALLIC TUBING (EMT), ELECTRICAL NONMETALLIC TUBING (ENT) OR RIGID NONMETALLIC CONDUIT (RIGID PVC, SCHEDULE 40) SHALL BE USED FOR CONCEALED INDOOR LOCATIONS.
- 17. SCHEDULE 40 PVC UNDERGROUND ON STRAIGHTS AND SCHEDULE 80 PVC FOR ALL ELBOWS/90s AND ALL APPROVED ABOVE GRADE PVC CONDUIT.
- 18. LIQUID-TIGHT FLEXIBLE METALLIC CONDUIT (LIQUID-TITE FLEX) SHALL BE USED INDOORS AND OUTDOORS, WHERE VIBRATION OCCURS OR FLEXIBILITY IS NEEDED.
- 19. CONDUIT AND TUBING FITTINGS SHALL BE THREADED OR COMPRESSION—TYPE AND APPROVED FOR THE LOCATION USED. SET SCREW FITTINGS ARE NOT ACCEPTABLE.
- 20. CABINETS, BOXES AND WIRE WAYS SHALL BE LABELED FOR ELECTRICAL USE IN ACCORDANCE WITH NEMA, UL, ANSI/IEEE AND NEC.
- 21. WIREWAYS SHALL BE EPOXY-COATED (GRAY) AND INCLUDE A HINGED COVER, DESIGNED TO SWING OPEN DOWNWARDS; SHALL BE PANDUIT TYPE E (OR EQUAL); AND RATED NEMA 1 (OR BETTER).
- 22. CONDUITS SHALL BE FASTENED SECURELY IN PLACE WITH APPROVED NON-PERFORATED . CONDUITS SHALL BE FASTENED SECURELY IN PLACE WITH APPROVED NON-PERFORATED STRAPS AND HANGERS EXPLOSIVE DEVICES FOR ATTACHING HANGERS TO STRUCTURE WILL NOT BE PERMITTED. CLOSELY FOLLOW THE LINES OF THE STRUCTURE, MAINTAIN CLOSE PROXIMITY TO THE STRUCTURE AND KEEP CONDUITS IN TIGHT ENVELOPES. CHANGES IN DIRECTION TO ROUTE AROUND OBSTACLES SHALL BE MADE WITH CONDUIT OUTLET BODIES. CONDUIT SHALL BE INSTALLED IN A NEAT AND WORKMANLIKE MANNER, PARALLEL AND PERPENDICULAR TO STRUCTURE WALL AND CELING LINES. ALL CONDUIT SHALL BE FISHED TO CLEAR OBSTRUCTIONS. ENDS OF CONDUITS SHALL BE TEMPORARILY CAPPED FLUSH TO FINISH GRADE TO PREVENT CONCRETE, PLASTER OR DIRT FROM ENTERING. CONDUITS SHALL BE RIGIDLY CLAMPED TO BOXES BY GALVANIZED MALLEABLE IRON BUSHING ON INSIDE AND GALVANIZED MALLEABLE IRON BUSHING ON INSIDE AND GALVANIZED MALLEABLE IRON BUSHING ON INSIDE
- 23. EQUIPMENT CABINETS, TERMINAL BOXES, JUNCTION BOXES AND PULL BOXES SHALL BE GALVANIZED OR EPOXY—COATED SHEET STEEL; SHALL MEET OR EXCEED UL 50 AND RATED NEMA 1 (OR BETTER) INDOORS OR NEMA 3R (OR BETTER) OUTDOORS.
- 24. METAL RECEPTACLE, SWITCH AND DEVICE BOXES SHALL BE GALVANIZED, EPOXY-COATED OR NON-CORRODING; SHALL MEET OR EXCEED UL 514A AND NEMA OS 1; AND RATED NEMA 1 (OR BETTER) INDOORS OR WEATHER PROTECTED (WP OR BETTER) OUTDOORS.
- 25. NONMETALLIC RECEPTACLE, SWITCH AND DEVICE BOXES SHALL MEET OR EXCEED NEMA OS 2; AND RATED NEMA 1 (OR BETTER) INDOORS OR WEATHER PROTECTED (WP OR BFTTER) OUTDOORS
- 26. THE SUBCONTRACTOR SHALL NOTIFY AND OBTAIN NECESSARY AUTHORIZATION FROM THE CONTRACTOR BEFORE COMMENCING WORK ON THE AC POWER DISTRIBUTION PANELS.
- THE SUBCONTRACTOR SHALL PROVIDE NECESSARY TAGGING ON THE BREAKERS, CABLES AND DISTRIBUTION PANELS IN ACCORDANCE WITH THE APPLICABLE CODES AND STANDARDS TO SAFEGUARD LIFE AND PROPERTY.
- 28. INSTALL PLASTIC LABEL ON THE METER CENTER TO SHOW "VERIZON".
- ALL CONDUITS THAT ARE INSTALLED ARE TO HAVE A METERED MULE TAPE PULL CORD INSTALLED.

GREENFIELD GROUNDING NOTES:

- ALL GROUND ELECTRODE SYSTEMS (INCLUDING TELECOMMUNICATION, RADIO, LIGHTNING PROTECTION AND AC POWER GES'S) SHALL BE BONDED TOGETHER AT OR BELOW GRADE, BY TWO OR MORE COPPER BONDING CONDUCTORS IN ACCORDANCE WITH THE NEC.
- THE SUBCONTRACTOR SHALL PERFORM IEEE FALL-OF-POTENTAL RESISTANCE TO EARTH TESTING (PER IEEE 1100 AND 81) FOR GROUN ELECTRODE SYSTEMS, THE SUBCONTRACTOR SHALL FURNISH AND INSTALL SUPPLEMENTAL GROUND ELECTRODES AS NEEDED TO ACHIEVE A TEST RESULT OF 5 OHMS OR LESS.
- 3. THE SUBCONTRACTOR IS RESPONSIBLE FOR PROPERLY SEQUENCING GROUNDING AND UNDERGROUND CONDUIT INSTALLATION AS TO PREVEN ANY LOSS OF CONTINUITY IN THE GROUNDING SYSTEM OR DAMAGE TO THE CONDUIT AND PROVIDE TESTING RESULTS.
- 4. METAL CONDUIT AND TRAY SHALL BE GROUNDED AND MADE ELECTRICALLY CONTINUOUS WITH LISTED BONDING FITTINGS OR BY BONDING ACROSS THE DISCONTINUITY WITH #6 AWG COPPER WIRE UL APPROVED GROUNDING TYPE CONDUIT CLAMPS.
- METAL RACEWAY SHALL NOT BE USED AS THE NEC REQUIRED EQUIPMENT GROUND CONDUCTOR STRANDED COPPER CONDUCTORS WITH GREEN INSULATION, SIZED IN ACCORDANCE WITH THE NEC, SH. BE FURNISHED AND INSTALLED WITH THE POWER CIRCUITS TO BTS
- EACH CABINET FRAME SHALL BE DIRECTLY CONNECTED TO THE MASTE GROUND BAR WITH GREEN INSULATED SUPPLEMENTAL EQUIPMENT GROUND WIRES, 6 AWG STRANDED COPPER OR LARGE FOR INDOOR BTS; #2 AWG SOLID TINNED COPPER FOR OUTDOOR BTS.
- CONNECTIONS TO THE GROUND BUS SHALL NOT BE DOUBLED UP OR STACKED BACK TO BACK CONNECTIONS ON OPPOSITE SIDE OF THE GROUND BUS ARE PERMITTED.
- 8. ALL EXTERIOR GROUND CONDUCTORS BETWEEN EQUIPMENT/GROUND BARS AND THE GROUND RING SHALL BE #2 AWG SOLID TINNED COPPER UNLESS OTHERWISE INDICATED.
- ALUMINUM CONDUCTOR OR COPPER CLAD STEEL CONDUCTOR SHALL NOT BE USED FOR GROUNDING CONNECTIONS.
- 10. USE OF 90' BENDS IN THE PROTECTION GROUNDING CONDUCTORS SHALL BE AVOIDED WHEN 45' BENDS CAN BE ADEQUATELY SUPPORTED
- 11. EXOTHERMIC WELDS SHALL BE USED FOR ALL GROUNDING CONNECTIONS BELOW GRADE
- ALL GROUND CONNECTIONS ABOVE GRADE (INTERIOR AND EXTERIOR) SHALL BE FORMED USING HIGH PRESS CRIMPS. 13. COMPRESSION GROUND CONNECTIONS MAY BE REPLACED BY
- EXOTHERMIC WELD CONNECTIONS. 14. ICE BRIDGE BONDING CONDUCTORS SHALL BE EXOTHERMICALLY BONDEL OR BOLTED TO THE BRIDGE AND THE TOWER GROUND BAR.
- 15. APPROVED ANTIOXIDANT COATINGS (I.E. CONDUCTIVE GEL OR PASTE)
 SHALL BE USED ON ALL COMPRESSION AND BOLTED GROUND
 CONNECTIONS.
- ALL EXTERIOR GROUND CONNECTIONS SHALL BE COATED WITH A CORROSION RESISTANT MATERIAL.
- 17. MISCELLANEOUS ELECTRICAL AND NON-ELECTRICAL METAL BOXES, FRAMES AND SUPPORTS SHALL BE BONDED TO THE GROUND RING, IN ACCORDANCE WITH THE NEC.
- 18. BOND ALL METALLIC OBJECTS WITHIN 6 FT. OF MAIN GROUND WIRES WITH 1-#2 AWG TIN-PLATED COPPER GROUND CONDUCTOR
- 19. GROUND CONDUCTORS USED IN THE FACILITY GROUND AND LIGHTNING PROTECTION SYSTEMS SHALL NOT BE ROUTED THROUGH METALLIC OBJECTS THAT FORM A RING AROUND THE CONDUCTOR, SUCH AS METALLIC CONDUITS, METAL SUPPORT CLIPS OR SLEEVES THROUGH WALLS OR FLOORS, WHEN IT IS REQUIRED TO BE HOUSED IN CONDUITIONS AND AMERICAL CONDUITIONS AMERICANCE CONDUITIO TO MEET CODE REQUIREMENTS OR LOCAL CONDITIONS, NON-METALLIC MATERIAL SUCH AS PVC PLASTIC CONDUIT SHALL BE USED. WHERE USE OF METAL CONDUIT IS UNAVOIDABLE (E.G., NONMETALLIC CONDUIT PROHIBITED BY LOCAL CODE) THE GROUND CONDUCTOR SHALL BE BONDED TO EACH END OF THE METAL CONDUIT.
- 20. ALL GROUNDS THAT TRANSITION FROM BELOW GRADE TO ABOVE GRADE MUST BE #2 TINNED SOLID IN 3/4" LIQUID TIGHT CONDUIT FROM 24"
 BELOW GRADE TO WITHIN 3" TO 6" OF CAD—WELD TERMINATION POINT.
 THE EXPOSED END OF THE LIQUID TIGHT CONDUIT MUST BE SEALED
 WITH SILICONE CAULK. (ADD TRANSITIONING GROUND STANDARD DETAIL AS WELL).

| | NSULATOR COLOR | |
|------------------|-------------------|---|
| DESCRIPTION | PHASE/CODE LETTER | WIRE COLOR |
| 240/120 10 | LEG 1 | BLACK |
| 240/120 10 | LEG 2 | RED |
| AC NEUTRAL | N | WHITE |
| GROUND (EGC) | G | GREEN |
| VDC POS | + | *RED-POLARITY MARK AT TERMINATION |
| VDC NEG | - | *BLACK-POLARITY MARK AT TERMINATION |
| | | |
| | PHASE A | BLACK |
| 240V OR 208V, 3Ø | PHASE B | RED(ORG. IF HI LEG) |
| | PHASE C | BLUE |
| | PHASE A | BROWN |
| 480V, 3Ø | PHASE B | ORANGE |
| | PHASE C | YELLOW |

* SEE NEC 210.5(C)(1) AND (2)



4502 10TH AVE

HANFORD, CA 93230



VERIZON SITE NUMBER: 110914

BU #: 857683 **CA371 - POTTER VALLEY**

12531 EEL RIVER ROAD POTTER VALLEY, CA 95469

EXISTING 65'-0" MONOPOLE

| | | ISSUE | ED FOR: | |
|-----|----------|-------|----------------|--------|
| REV | DATE | DRWN | DESCRIPTION | DES./Q |
| Α | 03/17/20 | AK | PRELIMINARY | CW |
| 0 | 04/09/20 | AK | SUBMITTAL CD'S | CW |
| | | | | |
| | | - | | |



SHEET NUMBER:



REVISION





4502 10TH AVE HANFORD, CA 93230



VERIZON SITE NUMBER: 110914

BU #: **857683 CA371 - POTTER VALLEY**

12531 EEL RIVER ROAD POTTER VALLEY, CA 95469

EXISTING 65'-0" MONOPOLE


| REV | DATE | DRWN | DESCRIPTION | DES./QA |
|-----|----------|------|----------------|---------|
| Α | 03/17/20 | AK | PRELIMINARY | CW |
| 0 | 04/09/20 | AK | SUBMITTAL CD'S | CW |
| | | | | |



IT IS A VIOLATION OF LAW FOR ANY PERSON, UNLESS THEY ARE ACTING UNDER THE DIRECTION OF A LICENSED PROFESSIONAL ENGINEER,





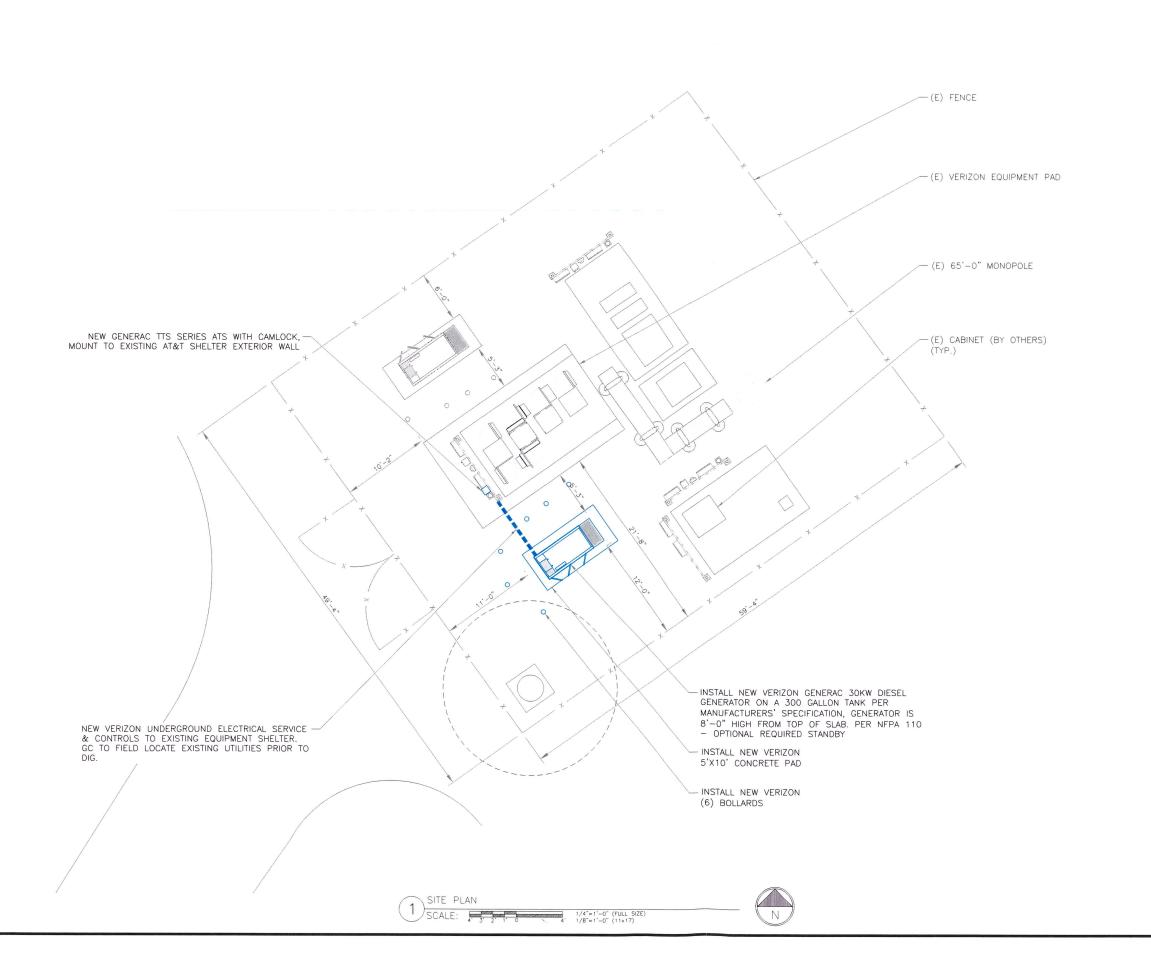





VERIZON SITE NUMBER: 110914

BU #: **857683 CA371 - POTTER VALLEY**

12531 EEL RIVER ROAD POTTER VALLEY, CA 95469

EXISTING 65'-0" MONOPOLE

| A 03/17/20 AK PRELIMINARY | CW CW |
|----------------------------|--------|
| 0 04/09/20 AK SUBMITTAL CE | o'S CW |



IT IS A VIOLATION OF LAW FOR ANY PERSON, UNLESS THEY ARE ACTING UNDER THE DIRECTION OF A LICENSED PROFESSIONAL ENGINEER, TO ALTER THIS DOCUMENT.

C-1.2

VERIZON EQUIPMENT ANTENNA CL: 46'-0" MOUNT CL: 46'-0" OVERALL STRUCTURE HEIGHT

ELEV. = 158'-0" OTHER ANTENNA RAD CENTER
ELEV. = 69'-0" TOP OF MONOPOLE

ELEV. = 65'-0" (E) OTHER ANTENNA OTHER ANTENNA RAD CENTER
ELEV. = 57'-2" - (E) VERIZON ANTENNA EXST. VERIZON RAD CENTER


ELEV. = 46'-0" (E) 65'-0" MONOPOLE (E) VERIZON EQUIPMENT -(E) GRADE ELEV. = 0'-0' EXISTING ELEVATION
SCALE: NOT TO SCALE


VERIZON EQUIPMENT

ANTENNA CL: 46'-0"


MOUNT CL: 46'-0"

◆ (E) GRADE ELEV. = 0'-0"

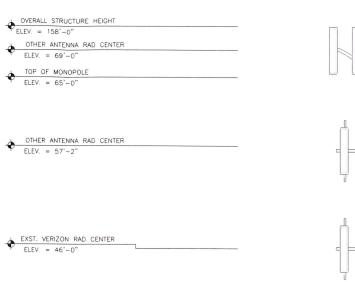

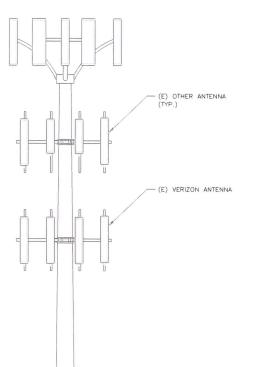

(E) 65'-0" MONOPOLE

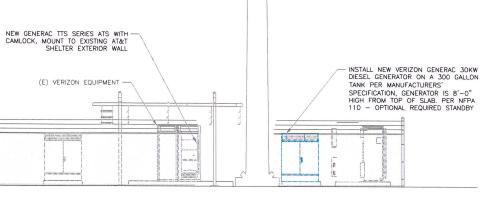

Verizon

4502 10TH AVE
HANFORD, CA 93230



VERIZON SITE NUMBER: 110914

BU #: **857683 CA371 - POTTER VALLEY**

12531 EEL RIVER ROAD POTTER VALLEY, CA 95469

EXISTING 65'-0" MONOPOLE

| REV | DATE | DRWN | DESCRIPTION | DES./QA |
|-----|----------|------|----------------|---------|
| Α | 03/17/20 | AK | PRELIMINARY | CW |
| 0 | 04/09/20 | AK | SUBMITTAL CD'S | CW |



IT IS A VIOLATION OF LAW FOR ANY PERSON, UNLESS THEY ARE ACTING UNDER THE DIRECTION OF A LICENSED PROFESSIONAL ENGINEER,

SHEET NUMBER:

Prince Revision

PINAL ELEVATION
SCALE: NOT TO SCALE

structural general notes

 1.0 <u>GENERAL CONDITIONS</u>
 1.1 <u>DESIGN AND CONSTRUCTION OF ALL WORK SHALL CONFORM TO LOCAL BUILDING CODES</u>, ACI-318-11. IN CASE OF CONFLICT BETWEEN THE CODES, STANDARDS, REGULATIONS. SPECIFICATIONS, GENERAL NOTES AND/OR MANUFACTURER'S REQUIREMENTS.USE THE MOST STRINGENT PROVISIONS

1.2 IT IS THE EXPRESS INTENT OF PARTIES INVOLVED IN THIS PROJECT THAT THE CONTRACTOR OR SUBCONTRACTOR OR INDEPENDENT CONTRACTOR OR THE RESPECTIVE EMPLOYEES SHALL EXCULPATE THE ARCHITECT, THE ENGINEER, TECH. CONSTRUCTION MANAGER, THE OWNER, AND THEIR AGENTS FROM ANY LIABILITY WHATSOEVER AND HOLD THEM HARMLESS AGAINST LOSS, DAMAGES, LIABILITY OR ANY EXPENSE ARISING IN ANY MATTER FROM THE WRONGFUL OR NEGLIGENT ACT, OR FAILURE TO CARRY METHODS, TECHNIQUES OR PROCEDURES OR FAILURE TO CONFORM TO THE STATE SCAFFOLDING ACT IN CONNECTION WITH THE WORK.

1.3 DO NOT SCALE DRAWINGS

1.4 VERIFY ALL EQUIPMENT MOUNTING DIMENSIONS PER MANUFACTURER DRAWINGS

1.5 DESIGN LOADS ARE (GENERAC): LIVE LOAD

EQUIPMENT SIZE : 144" H, 106" W, 37.4" D WEIGHT WITH WOODEN SHIPPING SKID

ENCLOSED GENERATOR WITH EMPTY FLIFI TANK

3974 LBS TANK SIZE 190 GAI

FOR DESIGN AND ANALYSIS OF THE FOUNDATION, THE MINIMUM NET SOIL BEARING CAPACITY SHALL BE ASSUMED TO BE 2000 PSF.

3.0 CONCRETE

3.1 MEET OR EXCEED THE FOLLOWING CODES AND STANDARDS: ACI 318-11

DESIGN CONSTRUCTION

ACI 301

DETAILING

CRSI MANUAL OF STANDARD PRACTICE ASTM A 615 GRADE 60. DEFORMED

STEEL MIXING AIR ENTRAINMENT

ASTM C 94. READY MIX CONCRETE ACI 318 AND ASTM C-260

AGGREGATE ASTM C 33 AND C 330 (FOR LIGHT WEIGHT)

3.2 CONCRETE STRENGTH AT 28 DAYS SHALL BE 4000 PSI MINIMUM.

3.3 DO NOT FIELD BEND OR WELD TO GRADE 60 REINFORCED STEEL

3.4 PROVIDE AIR ENTRAINED CONCRETE WITH AIR CONTENT OF 5 TO 7% FOR ALL CONCRETE EXPOSED TO EARTH OR WEATHER.

3.5 MAXIMUM AGGREGATE SIZE: 3/4"

3.6 DO NOT USE IN ADMIXTURE, WATER OR OTHER CONSTITUENTS OF CONCRETE WHICH HAS CALCIUM CHLORIDE


MINIMUM COVER FOR REINFORCING STEEL SHALL BE AS SHOWN ON PLAN.

4.0 FOUNDATION AND EXCAVATION NOTES

4.1 SLAB SHALL BE CONSTRUCTED UPON UNDISTURBED, NATURAL SUBGRADE OR COMPACTED GRANULAR FILL WITH AN ASSUMED MINIMUM NET ALLOWABLE BEARING CAPACITY OF 1500

4.2 ALL ORGANIC AND / OR OTHER UNSUITABLE MATERIAL SHALL BE REMOVED FROM FOUNDATION AND SLAB SUBGRADE AND BACKFILL AREAS, AND THEN BACKFILLED WITH ACCEPTABLE GRANULAR FILL COMPACTED TO 95 PERCENT OF MAXIMUM DENSITY AT OPTIMUM MOISTURE CONTENT (ASTM D1557).

4.3 THE CONTRACTOR SHALL PROVIDE ALL NECESSARY MEASURES TO PREVENT ANY WATER, FROST, OR ICE FROM PENETRATING ANY FOOTING OR STRUCTURAL SUBGRADE BEFORE AND AFTER PLACING OF CONCRETE, AND UNTIL SUCH CONCRETE HAS FULLY CURED.

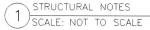

DOUBLE WALL FUEL TANK BASE GENERAL NOTES

REF: ATT 30KW GENERATOR PACKAGE

UL REGISTRATION NUMBER: MH18459

U.L. 142 DOUBLE WALL FUEL TANK BASE SPECIFICATION

FUEL TANK BASE CONSTRUCTION:

BE CONSTRUCTED IN ACCORDANCE WITH UNDERWRITERS LABORATORIES STANDARD UL-142. BE CONSTRUCTED IN ACCORDANCE WITH FLAMMABLE AND COMBUSTIBLE LIQUIDS CODE, NFPA 30; THE STANDARD FOR INSTALLATION AND USE OF STATIONARY COMBUSTIBLE ENGINE AND GAS TURBINES, NFPA 37; AND THE STANDARD FOR EMERGENCY AND STANDBY POWER SYSTEMS, NFPA 110.


ANCHORS MINIMUM (4) @ ½" FOR GEN-SET MOUNTING
SUB BASE TANK TESTING: PRIMARY TANK AND SECONDARY CONTAINMENT BASIN SECTIONS
SHALL BE PRESSURIZED AT 3-5 PSI AND LEAK-CHECKED TO ENSURE INTEGRITY OF SUB


BASE WELD SEAMS PER UL-142 STANDARDS FUEL FILL: 5 GALLON SPILL CONTAINMENT WITH ALARM

40% REMAINING FOR ALARM

20% REMAINING FOR SHUT-DOWN FACTORY PRE-SET AT 95% FULL FOR ALARM FUEL CONTAINMENT BASIN: SUB BASE TANK SHALL INCLUDE A WELDED STEEL CONTAINMENT BASIN, SIZED AT A MINIMUM OF 110% OF THE TANK CAPACITY TO PREVENT ESCAPE OF FUEL INTO THE ENVIRONMENT IN THE EVENT OF A TANK RUPTURE. A FUEL CONTAINMENT BASIN LEAK DETECTOR SWITCH SHALL BE PROVIDED.

> DOUBLE WALL FUEL TANK BASE SPECIFICATION 2) SCALE: NOT TO SCALE

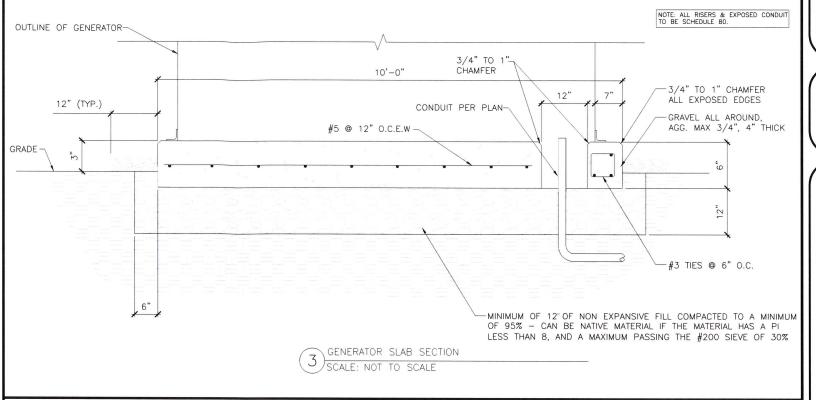

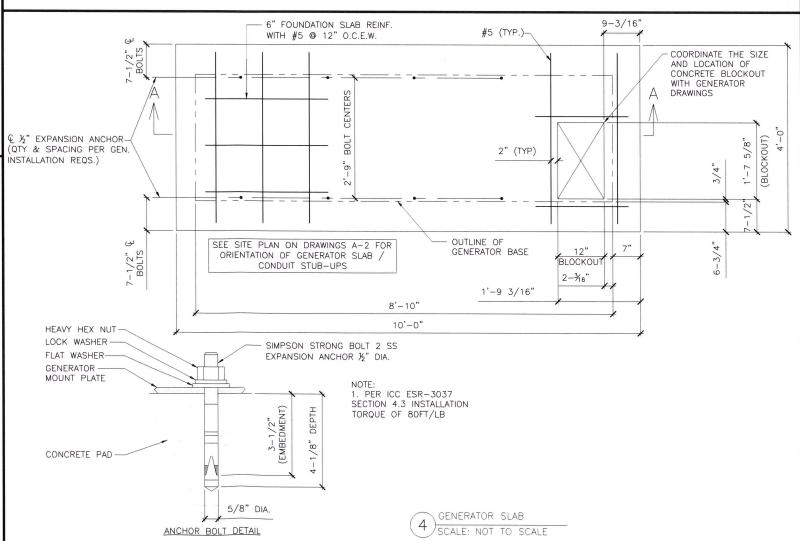





VERIZON SITE NUMBER: 110914

BU #: 857683 **CA371 - POTTER VALLEY**

12531 EEL RIVER ROAD POTTER VALLEY, CA 95469

EXISTING 65'-0" MONOPOLE

| REV | DATE | DRWN | DESCRIPTION | DES./QA |
|-----|----------|------|----------------|---------|
| Α | 03/17/20 | AK | PRELIMINARY | CW |
| 0 | 04/09/20 | AK | SUBMITTAL CD'S | CW |
| | | | | |



IT IS A VIOLATION OF LAW FOR ANY PERSON, UNLESS THEY ARE ACTING UNDER THE DIRECTION OF A LICENSED PROFESSIONAL ENGINEER,

SHEET NUMBER

REVISIO

| | | DIAGRAM C | IRCUI | T SC | HEDL | JLE |
|-----|------------------------------|---|---------|---------|-----------------|--------------------------------------|
| N0. | FROM | ТО | WIRES | GROUND | CONDUIT SIZE | FUNCTION |
| 1 | NORMAL POWER SOURCE | PANEL WITH AUTOMATIC TRANSFER SWITCH | (3) 3/0 | (1) #4 | 2" | NORMAL POWER FEEDER TO PANEL AND ATS |
| 2 | GENERATOR | PANEL WITH AUTOMATIC TRANSFER SWITCH | (3) 3/0 | (1) #4 | 2" | EMERGENCY POWER FEEDER TO ATS |
| 3 | AUTOMATIC TRANSFER SWITCH | GENERATOR | (3) 3/0 | (1) #2 | 2" | FUNCTION |
| 4 | PANEL | GENERATOR | (4) #12 | (1) #10 | 2" | HEATER AND BATTERY CHARGER |
| 5 | PANEL | AUTOMATIC TRANSFER SWITCH | (2) #12 | (1) #12 | 2" | ATS CONTROLLER |
| 6 | ATS | GENERATOR | (2) #14 | N/A | 2" | NO VOLTAGE ON THESE JUST A CONTACT |
| 7 | GENERATOR | TELCO BOARD | (2) #14 | N/A | 2" | NO VOLTAGE ON THESE JUST A CONTACT |
| 8 | AUTOMATIC TRANSFER SWITCH | TELCO BOARD | (2) #14 | N/A | 2" | NO VOLTAGE ON THESE JUST A CONTACT |

| | DIAGRAM CIRC | UIT SCHEDULE |
|------------------------|------------------|---------------------------|
| @ENERATOR ALARM WIRING | | ATS ALARMS WIRING |
| 66 BLOCK | GENERATOR | 66 BLOCK & ATS NAMED SAME |
| GEN RUN | GEN RUNNING | COMMERICAL POWER FAIL |
| GEN FAIL | GEN SHUT DOWN | TVSS |
| GEN MAJOR | GEN COMMON ALARM | ATS ENABLE |
| LOW FUEL | LOW FUEL | |
| FUEL LEAK | RUPTURED BASIN | |

NOTE: CONTRACTOR TO LABEL WIRES WITH P-TOUCH OR SIMILAR LABELS ONLY. ABSOLUTELY NO HANDWRITTEN LABELS.

> NOTE: ALL ALARMS NEED TO BE TERMINATED INSIDE OF GENERATOR BY GC. ALL ALARMS NEED TO BE TO EXISTING ACTIVE 66 BLOCK.

> > ALARM WIRING IDENTIFICATION DETAIL SCALE: NOT TO SCALE






4502 10TH AVE HANFORD, CA 93230

VERIZON SITE NUMBER: 110914

BU #: **857683 CA371 - POTTER VALLEY**


12531 EEL RIVER ROAD POTTER VALLEY, CA 95469


EXISTING 65'-0" MONOPOLE

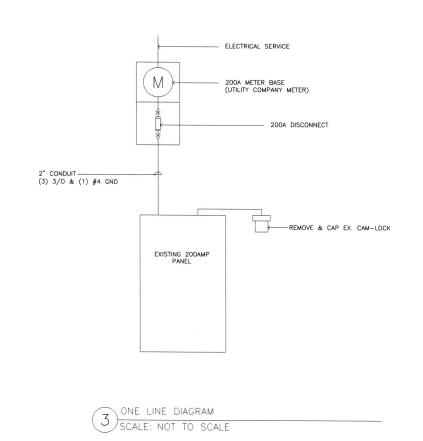

CIRCUIT DETAIL

(1) SCALE: NOT TO SCALE

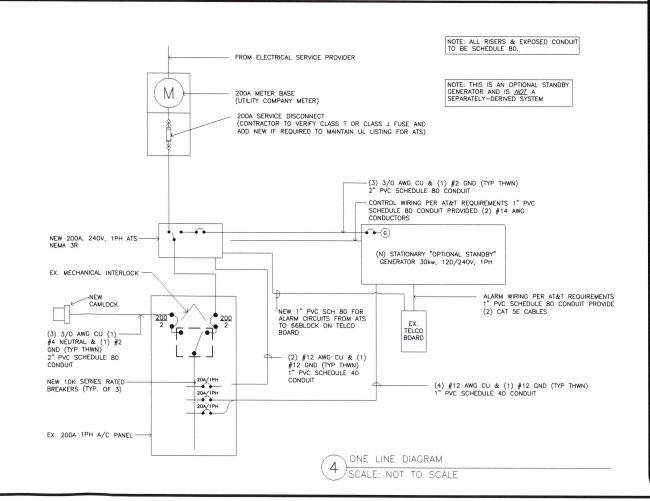

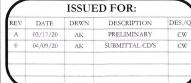




IT IS A VIOLATION OF LAW FOR ANY PERSON, UNLESS THEY ARE ACTING UNDER THE DIRECTION OF A LICENSED PROFESSIONAL ENGINEER,

SHEET NUMBER:

REVISION

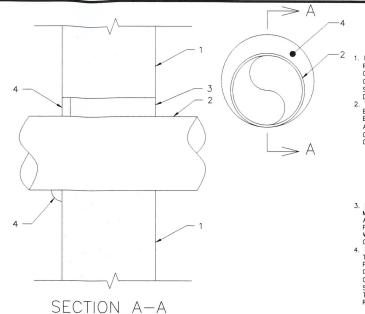

NOTE: IF EXISTING CONSTRUCTION VARIES FROM THIS DETAIL, AN EQUAL 3—HOUR U.L. PENETRATION APPROPRIATE FOR THE EXISTING 2WALL TYPE SHALL BE CONSTRUCTED

NOTE: GC SHALL USE NON-SHRINKING CAULK TO WEATHERSEAL ALL PENETRATIONS INTO OR THROUGH SHELTER WALL

U.L. SYSTEM NO. C-AJ-1150 CONDUIT THROUGH BEARING WALL SIMILAR TO U.L. DESIGN

1. FLOOR OR WALL ASSEMBLY: MINIMUM 4-1/2" THICK REINFORCED LIGHTWEIGHT OR NORMAL WEIGHT (100-150 PCF) CONCRETE. WALL MAY ALSO BE CONSTRUCTED OF ANY UL CLASSIFIED CONCRETE BLOCKS*. MAX DIAMETER OF OPENING IS 4". SEE CONCRETE BLOCKS (CATZ) CATEGORY IN THE FIRE RESISTANCE DIRECTORY FOR NAMES OF MANUFACTURERS.

2. THROUGH PENETRATIONS: ONE METALLIC PIPE OR CONDUIT TO BE RIGIDLY SUPPORTED ON BOTH SIDES OF FLOOR OR WALL ASSEMBLY, THE ANNULAR SPACE SHALL BE MINIMUM O". (POINT CONTACT) TO MAXIMUM 1-3/8". THE FOLLOWING TYPES AND SIZES OF METALLIC PIPE OR CONDUITS MAY BE USED:

A. STEEL PIPE - NOMINAL 6" DIAMETER (OR SMALLER) SCHEDULE 40 (OR HEAVIER) STEEL PIPE.

B. IRON PIPE - NOMINAL 6" DIAMETER (OR SMALLER) CAST OR DUCTILE IRON PIPE.

C. CONDUIT - NOMINAL 4" DIAMETER (OR SMALLER) STEEL ELECTRICAL METALLIC TUBING OR NOMINAL 3-1/2" DIAMETER (OR SMALLER) STEEL CONDUIT.

3. PACKING MATERIAL: MINIMUM 6" THICKNESS OF MIN 4.0 PCF MINIERAL WOOL BATTING INSULATION FIRMLY PACKED INTO OPENING AS A PERMANENT FORM. PACKING MATERIAL TO BE RECESSED FROM TOP SURFACE OF FLOOR OR FROM BOTH SURFACES OF WALL AS REQUIRED TO ACCOMMODATE THE REQUIRED THICKNESS OF FILL MATERIAL.

4. FILL, VOID, OR CAVITY MATERIAL*: SEALANT: MINIMUM 1/4" THICKNESS OF FILL MATERIAL.

5. FLUSH WITH TOP SURFACE OF FLOOR OR FROM BOTH SURFACES OF WALL AS REQUIRED TO ACCOMMODATE THE REQUIRED THICKNESS OF FILL MATERIAL. APPLIED WITHIN THE ANNULUS. FLUSH WITH TOP SURFACE OF FLOOR AND WITH BOTH SURFACES OF WALL. AT THE POINT CONTACT LOCATION BETWEEN PIPE AND CONCRETE, A MINIMUM 1/2" THICKNESS OF FILL MATERIAL. SEALANT: MINIMUM 1/4" THICKNESS OF FLOOR AND ON BOTH SURFACES OF WALL. WE RATING APPLIED AT THE CONCRETE/PIPE INTERREC ON THE TOP SURFACE OF FLOOR AND ON BOTH SURFACES OF WALL WE RATING APPLIED AT THE CONCRETE/PIPE INTERREC ON THE TOP SURFACE OF FLOOR AND ON BOTH SURFACES OF WALL WE RATING APPLIED AT THE CONCRETE/PIPE INTERREC ON THE TOP SURFACE OF FLOOR AND ON BOTH SURFACES OF WALL WE RATING APPLIED AT THE CONCRETE/PIPE INTERREC ON THE TOP SURFACE OF FLOOR AND

HILTI CONSTRUCTION CHEMICALS, DIV OF HILTI INC. : CP601S, CP604, CP606, OR FS-ONE SEALANT.

* BEARING THE UL CLASSIFICATION MARK

4502 10TH AVE HANFORD, CA 93230



VERIZON SITE NUMBER: 110914

BU #: **857683 CA371 - POTTER VALLEY**

12531 EEL RIVER ROAD POTTER VALLEY, CA 95469

EXISTING 65'-0" MONOPOLE

ISSUED FOR: DATE DRWN DESCRIPTION

PRELIMINARY

SUBMITTAL CD'S

CW

CW

03/17/20 AK

04/09/20 AK

A Company PE TYPE HS TYPE 2-YA-2 TYPE XA TYPE YA-2 TYPE GY (OT) TYPE VN TYPE NC TYPE SS TYPE GR TYPE VS TYPE VB TYPE PT TYPE GT2

OUTER WALL PENETRATION DETAIL

SCALE: NOT TO SCALE

- ERICO EXOTHERMIC "MOLD TYPES" SHOWN HERE ARE EXAMPLES. CONSULT WITH CONSTRUCTION MANAGER FOR SPECIFIC MOLDS TO BE USED FOR THIS PROJECT.
 MOLD TYPE ONLY TO BE USED BELOW GRADE WHEN CONNECTING GROUND RING TO GROUND ROD.


IT IS A VIOLATION OF LAW FOR ANY PERSON, UNLESS THEY ARE ACTING UNDER THE DIRECTION OF A LICENSED PROFESSIONAL ENGINEER,


SHEET NUMBER:

REVISION

PANEL PHOTO SCALE: NOT TO SCALE

CADWELD GROUNDING CONNECTIONS SCALE: NOT TO SCALE

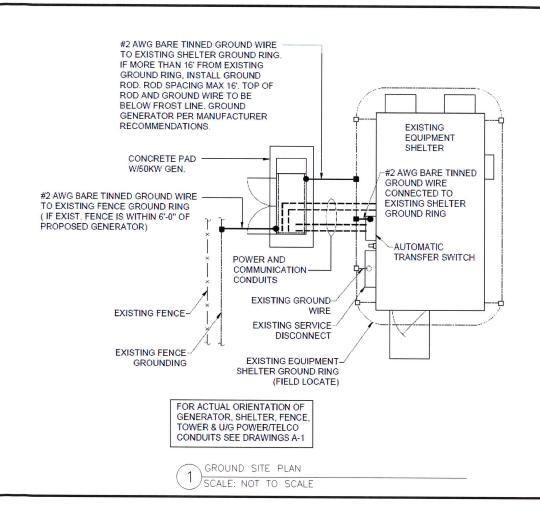

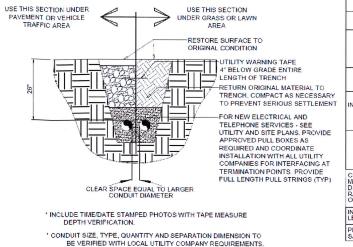

NOTE

GROUND RODS MAY BE:

MINIMUM COVER REQUIREMENTS, 0 TO 600 VOLTS, NOMINAL, BURIAL IN INCHES TYPE OF WIRING METHOD OR CIRCUIT CABLES OR CONDUCTORS 24 INCHES 6 INCHES TRENCH BELOW 2 INC THICK CONCRETE OR EQUIVALENT 18 INCHES 6 INCHES UNDER STREETS OR HIGHWAYS 24 INCHES 24 INCHES COVER IS DEFINED AS THE SHORTEST DISTANCE IN INCHES MEASURED BETWEEN A POINT ON THE TOP SURFACE OF ANY DIRECT-BURIED CONDUCTOR. CABLE, CONDUIT, OR OTHER RACEWAY AND THE TOP SURFACE OF FINISHED GRADE, CONCRETE, OR SIMILAR COVER.

INSTALL WARNING TAPE 4" BELOW GRADE FOR THE ENTIRE LENGTH OF TRENCH. PROVIDE AT LEAST 2 " OF SAND BED ABOVE CONDUIT AND 2" OF SAND BED BELOW THE CONDUIT.

4502 10TH AVE

HANFORD, CA 93230



VERIZON SITE NUMBER: 110914

BU #: **857683 CA371 - POTTER VALLEY**

12531 EEL RIVER ROAD POTTER VALLEY, CA 95469

EXISTING 65'-0" MONOPOLE

CONDUCTOR BURIAL REQUIREMENTS (2) SCALE: NOT TO SCALE


| UNISTRU | JT MOUNTING CHART |
|------------------------------|---|
| WALL CONSTRUCTION TYPE | USE |
| HOLLOW | 3/8"Ø TOGGLE BOLT |
| HOLLOW, AT STUD | 3/8"Ø LAG SCREW |
| CONCRETE BLOCK(HOLLOW) | 7/16"Ø HILTI HY-20 WITH SCREEN MINIMUM EMBEDMENT 2-1/2" |
| CONCRETE (SOLID) | 7/16"Ø HILTI HY-150 WITH SCREEN MINIMUM EMBEDMENT 2-1/2" |

USE GALVANIZED OR STAINLESS STEEL HARDWARE FOR WALL MOUNT AND CONNECTION OF CHANNELS

GC SHALL USE NON-SHRINKING CAULK TO WEATHER

SEAL ALL PENETRATIONS INTO OR THROUGH

SHELTER WALL

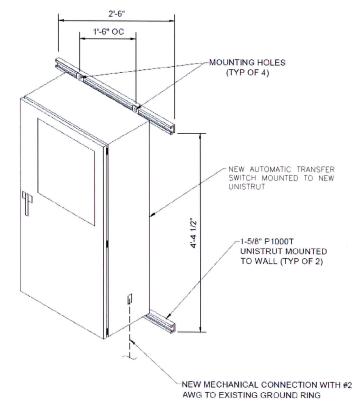

GRADE -WHERE CADWELD FROST LINE #2 AWG BARE TINNED COPPER OR ARTICLE 250-66 - ANGLE OF GROUND ROD SHALL NOT BE INSTALLED


ISSUED FOR: DATE DRWN DESCRIPTION PRELIMINARY AK SUBMITTAL CD'S CW 04/09/20 AK



IT IS A VIOLATION OF LAW FOR ANY PERSON, UNLESS THEY ARE ACTING UNDER THE DIRECTION OF A LICENSED PROFESSIONAL ENGINEER,


SHEET NUMBER

REVISIO

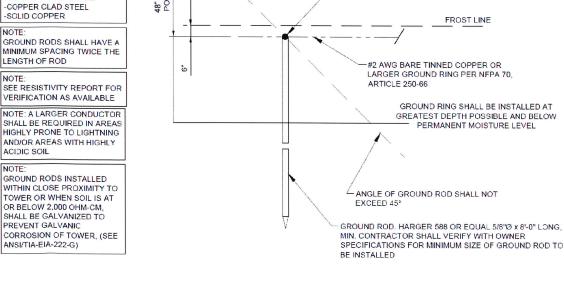

GROUND ROD DETAIL (4) SCALE: NOT TO SCALE

INTERSECT ATS MOUNTING DETAIL SCALE: NOT TO SCALE

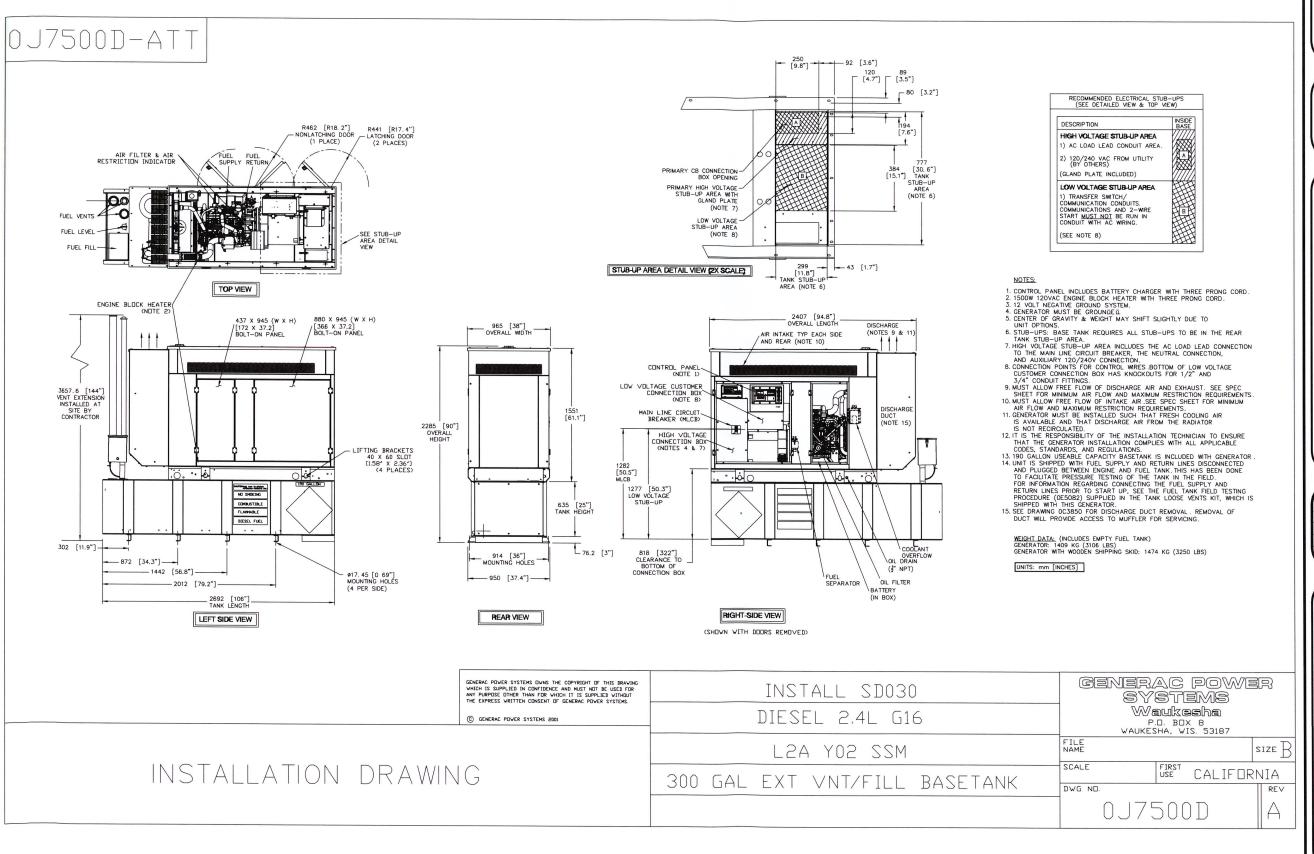





VERIZON SITE NUMBER: 110914

BU #: **857683 CA371 - POTTER VALLEY**

12531 EEL RIVER ROAD POTTER VALLEY, CA 95469

EXISTING 65'-0" MONOPOLE

| REV | DATE | DRWN | DESCRIPTION | DES./Q/ |
|-----|----------|------|----------------|---------|
| Α | 03/17/20 | AK | PRELIMINARY | CW |
| 0 | 04/09/20 | AK | SUBMITTAL CD'S | CW |




IT IS A VIOLATION OF LAW FOR ANY PERSON, UNLESS THEY ARE ACTING UNDER THE DIRECTION OF A LICENSED PROFESSIONAL ENGINEER,

SHEET NUMBER

-4 (R

GENERATOR DETAIL
SCALE: NOT TO SCALE

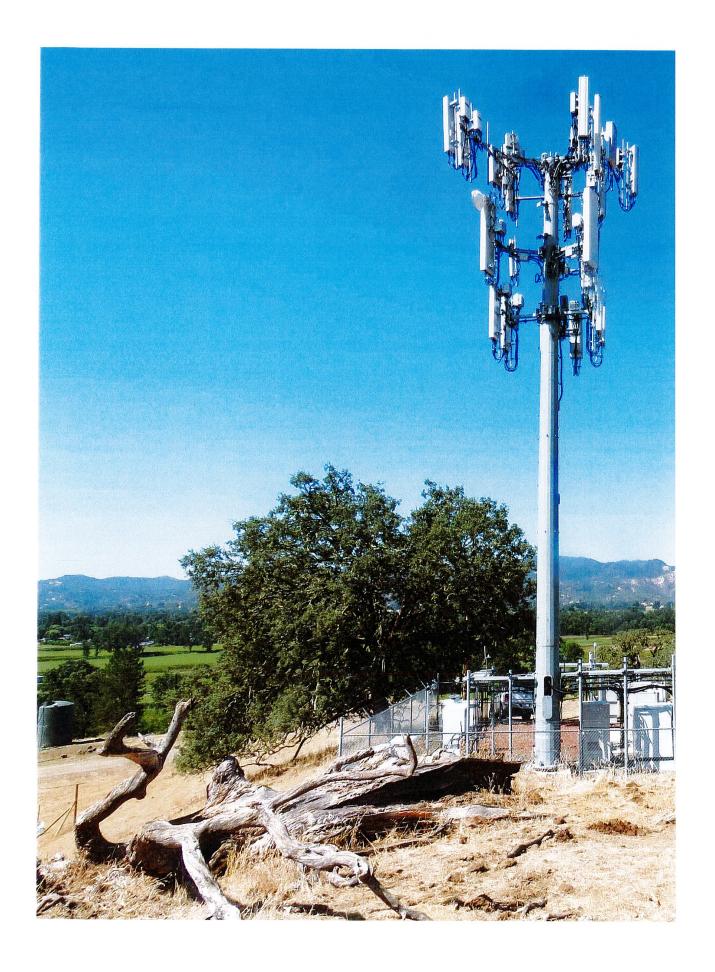

Google Maps 12500 Eel River Rd



Potter Valley, California

Google

Street View



